

Project Title:

## City of Albuquerque

### Planning Department

## Development & Building Services Division

### DRAINAGE AND TRANSPORTATION INFORMATION SHEET

(REV 02/2013)

Building Permit #: City Drainage #:

DRB#: EPC	#: Work 0	Order#:				
Legal Description:						
City Address:						
Engineering Firm:	Contac	t:				
Address:						
Phone#: Fax#	E-mail:					
Owner:	Contac	t:				
Address:						
Phone#: Fax#	: E-mail:					
Architect:	Contac	t:				
Address:						
Phone#: Fax#	: E-mail:	:				
Surveyor:	Contac	t:				
Address:						
Phone#: Fax#	E-mail:					
Contractor:	Contac	t:				
Address:						
Phone#: Fax#	E-mail:					
TYPE OF SUBMITTAL:	CHECK TYPE OF APPROVAL/ACC	CEPTANCE SOUGHT:				
DRAINAGE REPORT	SIA/FINANCIAL GUARANTEE REI	LEASE				
DRAINAGE PLAN 1st SUBMITTAL	PRELIMINARY PLAT APPROVAL					
DRAINAGE PLAN RESUBMITTAL	S. DEV. PLAN FOR SUB'D APPROV	VAL				
CONCEPTUAL G & D PLAN	S. DEV. FOR BLDG. PERMIT APPR	OVAL				
GRADING PLAN	SECTOR PLAN APPROVAL					
EROSION & SEDIMENT CONTROL PLAN (E	SC) FINAL PLAT APPROVAL					
ENGINEER'S CERT (HYDROLOGY)	CERTIFICATE OF OCCUPANCY (P	ERM)				
CLOMR/LOMR	CERTIFICATE OF OCCUPANCY (TCL TEMP)					
TRAFFIC CIRCULATION LAYOUT (TCL)	FOUNDATION PERMIT APPROVA	L				
ENGINEER'S CERT (TCL)	BUILDING PERMIT APPROVAL					
ENGINEER'S CERT (DRB SITE PLAN)	GRADING PERMIT APPROVAL	SO-19 APPROVAL				
ENGINEER'S CERT (ESC)	PAVING PERMIT APPROVAL	ESC PERMIT APPROVAL				
SO-19	WORK ORDER APPROVAL	ESC CERT. ACCEPTANCE				
OTHER (SPECIFY)	GRADING CERTIFICATION	OTHER (SPECIFY)				
WAS A PRE-DESIGN CONFERENCE ATTENDED:	Yes No Copy Provi	ided				
DATE SUBMITTED:	By:					

Requests for approvals of Site Development Plans and/or Subdivision Plats shall be accompanied by a drainage submittal. The particular nature, location, and scope to the proposed development defines the degree of drainage detail. One or more of the following levels of submittal may be required based on the followin

- 1. Conceptual Grading and Drainage Plan: Required for approval of Site Development Plans greater than five (5) acres and Sector Plans
- Drainage Plans: Required for building permits, grading permits, paving permits and site plans less than five (5) acres Drainage Report: Required for subdivision containing more than ten (10) lots or constituting five (5) acres or more
- Erosion and Sediment Control Plan: Required for any new development and redevelopment site with 1-acre or more of land disturbing area, including project less than 1-acre than are part of a larger common plan of development

# CITY OF ALBUQUERQUE

August 11, 2015



David Soule, P.E. Rio Grande Engineering PO Box 93924 Albuquerque, New Mexico 87199

RE: Parking Lot for 6<sup>th</sup> St/Fruit Ave 6th St/Fruit Ave Grading and Drainage Plan Engineers Stamp Date 8/4/15 (J14D177)

Dear Mr. Soule,

Based upon the information provided in your submittal received 8/4/15, this plan cannot be approved for Grading Permit or Paving Permit until the following comments are addressed.

- Provide a larger font for the Drainage Calculation Sheet. ADDED
- In the narrative a new home being built is mentioned. Where is the home located in this parking lot? CORRECT NARRATIVE ATTACHED
- The first flush pond to the south shows a TOP = 4957.00 and a BOTTOM = 4056.00, I hope this is a typo, adjust accordingly. CORRECTED
- The three ponds to the east have a TOP shown larger than the spot elevation provided next to the ponds, adjust accordingly. CORRECTED
- Is the lot being paved, or kept as is? Are parking bumpers supplied? The alley will need to be paved. A TCL is required. INCLUDED TCL
- Provide the benchmark. ADDED
- How will erosion, dirt, dust from the parking lot be kept out of the right of way (6<sup>th</sup> St.)?
   INCLUDED LANSCAPE PLAN TO SHOW GRAVEL

www.cabq.gov

New Mexico 87103

PO Box 1293

Albuquerque


If you have any questions, please contact me at 924-3695 or Rudy Rael at 924-3977.


Rita Harmon, P.E.

Senior Engineer, Hydrology

Planning Department

RR/RH C: File

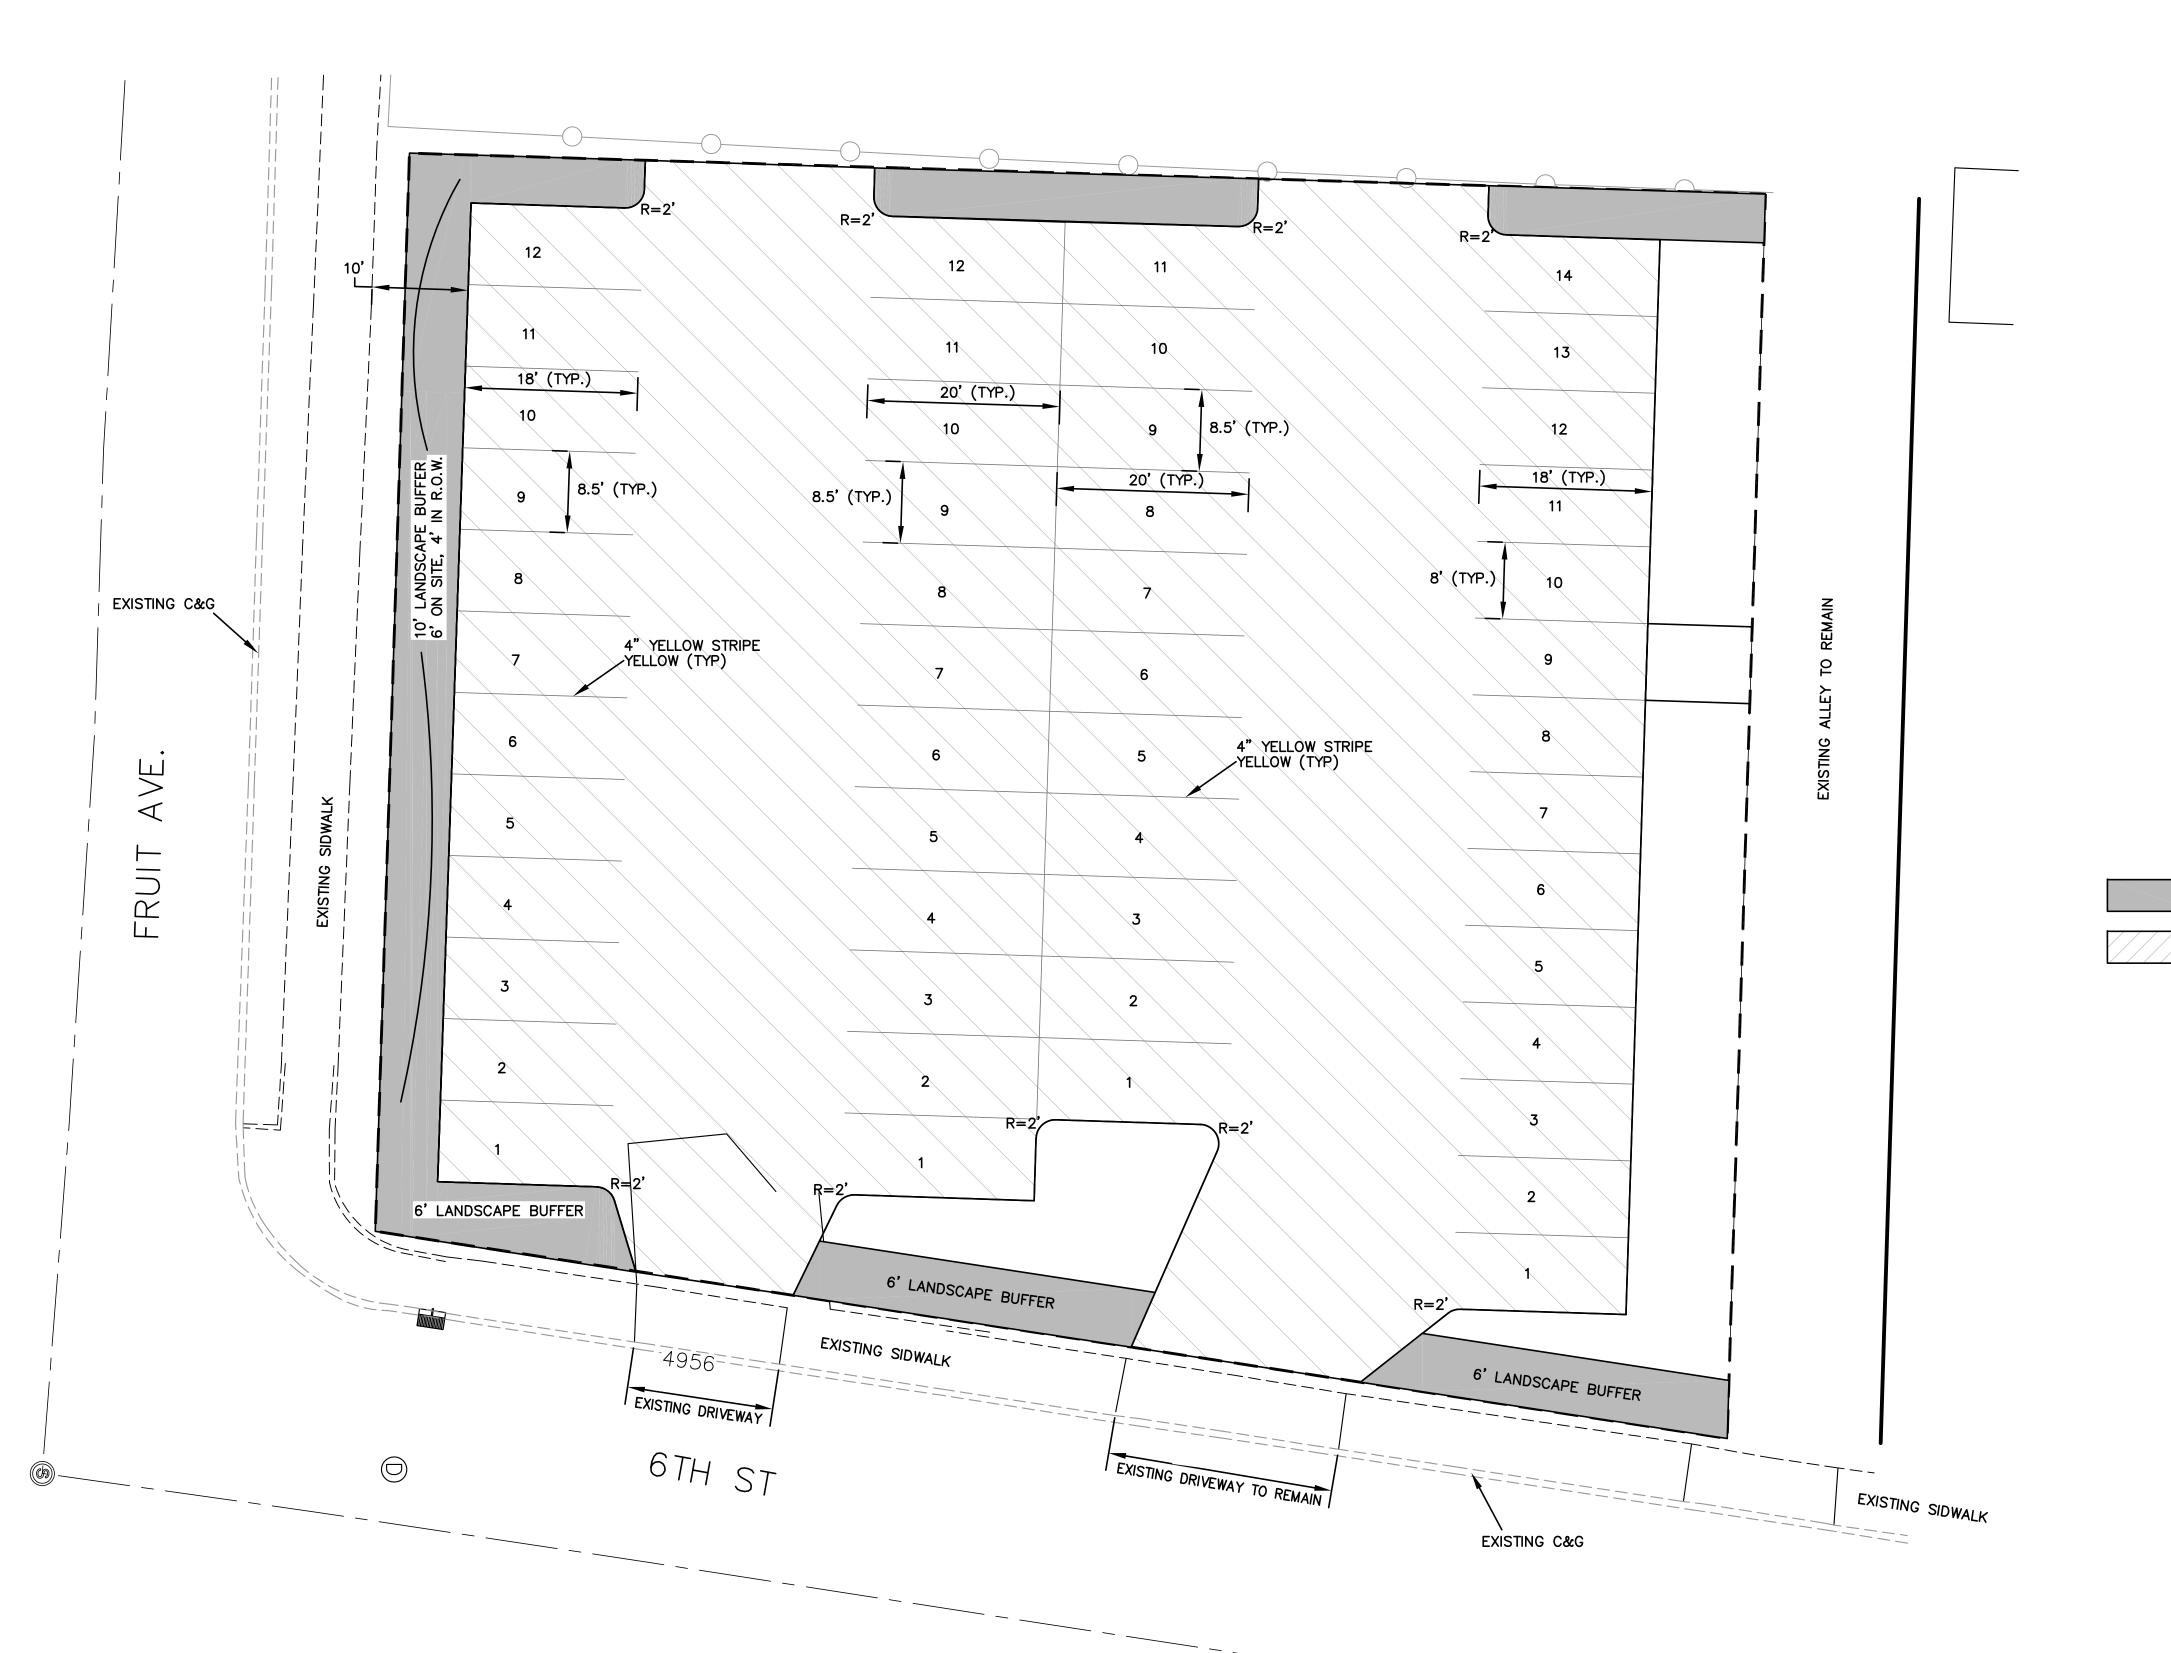

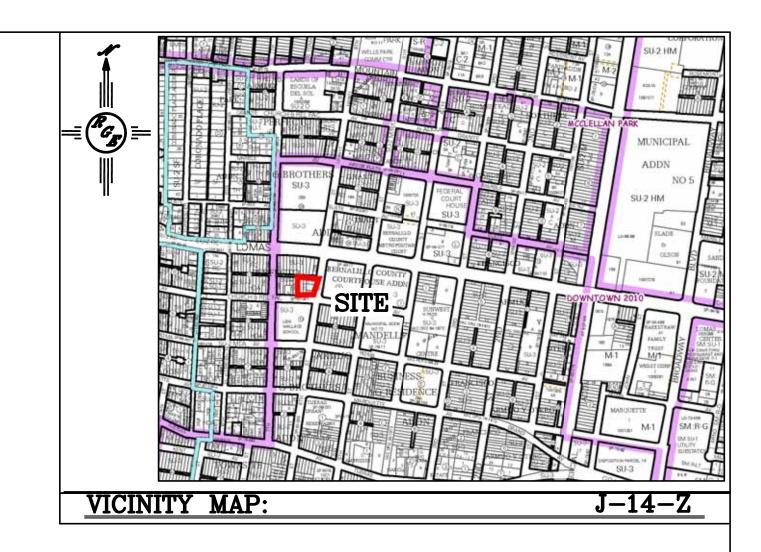

### NOTES:

- 1. PARKING BUMPERS SHALL BE INSTALLED.
- 2. EXISTING ALLEY WILL REMAIN, NO ACCESS TO PARKING FIELD SHALL BE TAKEN FROM ALLEY.


LANDSCAPE AREA

LIMITS OF NEW PAVEMENT
2" ASPHALT OVER COMPACTED SUBGRADE

SCALE: 1"=10'

ENGINEER'S SEAL	PARKING LOT FOR	DRAWN BY DEM
VIID SO	6TH ST AND FRUIT AVE.	DATE
OF EN MEXIC FM	SITE PLAN AND	7-15-1
AFOFESSIONAL BY		FRUIT-STH ST_GAQ_
PAOFESSIONAL ET	Rio Grande	SHEET ;
8/18/15	Engineering 1808 CENTRAL AVENUE	1 of
DAVID SOULE P.E. #14522	SUITE 201 ALBUQUERQUE, NM 87108 (505) 872-0999	JOB #

EXISTING UTILITIES ARE NOT SHOWN.
IT SHALL BE THE SOLE RESPONSIBILITY
OF THE CONTRACTOR TO CONDUCT ALL
NECESSARY FIELD INVESTIGATIONS PRIOR
TO ANY EXCAVATION TO DETERMINE THE
ACTUAL LOCATION OF UTILITIES & OTHER
IMPROVEMENTS.

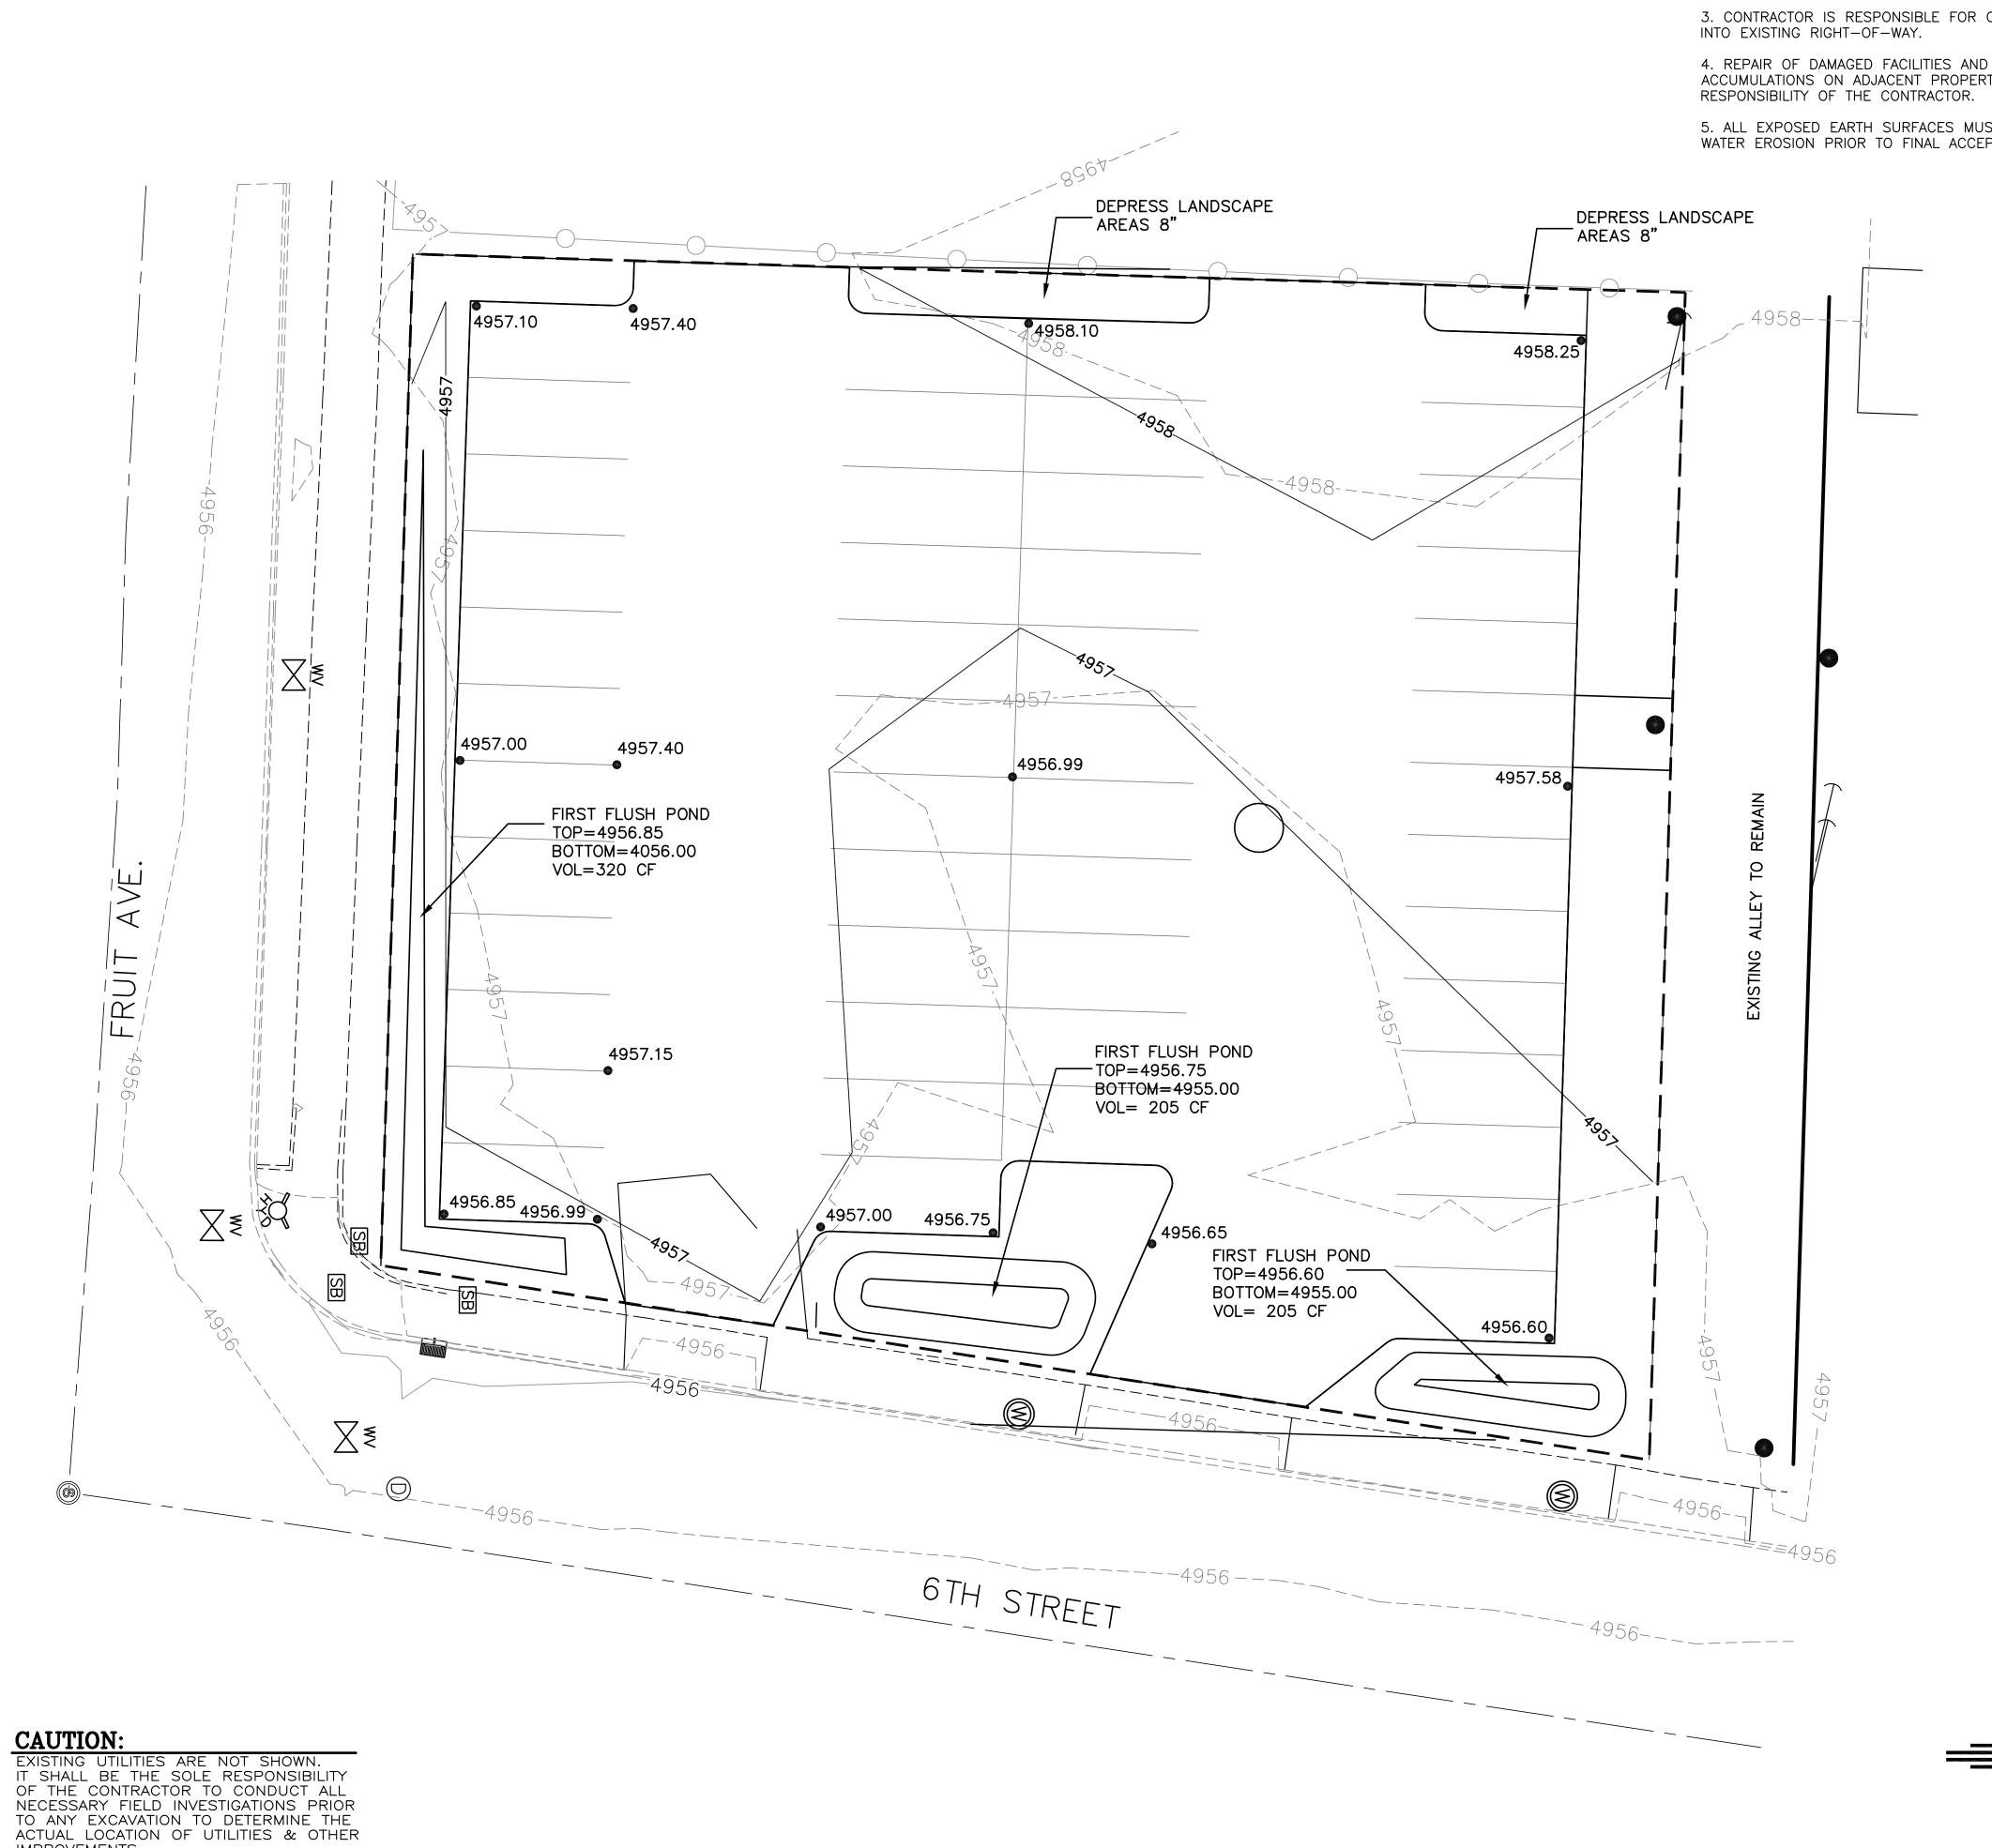

IMPROVEMENTS.

## **EROSION CONTROL NOTES:**

1. CONTRACTOR IS RESPONSIBLE FOR OBTAINING A TOPSOIL DISTURBANCE PERMIT PRIOR TO BEGINNING WORK.

2. CONTRACTOR IS RESPONSIBLE FOR MAINTAINING RUN-OFF ON SITE DURING

3. CONTRACTOR IS RESPONSIBLE FOR CLEANING ALL SEDIMENT THAT GETS

4. REPAIR OF DAMAGED FACILITIES AND CLEANUP OF SEDIMENT ACCUMULATIONS ON ADJACENT PROPERTIES AND IN PUBLIC FACILITIES IS THE

5. ALL EXPOSED EARTH SURFACES MUST BE PROTECTED FROM WIND AND WATER EROSION PRIOR TO FINAL ACCEPTANCE OF ANY PROJECT.



VICINITY MAP: J-14-Z




### LEGAL DESCRIPTION:

605 SIXTH STREET LOTS 212-216 ARMIJO BROTHERS ADDITION CITY OF ALBUQUERQUE BERNALILLO COUNTY, NEW MEXICO


1. ALL SPOT ELEVATIONS REPRESENT FLOWLINE ELEVATION UNLESS OTHERWISE

## **LEGEND**

---- EXISTING CONTOUR ---- EXISTING INDEX CONTOUR PROPOSED CONTOUR PROPOSED INDEX CONTOUR - LOT LINE CENTERLINE - RIGHT-OF-WAY EXTENDED STEM WALL SEE ARCH PLANS FOR DETAILS PROPOSED ROCK FACE WALL EXISTING CURB AND GUTTER PROPOSED EDGE OF CONCRETE · · · · · · · · · · · PROPOSED FLOWLINE EXISITNG WALL

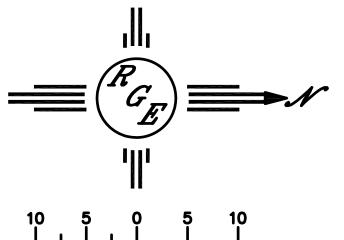

SCALE: 1"=10'

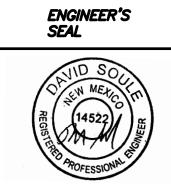

PARKING LOT FOR 6TH ST AND FRUIT AVE. GRADING AND

DATE 7-15-15 FRUIT-STH ST\_GGQ\_PLAN.dug

BY DEM

SHEET #

JOB #


XXXXX


Engineering 1606 CENTRAL AVENUE SUITE 201 ALBUQUERQUE, NM 87106 (505) 872-0999

Rio Grande 2 of 3

DRAINAGE PLAN

8/18/15 DAVID SOULE P.E. #14522

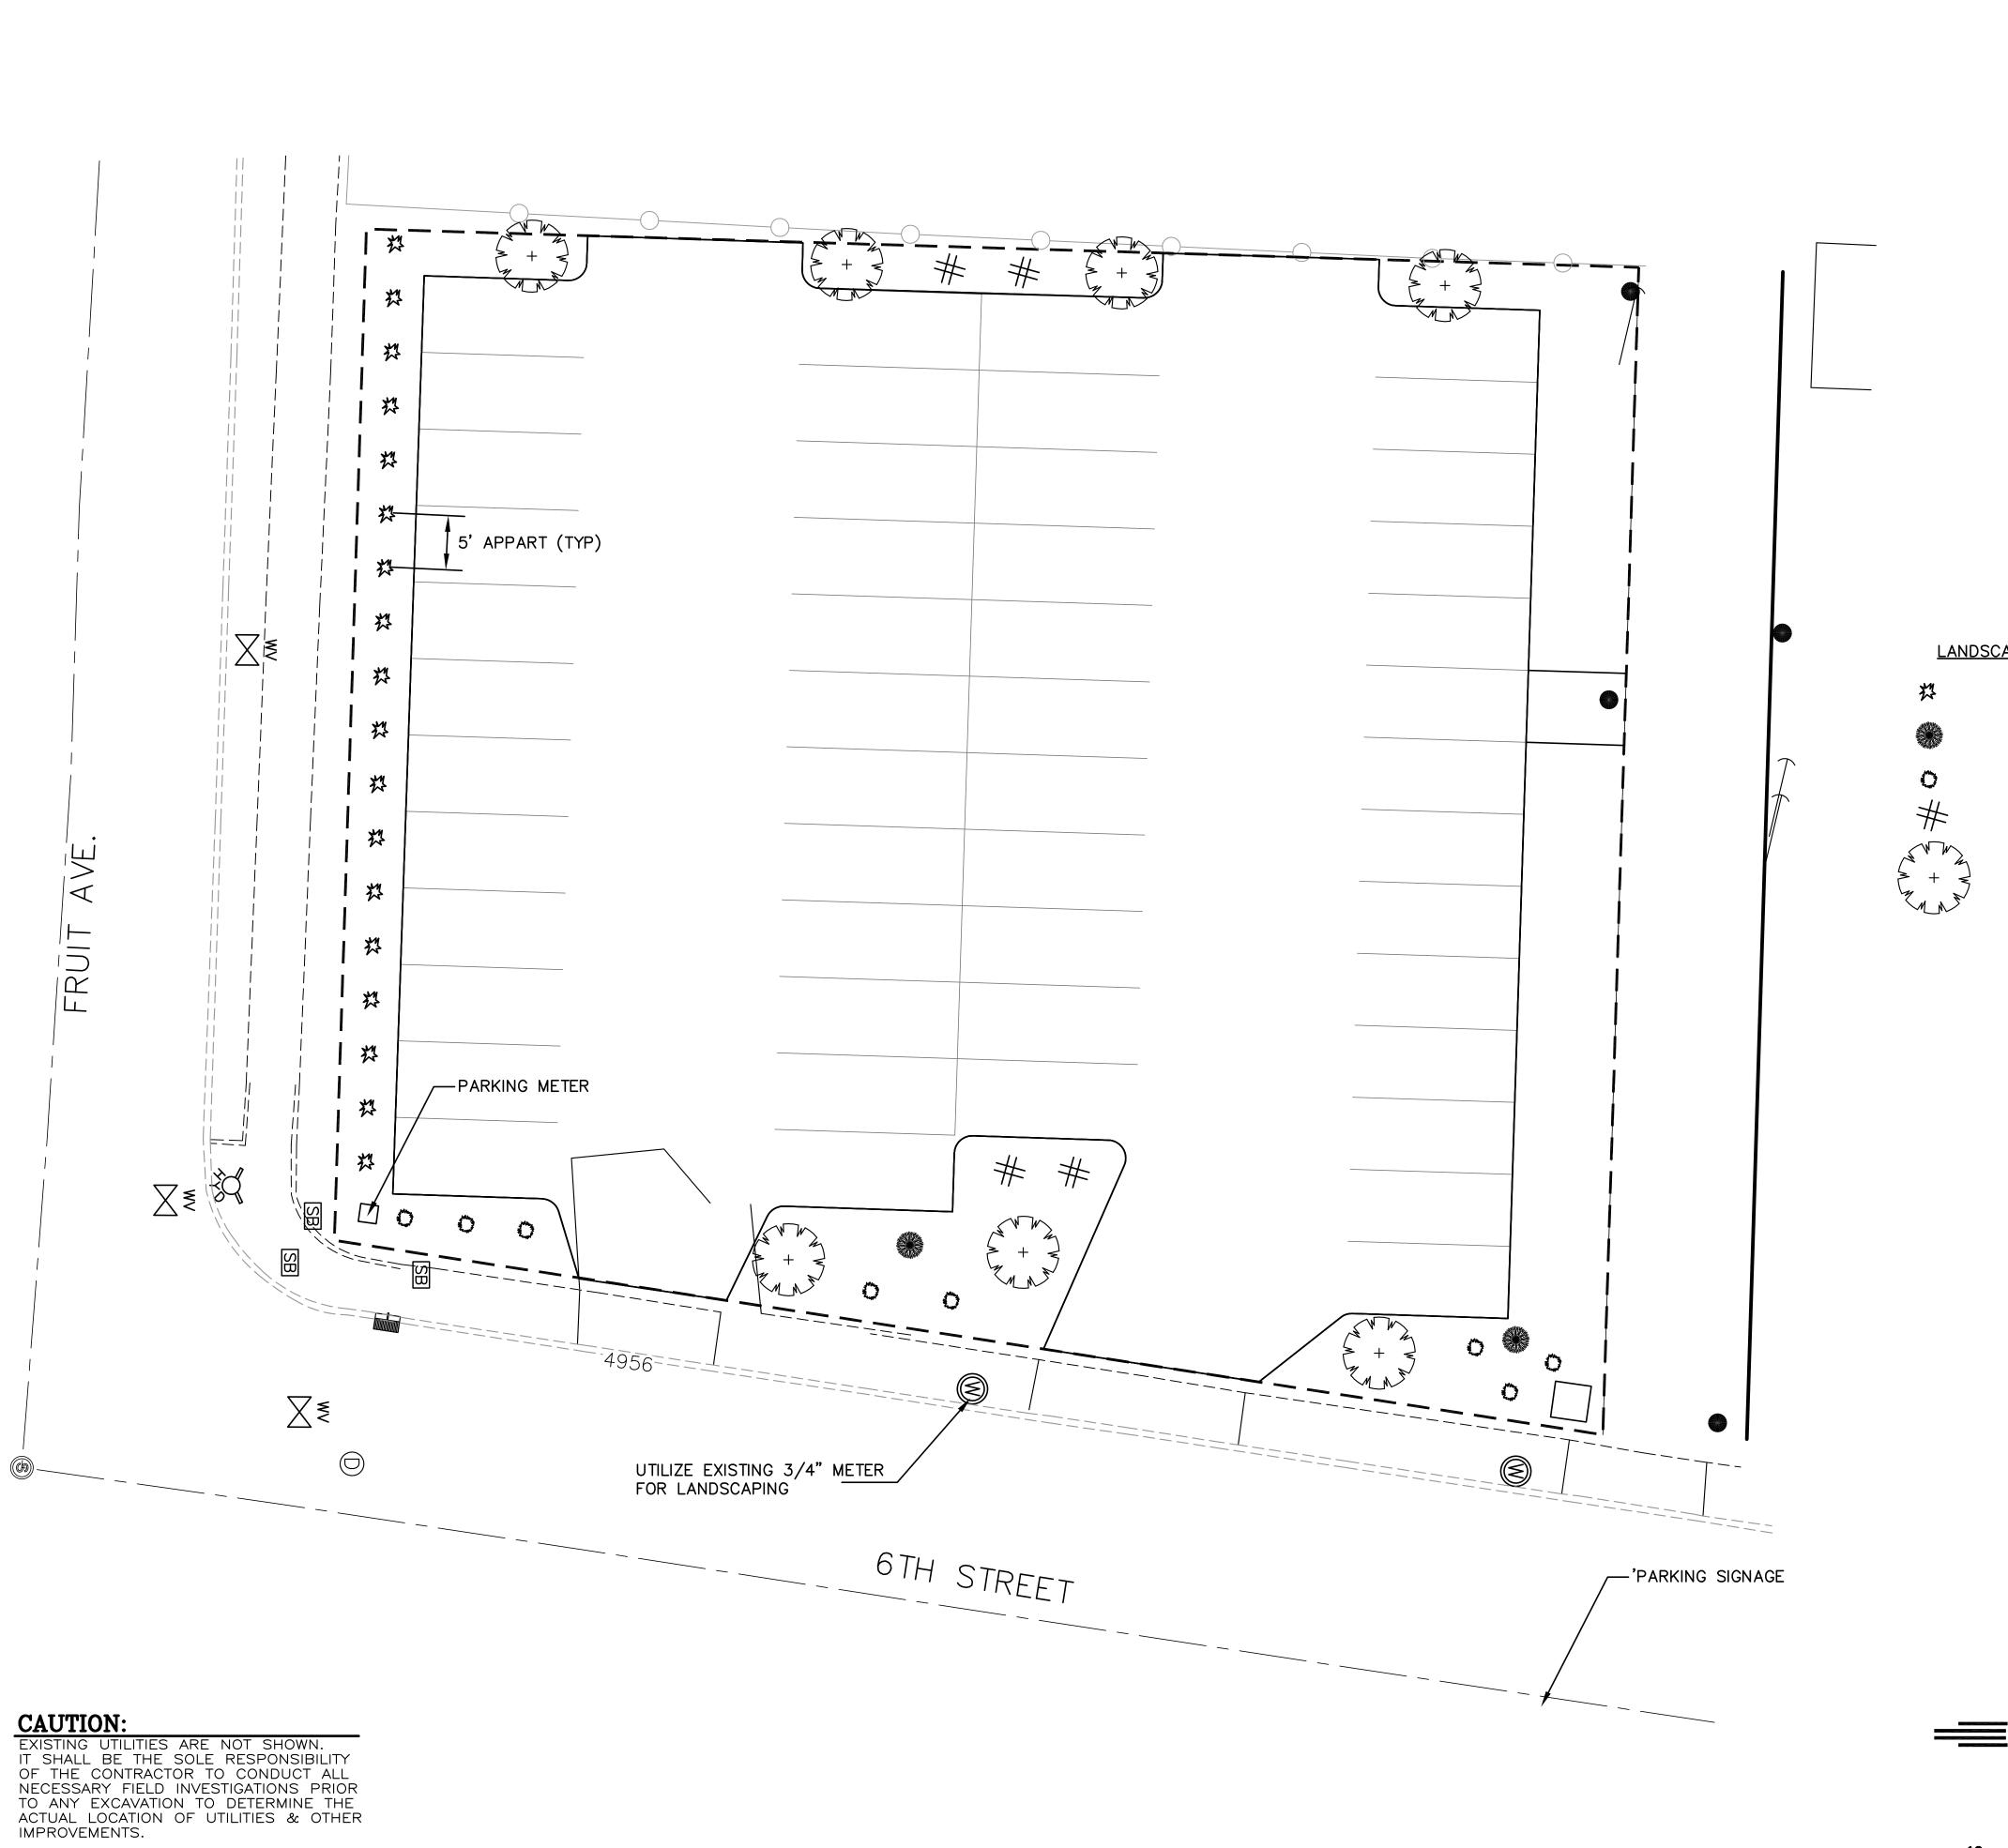

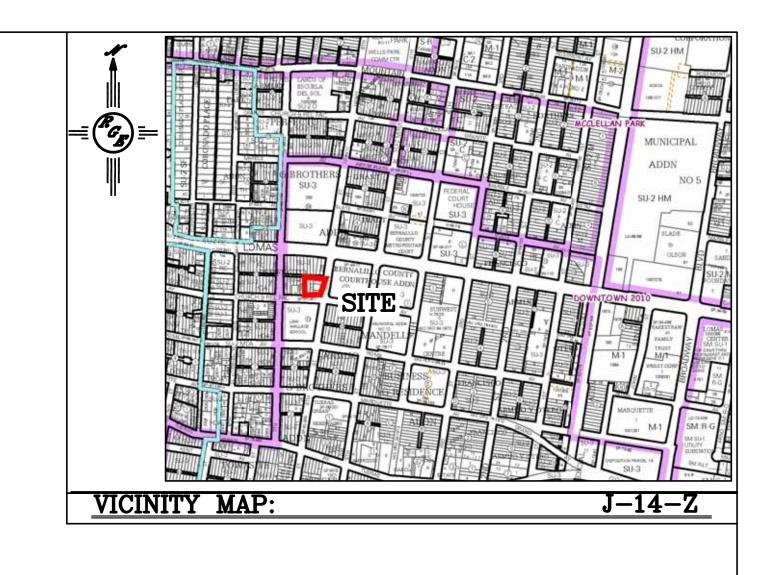

LANDSCAPE LEGEND


TURPENTINE BUSH

CHAMAEBATIARIA MILLEFOLIUM (FERN BUSH)

TEXAS RED YUCCA

RUSCHIA PULVINARIS

DESERT WILLOW

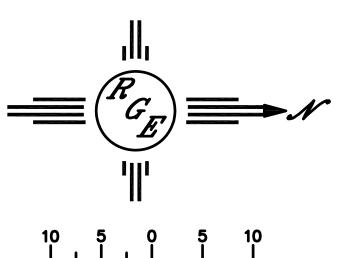

SCALE: 1"=10'

ENGINEER'S SEAL	PARKING LOT FOR	DRAWN BY DEM			
(IID SO	6TH ST AND FRUIT AVE.	DATE			
RECORD TO SEE SEE SEE SEE SEE SEE SEE SEE SEE SE	LANDSCAPE PLAN	7-15-15 FRUIT-STH ST_GAD_FLAN.			
8/18/15	Rio Grande  Engineering  1808 CENTRAL AVENUE	SHEET #			
DAVID SOULE P.E. #14522	ALBUQUERQUE, NM 87108 (505) 872-0999	JOB #			

### **Weighted E Method**

#### FRUIT PARKING LOT REPAVE

Existing Developed Basins

						100-Year, 6-hr.							
Basin	Area	Area	Treatment A		Treatment B		Treatment C		Treatment D		Weighted E	Volume	Flow
	(sf)	(acres)	%	(acres)	%	(acres)	%	(acres)	%	(acres)	(ac-ft)	(ac-ft)	cfs
EXISTING	17026	0.391	0%	0	0.0%	0.000	0.0%	0	100%	0.391	2.120	0.069	1.84
PROPOSED	17026	0.391	0%	0	0.0%	0.000	15.0%	0.05863	85%	0.332	1.972	0.064	1.75
HARVEST AREAS RETAINED	2557	0.059	0%	0	0.0%	0.038	100.0%	0.0587	0%	0.019	2.321	0.011	0.36
ALLOWABLE DISCHARGE													1.07

ALLOWABLE DISCHARGE

1.07

Equations:

ACTUAL DISCHARGE
1.39

Weighted  $E = Ea^*Aa + Eb^*Ab + Ec^*Ac + Ed^*Ad / (Total Area)$ 

Volume = Weighted D \* Total Area FIRST FLUSH VOLUME = 410 CF VOLUME PROVIDED 730 CF

Flow = Qa \* Aa + Qb \* Ab + Qc \* Ac + Qd \* Ad

Where for 100-year, 6-hour storm (zone 2)

Ea= 0.53 Qa= 1.57 Eb= 0.78 Qb= 2.28 Ec= 1.13 Qc= 3.14 Ed= 2.12 Qd= 4.7

#### **NARRATIVE**

THIS IS A REPAVING/ REPAIRE AN EXISTING INFILL LOT. THIS LOT WAS FULLY DEVELOPED IN THE PAST, BUT THE PAVMENT HAS BEEN DESINTIGRATED AND IS HARD PACKED TYPE D LAND TREATEMENT. WE ARE PROPOSING 730 CUBIC FEET OF FIRST FLUSH VOLUMES AND 15% DEPRESSED LANDSCAPE AREAS. THE IMPROVEMENTS WILL REDUCE DISCHARGE TO LESS THAN EXISTING, AND .32 CFS HIGHER THAN THE 2.75 CFS PER ACRE SPECIFIED IN THE NORTH VALLEY, SINCE THIS A REPAVE OF AN EXISTING PARKING FEEL A REDUCTION FROM HISTORICAL IS APPROPRIATE

## CITY OF ALBUQUERQUE



August 24, 2015

David Soule, P.E. Rio Grande Engineering PO Box 93924 Albuquerque, New Mexico 87199

RE:

Fruit Parking Lot 605 6<sup>th</sup> St NW Grading and Drainage Plan

Engineers Stamp Date 8/18/15 (J14D177)

Dear Mr. Soule,

Based upon the information provided in your submittal received 8/2/15, this plan is approved for Grading Permit and Paving Permit.

Please attach a copy of this approved plan to the construction sets in the permitting process prior to sign-off by Hydrology.

Prior to release of this site an As-build plan will be required with an Engineer Certification showing the new bottom of pond elevation.

Albuquerque

PO Box 1293

If you have any questions, please contact me at 924-3695 or Rudy Rael at 924-3977.

New Mexico 87103

www.cabq.gov

Sincerely,

Rita Harmon, P.E. Senior Engineer, Albuquerque

Planning Department

RR/RH C: File