CITY OF ALBUQUERQUE

Planning Department David S. Campbell, Director



Timothy M. Keller, Mayor

April 5, 2018

Reza Afaghpour, P.E. SBS Construction and Engineering 10209 Snowflake Ct., NW, Albuquerque, NM 87114

RE: Commercial Addition, Lot 5-A, 11-A, 13-A, & 15-A, Block 2 Grading and Drainage Plan Engineer's Stamp Date 3/28/2018 (J14D186)

Dear Mr. Afaghpour:

PO Box 1293

Based upon the information provided in your submittal received 3/30/2018, the above referenced plan is approved for Preliminary Plat and Work Order.

Albuquerque Please include the plan in the Work Order plan set and label the sheet "For Information Only". The construction plans must include more specific construction notes including, removal notes, inlet types, typical sections, and pipe lengths and slopes.

An Engineer Certification per the DPM checklist will be required prior to release of Financial Guarantees.

If you have any questions, you can contact me at 924-3986.

www.cabq.gov

NM 87103

Sincerely, amen 2

James D. Hughes, P.E. Principal Engineer, Planning Dept. Development Review Services

Orig: Drainage file




City of Albuquerque

Planning Department Development & Building Services Division DRAINAGE AND TRANSPORTATION INFORMATION SHEET (REV 10/2015)

Project Title: Lots 5-A, 11-A, 13-A, AND 15-A, BL	2 Commercial Add	Building Permit #: Hydrology File #: <u>J14D1</u>	86				
DRB#: <u>1011039</u>	EPC#:	Work Order#:					
Legal Description: Lots 5-A, 11-A, 13-A, AND 15-A, BLOCK 2, Commercial Addition							
City Address: 523-573 Commercial St., NE	, <u> </u>						
Applicant: SBS CONSTRUCTION AND ENGI	Contact: SHAWN BIAZA	<u>R</u>					
Address: 10209 SNOWFLAKE CT., NW, A	LBUQUERQUE	E, NM 87114					
Phone#: (505)804-5013	_ Fax <u>#: (505)897-</u> 4	996 E-mail: <u>AECLLC@AOL.C</u>	COM				
Other Contact:		Contact:					
Address:							
		E-mail:					
Check all that Apply:							
DEPARTMENT:		TYPE OF APPROVAL/ACCEPTANCE SOUGHT	:				
X HYDROLOGY/ DRAINAGE		BUILDING PERMIT APPROVAL	-				
TRAFFIC/ TRANSPORTATION MS4/ EROSION & SEDIMENT CONTROL	T.	CERTIFICATE OF OCCUPANCY					
		PRELIMINARY PLAT APPROVAL					
ENGINEER/ARCHITECT CERTIFICATIO	N	SITE PLAN FOR SUB'D APPROVAL					
CONCEPTUAL G & D PLAN		SITE PLAN FOR BLDG. PERMIT APPROVA FINAL PLAT APPROVAL					
X GRADING PLAN		FINAL PLAT APPROVAL					
DRAINAGE MASTER PLAN		SIA/ RELEASE OF FINANCIAL GUARANTE	Е				
DRAINAGE REPORT			ON PERMIT APPROVAL				
CLOMR/LOMR		GRADING PERMIT APPROVAL					
		SO-19 APPROVAL					
TRAFFIC CIRCULATION LAYOUT (TCL	IRCULATION LAYOUT (TCL) PAVING PER						
TRAFFIC IMPACT STUDY (TIS)		GRADING/ PAD CERTIFICATION					
EROSION & SEDIMENT CONTROL PLA	N (ESC)	X WORK ORDER APPROVAL					
OTHER (SPECIFY)		CLOMR/LOMR					
	-	PRE-DESIGN MEETING?					
IS THIS A RESUBMITTAL?: <u>X</u> Yes <u>N</u>	ō	OTHER (SPECIFY)					
DATE SUBMITTED: <u>3-30-2018</u> By: <u>SHAWN BIAZAR</u>							

COA STAFF: ELECTRONIC SUBMITTAL RECEIVED: ____

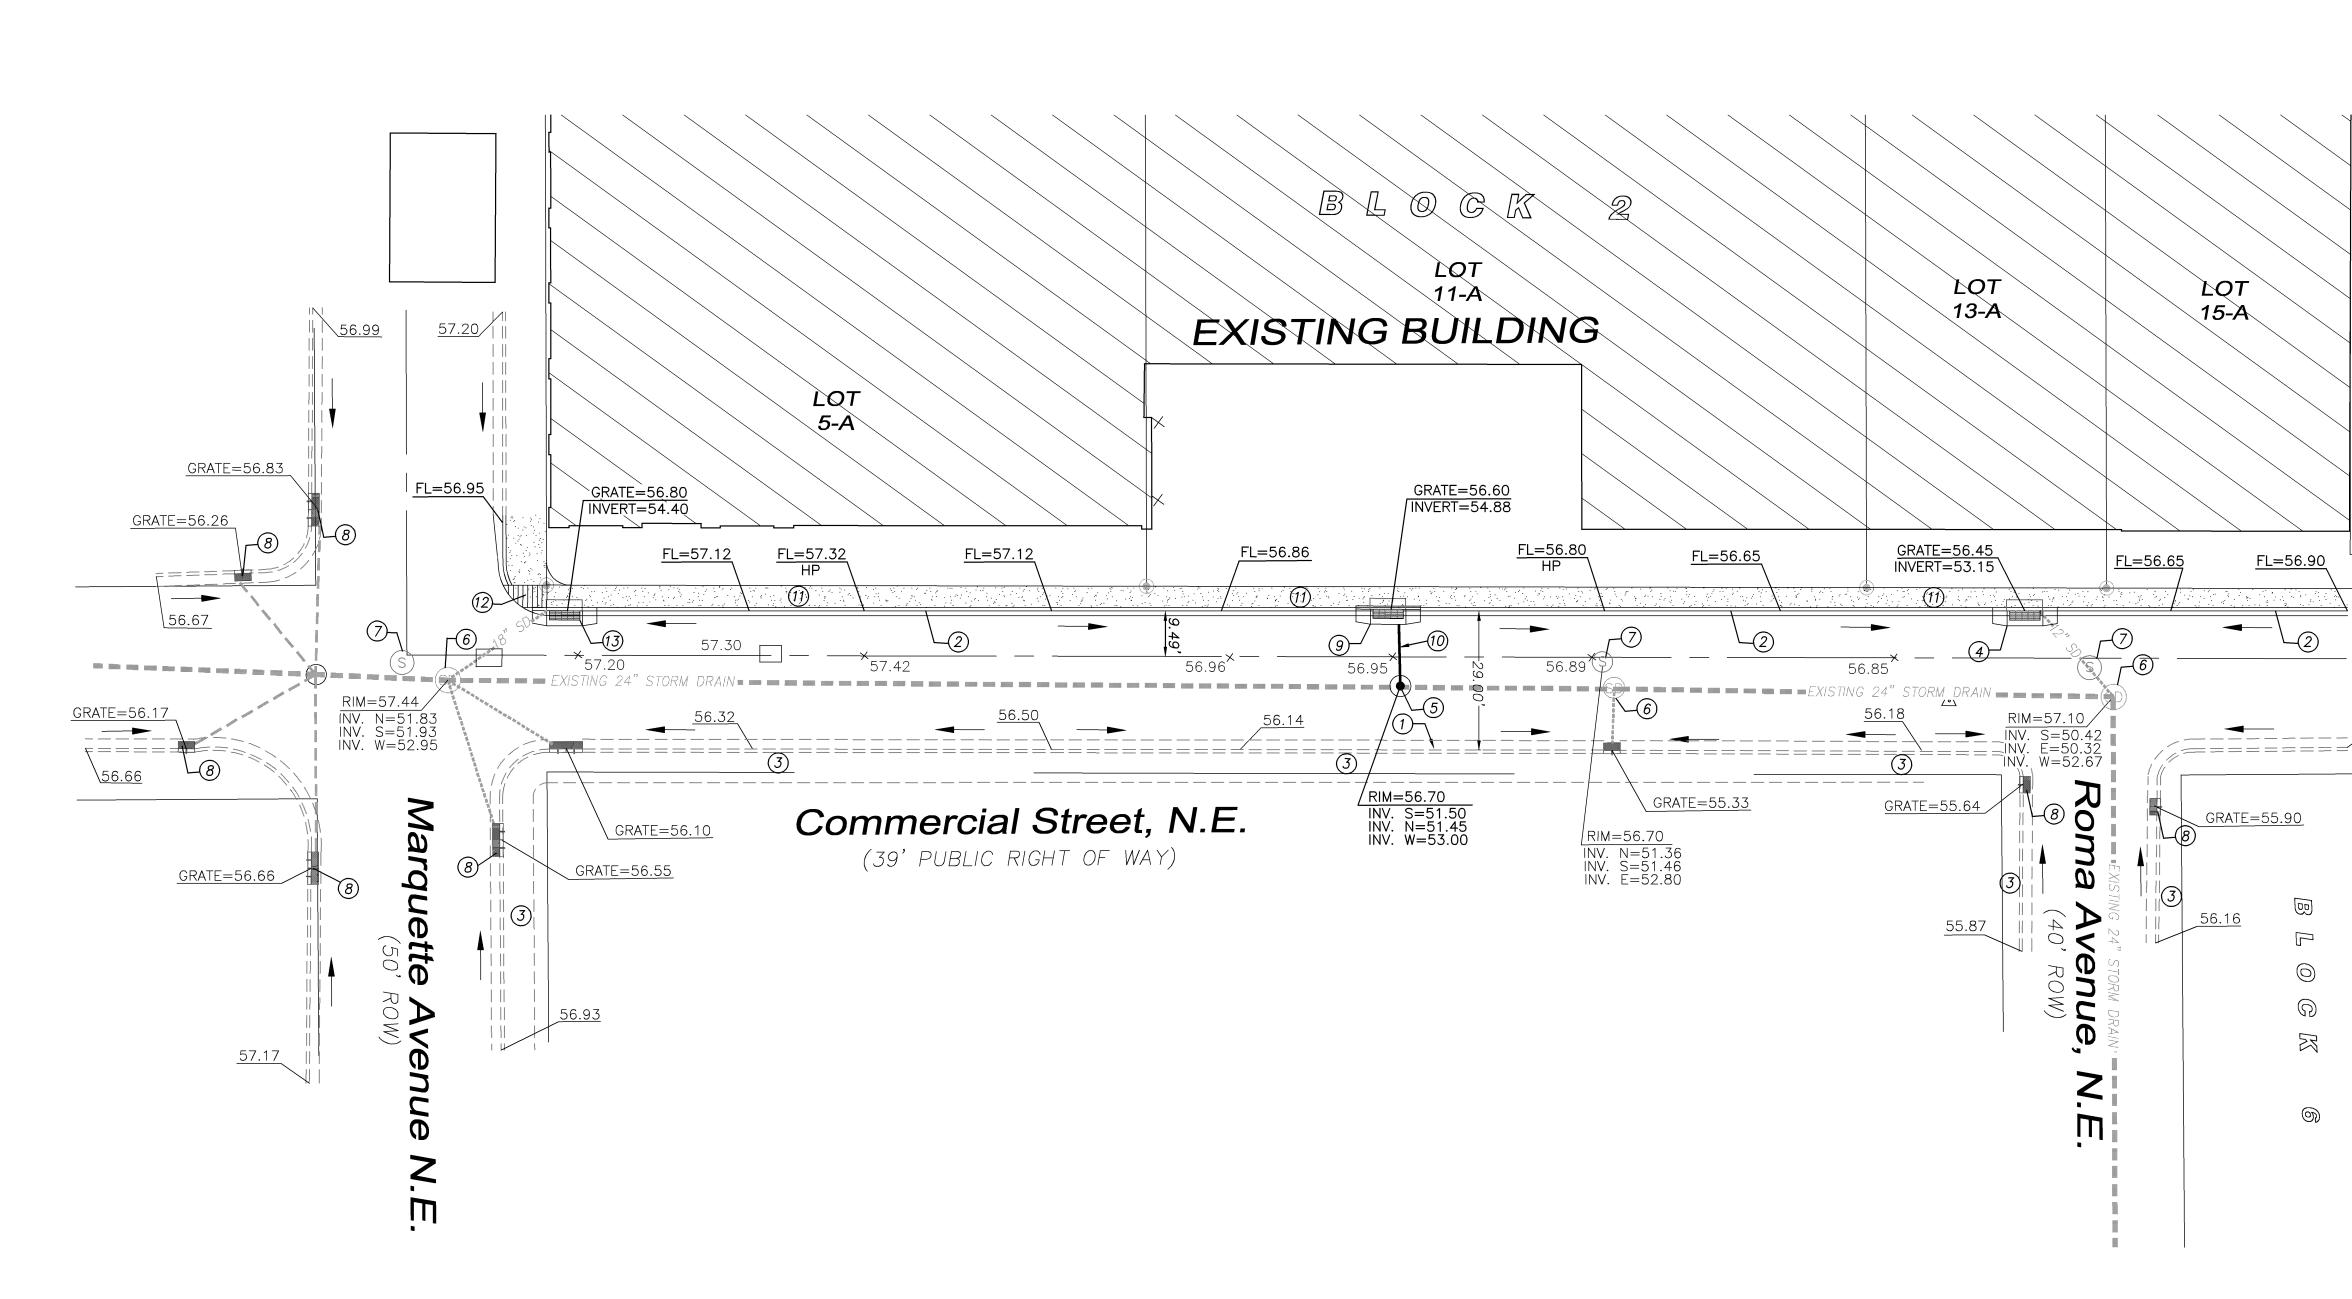

Location

LOT'S 5-A, 11-A, 13-A AND 15-A, BLOCK 2, COMMERCIAL ADDITION is located at 523-573 Commercial Street NE, containing 1.3776 acre. See attached portion of Vicinity Map J-14-Z for exact location.

Purpose

The purpose of this grading plan is to show the proposed curb and gutter for Commercial Street, NE with seven (7') vacated right-of-way on the west side and present the new grades for the new proposed street section.

Existing Drainage Conditions

The water currenly drains from center of Commercial Street to the west and east and into existing drop inlets alon the street. There are no other off-site water entering this portion of the street. There are existing drop inlets basically on each intersection, please see grading plan for reference.

Proposed Conditions


We are not changing any drainage patterns on Commercial Street. This grading plan is showing the new curb and gutter along the west side of street for the seven (7') feet vacated portion of Commercial Street, NE. We are relocationg the existing two drop inlets along the west side and constructing a new one.

) NOTES:

- 1. EXISTING STANDARI
- 2. PROPOSED MEDIAN
- 3. EXISTING SIDEWALK
- 4. PROPOSED DROP
- 5. PROPOSED STORM
- 6. EXISTING STORM SI
- 7. EXISTING SANITARY
- 8. EXISTING DROP INL
- 9. PROPOSED DROP
- 10. PROPOSED 12" ST
- 11. PROPOSED SIDEW
- 12. PROPOSED WHEEL
- 13. PROPOSED DROP

RD CURBA AND GUTTER.
N CURB.
K.
INLET SINGLE "C" PER CITY STANDARD DWG. # 2205.
1 DRAIN MANHOLE WITH GRATE RIM.
SEWER MANHOLE TYP.
Y SEWER MANHOLE, TYP.
ILET, TYP.
INLET SINGLE "D" PER CITY STANDARD DWG. # 2206.
STORM DRAIN
/ALK
LCHAIR RAMP
INLET DOUBLE "C" PER CITY STANDARD DWG. # 2205.


LEGEND	
S	EXISTING SAS MANHOLE
SD	EXISTING SD MANHOLE
EX. 24" SD	EXISTING STORM SEWER
——EX. 8" SAS——	EXISTING SANITARY SEWER L
	NEW CATCH BASIN
$\textcircled{\bullet}$	PROPOSED STORM DRAIN MA
<u>FL=75.65</u>	PROPOSED FLOWLINE ELEVA
X 86.65	EXISTING CENTERLINE GRADE
<u>56.50</u>	EXISTING FLOWLINE ELEVATION
HP	HIGH POINT
86.65 85.47	AS-BUILT GRADES
X 86.65	AS-BUILT SPOT ELEVATIONS

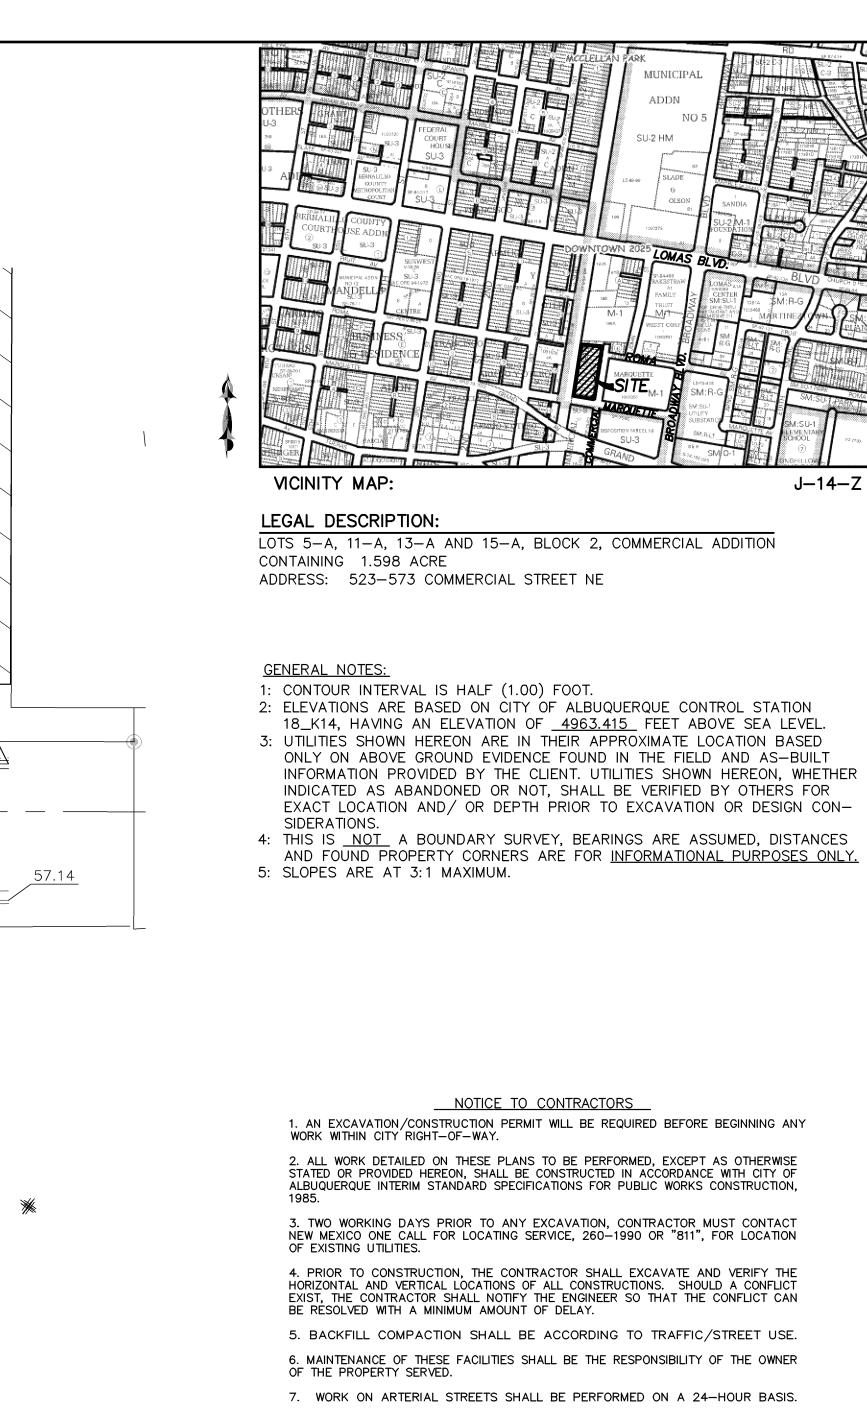

LINE

MANHOLE ATION DE TION

S

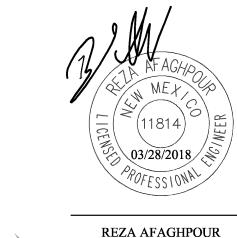

P.E. #11814



10209 SNOWFLAKE CT., NW ALBUQUERQUE, NEW MEXICO 87114 (505)899-5570

GRAPHIC SCALE	Lots 5-A, 11-A, 13-A and 15-A, Block 2 Commercial Addition GRADING PLAN				
	DRAWING:	DRAWN BY:	DATE:	SHEET #	
SCALE: 1"=20'	201622-GD.DWG	SH-B	3/25/2017		
	1		1		