
CITY OF ALBUQUERQUE

Planning Department Alan Varela, Director

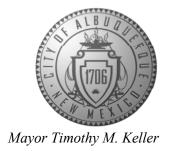

January 9, 2024

Shawn Biazar SBS Construction and Engineering, LLC 10209 Snowflake Ct. NW Albuquerque, NM 87114

RE: 911 Franciscan St NE

Grading & Drainage Plan

Engineer's Stamp Date: 12/11/23

Hydrology File: J14D207

Dear Mr. Biazar:

PO Box 1293

Based upon the information provided in your submittal received 01/03/2024, the Grading and Drainage Plan is approved for Building Permit and Grading Permit. Since this site is relatively flat, a pad certification is not needed for this project. Please attach a copy of this approved plan in the construction sets for Building Permit processing along with a copy of this letter.

Albuquerque

PRIOR TO CERTIFICATE OF OCCUPANCY:

NM 87103

1. Engineer's Certification, per the DPM Part 6-14 (F): Engineer's Certification Checklist For Non-Subdivision is required.

If you have any questions, please contact me at 924-3995 or <u>rbrissette@cabq.gov</u>.

www.cabq.gov

Sincerely,

Renée C. Brissette, P.E. CFM Senior Engineer, Hydrology Planning Department

Renée C. Brissette



City of Albuquerque

Planning Department

Development & Building Services Division

DRAINAGE AND TRANSPORTATION INFORMATION SHEET (REV 6/2018)

Project Title: 911 FRANCISCAN ST., NE	Building Permit #:	Hydrolo	Hydrology File #:	
DRB#:	EPC#:	Work C	Work Order#:	
Legal Description: LOTS 21 AND 22, BLOCK	3, MAYOAND ROSS ADDITIO	N		
City Address: 8035 KIBO, NW				
Applicant: SBS CONSTRUCTION AND EN Address: 7632 WILLIAM MOYERS AVE., NE, A		Contact:	SHAWN BIAZAR	
Phone#: (505) 804-5013		AECLLC@AOL.COM		
Other Contact:				
Address:Phone#:				
TYPE OF DEVELOPMENT: PLATIS THIS A RESUBMITTAL? Yes	(# of lots) X RESI			
DEPARTMENT TRANSPORTATION	X HYDROLOG	Y/DRAINAGE		
Check all that Apply: TYPE OF SUBMITTAL: ENGINEER/ARCHITECT CERTIFICATION PAD CERTIFICATION CONCEPTUAL G & D PLAN X GRADING PLAN DRAINAGE REPORT DRAINAGE MASTER PLAN FLOODPLAIN DEVELOPMENT PERMIT ELEVATION CERTIFICATE CLOMR/LOMR TRAFFIC CIRCULATION LAYOUT (TC) TRAFFIC IMPACT STUDY (TIS) STREET LIGHT LAYOUT OTHER (SPECIFY) PRE-DESIGN MEETING?	APPLIC X	TYPE OF APPROVAL/ACCEPTANCE SOUGHT: X BUILDING PERMIT APPROVAL CERTIFICATE OF OCCUPANCY PRELIMINARY PLAT APPROVAL SITE PLAN FOR SUB'D APPROVAL SITE PLAN FOR BLDG. PERMIT APPROVAL FINAL PLAT APPROVAL SIA/ RELEASE OF FINANCIAL GUARANTEE FOUNDATION PERMIT APPROVAL X GRADING PERMIT APPROVAL SO-19 APPROVAL PAVING PERMIT APPROVAL GRADING/ PAD CERTIFICATION WORK ORDER APPROVAL CLOMR/LOMR FLOODPLAIN DEVELOPMENT PERMIT OTHER (SPECIFY)		
DATE SUBMITTED: 1-2-2024	By: SHAWN BI			
COA STAFF:	ELECTRONIC SUBMITTA	AL RECEIVED:		

FEE PAID:____

Location

Lots 21 and 22, Block 3, Mayo and Ross Addition is located at 119 Franciscan St., NE, Albuquerque NM 87102. See attached portion of Vicinity Map J-14-Z for exact location.

Purpose

The purpose of this drainage report is to present a grading and drainage solution for the proposed buildings.

Existing Drainage Conditions

This lot is very flat and drains from east to west. No offsite runoff enters this site. There was existing house that was removed for a new construction.

Proposed Conditions and On-Site Drainage Management Plan

The drainage patterns will remain the same. The additional runoff volume generated by this project garage will be retained on site. The total volume requirement under proposed conditions is 641.37 cf based on the 100-yr/10-day volume. Retention volume provided is 729.00 cf. First Volume requirement is (0.42/12*3,195.00) 111.83 cf.

VOLUME CALCULATIONS FOR 10 DAY STORM

		, ,	, ,	, ,			
	ON-SITE	7,100.00	0.1630	0.007375			
E = EA(AA) + EB(AB) + EC(AC) + ED(AD)							

AA + AB + AC + AD

V-360 = E(AA + AB + AC + AD)

BASIN AREA (SF) AREA (AC) AREA (MI²)

EA = 0.62

EB = 0.80

EC = 1.03

ED = 2.33

P-60 = 1.78P-360 = 2.29

P-1440 = 2.59

P-10 Day = 3.62

AD = 25.00%

EXISTING CONDITIONS

AA = 55.00%AA = 0.00%AB = 10.00%AB = 10.00%AC = 10.00%AC = 45.00%

1.1065 IN $\mathbf{E} =$

V-360 =

 $0.0155 \text{ AC-FT } (654.68 \text{ CF}) \quad \text{V-}360 =$

AD =

V-10 DAY = 869.75 CF

0.0407 AC AD =

AD = 45.00%

0.0216 AC-FT (941.93 CF) 0.0733 AC V-10 DAY = 1,296.05 CF

1.5290 IN

PROPOSED CONDITIONS

V (REQUIRED) =941.93 - 654.68 = 287.25 CF USING V-360 V (REQUIRED) = 1,296.05 - 654.68 = 641.37 CF USING V-10 DAY

PONDING VOLUME CALCULATION

POND A


BOTTOM AREA (@ 4957.00)= 654.68 SF TOP AREA (94958.00) = 1296.05 SF


DEPTH = 1.00

POND VOLUME=(1296.05+654.68)/2*1.00

total POND VOLÙME=729.00 CF

FRANCISCAN ST., N.E.

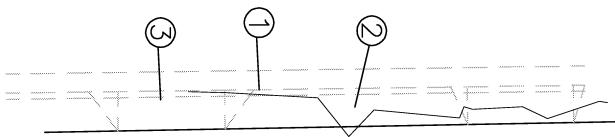

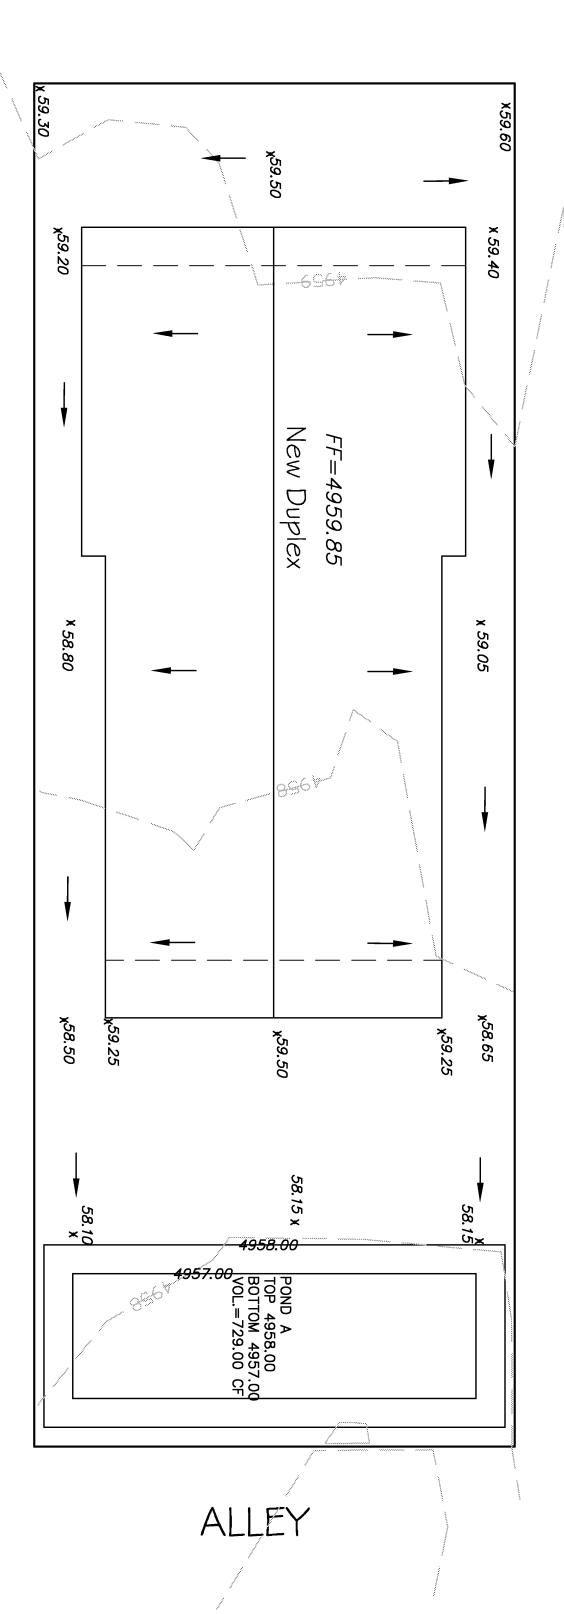

GENERAL NOTES:

- 1: CONTOUR INTERVAL IS ONE (1.00) FOOT.
- 2: ELEVATIONS ARE BASED ON CITY OF ALBUQUERQUE CONTROL STAT ION 22_J14, HAVING AN ELEVATION OF 4973.647 FEET ABOVE SEA LEVEL.
- 3: UTILITIES SHOWN HEREON ARE IN THEIR APPROXIMATE LOCATION BASED ONLY ON ABOVE GROUND EVIDENCE FOUND IN THE FIELD AND AS-BUILT INFORMATION PROVIDED BY THE CLIENT. UTILITIES SHOWN HEREON, WHETHER INDICATED AS ABANDONED OR NOT, SHALL BE VERIFIED BY OTHERS FOR EXACT LOCATION AND / OR DEPTH PRIOR TO EXCAVATION OR DESIGN CON-SIDERATIONS. A BOUNDARY SURVEY, BEARINGS ARE ASSUMED, DISTANCES %%U
- 4: THIS IS UINFORMATIONAL PURPOSES ONLY AND FOUND PROPERTY CORNERS
- 5: SLOPES ARE AT 3:1 MAXIMUM.

NOTICE TO CONTRACTORS

1. AN EXCAVATION/CONSTRUCTION PERMIT WILL BE REQUIRED BEFORE BEGINNING ANY WORK WITHIN CITY RIGHT-OF-WAY.

2. ALL WORK DETAILED ON THESE PLANS TO BE PERFORMED, EXCEPT AS OTHERWISE STATED OR PROVIDED HEREON, SHALL BE CONSTRUCTED IN ACCORDANCE WITH CITY OF ALBUQUERQUE INTERIM STANDARD SPECIFICATIONS FOR PUBLIC WORKS CONSTRUCTION,

3. TWO WORKING DAYS PRIOR TO ANY EXCAVATION, CONTRACTOR MUST CONTACT LINE LOCATING SERVICE, 765-1234, FOR LOCATION OF EXISTING UTILITIES.

4. PRIOR TO CONSTRUCTION, THE CONTRACTOR SHALL EXCAVATE AND VERIFY THE HORIZONTAL AND VERTICAL LOCATIONS OF ALL CONSTRUCTIONS. SHOULD A CONFLICT EXIST, THE CONTRACTOR SHALL NOTIFY THE ENGINEER SO THAT THE CONFLICT CAN BE RÉSOLVED WITH A MINIMUM AMOUNT OF DELAY.


- 5. BACKFILL COMPACTION SHALL BE ACCORDING TO TRAFFIC/STREET USE. 6. MAINTENANCE OF THESE FACILITIES SHALL BE THE RESPONSIBILITY OF THE OWNER OF THE PROPERTY SERVED.
- 7. WORK ON ARTERIAL STREETS SHALL BE PERFORMED ON A 24-HOUR BASIS.

OKEYED NOTES:

- 1. EXISTING CURB & GUTTER.
- 2. EXISTING SIDEWALK.
- 3. EXISTING DRIVEWAY.


HYDROLOGY SECTION APPROVED 01/09/24

PPROVAL OF GRADING & DRAINAGE PLAN(S) SHALL EXPIR WO (2) YEARS AFTER THE APPROAL DATE BY THE CITY IF NO ILDING PERMIT HAS BEEN PULLED ON THE DEVELOPMEN

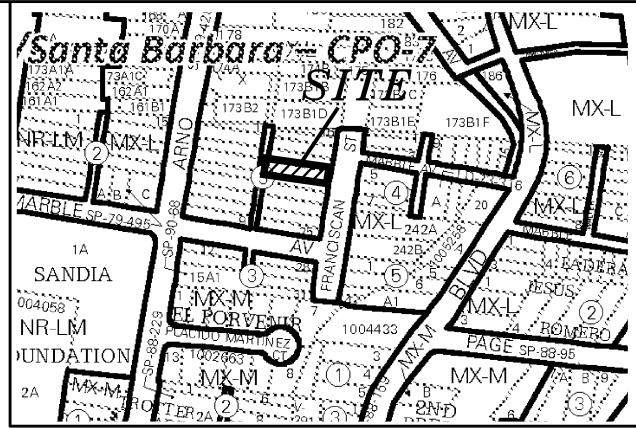

VICINITY MAP:

J-14-Z

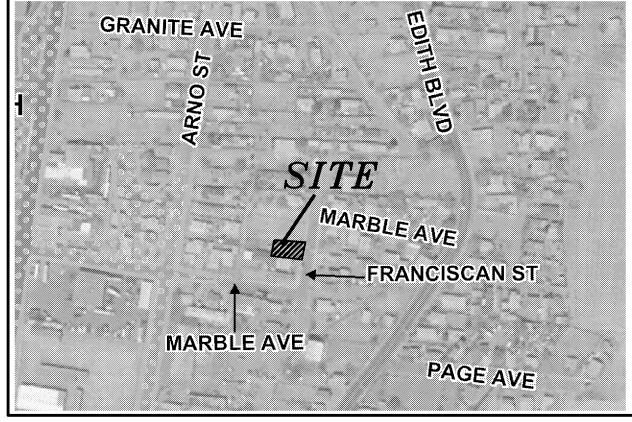

FIRM MAP:

35001C0334G

LEGAL DESCRIPTION:

LOT 21 AND 22, BLOCK 3, MAYO AND ROSS ADDITION. ADDRESS: 911 FRANCISCAN ST., NE, ALBUQUERQUE, NM 87102

BENCH MARK

CITY OF ALBUQUERQUE MON. 22_J14, HAVING AN ELEVATION OF 4973.647 FEET

LEGEND

TF = 42.00

X81.65

______ EXISTING CONTOUR (MAJOR) EXISTING CONTOUR (MINOR) **BOUNDARY LINE** PROPOSED SPOT ELEVATION X 42.70 EXISTING GRADE **★** 5029.16 EXISTING FLOWLINE ELEVATION × 5075.65 PROPOSED RETAINING WALL BC = 41.30BOTTOM OF CHANEL

TOP OF FOOTING

AS-BUILT SPOT ELEVATIONS

TRW=45.12 TOP OF RETAINING WALL HIGH POINT

5181.13 *5180.65* AS-BUILT GRADES



REZA AFAGHPOUR P.E. #11814

SCALE: 1"=10'

GRAPHIC SCALE

911 FRANCISCAN ST., NE

GRADING PLAN DRAWN BY: DATE: DRAWING: SHEET# 202138GD.DWG SH-B 12-11-2023