


CONSTRUCTION NOTES:

- TWO (2) WORKING DAYS PRIOR TO ANY EXCAVATION, CONTRACTOR MUST CONTACT NEW MEXICO ONE CALL SYSTEM 260-1990 FOR DESIGNATION (LINE-SPOTTING) OF EXISTING PUBLIC UTILITIES AND EXISTING UTILITIES OWNED AND OPERATED BY ALBUQUERQUE PUBLIC SCHOOLS.
- PRIOR TO CONSTRUCTION, THE CONTRACTOR SHALL EXCAVATE AND VERIFY THE HORIZONTAL AND VERTICAL LOCATION OF ALL POTENTIAL OBSTRUCTIONS. SHOULD A CONFLICT EXIST, THE CONTRACTOR SHALL NOTIFY THE ENGINEER IN WRITING SO THAT THE CONFLICT CAN BE RESOLVED WITH A MINIMUM AMOUNT OF DELAY. THE CONTRACTOR SHALL BE RESPONSIBLE FOR ALL INTERPRETATIONS IT MAKES WITHOUT FIRST CONTACTING THE ENGINEER AS
- ALL WORK ON THIS PROJECT SHALL BE PERFORMED IN ACCORDANCE WITH APPLICABLE FEDERAL, STATE AND LOCAL LAWS, RULES AND REGULATIONS CONCERNING CONSTRUCTION
- ALL CONSTRUCTION WITHIN PUBLIC RIGHT-OF-WAY SHALL BE PERFORMED IN ACCORDANCE WITH APPLICABLE CITY OF ALBUQUERQUE STANDARDS AND PROCEDURES.
- IF ANY UTILITY LINES, PIPELINES, OR UNDERGROUND UTILITY LINES ARE SHOWN ON THESE DRAWINGS, THEY ARE SHOWN IN AN APPROXIMATE MANNER ONLY, AND SUCH LINES MAY EXIST WHERE NONE ARE SHOWN. IF ANY SUCH EXISTING LINES ARE SHOWN, THE LOCATION S BASED UPON INFORMATION PROVIDED BY THE OWNER OF SAID UTILITY, AND THE INFORMATION MAY BE INCOMPLETE, OR MAY BE OBSOLETE BY THE TIME CONSTRUCTION COMMENCES. THE ENGINEER HAS CONDUCTED ONLY PRELIMINARY INVESTIGATION OF THE LOCATION, DEPTH, SIZE, OR TYPE OF EXISTING UTILITY LINES, PIPELINES, OR UNDERGROUND UTILITY LINES. THIS INVESTIGATION IS NOT CONCLUSIVE, AND MAY NOT BE COMPLETE, THEREFORE, MAKES NO REPRESENTATION PERTAINING THERETO, AND ASSUMES NO RESPONSIBILITY OR LIABILITY THEREFOR. THE CONTRACTOR SHALL INFORM ITSELF OF THE LOCATION OF ANY UTILITY LINE, PIPELINE, OR UNDERGROUND UTILITY LINE IN OR NEAR THE AREA OF THE WORK IN ADVANCE OF AND DURING EXCAVATION WORK. THE CONTRACTOR IS FULLY RESPONSIBLE FOR ANY AND ALL DAMAGE CAUSED BY ITS FAILURE TO LOCATE, IDENTIFY AND PRESERVE ANY AND ALL EXISTING UTILITIES, PIPELINES, AND UNDERGROUND UTILITY LINES. IN PLANNING AND CONDUCTING EXCAVATION, THE CONTRACTOR SHALL COMPLY WITH STATE STATUTES, MUNICIPAL AND LOCAL ORDINANCES, RULES AND REGULATIONS, IF ANY, PERTAINING TO THE LOCATION OF THESE LINES AND FACILITIES.

EROSION CONTROL MEASURES:

- THE CONTRACTOR SHALL ENSURE THAT NO SOIL ERODES FROM THE SITE INTO PUBLIC RIGHT-OF-WAY OR ONTO PRIVATE PROPERTY.
- THE CONTRACTOR SHALL PROMPTLY CLEAN UP ANY MATERIAL EXCAVATED WITHIN THE PUBLIC RIGHT-OF-WAY SO THAT THE EXCAVATED MATERIAL IS NOT SUSCEPTIBLE TO BEING WASHED
 - WHEN APPLICABLE, CONTRACTOR SHALL SECURE "TOPSOIL DISTURBANCE PERMIT" FROM THE CITY AND/OR FILE A NOTICE OF INTENT (N.O.I.) WITH THE EPA PRIOR TO BEGINNING

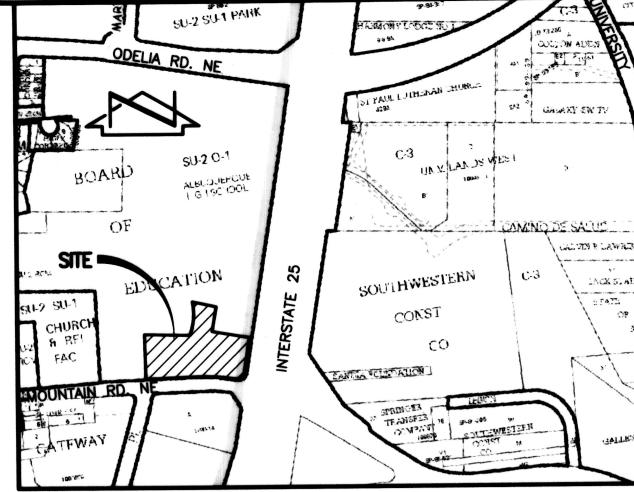

VICINITY MAP

SCALE: 1'' = 750'

J - 15



F.I.R.M. SCALE: 1" = 500'

825 332 of DATE: 9-26-2008

LEGAL DESCRIPTION

UNPLATTED TRACTS; SITE LOCATED WITHIN PROJECTED SECTION 16, TOWNSHIP 10 NORTH, RANGE 3 EAST, N.M.P.M. (TOWN OF ALBUQUERQUE GRANT).

BENCHMARKS

PROJECT BENCHMARK

CITY OF ALBUQUERQUE SURVEY CONTROL 3 1/4" ALUMINUM DISK STAMPED "9-J15 1990", RIVETED TO AN ALUMINUM TUBE PROJECTING 0.25' ABOVE GRADE ON THE NORTH SIDE OF LOMAS BLVD. N.E. APPROXIMATELY 244' WEST OF THE INTERSECTION WITH LEGION ROAD N.E. ELEVATION = 5093.057 FEET (NAVD 88)

TEMPORARY BENCHMARK #1 (T.B.M.)

A #5 REBAR WITH CONTROL CAP STAMPED "HMCG CONTROL NMPS 11184", IN THE SOUTHEASTERN PORTION OF THE SITE, AS SHOWN ON SHEET 2. ELEVATION = 5043.15 FEET (NAVD 88)

TEMPORARY BENCHMARK #2 (T.B.M.)

A #5 REBAR WITH CONTROL CAP STAMPED "HMCG CONTROL NMPS 11184", IN THE NORTHWESTERN PORTION OF THE SITE, AS SHOWN ON SHEET 2. ELEVATION = 5026.87 FEET (NAVD 88)

RECORD DRAWING

2013.184.2

MESA\Consulting Group

6010-B MIDWAY PARK BLVD. NE . ALBUQUERQUE, NEW MEXICO 87109

PHONE: 505.345.4250 • FAX: 505.345.4254 • www.highmesacg.com

DRAINAGE PLAN AND CALCULATIONS PORTABLE CLASSROOM RELOCATIONS CAREER ENRICHMENT CENTER 807 MOUNTAIN ROAD N.E.

13 OB/14 J.G.M. CORRECT 2-YEAR VOLUME CALC 06-2014 DRAWN BY APPROVED BY J.G.M.

 $((0.00^{\circ}0.53) + (0.00^{\circ}0.78) + (0.04^{\circ}1.13) + (0.42^{\circ}2.12))/0.46 = 2.03 \text{ IN}$

-930 CF (DECREASE)

-0.4 CFS (DECREASE)

0.0 CFS (NO CHANGE)

30 CF (NEGLIGIBLE INCREASE)

3,390 CF

2.1 CFS

(2.03/12)0.46 = 0.0778 AC-FT =

 $V_{100} = (E_W/12)A_T =$

b. PEAK DISCHARGE

 $\Delta Q_{100} = 2.1 - 2.1 =$

 $V_{POND} = 22,630 \text{ CF} >> V_{2 DEV} = 380 \text{ CF} : OK$

 V_{POND} = 22,630 CF >> $V_{100 DEV}$ = 4,030 CF $\therefore V_{POND}$ = 5X $V_{100 DEV}$

WSL @ V_{100 DEV} = 5022.5 (5022.5 - 5022.0 = 0.5' = 6" DEEP)

CONFERENCE RECAP

DATE: 04-30-2014 DRAINAGE FILE/ZONE ATLAS PAGE NUMBER: <u>J15/D001</u> CROSS REFERENCE NUMBERS: EPC_ _ DRB_ DRC SUBJECT: PORTABLE CLASSROOM RELOCATIONS STREET ADDRESS: 807 MOUNTAIN ROAD NE SUBDIVISION NAME: UNPLATTED LANDS OF APS KNOWN AS ALBUQUEROUE HIGH SCHOOL SITE

TYPE OF APPROVAL

PRELIMINARY PLAT FINAL PLAT SITE DEVELOPMENT PLAN _ BUILDING PERMIT OTHER **ROUGH GRADING**

ATTENDEE: **CURTIS CHERNE** JEFF MORTENSEN

ORGANIZATION: HYDROLOGY **HMCG**

PHONE: 924-3986 345-4250


FINDINGS:

- 1. BACKGROUND PORTABLE CLASSROOM BUILDINGS MUST BE RELOCATED ON THE SITE IN ADVANCE OF A PERMANENT BUILDING ADDITION ON THE WEST SIDE OF THE EXISTING BUILDING.
- 2. SEPARATE DRAINAGE SUBMITTALS ARE REQUIRED FOR THE PORTABLE BUILDING RELOCATIONS AND THE PERMANENT CLASTOOM BUILDING
- 3. THE RELOCATION OF THE PORTABLE BUILDINGS IS TEMPORARY UNTIL THE NEW BUILDING IS COMPLETE AFTER WHICH THE PORTABLES WILL BE RELOCATED OFF SITE.
- 4. LID FEATURES ARE NOT REQUIRED FOR THE PORTABLE CLASSROOM BUILDING RELOCATION PROJECT AS IT IS TEMPORARY AND THE BUILDINGS WILL LIKELY BE PLACED IN AN EXISTING PAVED AREA ON THE ALBUQUERQUE HS PORTION OF THE OVERALL PROPERTY. THE PERMANENT BUILDING PROJECT WILL NEED TO ADDRESS LONGTERM LID REQUIREMENTS (SEPARATE SUBMITTAL AS REFERENCED ABOVE).
- 5. SEPARATE GRADING AND DRAINAGE PLANS REQUIRED FOR BUILDING PERMIT APPROVALS.
- 6. REFERENCE DRAINAGE MASTER PLAN FOR SITE PREPARED BY HMCG DATED 07-27-2008. ADDRESS HOW PROPOSED PORTABLE RELOCATION PLAN COMPLIES WITH DRAINAGE MASTER PLAN ON A BASIN BY BASIN BASIS (I.E. AFFECTED BASINS ONLY).
- 7. VERIFICATION OF DOWNSTREAM CAPACITY NOT REQUIRED HOWEVER SHOULD BE ADDRESSED QUALITATIVELY (I.E. MUST COMPLY WITH THE MDP DRAINAGE CONCEPT OF REDUCING DISCHARGE FROM THE SITE)
- 8. IF THE PROJECT DISTURBS GREATER THAN ONE ACRE OF LAND, AN EROSION AND SEDIMENT CONTROL PLAN IS REQUIRED AS A CONDITION FOR BUILDING PERMIT APPROVAL. THIS IS A SEPARATE SUBMITTAL IN ADDITION TO THE GRADING AND DRAINAGE PLAN FOR BUILDING PERMIT.
- 9. BMPS ARE REQUIRED TO MITIGATE THE DISCHARGE OF SEDIMENT FROM THE EXISTING PORTABLE FOR THE INTERIM TIME PERIOD UNTIL THE BUILDING PERMIT FOR THE PERMANENT BUILDING IS ISSUED.
- 10. ABOVE REFERENCED BMPS CAN CONSIST OF SILT FENCE, WADDLES AND EARTHEN BERMS
- 11. SUPPORTING CALCULATIONS REQUIRED TO DEMONSTRATE RUNOFF FROM THE 2-YEAR EVENT CAN BE CONTAINED

THE UNDERSIGNED AGREE THAT THE ABOVE FINDINGS ARE SUMMARIZED ACCURATELY AND ARE ONLY SUBJECT TO CHANGE IF FURTHER INVESTIGATION REVEALS THAT THE FINDINGS ARE NOT REASONABLE OR THAT THEY ARE BASED UPON INACCURATE INFORMATION.

SIGNED: Link & Colom TITLE: HYDROLOGY (COA) DATE: 5-29-14

NOTE: PROVIDE A COPY OF THIS RECAP WITH DRAINAGE SUBMITTAL

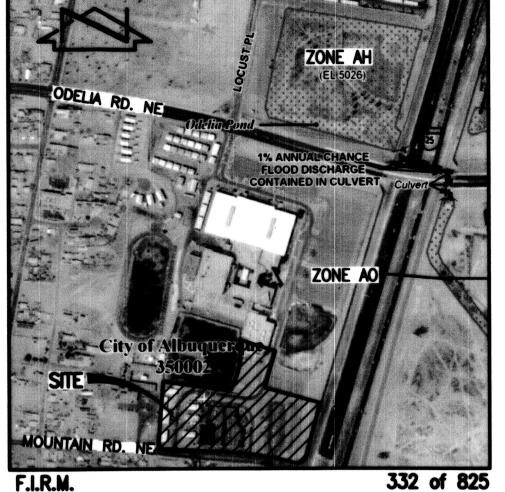

SCALE: 1" = 500"

ENGINEER'S DRAINAGE CERTIFICATION FOR TEMPORARY C.O.

I, JEFFREY G. MORTENSEN, NMPE 8547, OF THE FIRM HIGH MESA CONSULTING GROUP,

HEREBY CERTIFY THAT THIS PROJECT HAS BEEN GRADED AND DRAINED IN SUBSTANTIAL

COMPLIANCE WITH AND IN ACCORDANCE WITH THE DESIGN INTENT OF THE APPROVED

PLAN DATED 06/27/2014 WITH EXCEPTIONS AS NOTED BELOW. THE RECORD

INFORMATION EDITED ONTO THE ORIGINAL DESIGN DOCUMENT HAS EITHER BEEN OBTAINED

BY ME OR UNDER MY DIRECT SUPERVISION AS SUPPLEMENTAL SITE DATA COMBINED WITH

RECORD INFORMATION OBTAINED FROM THE VERIFICATION SURVEY CONDUCTED 08/04/2014 AND 08/05/2009 UNDER THE DIRECT SUPERVISION OF CHARLES G. CALA,

JR., NMPS 11184, OF THE FIRM HIGH MESA CONSULTING GROUP, AND IS TRUE AND

CORRECT TO THE BEST OF MY KNOWLEDGE AND BELIEF. THIS CERTIFICATION IS SUBMITTED

THE FOLLOWING EXCEPTIONS ARE NOTED AS THE RESULT OF VISUAL SITE INSPECTIONS

1. THE STORMWATER RETENTION/SEDIMENT DETENTION POND HAS NOT BEEN GRADED.

2. WADDLES WERE NOT INSTALLED. INSTEAD, SEDIMENT WAS SWEPT AND/OR OTHERWISE

THE RECORD INFORMATION PRESENTED HEREON IS NOT NECESSARILY COMPLETE AND

INTENDED ONLY TO VERIFY SUBSTANTIAL COMPLIANCE OF THE GRADING AND DRAINAGE

ASPECTS OF THIS PROJECT. THIS CERTIFICATION DOES NOT ADDRESS ADA COMPLIANCE

WHICH IS BEYOND THE SCOPE OF GRADING AND DRAINAGE. THOSE RELYING ON THIS

RECORD DOCUMENT ARE ADVISED TO OBTAIN INDEPENDENT VERIFICATION OF ITS ACCURACY BEFORE USING IT FOR ANY OTHER PURPOSE. A SEPARATE CERTIFICATION IS

MANAGED TO PREVENT TRACKING AND AVOID DISCHARGE FROM THE SITE.

REQUIRED TO SUPPORT A REQUEST FOR PERMANENT CERTIFICATE OF OCCUPANCY.

GRADING IS PENDING REMOVAL AND RELOCATION OF THE EXISTING UTILITIES WITHIN


IS SUPPORT OF A REQUEST FOR TEMPORARY CERTIFICATE OF OCCUPANCY.

CONDUCTED 08-25-2014 AND 08-26-2014:

THAT PORTION OF THE PROJECT SITE.

FREY CAMORTENSEN, NMPE 8547

332 of 825 DATE: 9-26-2008

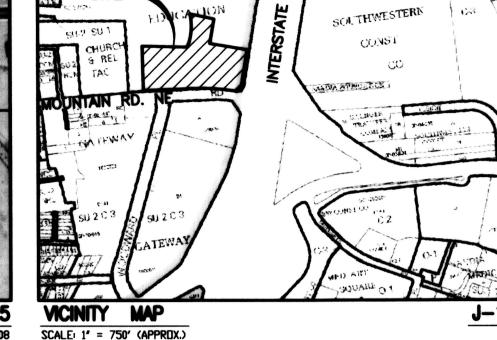

LINE LANDS WEST

LAMAD DE S

NDIAN SCHOOL RD. NE

ALSO SELECTE

CONSTRUCTION NOTES:

- TWO (2) WORKING DAYS PRIOR TO ANY EXCAVATION, CONTRACTOR MUST CONTACT NEW MÉXICO ONE CALL SYSTEM 260—1990 FOR DESIGNATION (LINE—SPOTTING) OF EXISTING PUBLIC UTILITIES AND EXISTING UTILITIES OWNED AND OPERATED BY albuquerque public schools.
- 2. PRIOR TO CONSTRUCTION, THE CONTRACTOR SHALL EXCAVATE AND VERIFY THE HORIZONTAL AND VERTICAL LOCATION OF ALL POTENTIAL OBSTRUCTIONS. SHOULD A CONFLICT EXIST, THE CONTRACTOR SHALL NOTIFY THE ENGINEER IN WRITING SO THAT THE CONFLICT CAN BE RESOLVED WITH A MINIMUM AMOUNT OF DELAY. THE CONTRACTOR SHALL BE RESPONSIBLE FOR ALL INTERPRETATIONS IT MAKES ITHOUT FIRST CONTACTING THE ENGINEER AS REQUIRED ABOVE.
- ALL WORK ON THIS PROJECT SHALL BE PERFORMED IN ACCORDANCE WITH APPLICABLE FEDERAL, STATE AND LOCAL LAWS, RULES AND REGULATIONS CONCERNING CONSTRUCTION SAFETY AND HEALTH.
- 4. ALL CONSTRUCTION WITHIN PUBLIC RIGHT-OF-WAY SHALL BE PERFORMED IN ACCORDANCE WITH APPLICABLE CITY OF ALBUQUERQUE STANDARDS AND
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- 3. WHEN APPLICABLE, CONTRACTOR SHALL SECURE "TOPSOIL DISTURBANCE PERMIT" FROM THE CITY AND/OR FILE A NOTICE OF INTENT (N.O.I.) WITH THE EPA PRIOR TO BEGINNING CONSTRUCTION

LEGAL DESCRIPTION

UNPLATTED TRACTS; SITE LOCATED WITHIN PROJECTED SECTION 16, TOWNSHIP 10 NORTH, RANGE 3 EAST, N.M.P.M. (TOWN OF ALBUQUERQUE GRANT).

Project benchmark

CITY OF ALBUQUERQUE SURVEY CONTROL 3 1/4" ALUMINUM DISK STAMPED "9-J15 1990", RIVETED TO AN ALUMINUM TUBE PROJECTING 0.25' ABOVE GRADE ON THE NORTH SIDE OF LOMAS BOULEVARD N.E. APPROXIMATELY 244' WEST OF THE INTERSECTION WITH LEGION ROAD N.E. ELEVATION = 5093.057 FEET (NAVD 88)

TEMPORARY BENCHMARK #1 (T.B.M.)


A #5 REBAR WITH CONTROL CAP STAMPED "HMCG CONTROL NMPS 11184", IN THE SOUTHEASTERN PORTION OF THE SITE, AS SHOWN ON SHEET 2. ELEVATION = 5043.15 FEET (NAVD 88)

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A #5 REBAR WITH CONTROL CAP STAMPED "HMCG CONTROL MPS 11184", IN THE NORTHWESTERN PORTION OF THE SITE, AS ELEVATION = 5026.87 FEET (NAVD 88)

hydrology file no:

J15/D001

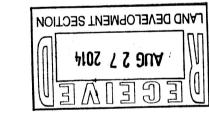

INDEX OF DRAWINGS


SH	SHEET NO.		DESCRIPTION					
1	OF	14	SUPPLEMENTAL SITE AND DRAINAGE INFORMATION					
2	OF	14	OVERALL PLAN (FOR ORIENTATION)					
3	OF	14	DEMOLITION PLAN - SOUTH					
4	OF	14	DEMOLITION PLAN - NORTH					
5	OF	14	SITE PLAN					
7	OF	14	GRADING PLAN - SOUTH					
8	OF	14	GRADING PLAN - NORTH					
9	OF	14	DRAINAGE PLAN AND CALCULATIONS					
13	OF	14	TYPICAL APS PORTABLE CLASSROOM FOUNDATION PLAN					



6010-B MIDWAY PARK BLVD. NE • ALBUQUERQUE, NEW MEXICO 87109 PHONE: 505.345.4250 • FAX: 505.345.4254 • www.highmesacg.com

SUPPLEMENTAL SITE AND DRAINAGE INFORMATION PORTABLE CLASSROOM RELOCATIONS CAREER ENRICHMENT CENTER

		NO.	DATE	BY	REVISIONS	JOB NO.	201	7 1	04 2
DESIGNED BY	J.G.M.		06/14	JG.M.	DRAINAGE CERTIFICATION FOR TEMPORARY C.O.		201	J. I	84.2
	J.Y.R.				-	DATE	06-	-20	14
DRAWN BY	<u> Jiriki</u>							20	
APPROVED BY	J.G.M.					SHEET	1	OF	1
							ı		

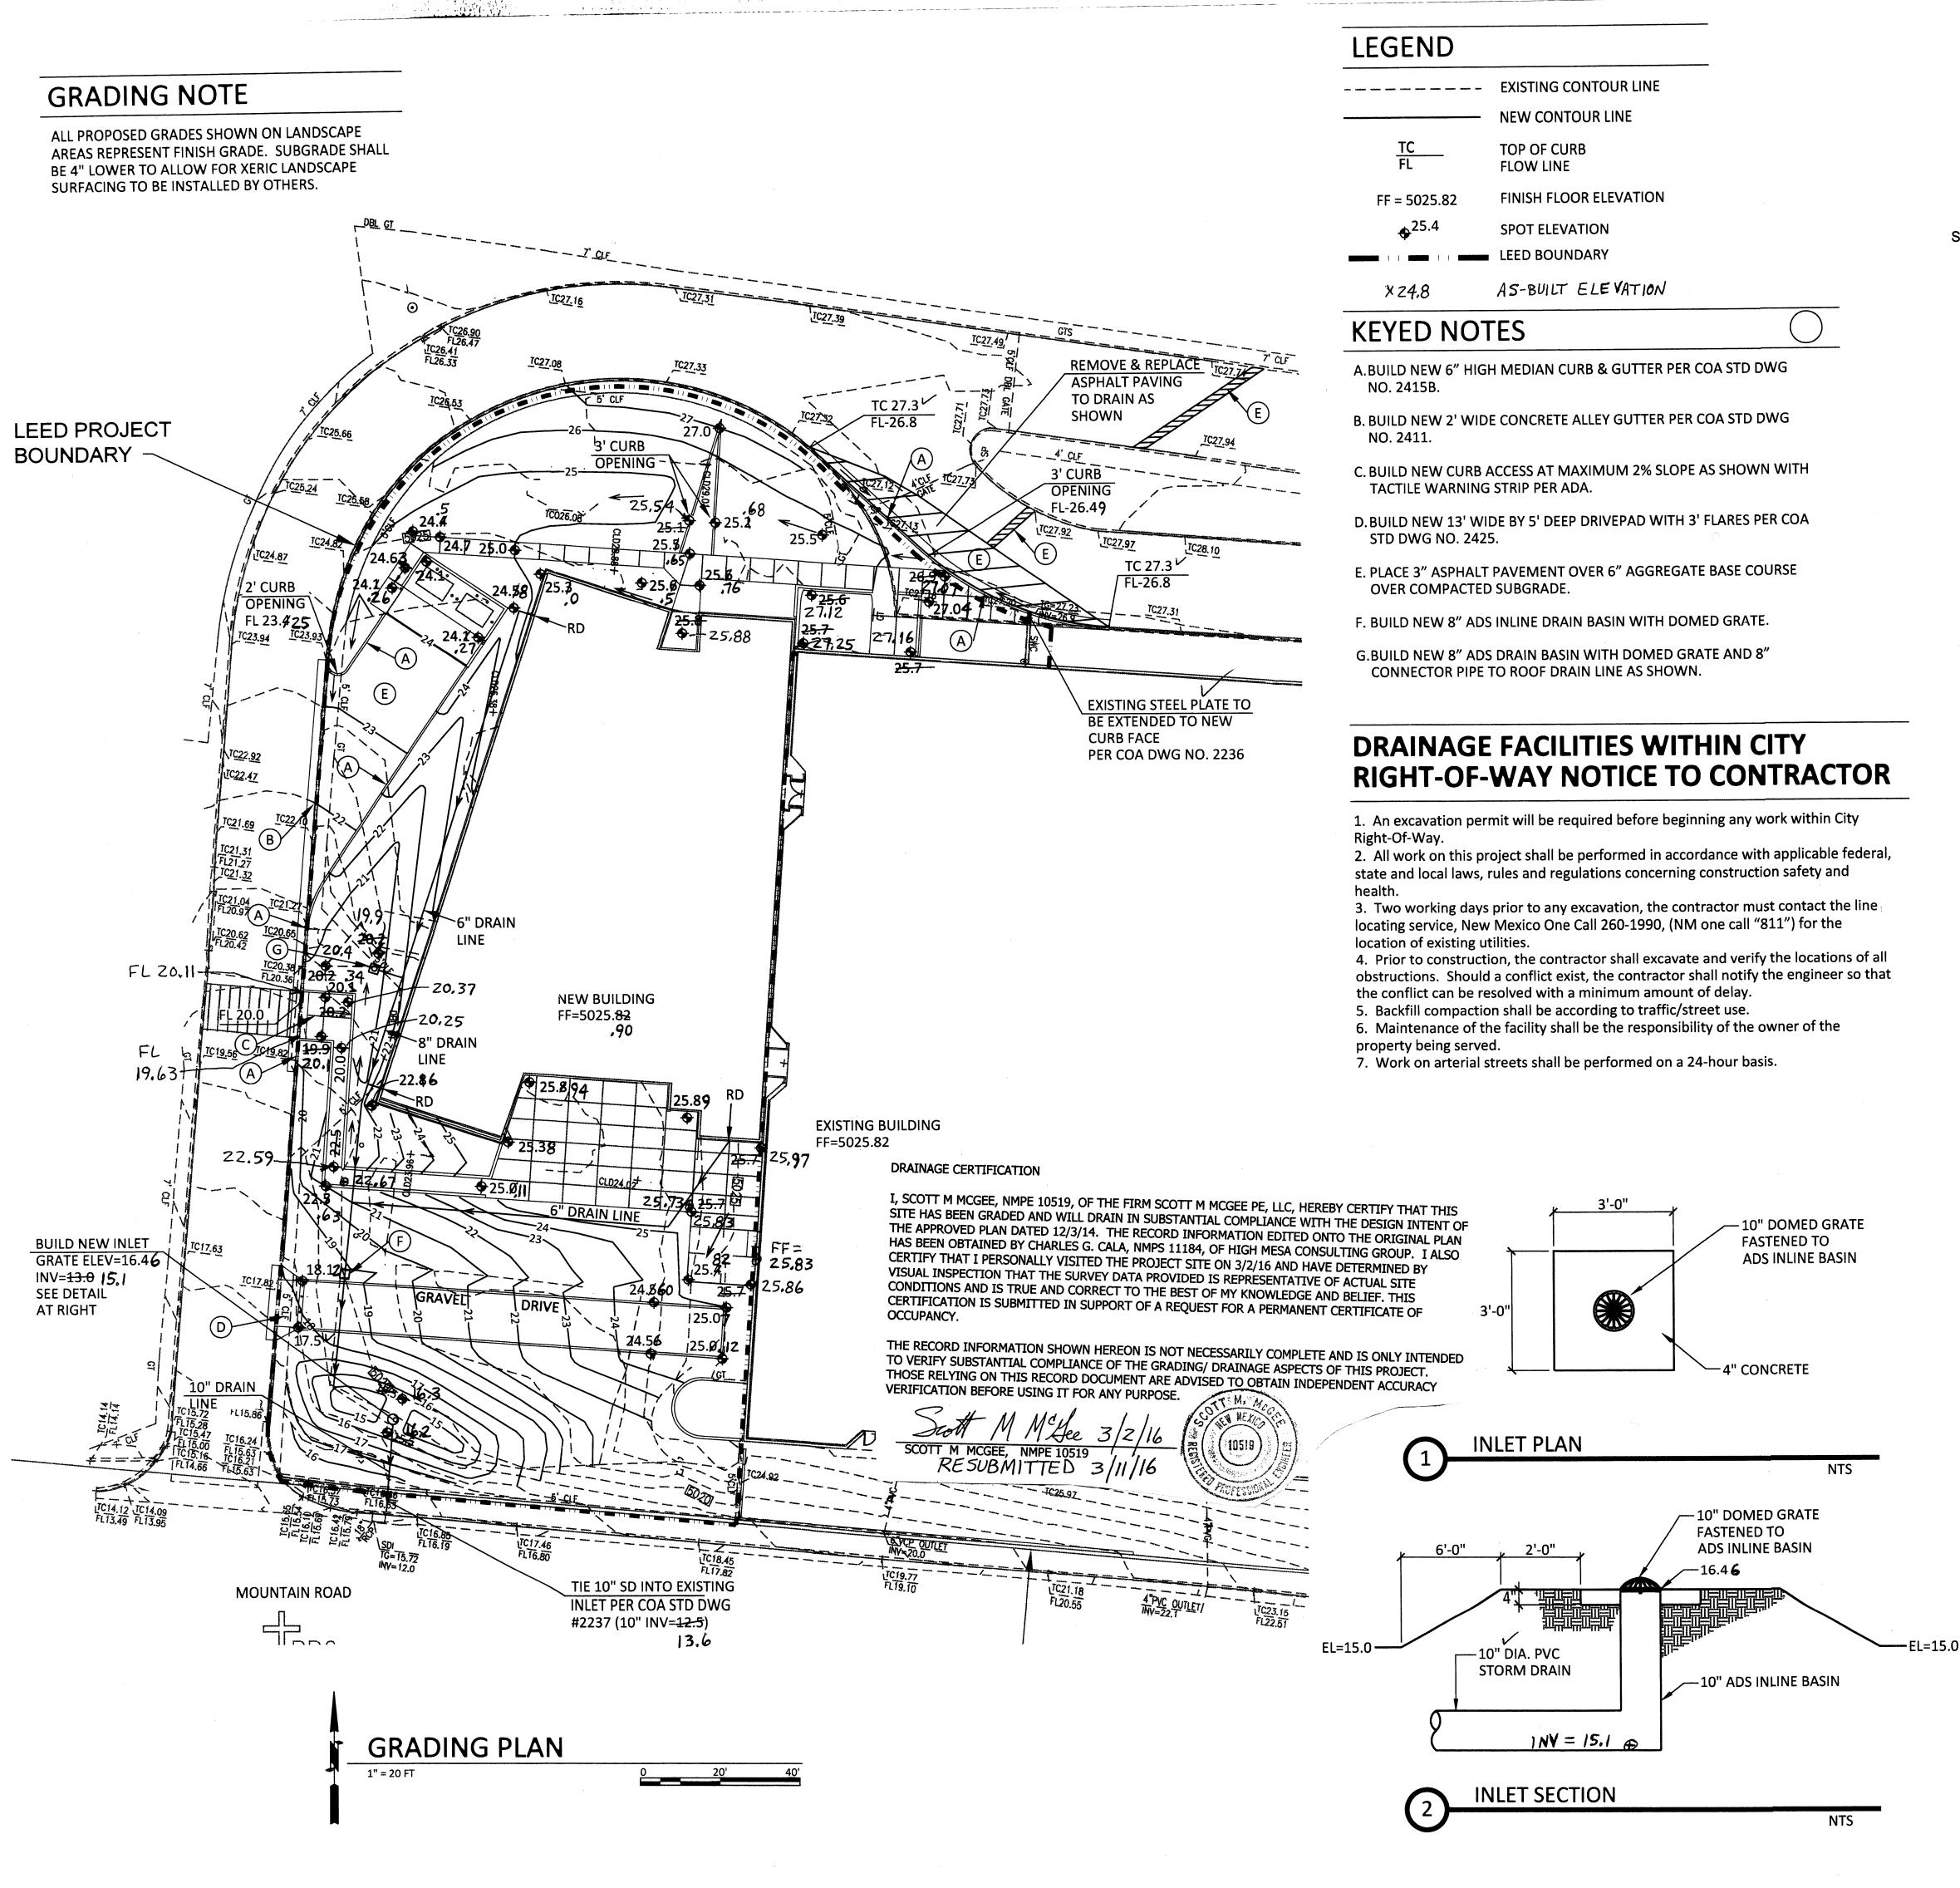



ALBUQUERQUE PUBLIC SCHOOLS CAREER ENRICHMENT CENTER

VICINITY MAP

DRAINAGE

LEGAL: A southerly portion of the tract BOARD OF EDUCATION (aka Career Enrichment Center)

AREA: LEED boundary portion of site this project -- 0.77 acres (33,525 sf)

BENCHMARK: ACS brass disk "9-J15 1990" set on the north side of Lomas Blvd NE approximately 244' west of Legion Road NE. ELEV= 5093.057 (NAVD 1988)

TBM: a #5 rebar with cap as shown in the northwest corner of the site. ELEV= 5026.87 (NAVD 1988)

SURVEYOR: High Mesa Consulting Group dated March, 2013

FLOOD HAZARD: From FEMA Panel 35001C0332G (09/26/2008), this site is identified as being within Zone 'X' which is outside the 0.2% annual chance floodplain.

EXISTING CONDITIONS: The site is an existing school facility. The land west of the existing building to the existing asphalt access road is the area of the site affected. This area is presently four portable classroom buildings, dirt/gravel surfacing, and asphalt walkways that slope down from northeast to southwest.

FIRST FLUSH: Q=(0.44-0.10)(18,295)/12= 518 CF
This volume will be provided in the detention pond located at the SW corner of the site as the storage depth of 1.4' provides 532 CF storage volume.

OFFSITE FLOWS: A portion of the existing building roof (6,000 SF), discharges runoff north which then flows west and passes through a curb opening north of the building. This drainage continues west through the landscaped area north of the addition.

PROPOSED IMPROVEMENTS: The proposed addition is a 20,900 sf (2-story) building addition located adjacent to the west side of the existing building.

DRAINAGE APPROACH: The proposed drainage plan will follow historic flow paths and the approved Grading Plan. Building roof runoff will discharge to the west and south sides of the building. Site runoff will discharge in two different ways. The refuse access drive will surface flow south. The proposed roof area will discharge below grade and be piped to the proposed detention pond. Depressed landscape areas will convey surface flow along the west and south sides of the building to proposed area drains. The pond will discharge through a piped connection to an existing drop inlet on the north side of Mountain Road.

HYDROLOGY: For precipitation Zone 2 with 62% C & 38% D land treatment Existing Q = (0.477)(3.14)+(0.293)(4.70)= 2.9 CFS

The proposed building, impervious plaza area, and walks are 55% of the area with the balance of the site considered as land treatment type 'C'. A subsequent APS project will landscape this site with 100% xeric surfacing. Proposed Q = (0.35)(3.14) + (0.42)(4.70) = 3.1 CFS

This minor runoff increase (0.2 CFS) will not have an adverse impact on downstream drainage facilities.

MAP 1 1 2016

LAND DEVELOPMENT SECTION




LEE GAMELSKY ARCHITECTS P.C

ALBUQUERQUE, NM 87106 505.842.8865 FAX 842.1693

office@lganm.com

CAREER ENRICHMENT CENTER
807 MOUNTAIN RD. NE
ALBUQUERQUE, NEW MEXICO 8710

J-15

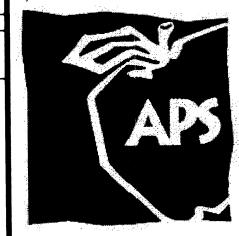

IARK DATE DESCRIPTION

LGA PROJECT NO: 13-06-APS

APS PROJECT NO: 592.5107.31131

CAD DWG FILE: MG-1401_C101_C102.DWG


DATE: 12/08/2014


DRAWN BY: CB CHK'D BY: SMM


COPYRIGHT: LEE GAMELSKY ARCHITECTS P.C.

> GRADING PLAN

C-101

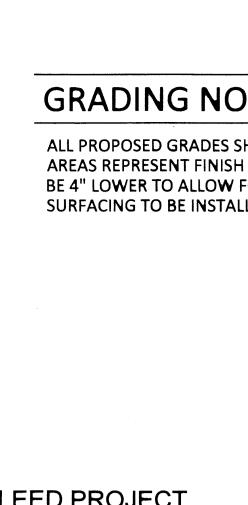

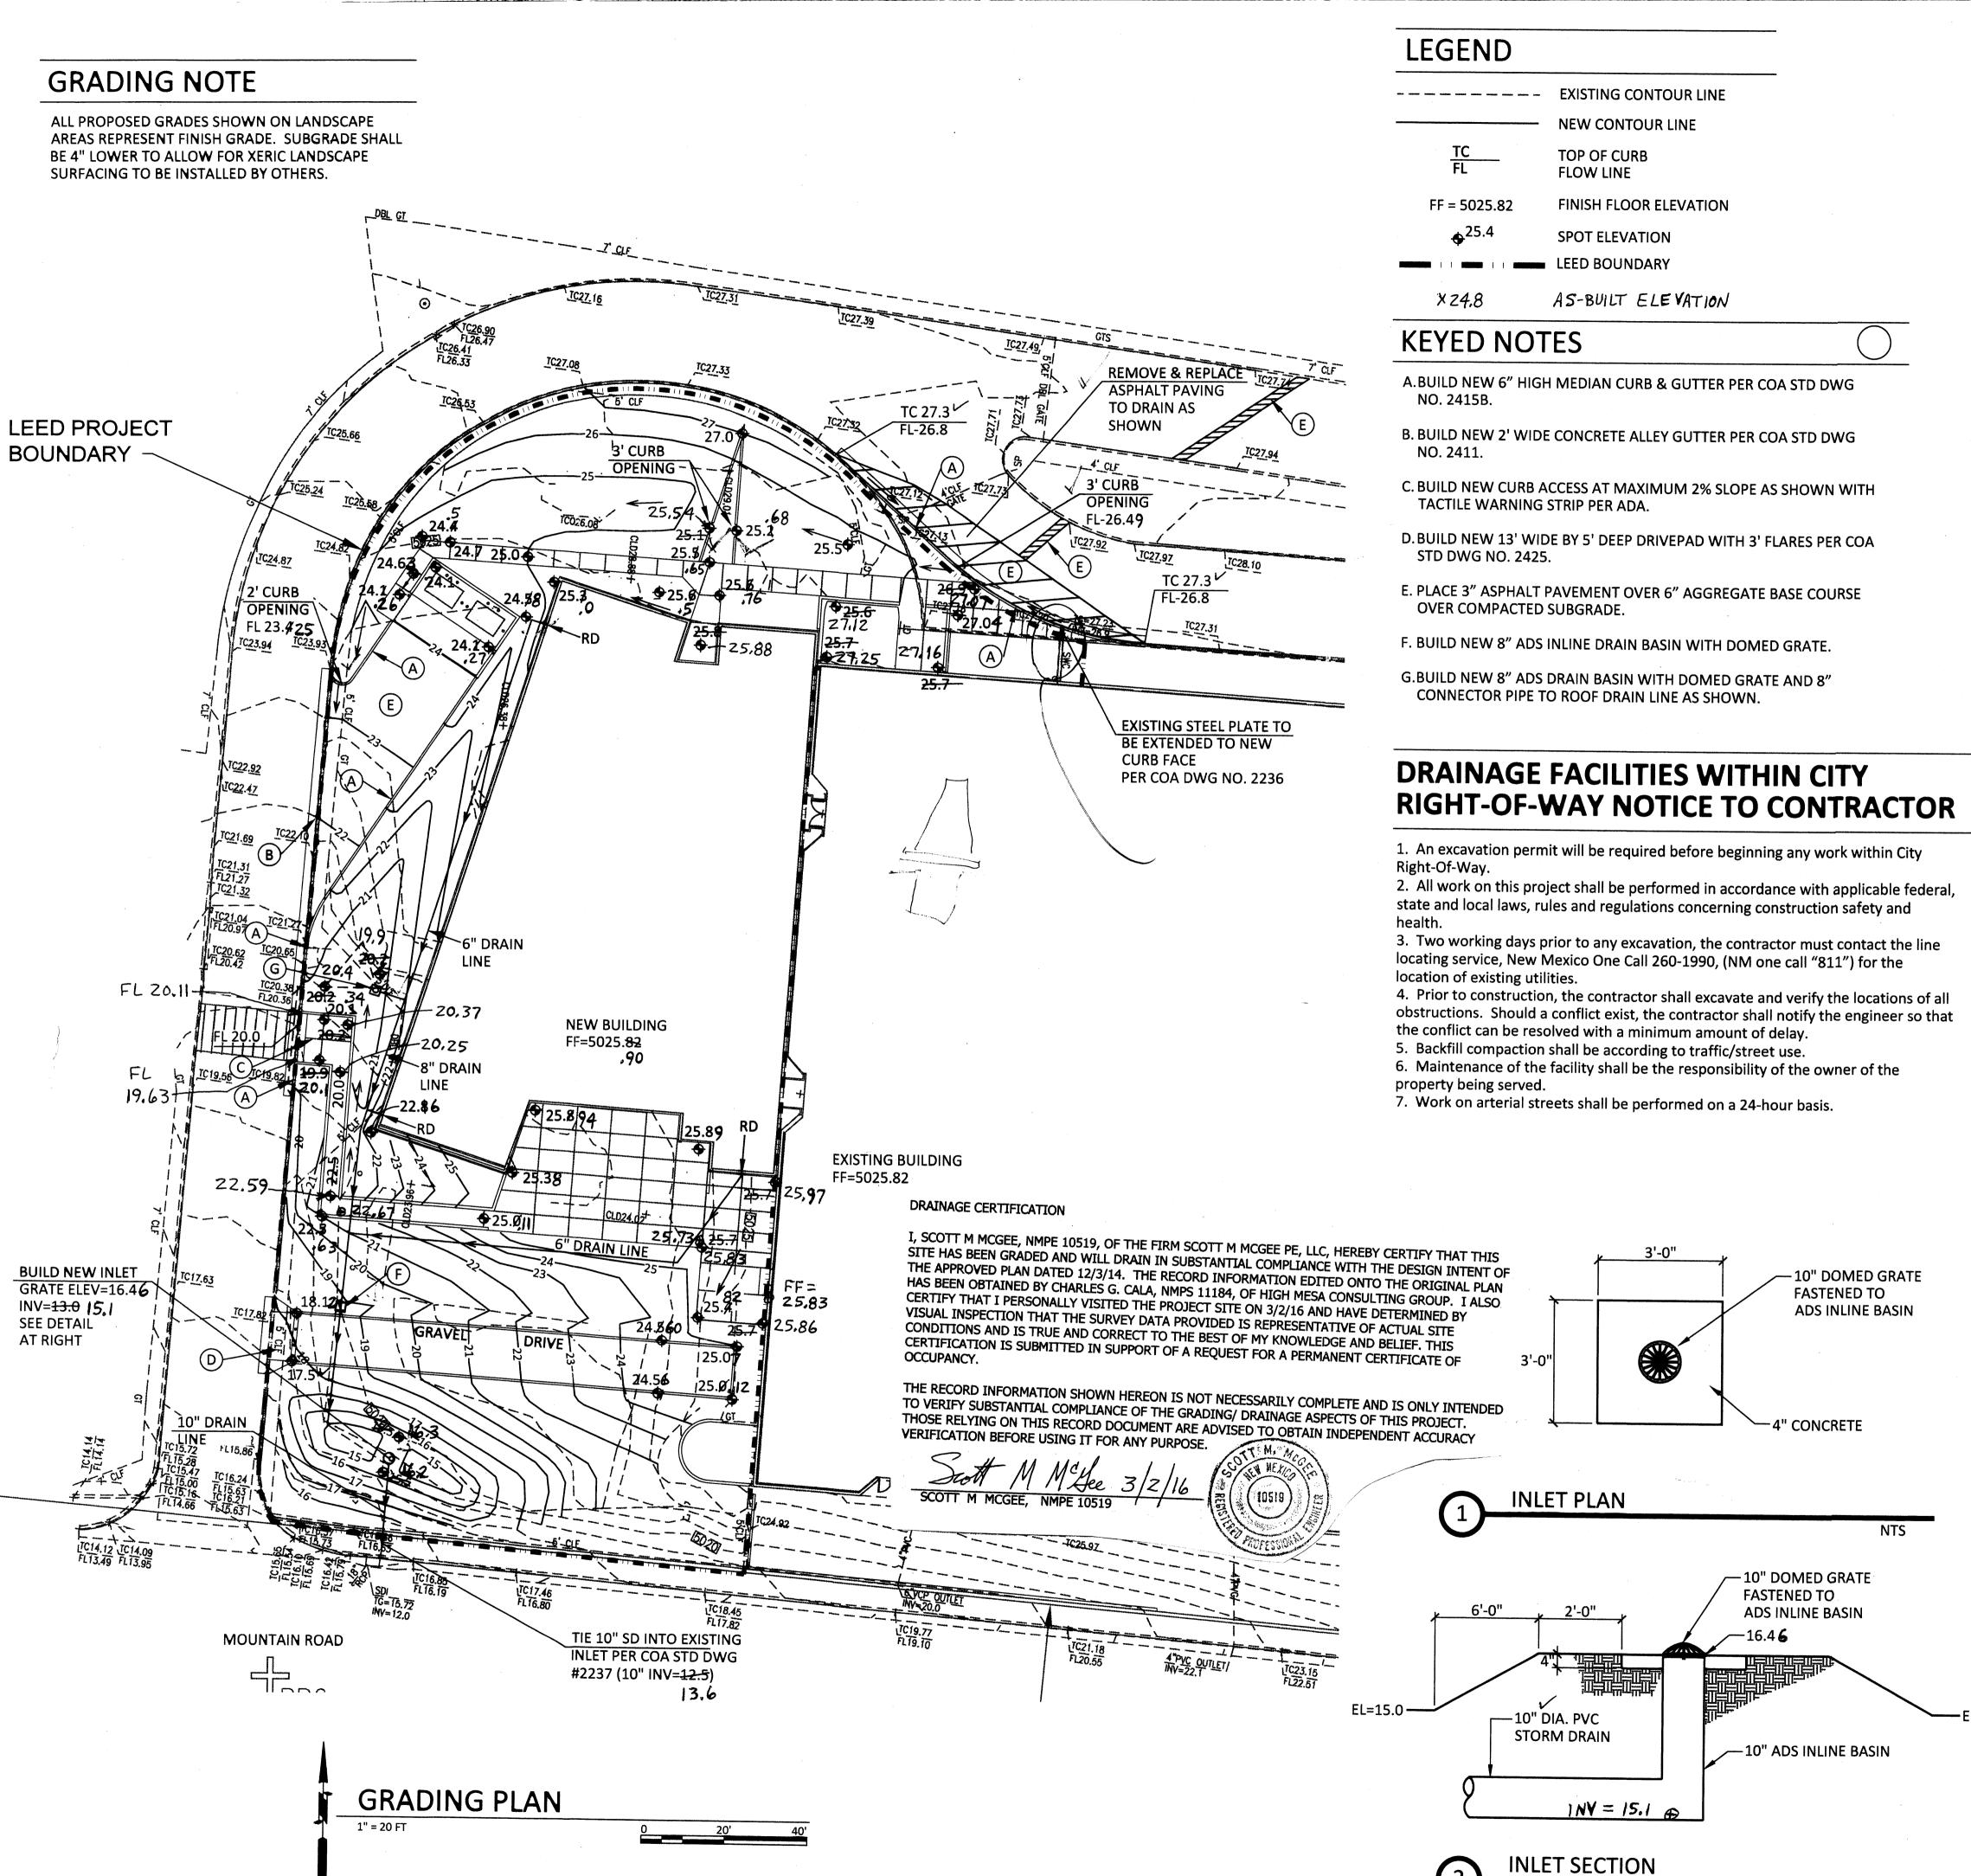

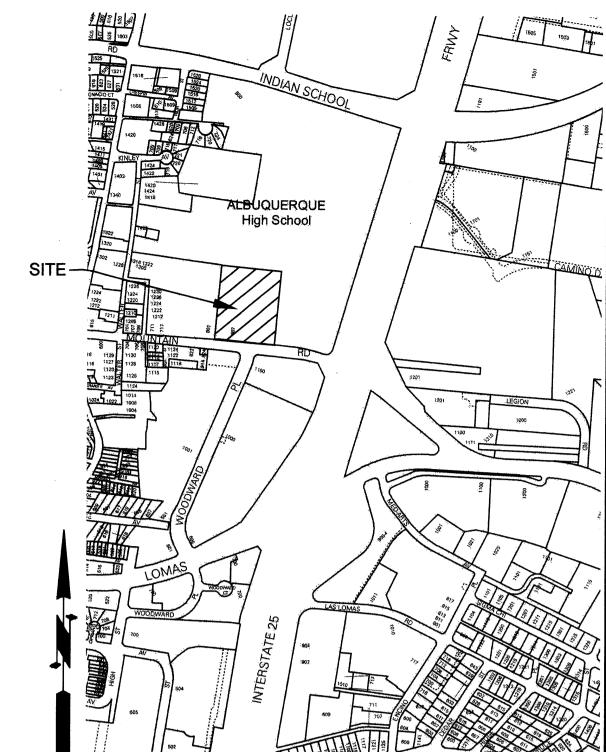

EE GAMELSKY ARCHITECTS P.C. ALBUQUERQUE, NM 87106 505.842.8865 FAX 842.1693 office@lganm.com LBUQUERQUE PUBLIC SCHOOLS CAREER ENRICHMENT CENTER 807 MOUNTAIN RD. NE

VICINITY MAP

J-15

DRAINAGE

LEGAL: A southerly portion of the tract BOARD OF EDUCATION (aka Career Enrichment Center)

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NTS

MARK DATE DESCRIPTION


DATE: 12/08/2014 LGA PROJECT NO: 13-06-APS APS PROJECT NO: 592.5107.31131

CAD DWG FILE: MG-1401_C101_C102.DW0 DRAWN BY: CB

HK'D BY: SMM OPYRIGHT: EE GAMELSKY ARCHITECTS P.C.

GRADING PLAN

C-101

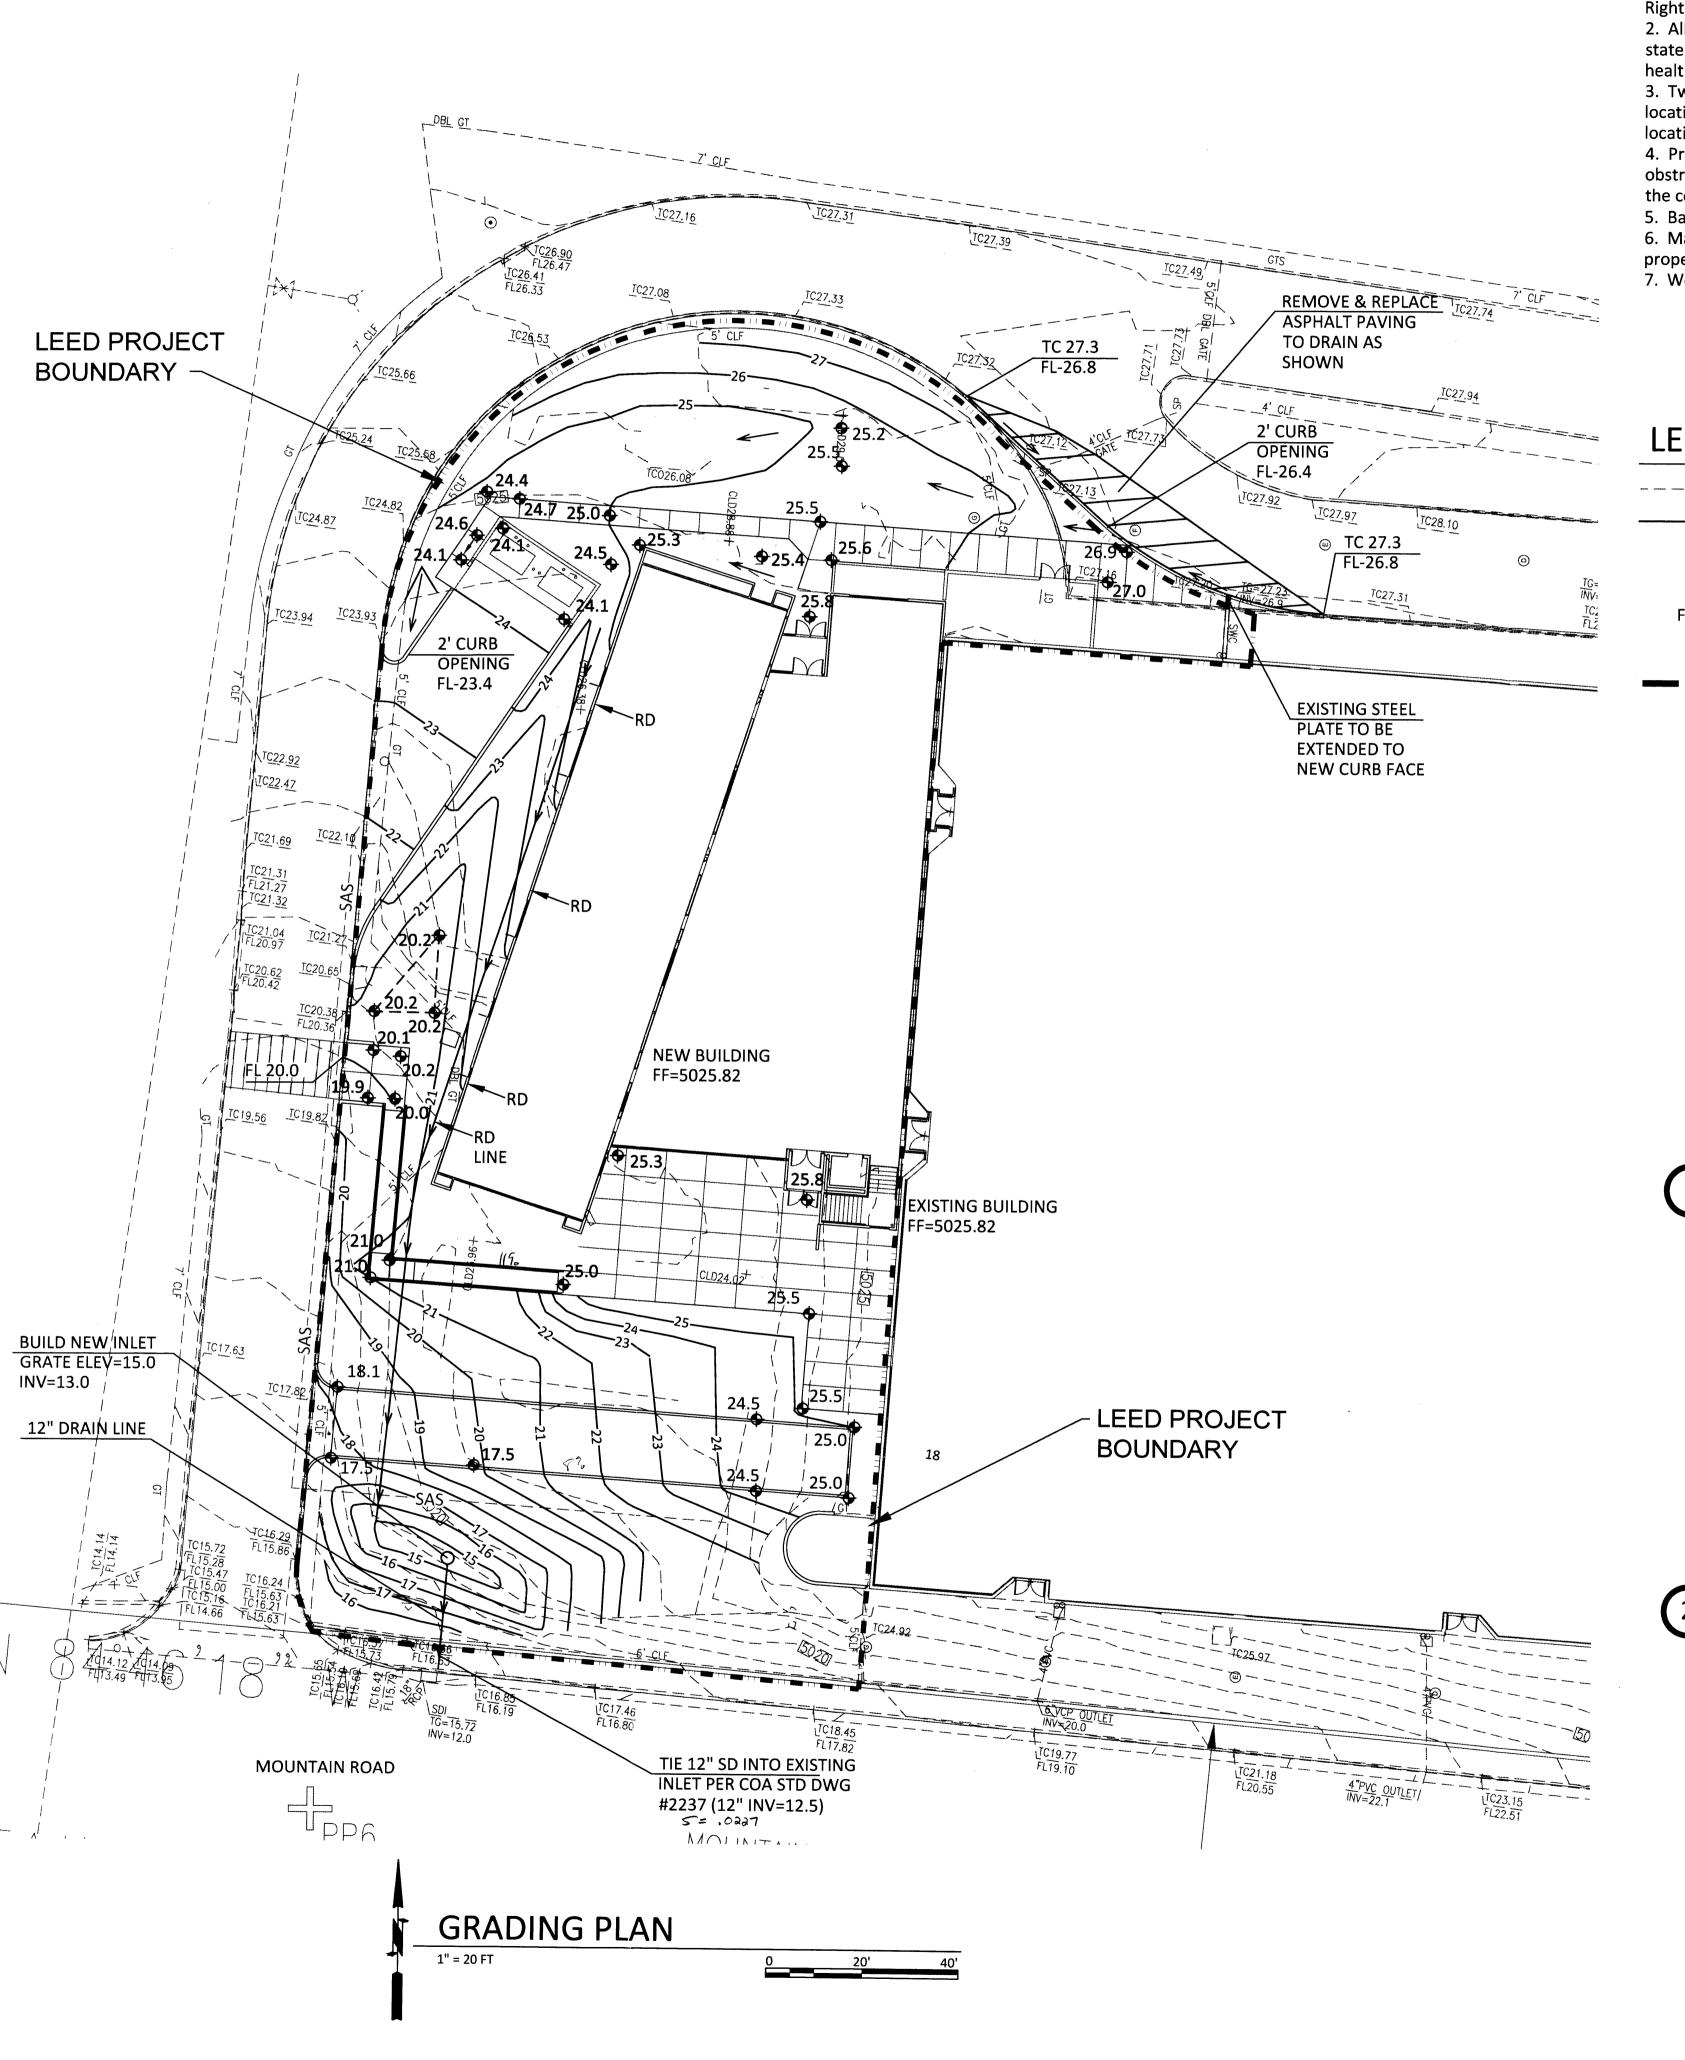

DRAINAGE FACILITIES WITHIN CITY RIGHT-OF-WAY NOTICE TO CONTRACTOR

- 1. An excavation permit will be required before beginning any work within City Right-Of-Way.
- 2. All work on this project shall be performed in accordance with applicable federal, state and local laws, rules and regulations concerning construction safety and health.
- 3. Two working days prior to any excavation, the contractor must contact the line locating service, New Mexico One Call 260-1990, (NM one call "811") for the location of existing utilities.
- 4. Prior to construction, the contractor shall excavate and verify the locations of all obstructions. Should a conflict exist, the contractor shall notify the engineer so that the conflict can be resolved with a minimum amount of delay.
- 5. Backfill compaction shall be according to traffic/street use.
- 6. Maintenance of the facility shall be the responsibility of the owner of the property being served.
- 7. Work on arterial streets shall be performed on a 24-hour basis.

LEGEND

EXISTING CONTOUR LINE


NEW CONTOUR LINE

TOP OF CURB


FL FLOW LINE

FF = 5025.82 FINISH FLOOR ELEVATION

\$POT ELEVATION LEEDS BOUNDRY

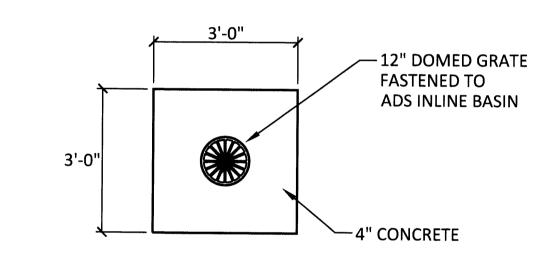


1) INLET PLAN

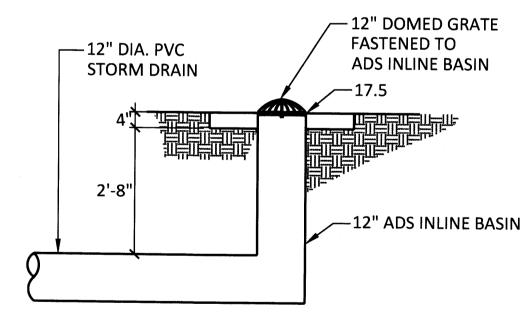

INLET SECTION

NTS

NTS

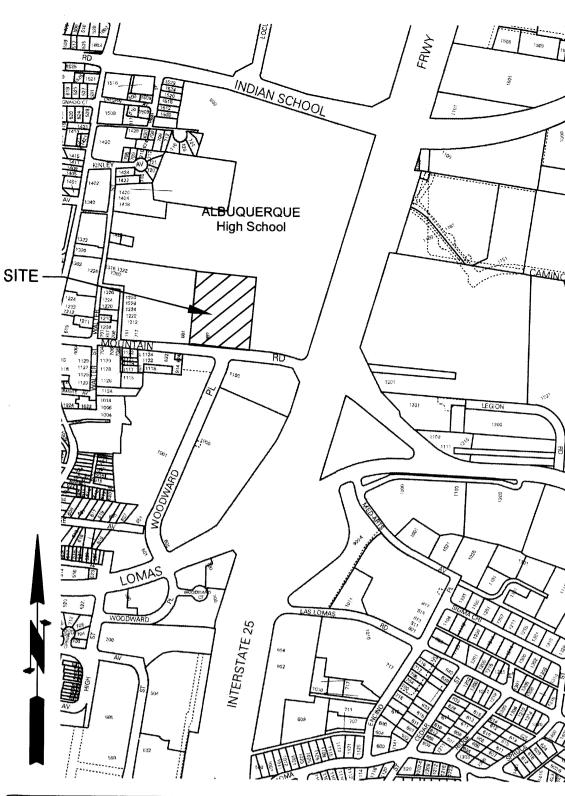

VICINITY MAP

DRAINAGE

LEGAL: A southerly portion of the tract BOARD OF EDUCATION (aka Career Enrichment Center)

AREA: LEED boundary portion of site this project -- 0.77 acres (33,525 sf)

BENCHMARK: ACS brass disk "9-J15 1990" set on the north side of Lomas Blvd NE approximately 244' west of Legion Road NE. ELEV= 5093.057 (NAVD 1988)

TBM: a #5 rebar with cap as shown in the northwest corner of the site.
ELEV= 5026.87 (NAVD 1988)

SURVEYOR: High Mesa Consulting Group dated March, 2013

FLOOD HAZARD: From FEMA Panel 35001C0332G (09/26/2008), this site is identified as being within Zone 'X' which is outside the 0.2% annual chance floodplain.

EXISTING CONDITIONS: The site is an existing school facility. The land west of the existing building to the existing asphalt access road is the area of the site affected. This area is presently four portable classroom buildings, dirt/gravel surfacing, and asphalt walkways that slopes down from northeast to southwest.

OFFSITE FLOWS: No offsite flow enters this area as all drainage is carried in the perimeter road around the project area.

PROPOSED IMPROVEMENTS: The proposed improvements include a 20,900 sf (2-story) building addition located adjacent to the west side of the existing building.


DRAINAGE APPROACH: The proposed drainage plan will follow historic flow paths and the approved Grading Plan. Building roof runoff will primarily discharge to the west and south sides of the building. Site runoff will discharge in two different ways. A small portion will surface flow south. The proposed roof area will discharge to the west side of the building and is then piped to the proposed detention pond. A depressed landscape area will convey surface flow along the west side of the building. The pond will then discharge through a piped connection to an existing drop inlet on the north side of Mountain Road.

HYDROLOGY: For precipitation Zone 2 with 62% C & 38% D land treatment Existing Q= (0.477)(3.14)+(0.293)(4.70)=2.9 CFS

The proposed improvements include the building, impervious courtyard area, walks, and the shallow depressed area to the south of the proposed building.

Proposed Q = (0.07)(2.28) + (0.31)(3.14) + (0.39)(4.70) = 3.0 CFS

This minor runoff increase (0.1 CFS) will not have an adverse impact on downstream drainage facilities.

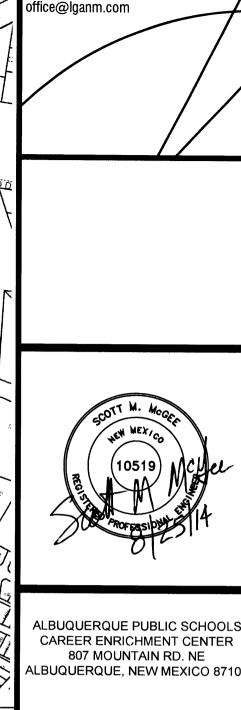

J-15

LEE GAMELSKY ARCHITECTS P.O

2412 MILES ROAD SE ALBUQUERQUE, NM 87106

505.842.8865 FAX 842.1693

APS

CONSTRUCTION
DOCUMENTS
SUBMITTAL
PHASE

RK	DATE	DESCRIPTION						
			_					
			_					
TE: (08/29/20	14						

LGA PROJECT NO: 13-06-APS
APS PROJECT NO: 592.5107.31131

CAD DWG FILE:

MG-1401_C101_C102.DWG

DRAWN BY: CB

CHK'D BY: SMM

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LEE GAMELSKY ARCHITECTS P.C.


GRADING

PLAN

C-101

GRADING NOTE

ALL PROPOSED GRADES SHOWN ON LANDSCAPE AREAS REPRESENT FINISH GRADE. SUBGRADE SHALL

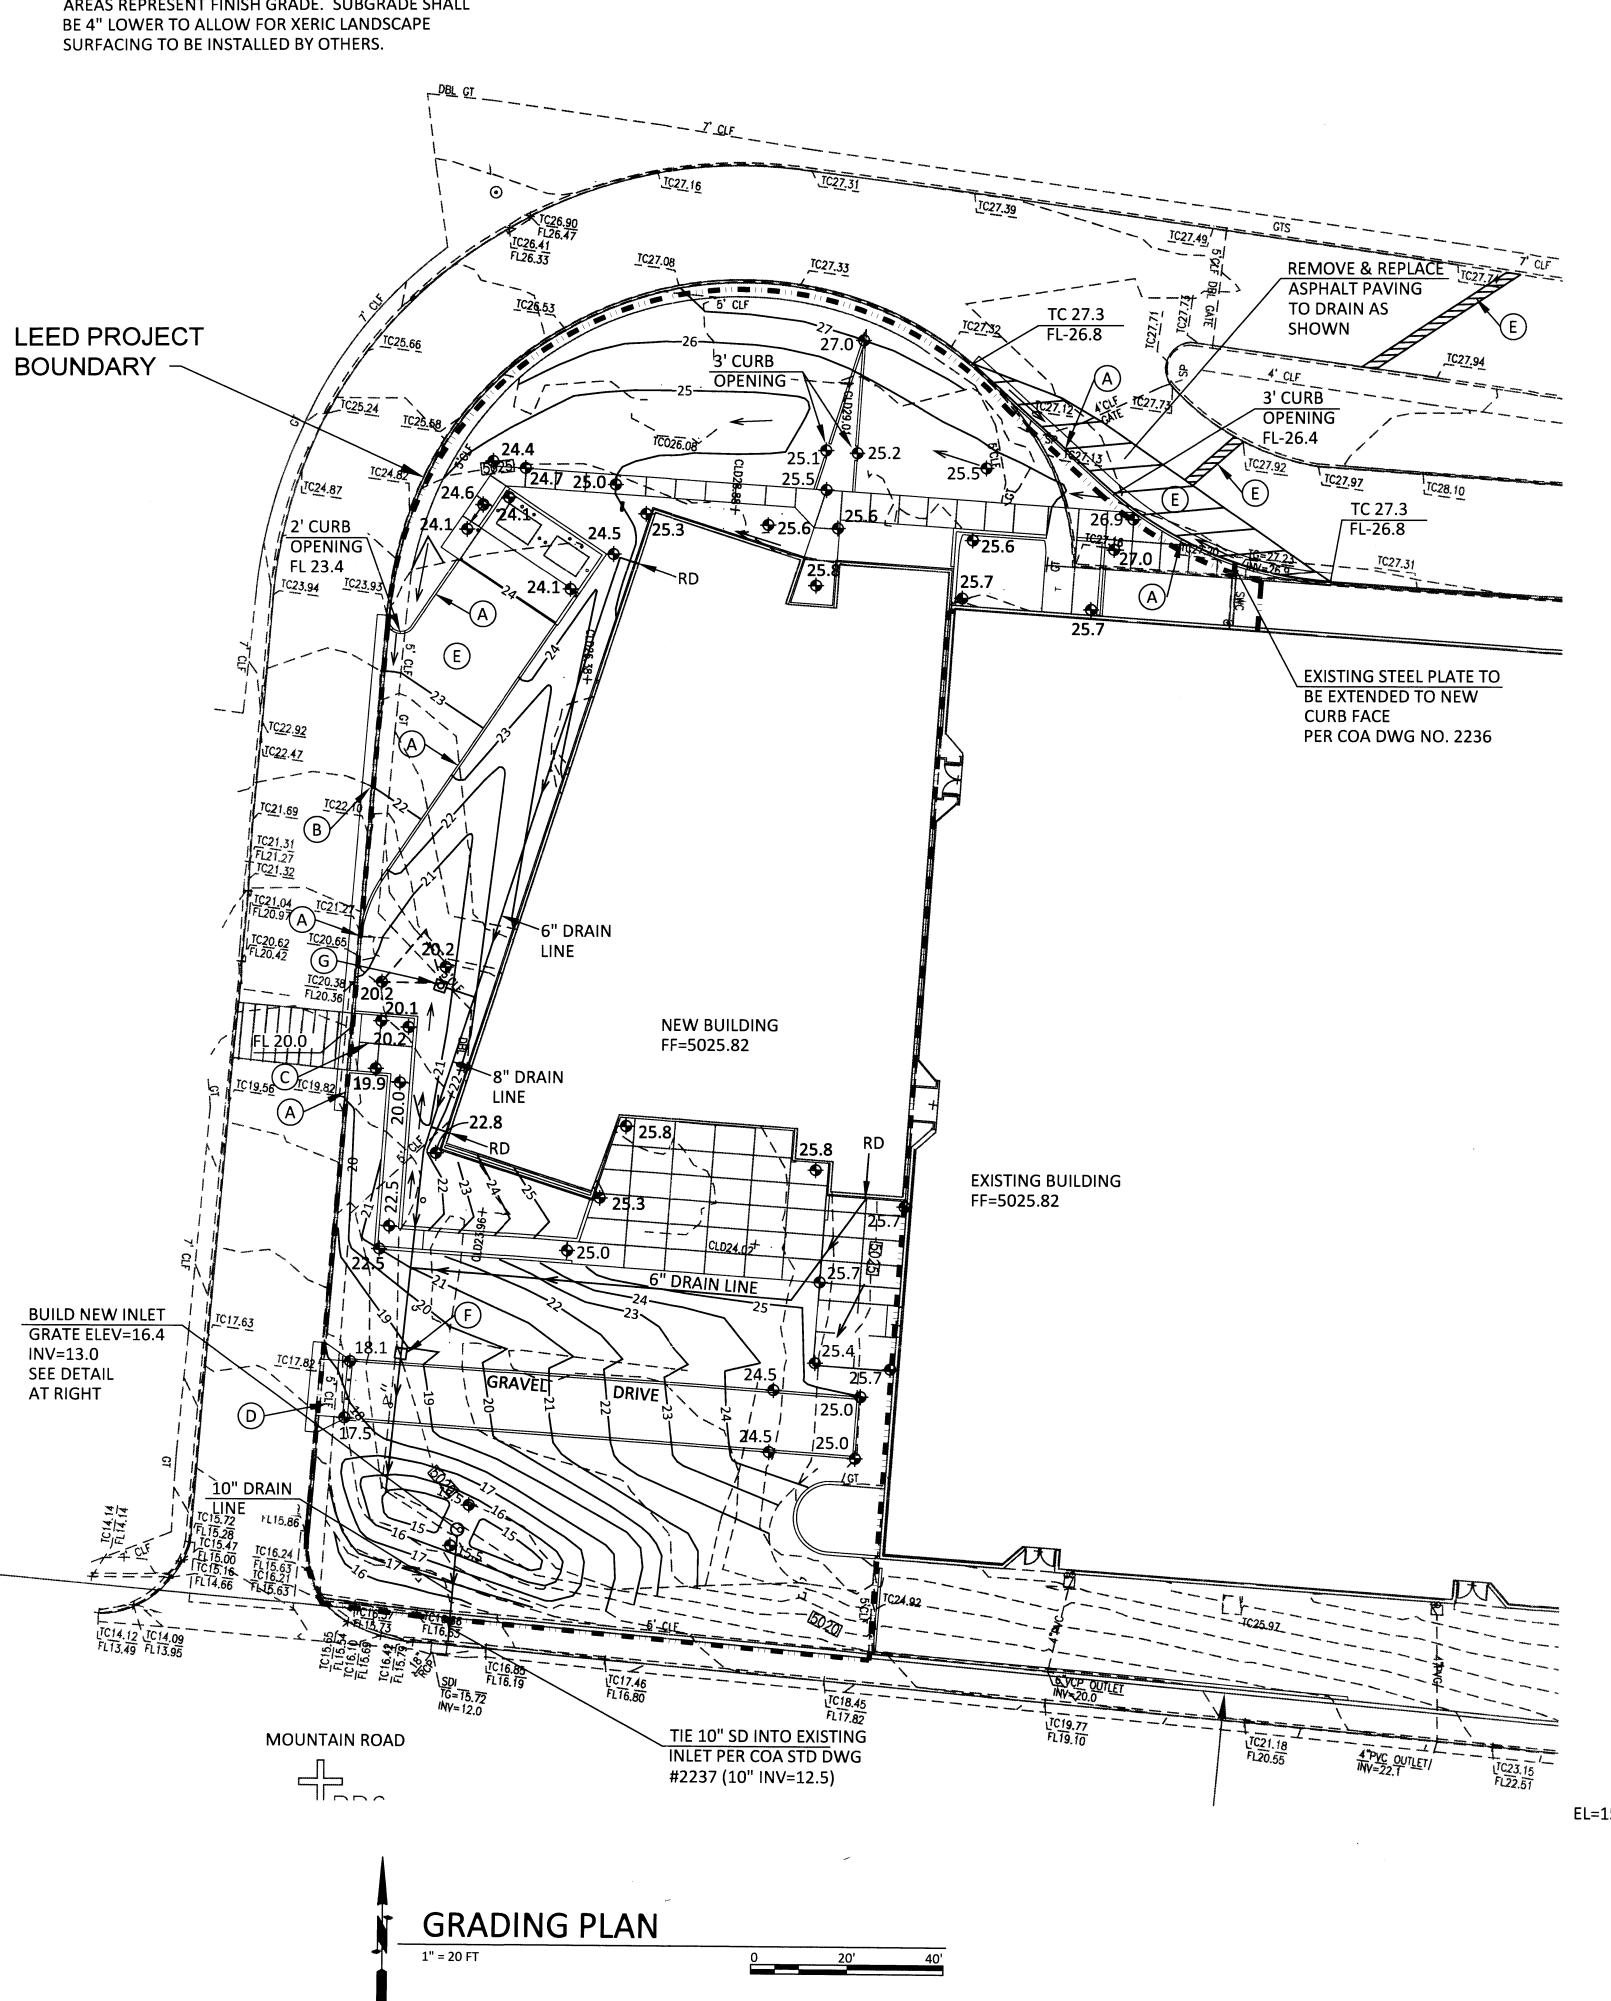

LEGEND

---- EXISTING CONTOUR LINE **NEW CONTOUR LINE TOP OF CURB** FLOW LINE FINISH FLOOR ELEVATION FF = 5025.82SPOT ELEVATION LEED BOUNDARY

KEYED NOTES

A.BUILD NEW 6" HIGH MEDIAN CURB & GUTTER PER COA STD DWG NO. 2415B.

B. BUILD NEW 2' WIDE CONCRETE ALLEY GUTTER PER COA STD DWG NO. 2411.

C. BUILD NEW CURB ACCESS AT MAXIMUM 2% SLOPE AS SHOWN WITH TACTILE WARNING STRIP PER ADA.

D.BUILD NEW 13' WIDE BY 5' DEEP DRIVEPAD WITH 3' FLARES PER COA STD DWG NO. 2425.

E. PLACE 3" ASPHALT PAVEMENT OVER 6" AGGREGATE BASE COURSE OVER COMPACTED SUBGRADE.

F. BUILD NEW 8" ADS INLINE DRAIN BASIN WITH DOMED GRATE.

G.BUILD NEW 8" ADS DRAIN BASIN WITH DOMED GRATE AND 8" CONNECTOR PIPE TO ROOF DRAIN LINE AS SHOWN.

DRAINAGE FACILITIES WITHIN CITY **RIGHT-OF-WAY NOTICE TO CONTRACTOR**

1. An excavation permit will be required before beginning any work within City

2. All work on this project shall be performed in accordance with applicable federal, state and local laws, rules and regulations concerning construction safety and


3. Two working days prior to any excavation, the contractor must contact the line locating service, New Mexico One Call 260-1990, (NM one call "811") for the location of existing utilities.


4. Prior to construction, the contractor shall excavate and verify the locations of all obstructions. Should a conflict exist, the contractor shall notify the engineer so that

the conflict can be resolved with a minimum amount of delay. 5. Backfill compaction shall be according to traffic/street use.

6. Maintenance of the facility shall be the responsibility of the owner of the property being served.

7. Work on arterial streets shall be performed on a 24-hour basis.

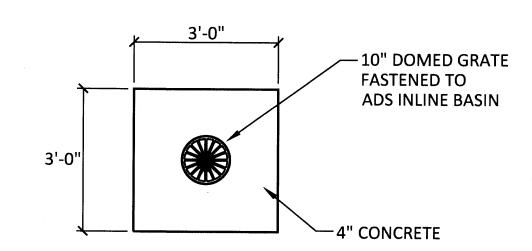

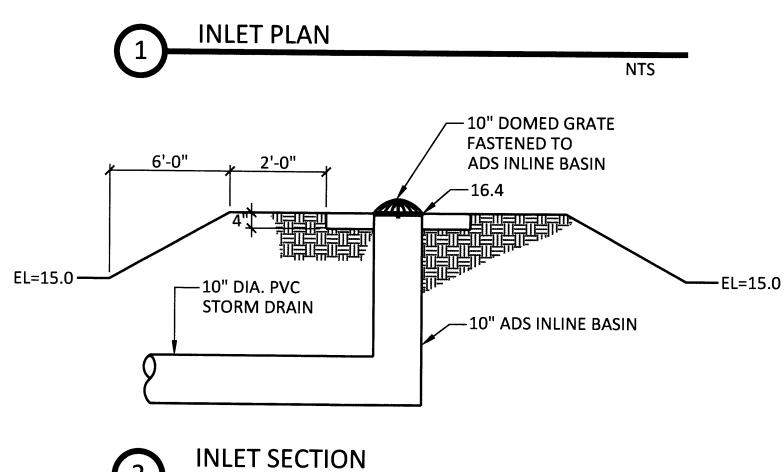



ALBUQUERQUE PUBLIC SCHOOLS CAREER ENRICHMENT CENTER

EE GAMELSKY ARCHITECTS P.O.

2412 MILES ROAD SE ALBUQUERQUE, NM 87106 505.842.8865 FAX 842.1693

VICINITY MAP

J-15

DRAINAGE

LEGAL: A southerly portion of the tract BOARD OF EDUCATION (aka Career Enrichment Center)

AREA: LEED boundary portion of site this project -- 0.77 acres (33,525 sf)

BENCHMARK: ACS brass disk "9-J15 1990" set on the north side of Lomas Blvd NE approximately 244' west of Legion Road NE. ELEV= 5093.057 (NAVD 1988)

TBM: a #5 rebar with cap as shown in the northwest corner of the site. ELEV= 5026.87 (NAVD 1988)

SURVEYOR: High Mesa Consulting Group dated March, 2013

FLOOD HAZARD: From FEMA Panel 35001C0332G (09/26/2008), this site is identified as being within Zone 'X' which is outside the 0.2% annual chance floodplain.

EXISTING CONDITIONS: The site is an existing school facility. The land west of the existing building to the existing asphalt access road is the area of the site affected. This area is presently four portable classroom buildings, dirt/gravel surfacing, and asphalt walkways that slope down from northeast to southwest.

FIRST FLUSH: Q=(0.44-0.10)(18,295)/12= 518 CF This volume will be provided in the detention pond located at the SW corner of the site as the storage depth of 1.4' provides 532 CF storage

OFFSITE FLOWS: A portion of the existing building roof (6,000 SF), discharges runoff north which then flows west and passes through a curb opening north of the building. This drainage continues west through the landscaped area north of the addition.

PROPOSED IMPROVEMENTS: The proposed addition is a 20,900 sf (2story) building addition located adjacent to the west side of the existing building.


DRAINAGE APPROACH: The proposed drainage plan will follow historic flow paths and the approved Grading Plan. Building roof runoff will discharge to the west and south sides of the building. Site runoff will discharge in two different ways. The refuse access drive will surface flow south. The proposed roof area will discharge below grade and be piped to the proposed detention pond. Depressed landscape areas will convey surface flow along the west and south sides of the building to proposed area drains. The pond will discharge through a piped connection to an existing drop inlet on the north side of Mountain Road.

HYDROLOGY: For precipitation Zone 2 with 62% C & 38% D land

Existing Q = (0.477)(3.14) + (0.293)(4.70) = 2.9 CFS

The proposed building, impervious plaza area, and walks are 55% of the 45% area with the balance of the site considered as land treatment type 'C'. A subsequent APS project will landscape this site with 100% xeric surfacing. Proposed Q= (0.35)(3.14)+(0.42)(4.70)=3.1 CFS

This minor runoff increase (0.2 CFS) will not have an adverse impact on downstream drainage facilities.

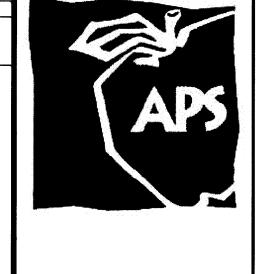

807 MOUNTAIN RD. NE

ARK DATE DESCRIPTION

DATE: 12/08/2014 LGA PROJECT NO: 13-06-APS APS PROJECT NO: 592.5107.31131

CAD DWG FILE: MG-1401_C101_C102.DWG

DRAWN BY: CB CHK'D BY: SMM

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> GRADING **PLAN**

C-101 6 OF 133