

Legal Description

A LOT IN SECTION 16, TOWNSHIP 10 NORTH, RANGE 3
E, BEING 81.50x125 LYING EAST OF WALTER N.E. AND
WEST OF STONE N.E.

Drainage Narrative

THE INTENT OF THIS GRADING AND DRAINAGE PLAN IS TO ACCOMMODATE A NEW RESIDENCE ON SITE. THE SITE IS CURRENTLY AN EXISTING PARKING LOT AND BOUNDED TO THE EAST, NORTH AND WEST BY EXISTING ROADWAY AND TO THE SOUTH, AN EXISTING RESIDENCE. THE SITE ALSO CURRENTLY SLOPES FROM THE EAST TO THE WEST AT 7% SLOPE. THE SITE IS NOT WITHIN A 100 YR FLOOD PLANE.

THIS GRADING PLAN WILL REDUCE THE EXISTING FLOW
FROM 1.08 CFS TO 0.70 CFS


Drainage Calculations

Hydrology Calculations
Date: January 25, 2010
DPM - Section 22.2
Volume 2, January 1993

Precipitation Zone	2
100 Year Storm Depth, P (360)	2.35
100 year Storm Depth, P (10 day)	3.95


Treatment Area	A	B	C	D
Excess Precipitation Factors	0.53	0.78	1.13	2.12
Peak Discharge Factors	1.56	2.28	3.14	4.7

Land Treatment Area	Acres	Existing	Proposed
Type "D" (Roof)		0.23	0.05
Type "C" (Unpaved Roadway)		0.00	0.06
Type "B" (Irigated Lawns)		0.00	0.12
Type "A" (Undeveloped)		0.00	0.00
Total (Acres)		0.23	0.23
Excess Precipitation(in)		2.12	1.16
Volume (100), cf		1769.99	970.66
Volume (10),cf		1185.89	650.34
Q (100), cfs		1.08	0.70
Q (10), cfs		0.72	0.47

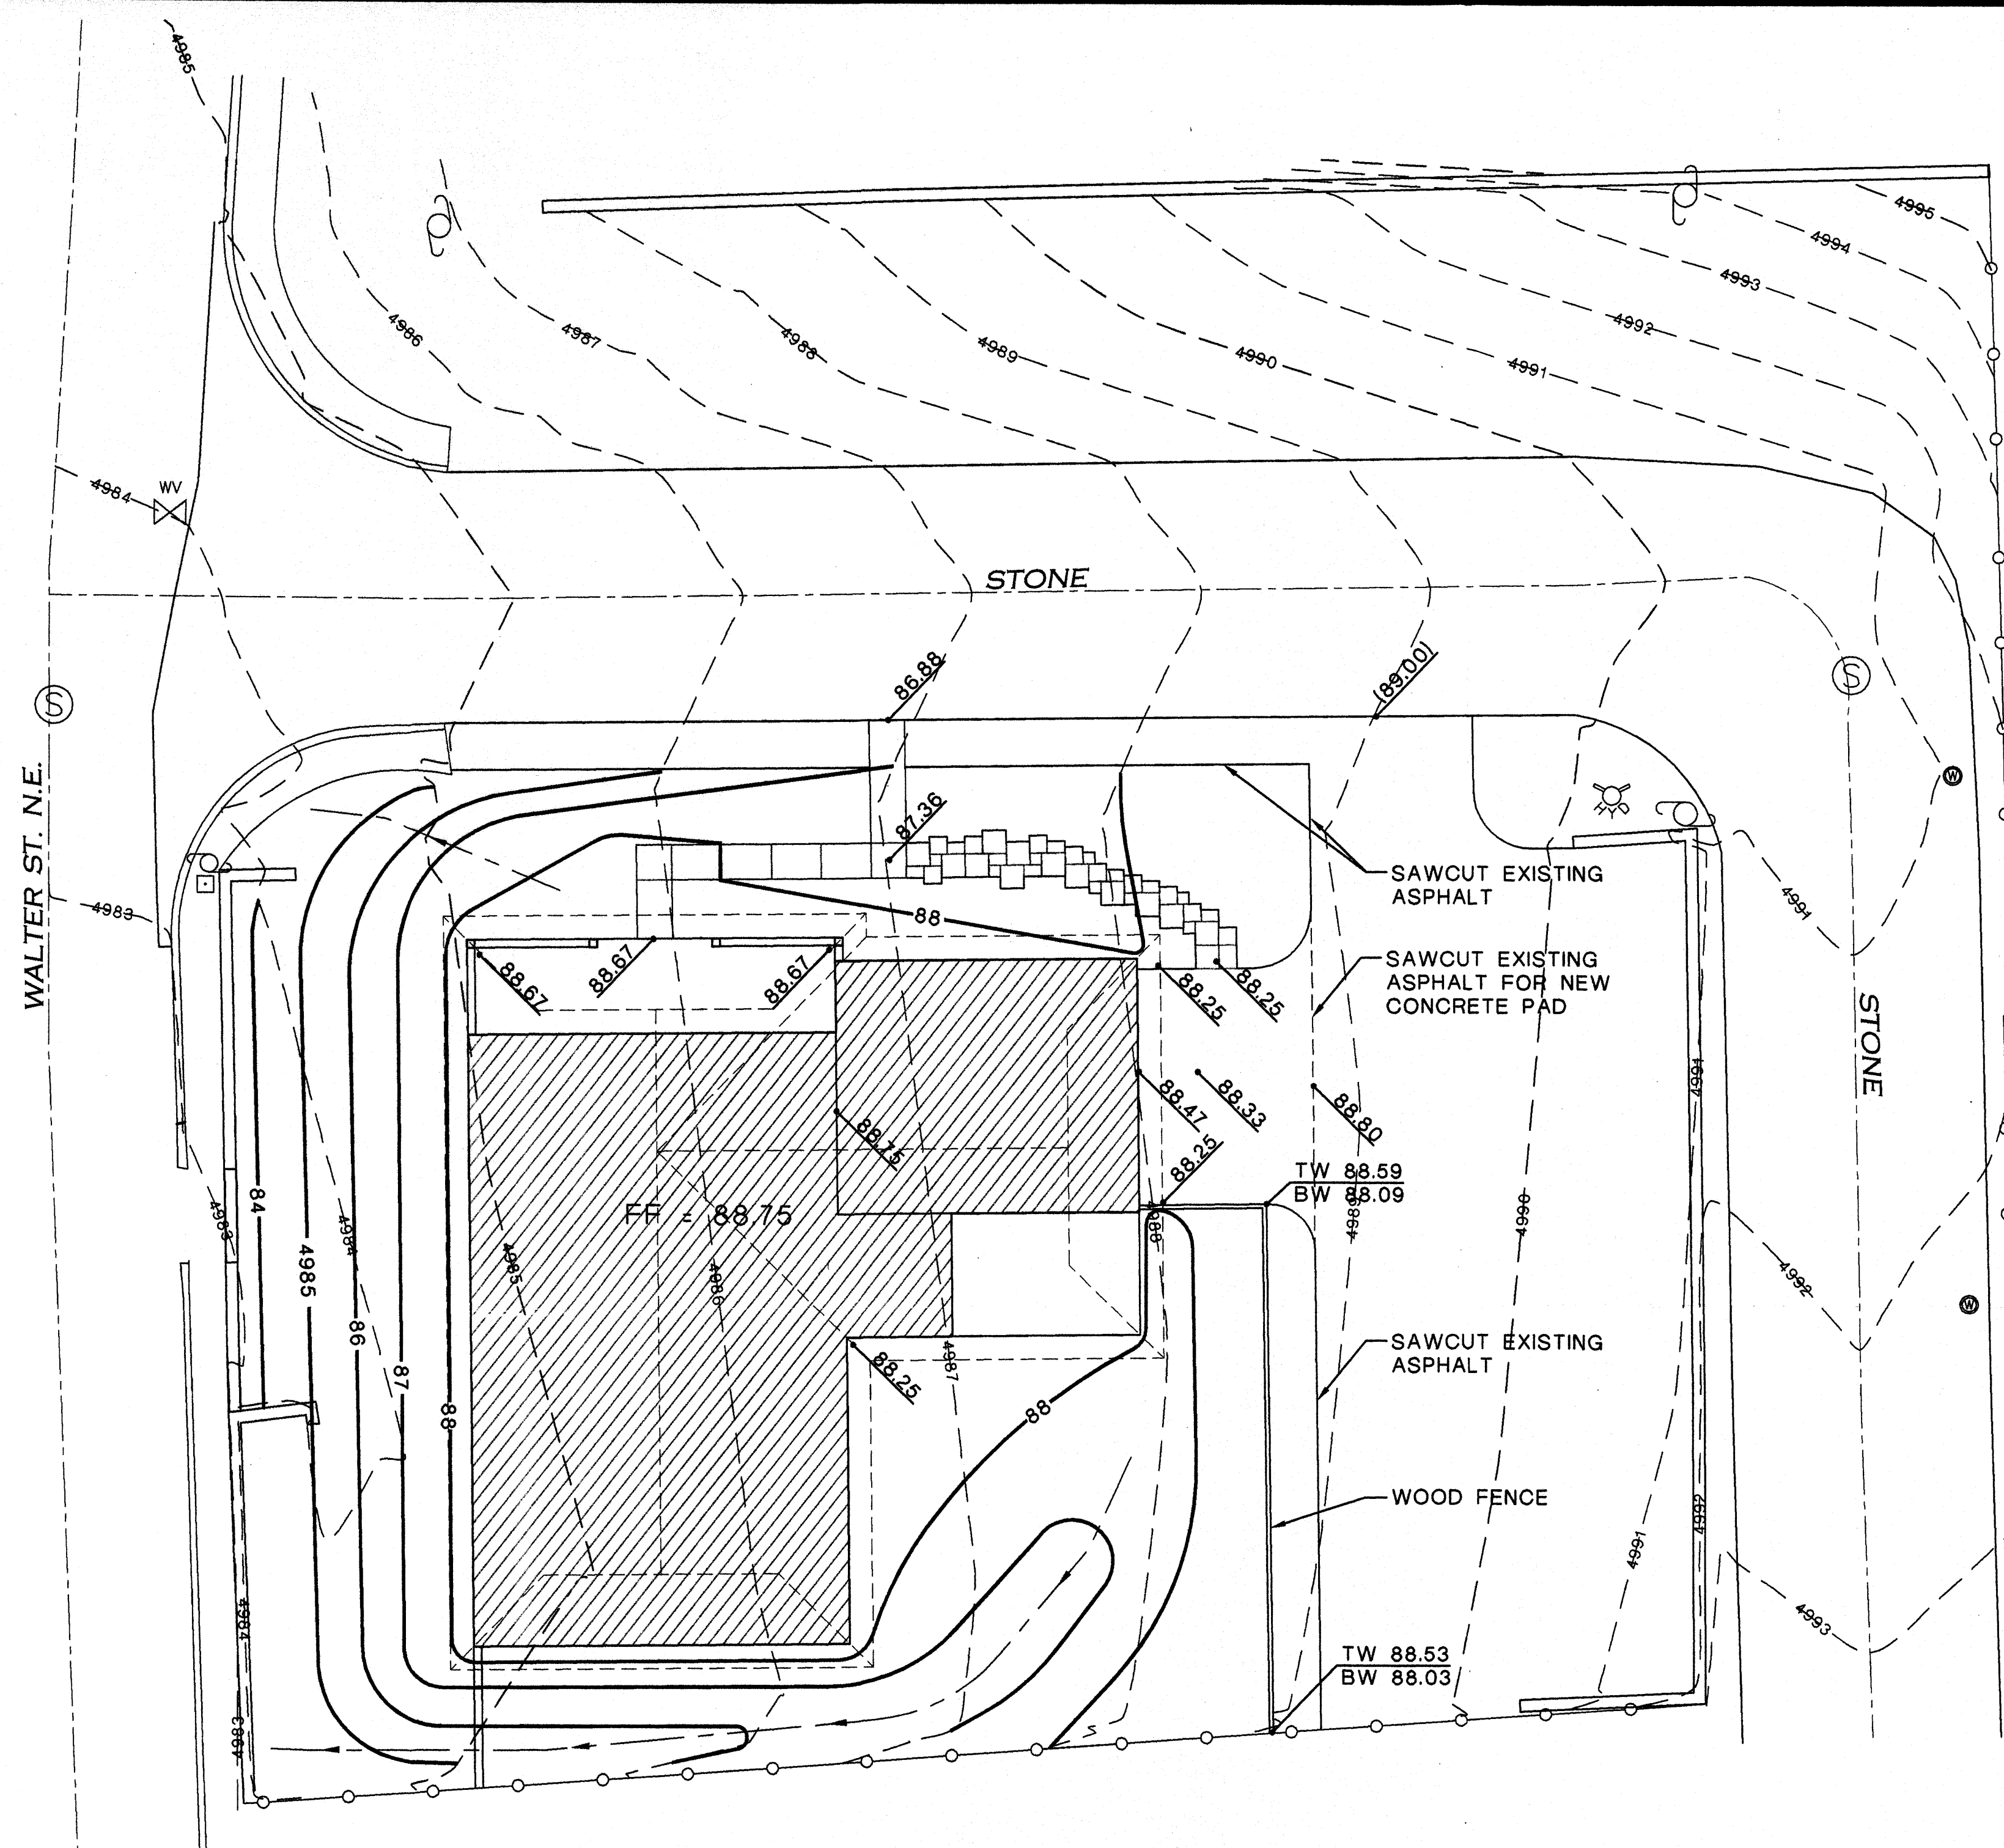

GRADING AND DRAINAGE PLAN

SCALE: 1" = 10'

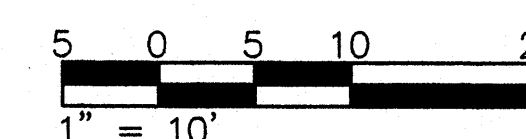



Engineer's Statement

I, THE ENGINEER OF RECORD CERTIFY THAT I HAVE PERSONALLY VISITED THE SITE AND THE EXISTING GRADES AND CONTOURS DEPICTED ON THIS PLAN MATCH WHAT PRESENTLY EXISTS AT THIS LOCATION

MARTIN J, GARCIA, NMPE #11767

Legend

---	5630	---	EXISTING CONTOUR
=====	5030	=====	NEW CONTOUR
●	30.11		NEW SPOT ELEVATION
●	(30.11)		EXISTING SPOT ELEVATION
TW			TOP OF WALL
BW			BOTTOM OF WALL
FF			FINISH FLOOR ELEVATION
---	▶	---	DIRECTION OF FLOW

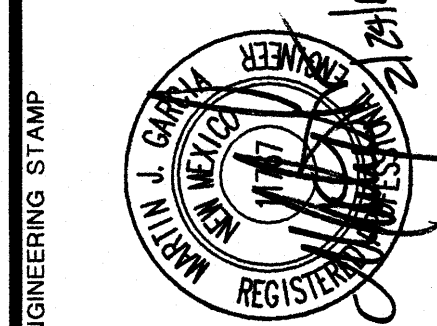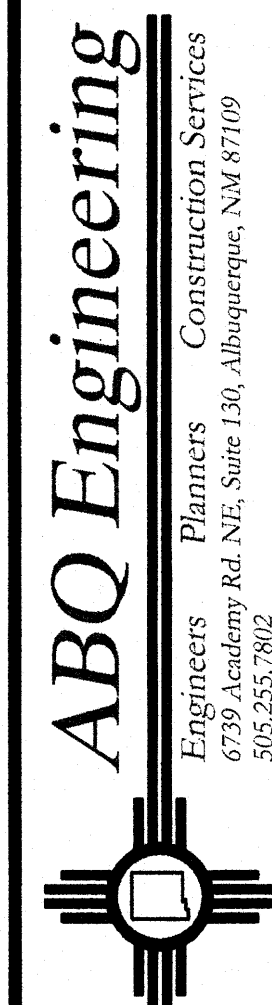

DO NOT SCALE DRAWINGS
CONTRACTOR TO VERIFY ALL
EXISTING CONDITIONS AND
DIMENSIONS- NOTIFY
ENGINEER/ARCHITECT OF ANY
DISCREPANCIES PRIOR TO
BEGINNING CONSTRUCTION

SAN YGNACIO CATHOLIC CHURCH
RESIDENCE
1226 WALTER STREET NE
ALBUQUERQUE, NEW MEXICO

DESIGNED BY:	M GARCIA	PROJECT NO.	10-004
DRAWN BY:	F PHILLIPS	DATE	FEBRUARY 24, 2010

SHEET TITLE

GRADING AND DRAINAGE PLAN

SHEET NUMBER


C-101

LAST MODIFIED: Feb 24, 2010 - 9:52am
 WC LOCATION: K:\Projects\2010\10-004\
 WC NAME: GRADINGS.MN C=101.dwg
 BY USER: Philips

RECEIVED
FEB 24 1987
HYDROLOGY
SECTION

DATE	FLUOROVARI 24, 2010
SIGNATURE	F. PHILLIPS

THESE DRAWINGS AS INSTRUMENTS OF SERVICE REMAIN THE PROPERTY OF THE ENGINEER. ANY CHANGES, PUBLICATION OR UNAUTHORIZED USE IS PROHIBITED UNLESS EXPRESSLY APPROVED BY THE ENGINEER. © 2010

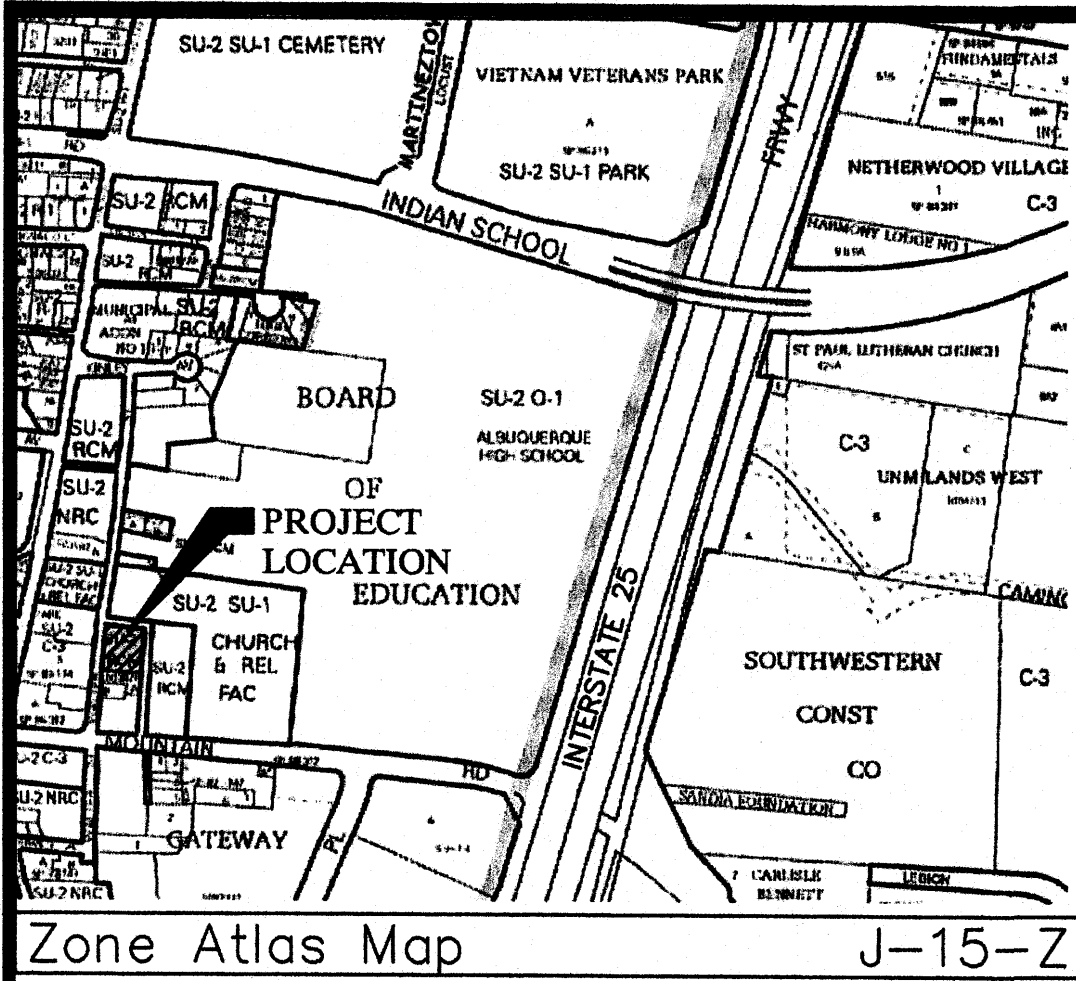

Legal Description

A LOT IN SECTION 16, TOWNSHIP 10 NORTH, RANGE 3 E, BEING 81.50x125 LYING EAST OR WALTER N.E. AND WEST OF STONE N.E.

Drainage Narrative

THE INTENT OF THIS GRADING AND DRAINAGE PLAN IS TO ACCOMMODATE A NEW RESIDENCE ON SITE. THE SITE IS CURRENTLY AN EXISTING PARKING LOT AND BOUNDED TO THE EAST, NORTH AND WEST BY EXISTING ROADWAY AND TO THE SOUTH, AN EXISTING RESIDENCE. THE SITE ALSO CURRENTLY SLOPES FROM THE EAST TO THE WEST AT 7% SLOPE. THE SITE IS NOT WITHIN A 100 YR FLOOD PLAIN.


THIS GRADING PLAN WILL REDUCE THE EXISTING FLOW FROM 1.08 CFS TO 0.70 CFS

Drainage Calculations

Hydrology Calculations
Date: January 25, 2010
DPM - Section 22.2
Volume 2, January 1993

Precipitation Zone	2
100 Year Storm Depth, P (360)	2.35
100 year Storm Depth, P (10 day)	3.95

Treatment Area	A	B	C	D
Excess Precipitation Factors	0.53	0.78	1.13	2.12
Peak Discharge Factors	1.56	2.28	3.14	4.7
Land Treatment Area	Acres	Existing	Proposed	
Type "D" (Roof)		0.23	0.05	
Type "C" (Unpaved Roadway)		0.00	0.06	
Type "B" (Irrigated Lawns)		0.00	0.12	
Type "A" (Undeveloped)		0.00	0.00	
Total (Acres)		0.23	0.23	
Excess Precipitation(in)		2.12	1.16	
Volume (100), cf		1769.99	970.66	
Volume (10), cf		1185.89	650.34	
Q (100), cfs		1.08	0.70	
Q (10), cfs		0.72	0.47	

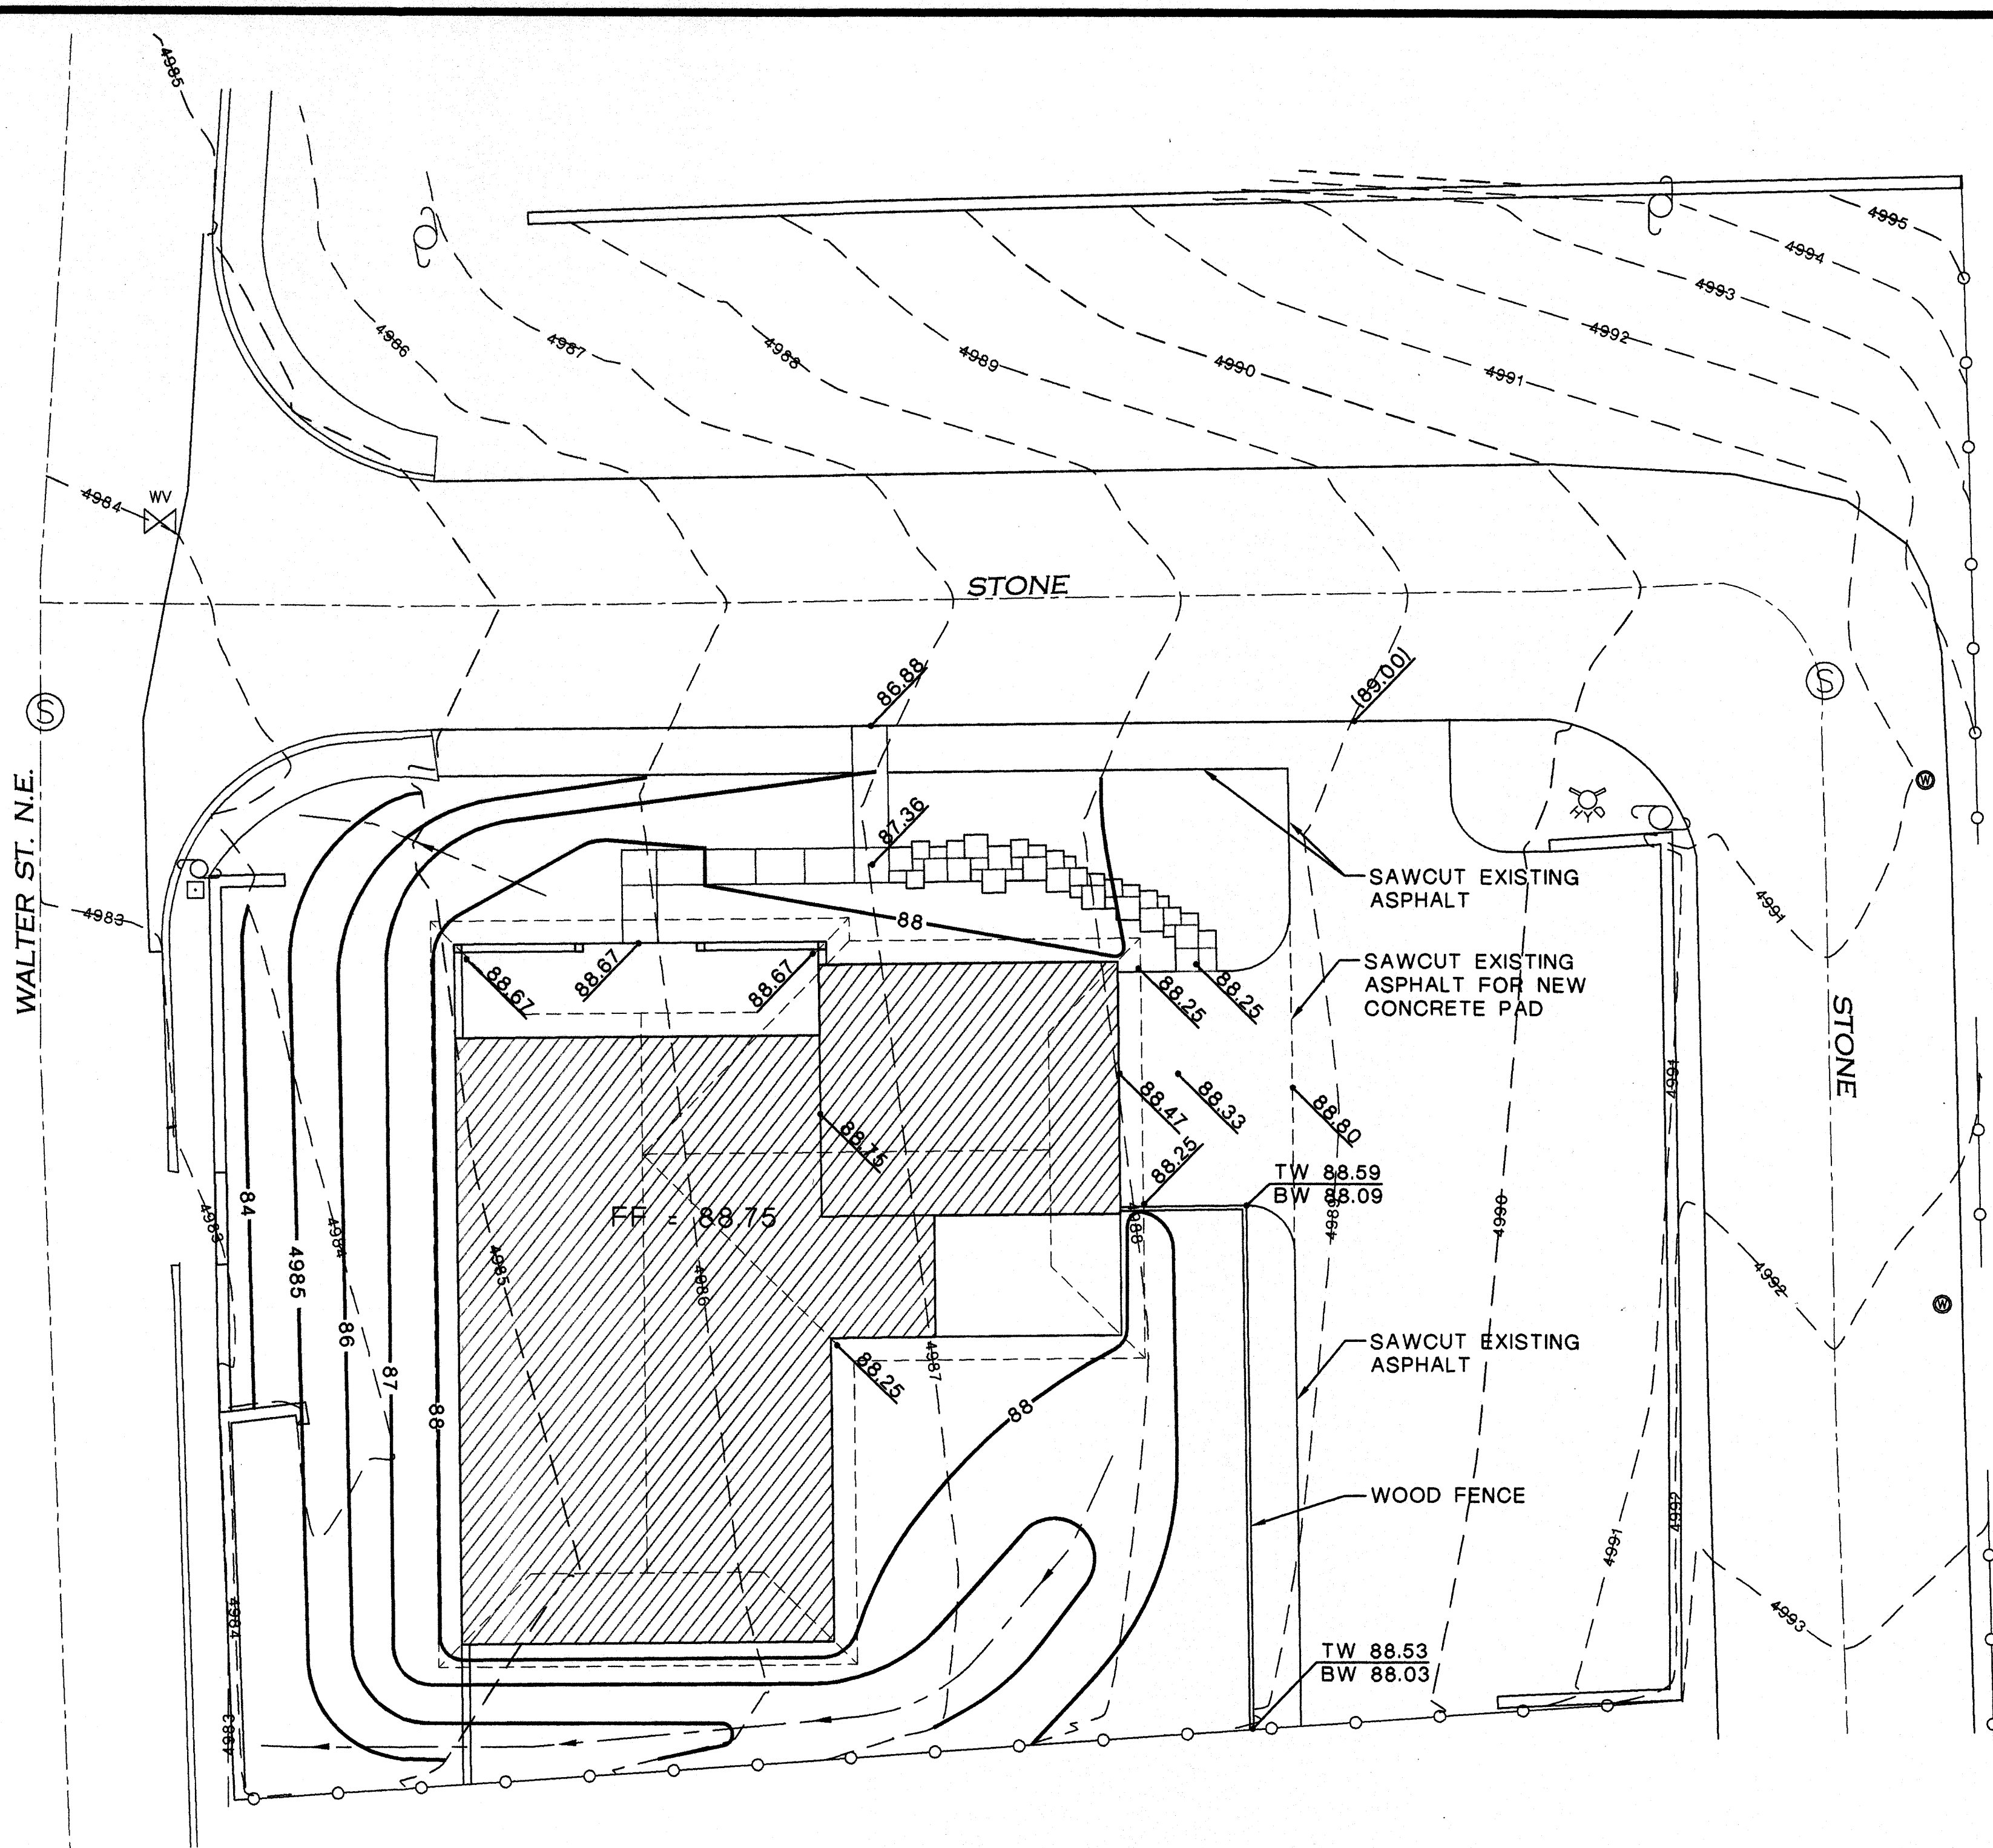



GRADING AND DRAINAGE PLAN

SCALE: 1" = 10'

Engineer's Statement


I, THE ENGINEER OF RECORD CERTIFY THAT I HAVE PERSONALLY VISITED THE SITE AND THE EXISTING GRADES AND CONTOURS DEPICTED ON THIS PLAN MATCH WHAT PRESENTLY EXISTS AT THIS LOCATION

MARTIN J. GARCIA, NMPE #11767

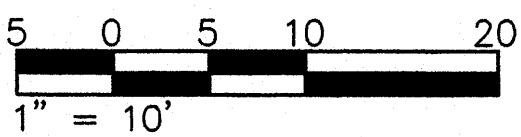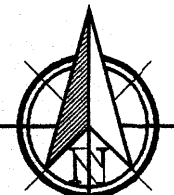

Legend

- - - 5030 - - -	EXISTING CONTOUR
— 5030 —	NEW CONTOUR
• 30.11	NEW SPOT ELEVATION
• (30.11)	EXISTING SPOT ELEVATION
TW	TOP OF WALL
BW	BOTTOM OF WALL
FF	FINISH FLOOR ELEVATION
—>—>—>	DIRECTION OF FLOW

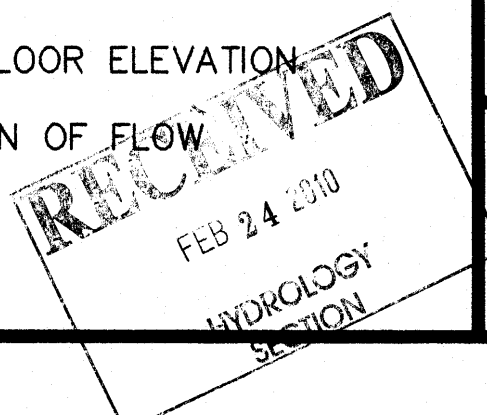

ABO Engineering
Engineers Planners Construction Services
6739 Academy Rd. NE, Suite 130, Albuquerque, NM 87109
505.255.7802

ENGINEERING STAMP
MARTIN J. GARCIA
REGISTERED PROFESSIONAL ENGINEER
STATE OF NEW MEXICO
#11767

DO NOT SCALE DRAWINGS.
CONTRACTOR TO VERIFY ALL
EXISTING CONDITIONS AND
DIMENSIONS. NOTIFY
ENGINEER/ARCHITECT OF ANY
DISCREPANCIES PRIOR TO
BEGINNING CONSTRUCTION

SAN YGNACIO CATHOLIC CHURCH
RESIDENCE
1226 WALTER STREET NE
ALBUQUERQUE, NEW MEXICO

DESIGNED BY: M. GARCIA
DRAWN BY: F. PHILLIPS
PROJECT NO. 10-004
DATE FEBRUARY 24, 2010

SHEET TITLE
GRADING AND DRAINAGE PLAN

SHEET NUMBER
C-101

