



TYPICAL SIX-INCH CURB & GUTTER

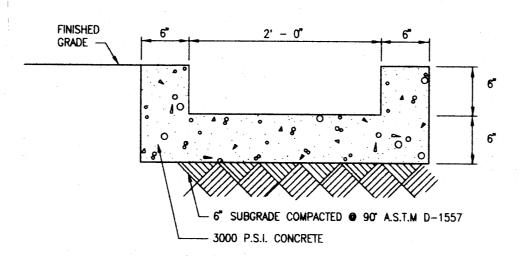

SECTION A-A

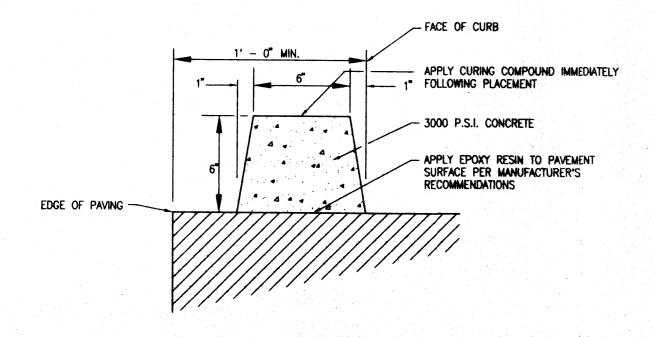

TYPICAL EXTRUDED CONCRETE CURB SECTION

2" ASPHALTIC CONCRETE SURFACE COURSE,


EMULSIFIED ASPHALTIC TACK COAT

1800 # STABILITY

2" ASPHALTIC CONCRETE BASE COURSE.

— 6" SUBGRADE COMPACTED ● 95% A.S.T.M. D-1557

TYPICAL PRIVATE PAVING SECTION

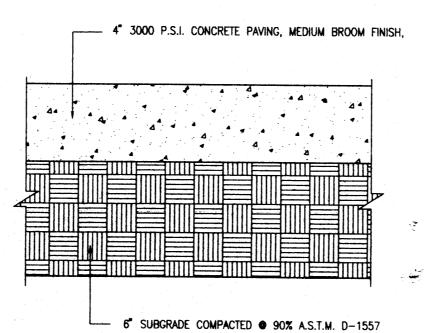

TYPICAL CONCRETE SIDEWALK SECTION

SCALE: 1" = 5"

DRAINAGE PLAN

The following items concerning the Mountain Road Closure Drainage Plan are contained hereon:

Vicinity Map
 Demolition Plan
 Grading and Paving Plan
 Sections and Details

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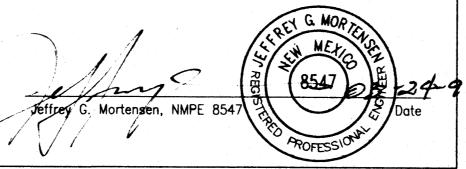
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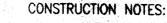
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culvert will have a 1.8 cfs weir capacity. Using the equation of  $Q = CLH\sim S3/2\sim s$  where C = 2.6, L = 2.0 and H = 1.5. The two culverts have a combined capacity of 3.6 cfs. This corresponds to an area of 0.77 acres which is 100% impervious (Treatment D) in Zone 2 (3.6/4.70 = 0.77 acres). The contributing area is approximately 44 feet wide and 200 feet long which corresponds to 0.2 acres. This analysis clearly demonstrates that the two sidewalk culverts proposed have adequate capacity.

CERTIFICATION

As indicated by the as—built information shown hereon, this project has been graded and drained in substantial compliance with the approved Plan. The as—built information shown hereon has been obtained by me or under my direct supervision and is true and correct to the best of my knowledge and belief.






- 1. ALL WORK DETAILED ON THESE PLANS TO BE PERFORMED UNDER CONTRACT SHALL, EXCEPT AS OTHERWISE STATED OR PROVIDED FOR HEREON, BE CONSTRUCTED IN ACCORDANCE WITH THE NEW MEXICO STANDARD SPECIFICATIONS FOR PUBLIC WORKS CONSTRUCTION 1987, PUBLISHED BY THE NEW MEXICO CHAPTER AMERICAN PUBLIC WORKS ASSOCIATION.
- 2. TWO (2) WORKING DAYS PRIOR TO ANY EXCAVATION, CONTRACTOR MUST CONTACT NEW MEXICO ONE CALL SYSTEM, 260-1990 (ALBUQUERQUE AREA), 1-800-321-ALERT(2537) (STATEWIDE), AND U.N.M. PHYSICAL PLANT (277-2421). FOR LOCATION OF EXISTING UTILITIES.
- 3. IF ANY UTILITY LINES, PIPELINES, OR UNDERGROUND UTILITY LINES ARE SHOWN ON THESE DRAWINGS, THEY ARE SHOWN IN AN APPROXIMATE MANNER ONLY, AND SUCH LINES MAY EXIST WHERE NONE ARE SHOWN. IF ANY SUCH EXISTING LINES ARE SHOWN, THE LOCATION IS BASED UPON INFORMATION PROVIDED BY THE OWNER OF SAID UTILITY, AND THE INFORMATION MAY BE INCOMPLETE, OR MAY BE OBSOLETE BY THE TIME CONSTRUCTION COMMENCES. THE ENGINEER HAS CONDUCTED ONLY PRELIMINARY INVESTIGATION OF THE LOCATION, DEPTH, SIZE, OR TYPE OF EXISTING UTILITY LINES, PIPELINES, OR UNDERGROUND UTILITY LINES. THIS INVESTIGATION IS NOT CONCLUSIVE, AND MAY NOT BE COMPLETE, THEREFORE, MAKES NO REPRESENTATION PERTAINING THERETO, AND ASSUMES NO RESPONSIBILITY OR LIABILITY THEREFORE. THE CONTRACTOR SHALL INFORM ITSELF OF THE LOCATION OF ANY UTILITY LINE, PIPELINE, OR UNDERGROUND UTILITY LINE IN OR NEAR THE AREA OF THE WORK IN ADVANCE OF AND DURING EXCAVATION WORK. THE CONTRACTOR IS FULLY RESPONSIBLE FOR ANY AND ALL DAMAGE CAUSED BY ITS FAILURE TO LOCATE, IDENTIFY AND PRESERVE ANY AND ALL EXISTING UTILITIES, PIPELINES, AND UNDERGROUND UTILITY LINES. IN PLANNING AND CONDUCTING EXCAVATION, THE CONTRACTOR SHALL COMPLY WITH STATE STATUTES, MUNICIPAL AND LOCAL ORDINANCES, RULES AND REGULATIONS, IF ANY, PERTAINING TO THE LOCATION OF THESE LINES AND
- 4. SHOULD A CONFLICT EXIST BETWEEN THESE PLANS AND ACTUAL FIELD CONDITIONS, THE CONTRACTOR SHALL PROMPTLY NOTIFY THE ENGINEER IN WRITING SO THAT THE CONFLICT CAN BE RESOLVED WITH A MINIMUM AMOUNT OF DELAY FOR ALL PARTIES. THE CONTRACTOR SHALL BE RESPONSIBLE FOR ALL INTERPRETATIONS IT MAKES WITHOUT FIRST CONTACTING THE ENGINEER AS REQUIRED ABOVE.
- 5: THE CONTRACTOR SHALL MAINTAIN ACCESS TO ADJACENT PROPERTIES AND FACILITIES DURING CONSTRUCTION.
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- 7. THE CONTRACTOR SHALL ENSURE THAT NO SOIL ERODES FROM THE SITE INTO PUBLIC RIGHT-OF-WAY OR ONTO PRIVATE PROPERTY. THIS CAN BE ACHIEVED BY CONSTRUCTING AND MAINTAINING TEMPORARY BERMS AT THE PROPERTY LINES AND WETTING THE SOIL TO KEEP IT FROM BLOWING.
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- 9 CONTRACTOR SHALL SECURE "TOPSOIL DISTURBANCE PERMIT" PRIOR TO BEGINNING CONSTRUCTION.
- 1D. CONTRACTOR SHALL NOTIFY THE ENGINEER NOT LESS THAN SEVEN (7) DAYS PRIOR TO STARTING WORK IN ORDER THAT THE ENGINEER MAY TAKE NECESSARY MEASURES TO ENSURE THE PRESERVATION OF SURVEY MONUMENTS. CONTRACTOR SHALL NOT DISTURB PERMANENT SURVEY MONUMENTS WITHOUT THE CONSENT OF THE ENGINEER AND SHALL NOTIFY THE ENGINEER AND BEAR THE EXPENSE OF REPLACING ANY THAT MAY BE DISTURBED WITHOUT PERMISSION. REPLACEMENT SHALL BE DONE ONLY BY THE ENGINEER. WHEN A CHANGE IS MADE IN THE FINISHED ELEVATION OF THE PAVEMENT OF ANY ROADWAY IN WHICH A PERMANENT SURVEY MONUMENT IS LOCATED, CONTRACTOR SHALL, AT HIS OWN EXPENSE, ADJUST THE MONUMENT COVER TO THE NEW GRADE UNLESS OTHERWISE SPECIFIED.
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APPROVALS	NAME	DATE		
A.C.E./DESIGN				
INSPECTOR				
A.C.E./FIELD				



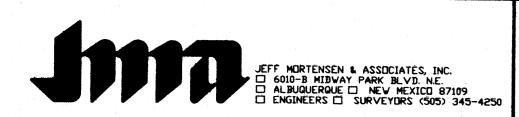

RECORD DRAWING

- NEATLY SAWCUT EXISTING


EDGE & APPLY TACK COAT


PRIOR TO PATCHING

PAVING; THOROUGHLY CLEAN


DRAINAGE PLAN, SECTIONS, DETAILS AND NOTES MOUNTAIN ROAD CLOSURE

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	NO.	DATE	BY	REVISIONS	JOB NO.
DESIGNED BY J.G.M.	A	02/97	MDS	AS-BUILT & CERTIFY	960691
MALIN BY C.J.H.					DATE 07/06
DRAWN BY C.J.n.					07/96
APPROVED BY J.G.M.					SHEET OF
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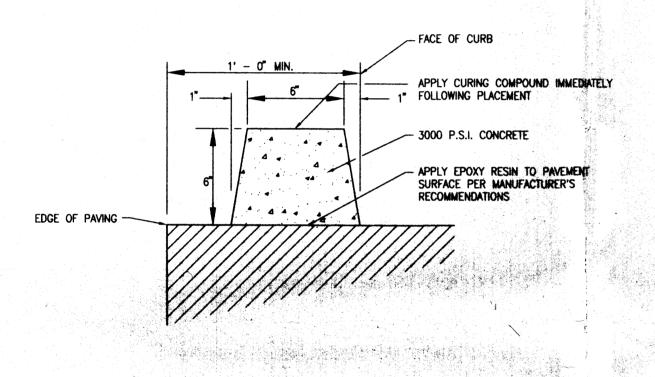


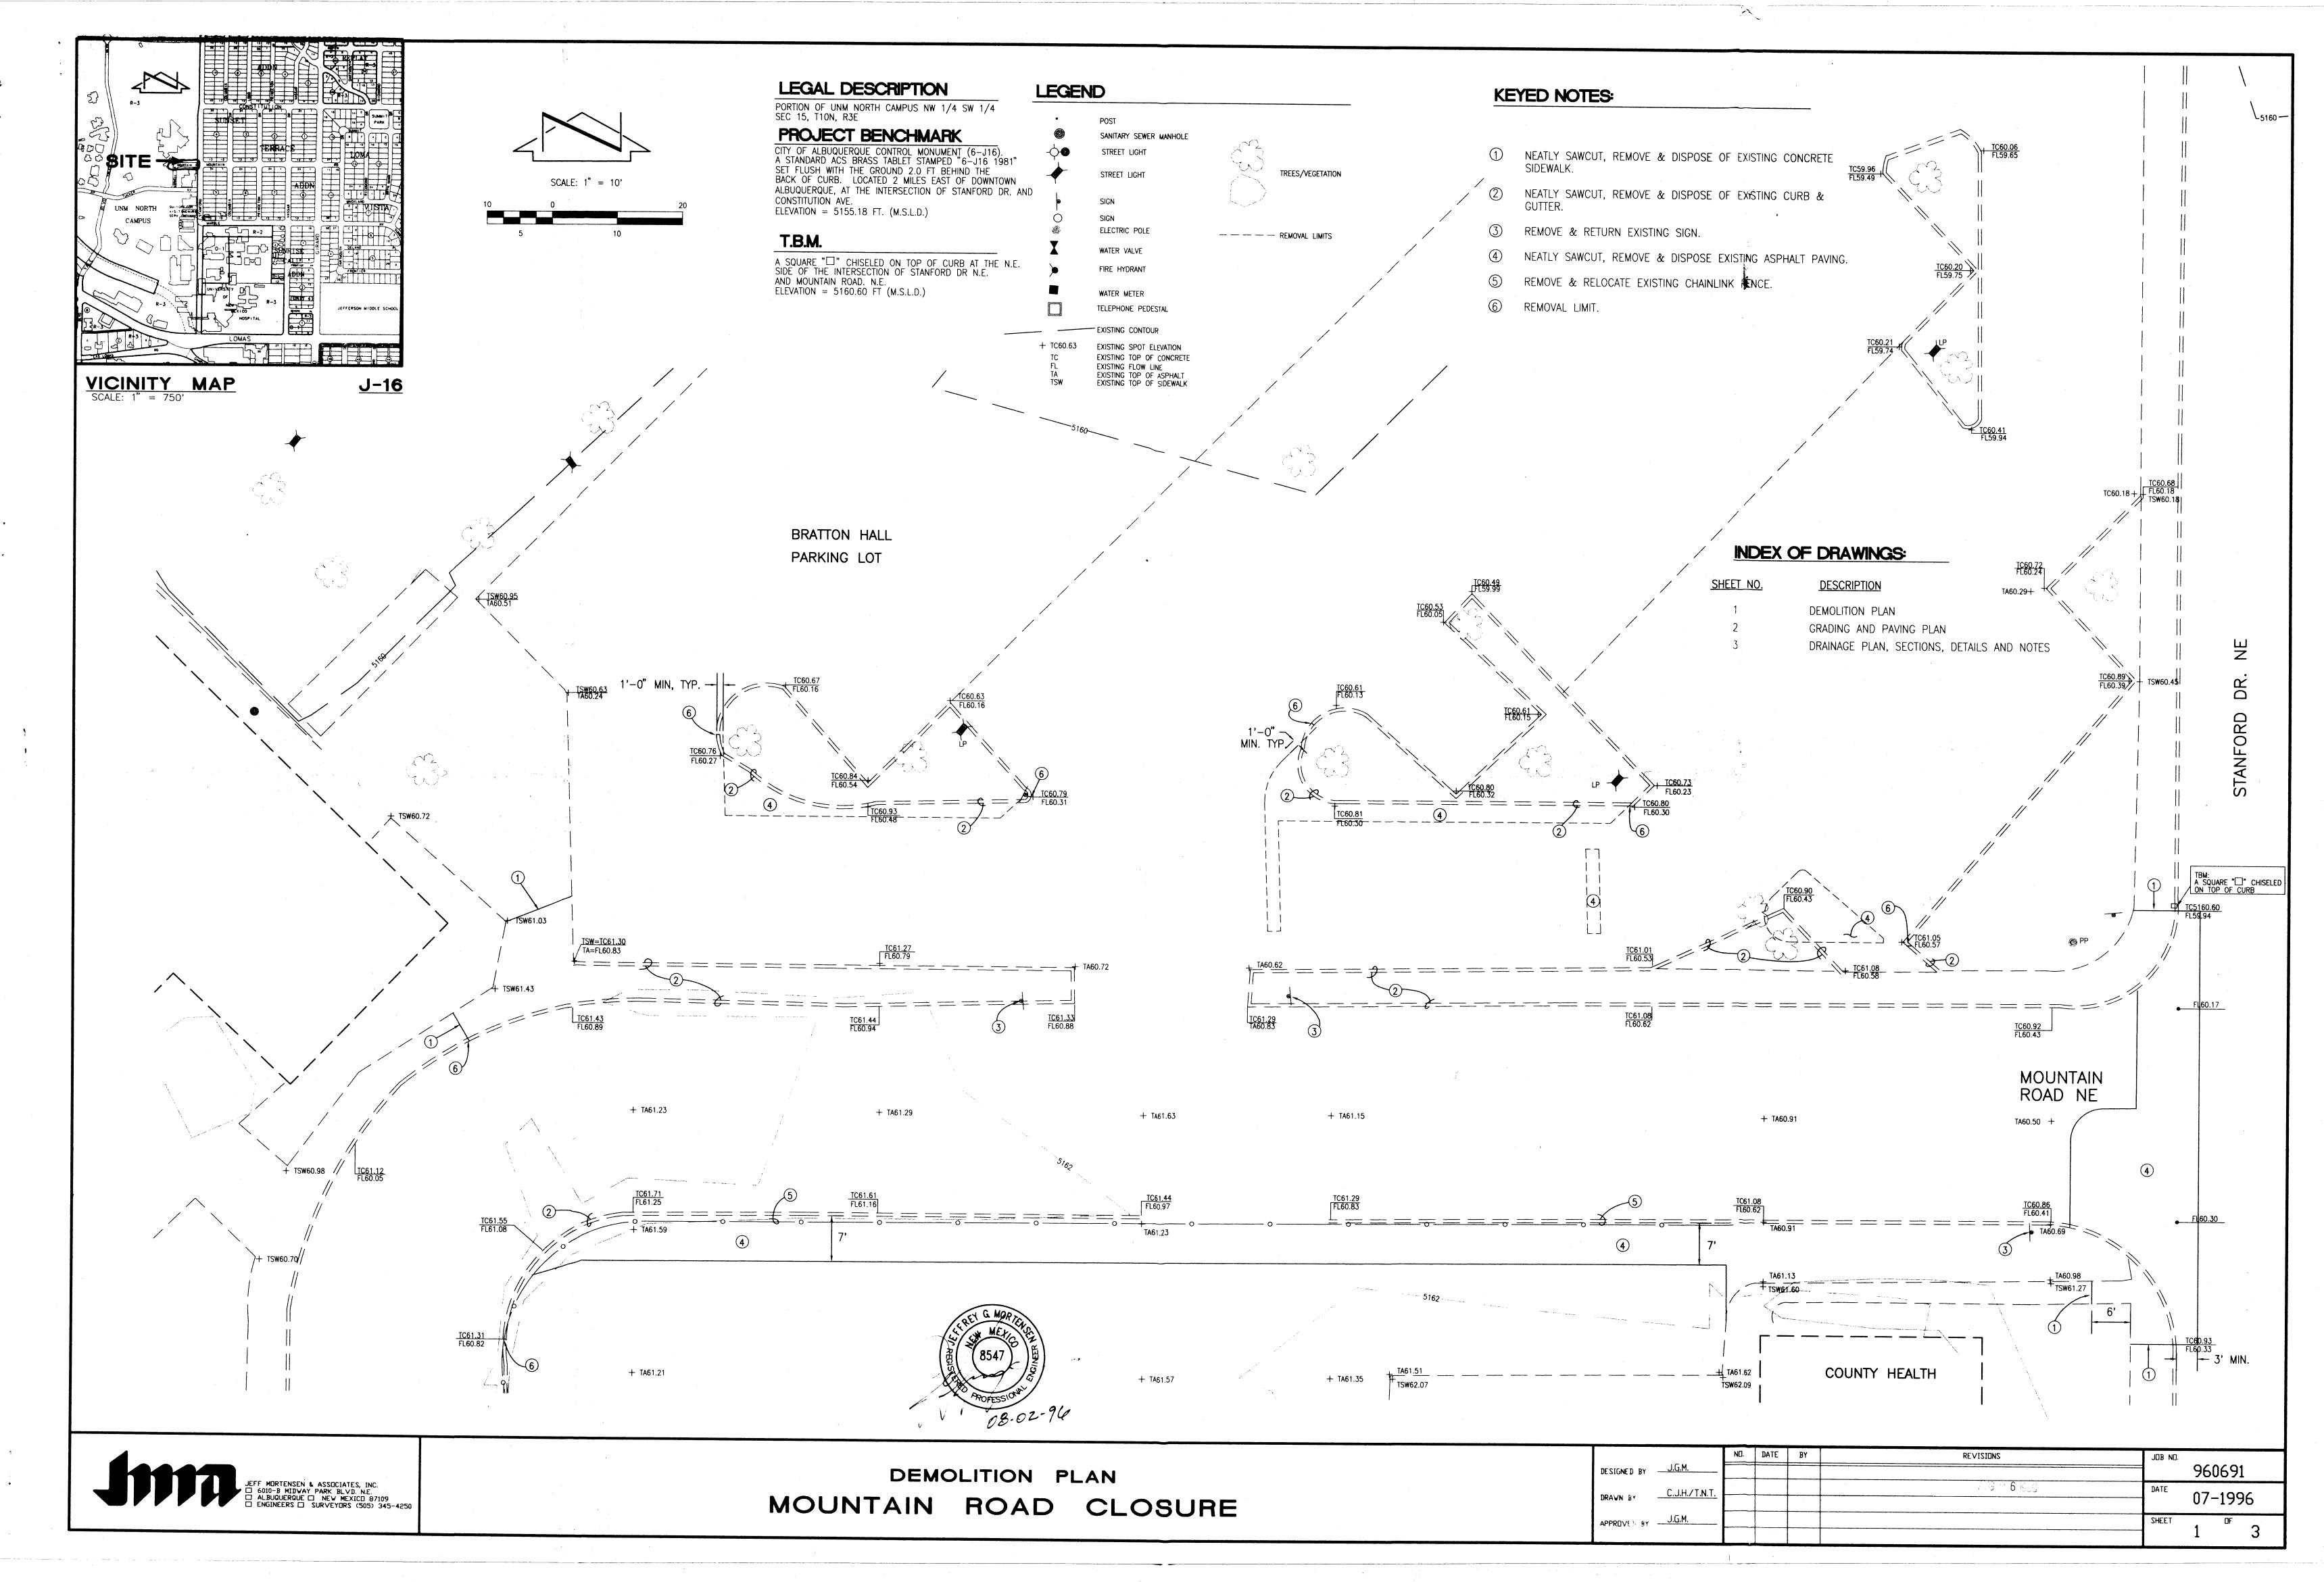

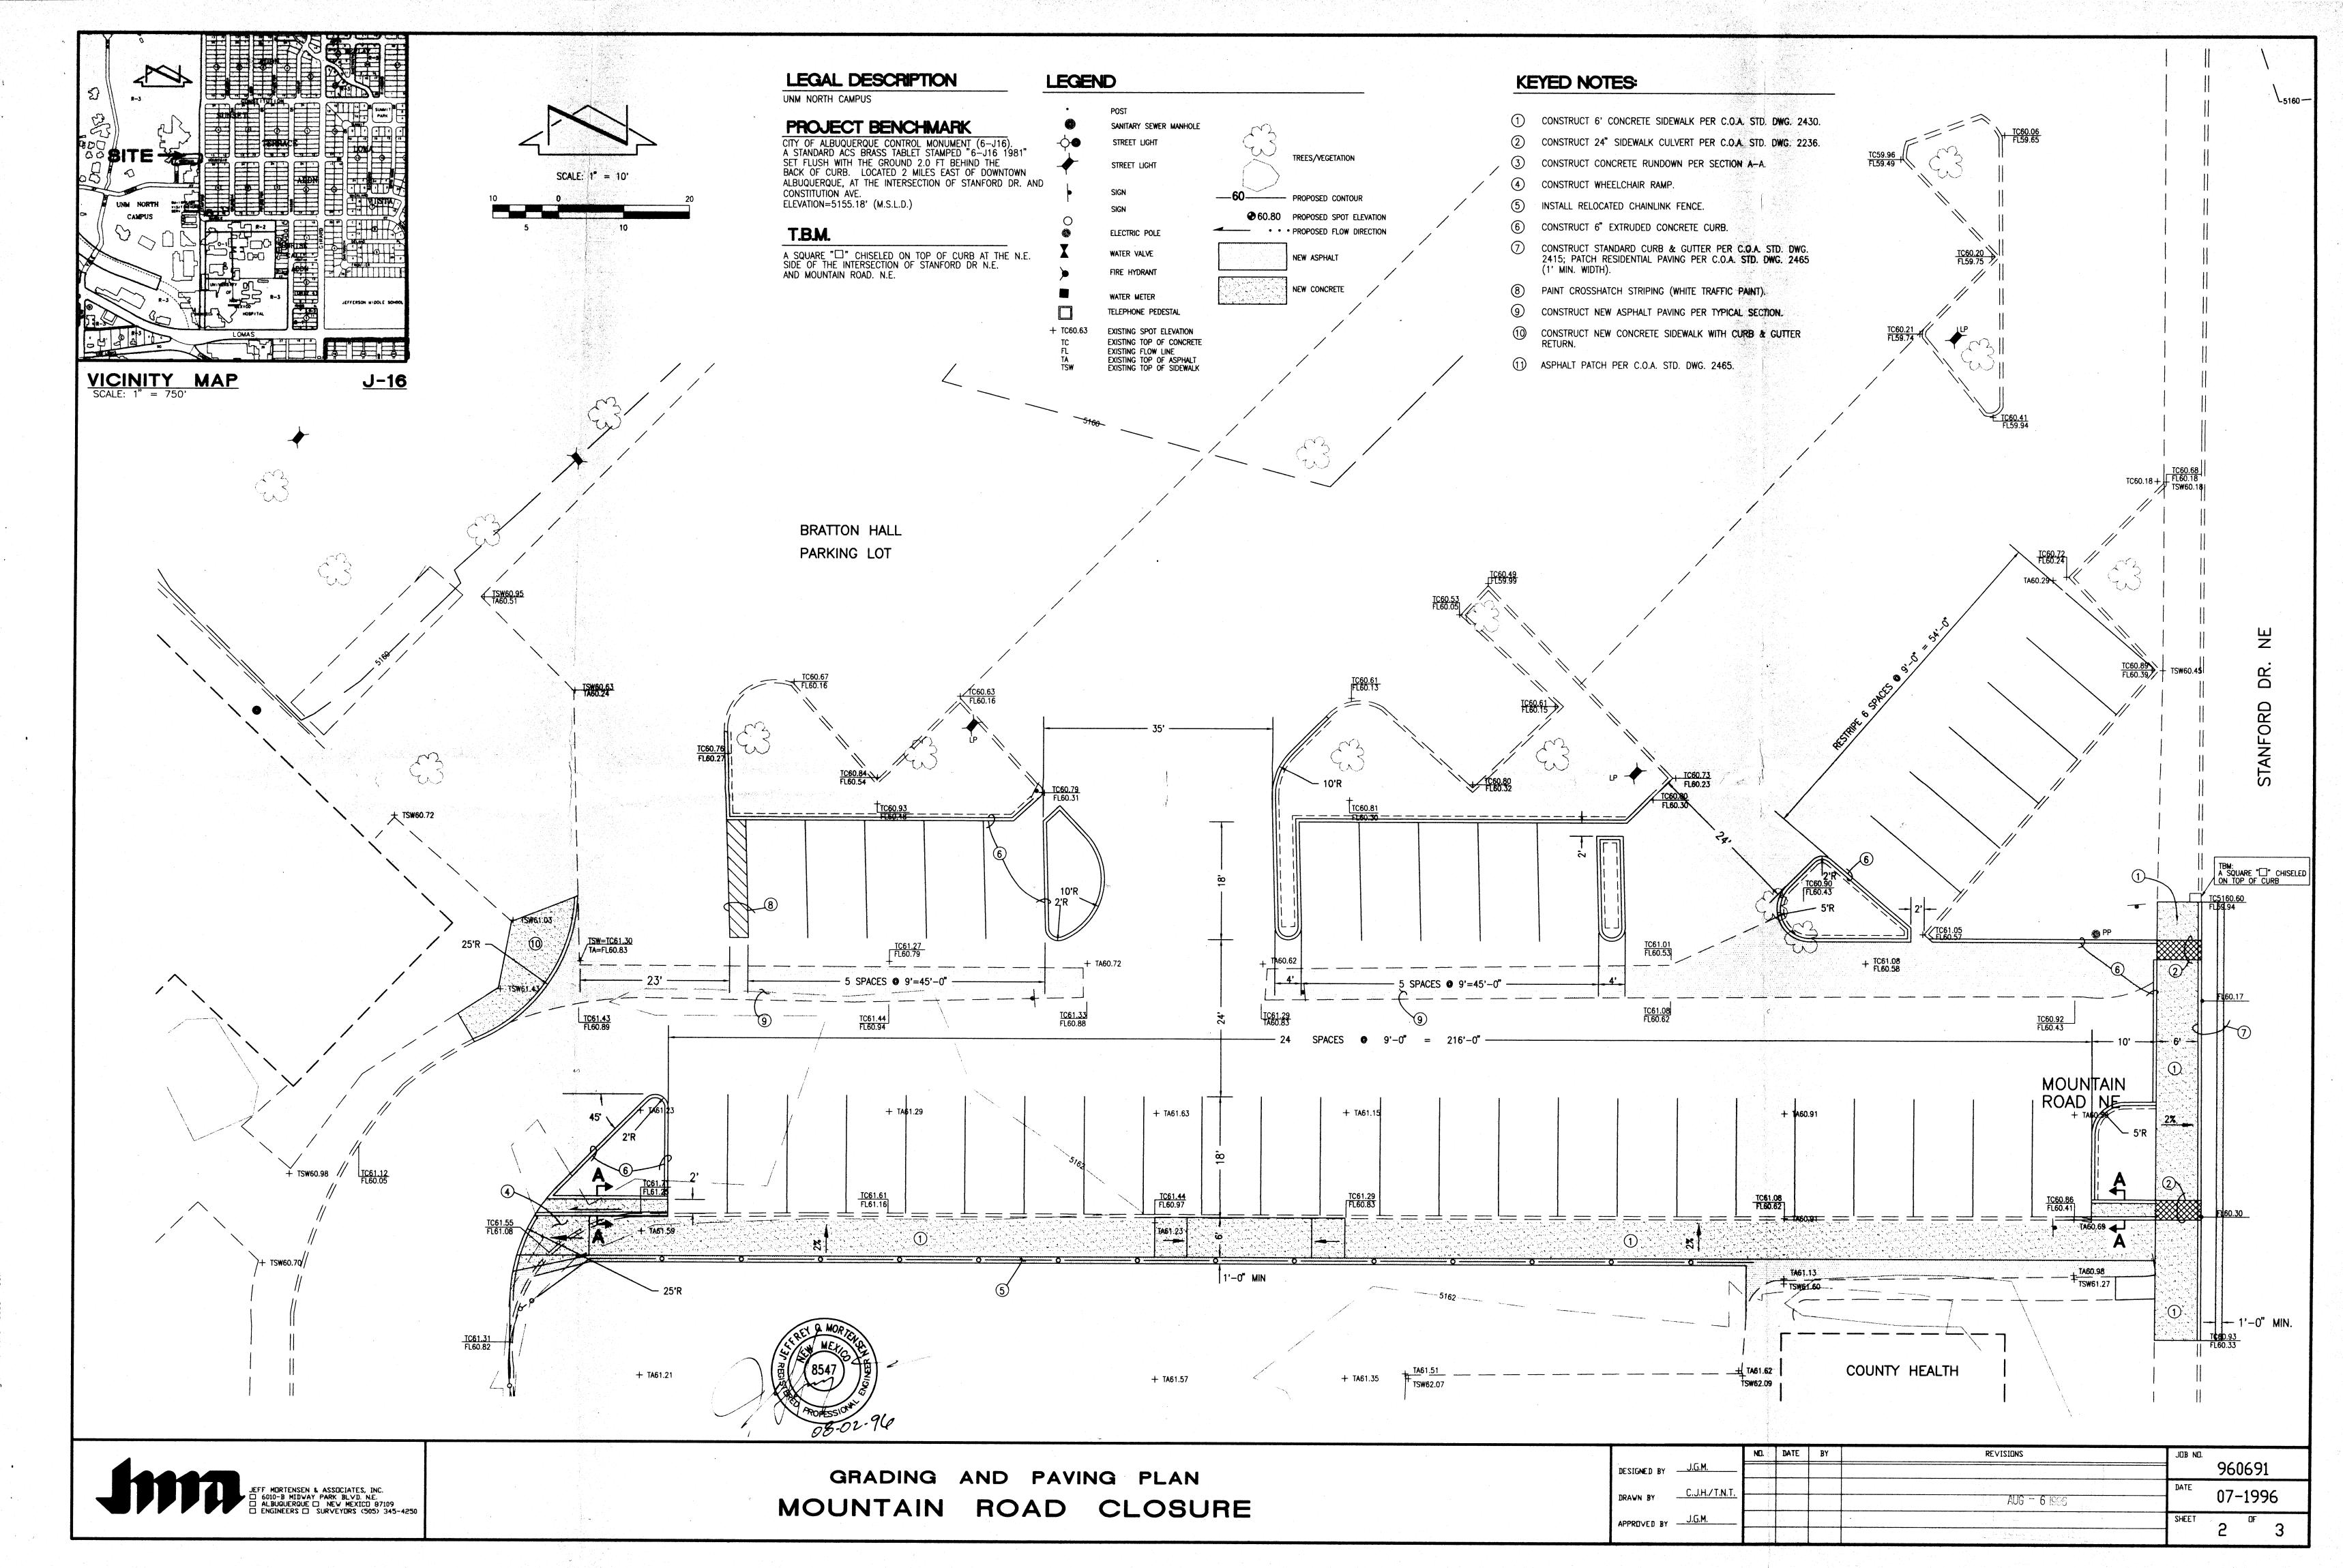
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TYPICAL SIX-INCH CURB & GUTTER

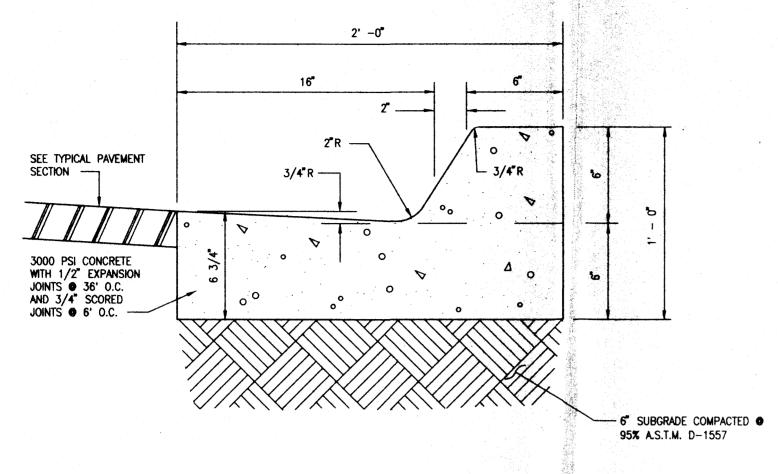


TYPICAL EXTRUDED CONCRETE CURB SECTION




TYPICAL PRIVATE PAVING SECTION

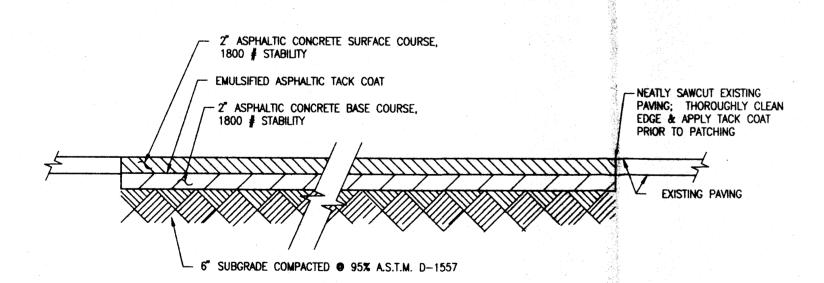SCALE: 1" = 1' - 0"

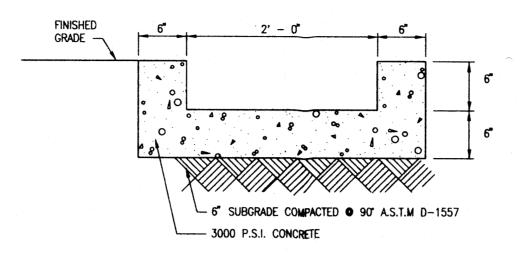

SECTION A-A

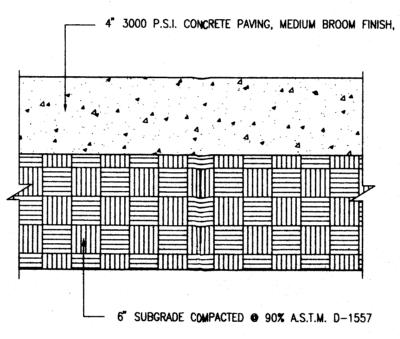

TYPICAL CONCRETE SIDEWALK SECTION

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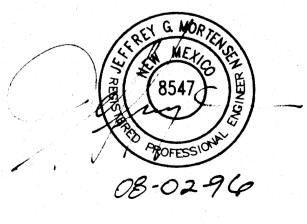
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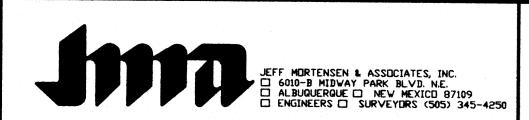
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APPROVALS.	NAME	DATE
A.C.E./DESIGN	Burne Monteys	8/28/91
INSPECTOR		
A.C.E./FIELD	4	





DRAINAGE PLAN, SECTIONS, DETAILS AND NOTES MOUNTAIN ROAD CLOSURE

		NQ.	DATE	BY	REVISIONS	JOB NO.	
SIGNED BY	J.G.M.						960691
AWN BY C.J.H.	CIH				∐_ AUG - 6 1996	DATE	07/96
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PROVED BY	J.G.M				THUNGLOUT DIVINE	SHEET	OF O
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