## CITY OF ALBUQUERQUE



July 27, 2018

Stephen A. Dunbar, RA Modulus Architects 100 Sun Ave. Ste. 305 Albuquerque, NM 87109

Re: Winrock-Mens Warehouse

2100 Louisianna Blvd. NE

30-Day Temporary Certificate of Occupancy- Transportation Development

**Transportation Development Final Inspection** 

Engineer's/Architect's Stamp dated 02-19-18 (J19D058F)

Certification dated 07-19-18

Dear Mr. Dunbar

Based upon the information provided in your submittal received 07-27-18, Transportation Development has no objection to the issuance of a <u>30-day Temporary Certificate of Occupancy</u>. This letter serves as a "green tag" from Transportation Development for a <u>30-day Temporary Certificate of Occupancy</u> to be issued by the Building and Safety Division.

PO Box 1293

Prior to the issuance of a permanent Certificate of Occupancy, the following items must be addressed:

Albuquerque

- Build Sidewalk Connection.
- 2. Add "No Parking" marking to ADA access aisle.

NM 87103

Once corrections are complete resubmit acceptable package along with fully completed Drainage Transportation Information Sheet to front counter personnel for log in and evaluation by Transportation. For digital submittal and minor comments and/or repairs, please submit photos to <a href="mailto:PLNDRS@cabq.gov">PLNDRS@cabq.gov</a> prior to submittal. If you have any questions, please contact me at (505) 924-3891.

www.cabq.gov

Sincerely,

Ernie Gomez

Plan Checker, Transportation & Hydrology

**Development Review Services** 

Racquel M. Michel, P.E.


Traffic Engineer, Planning Dept. Development Review Services


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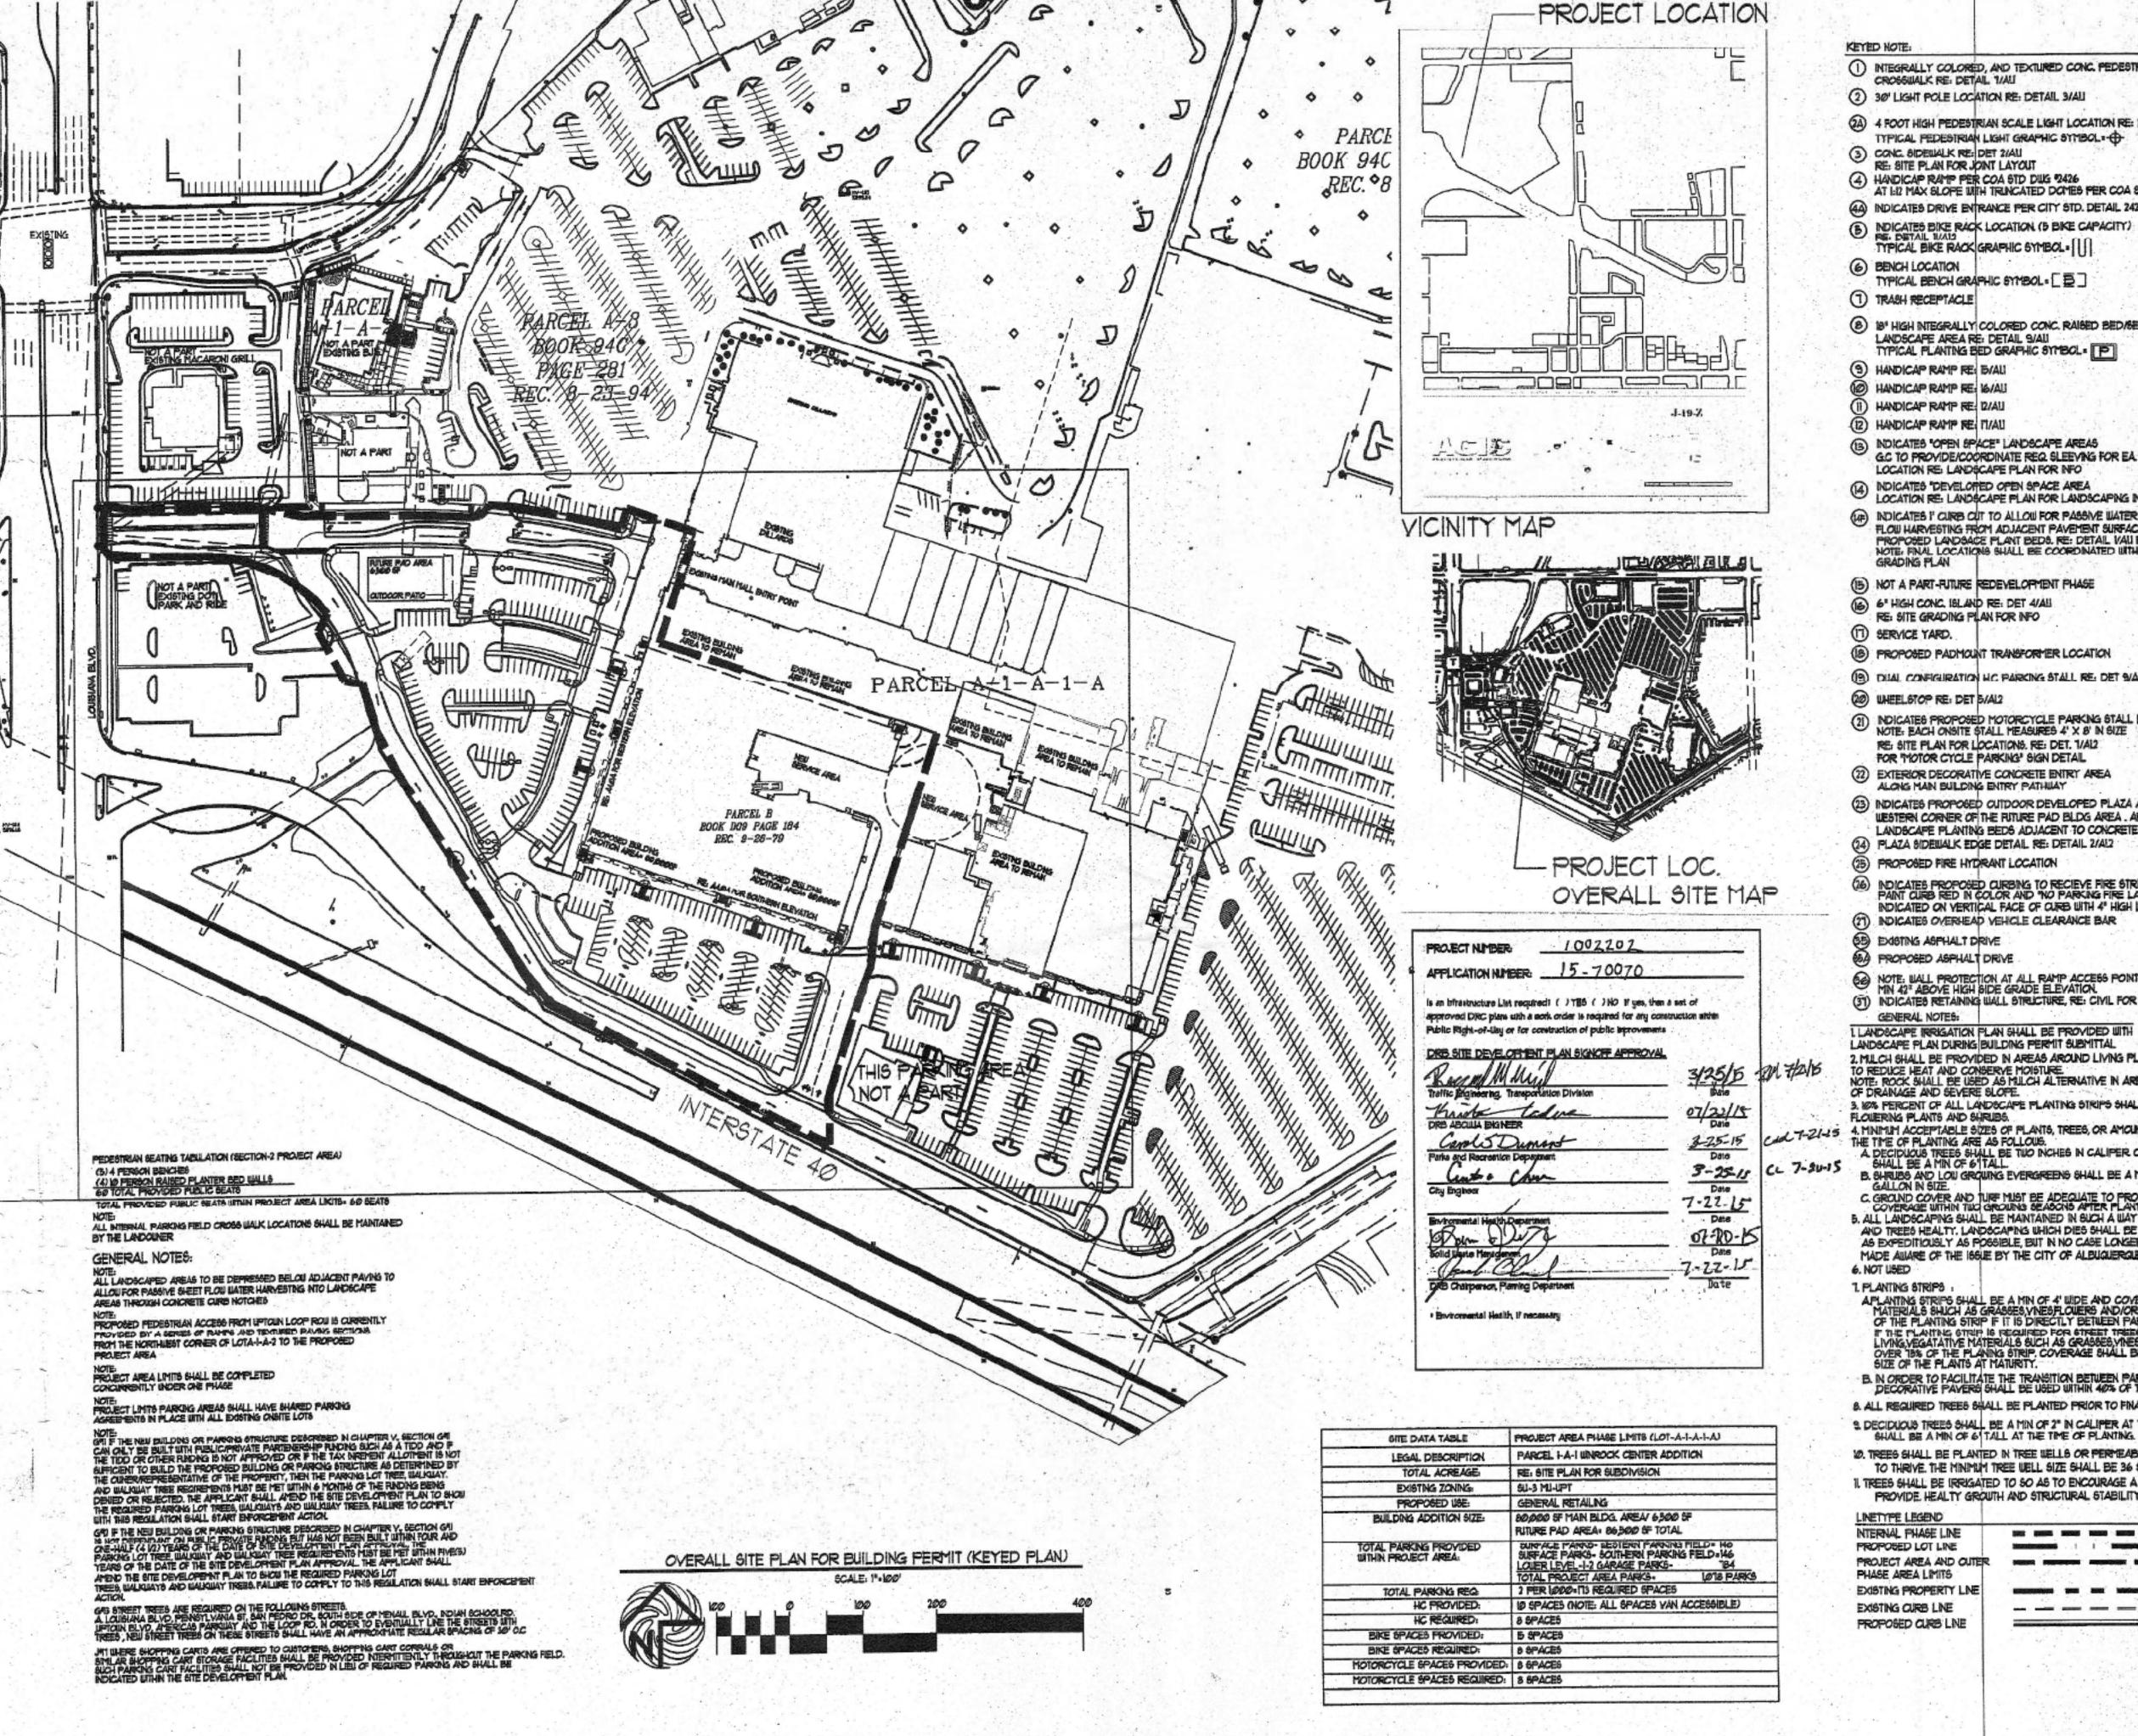
C: CO Clerk, File







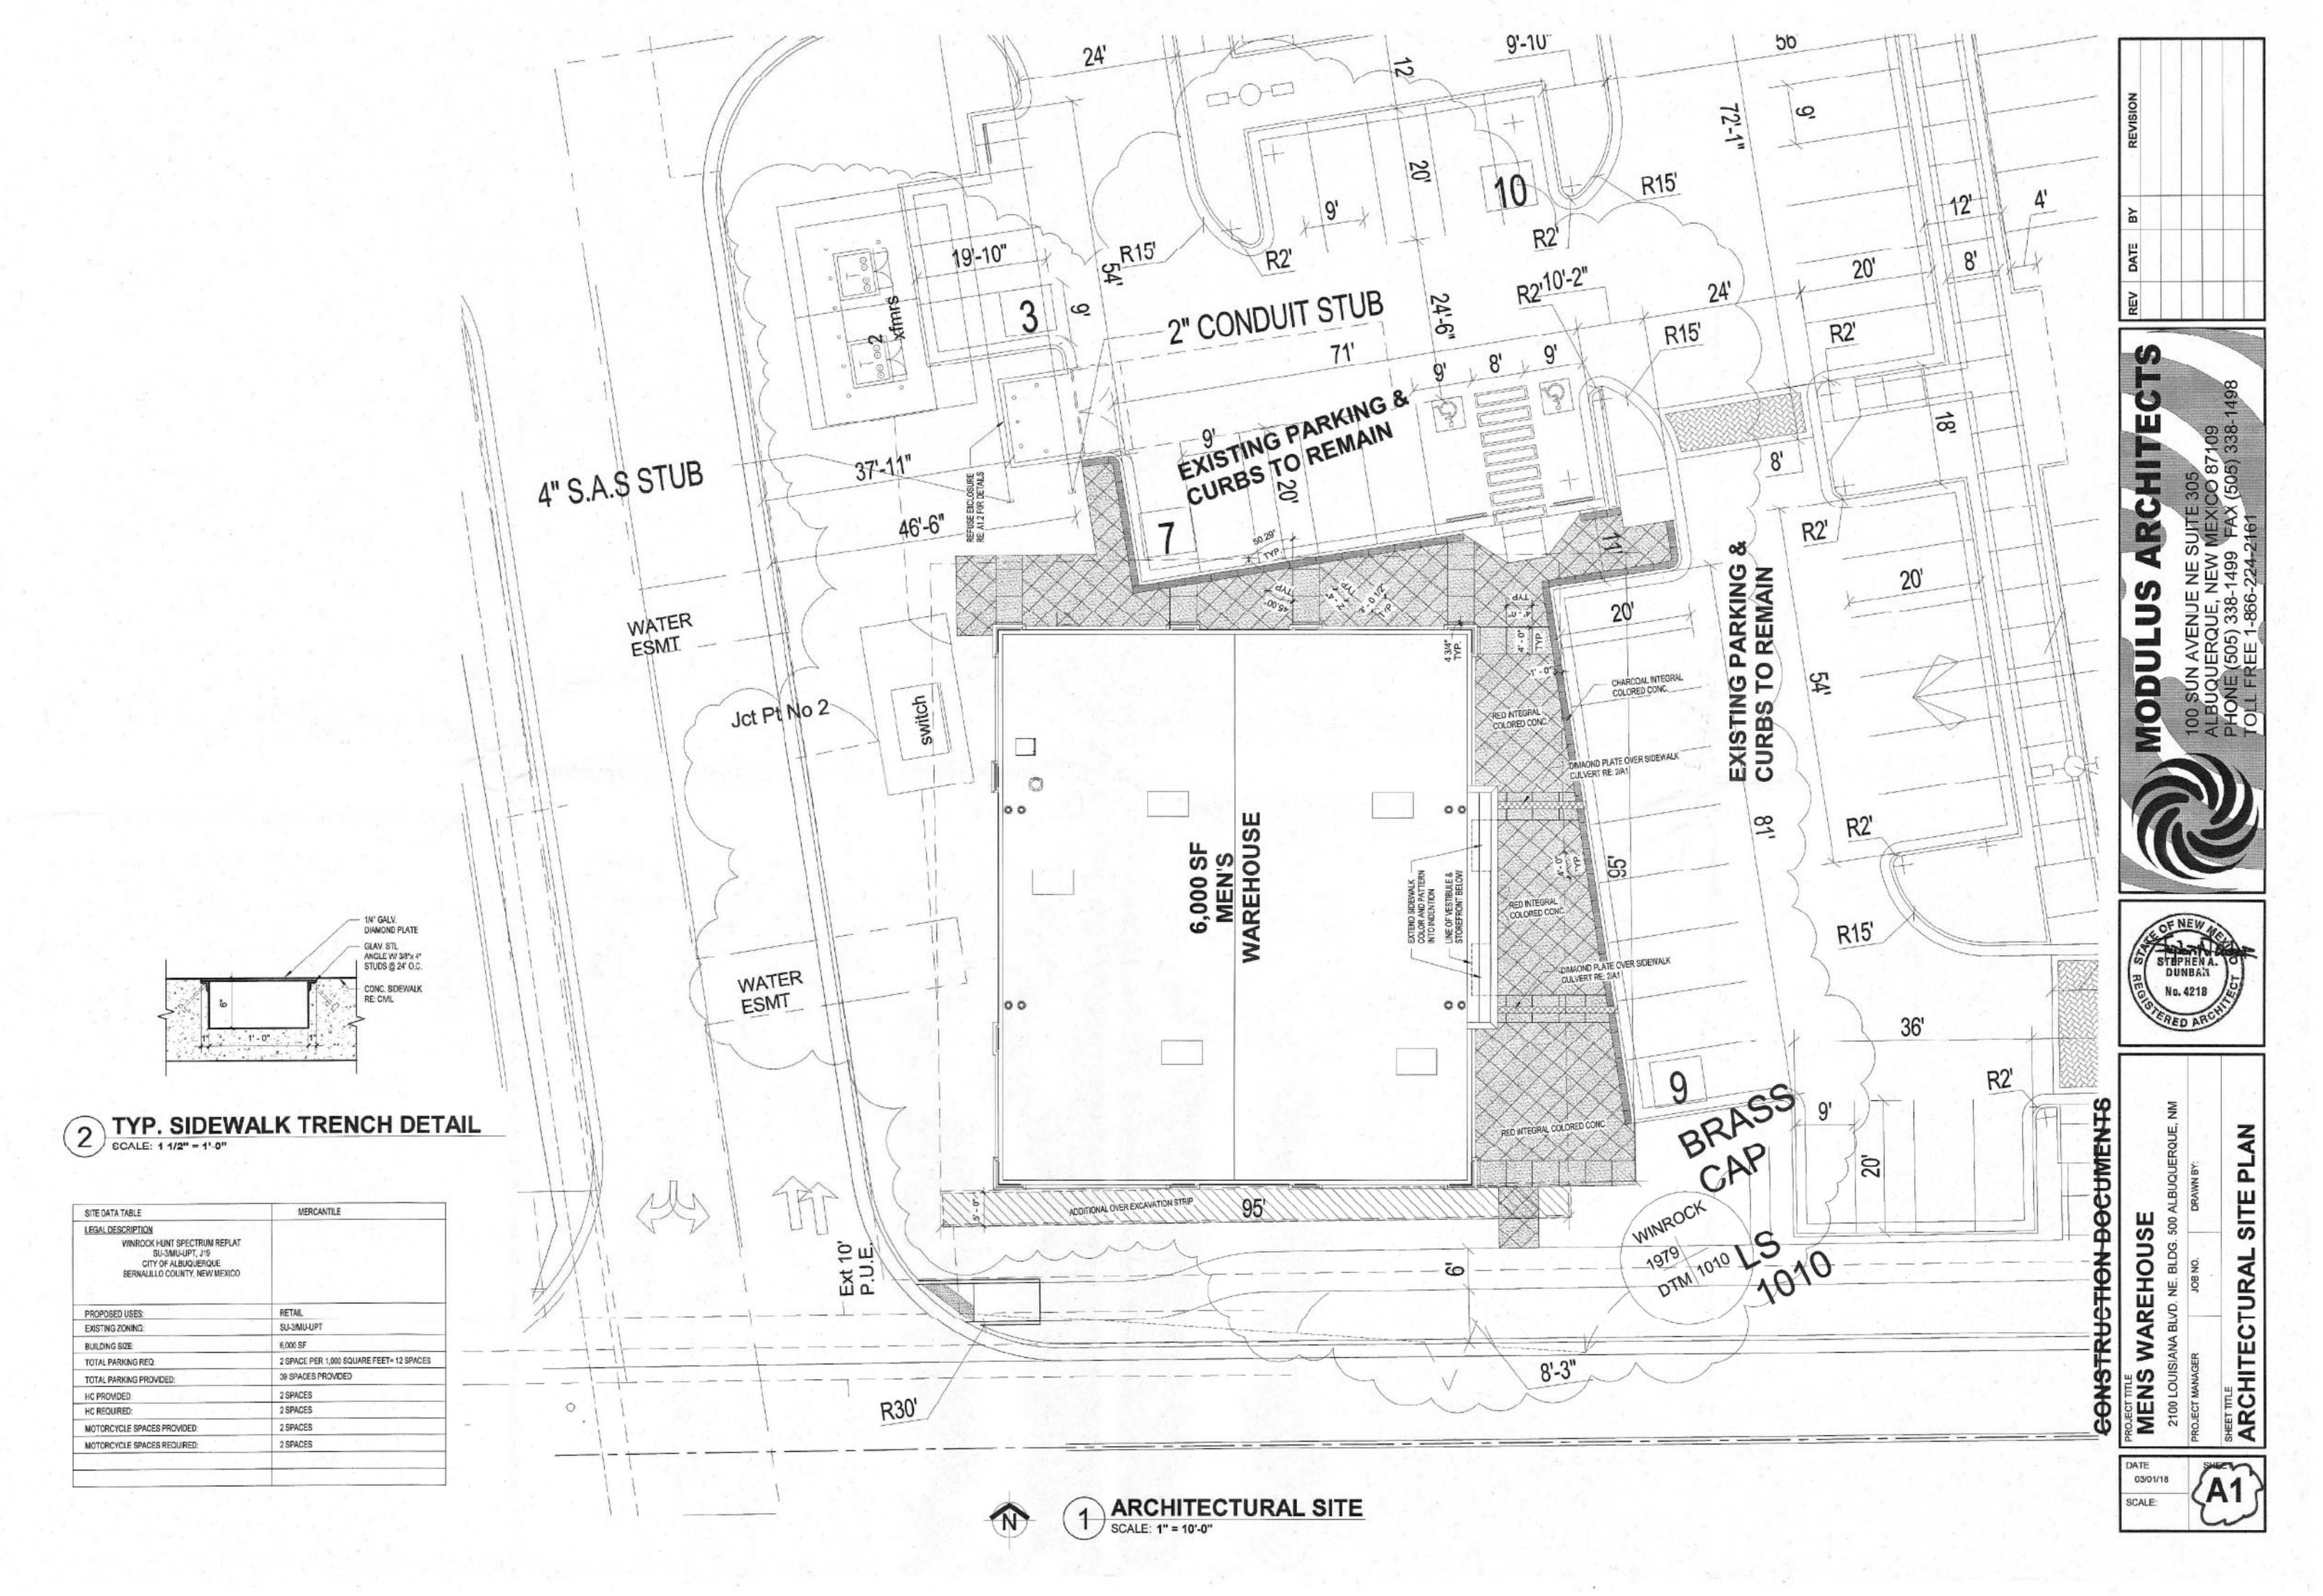

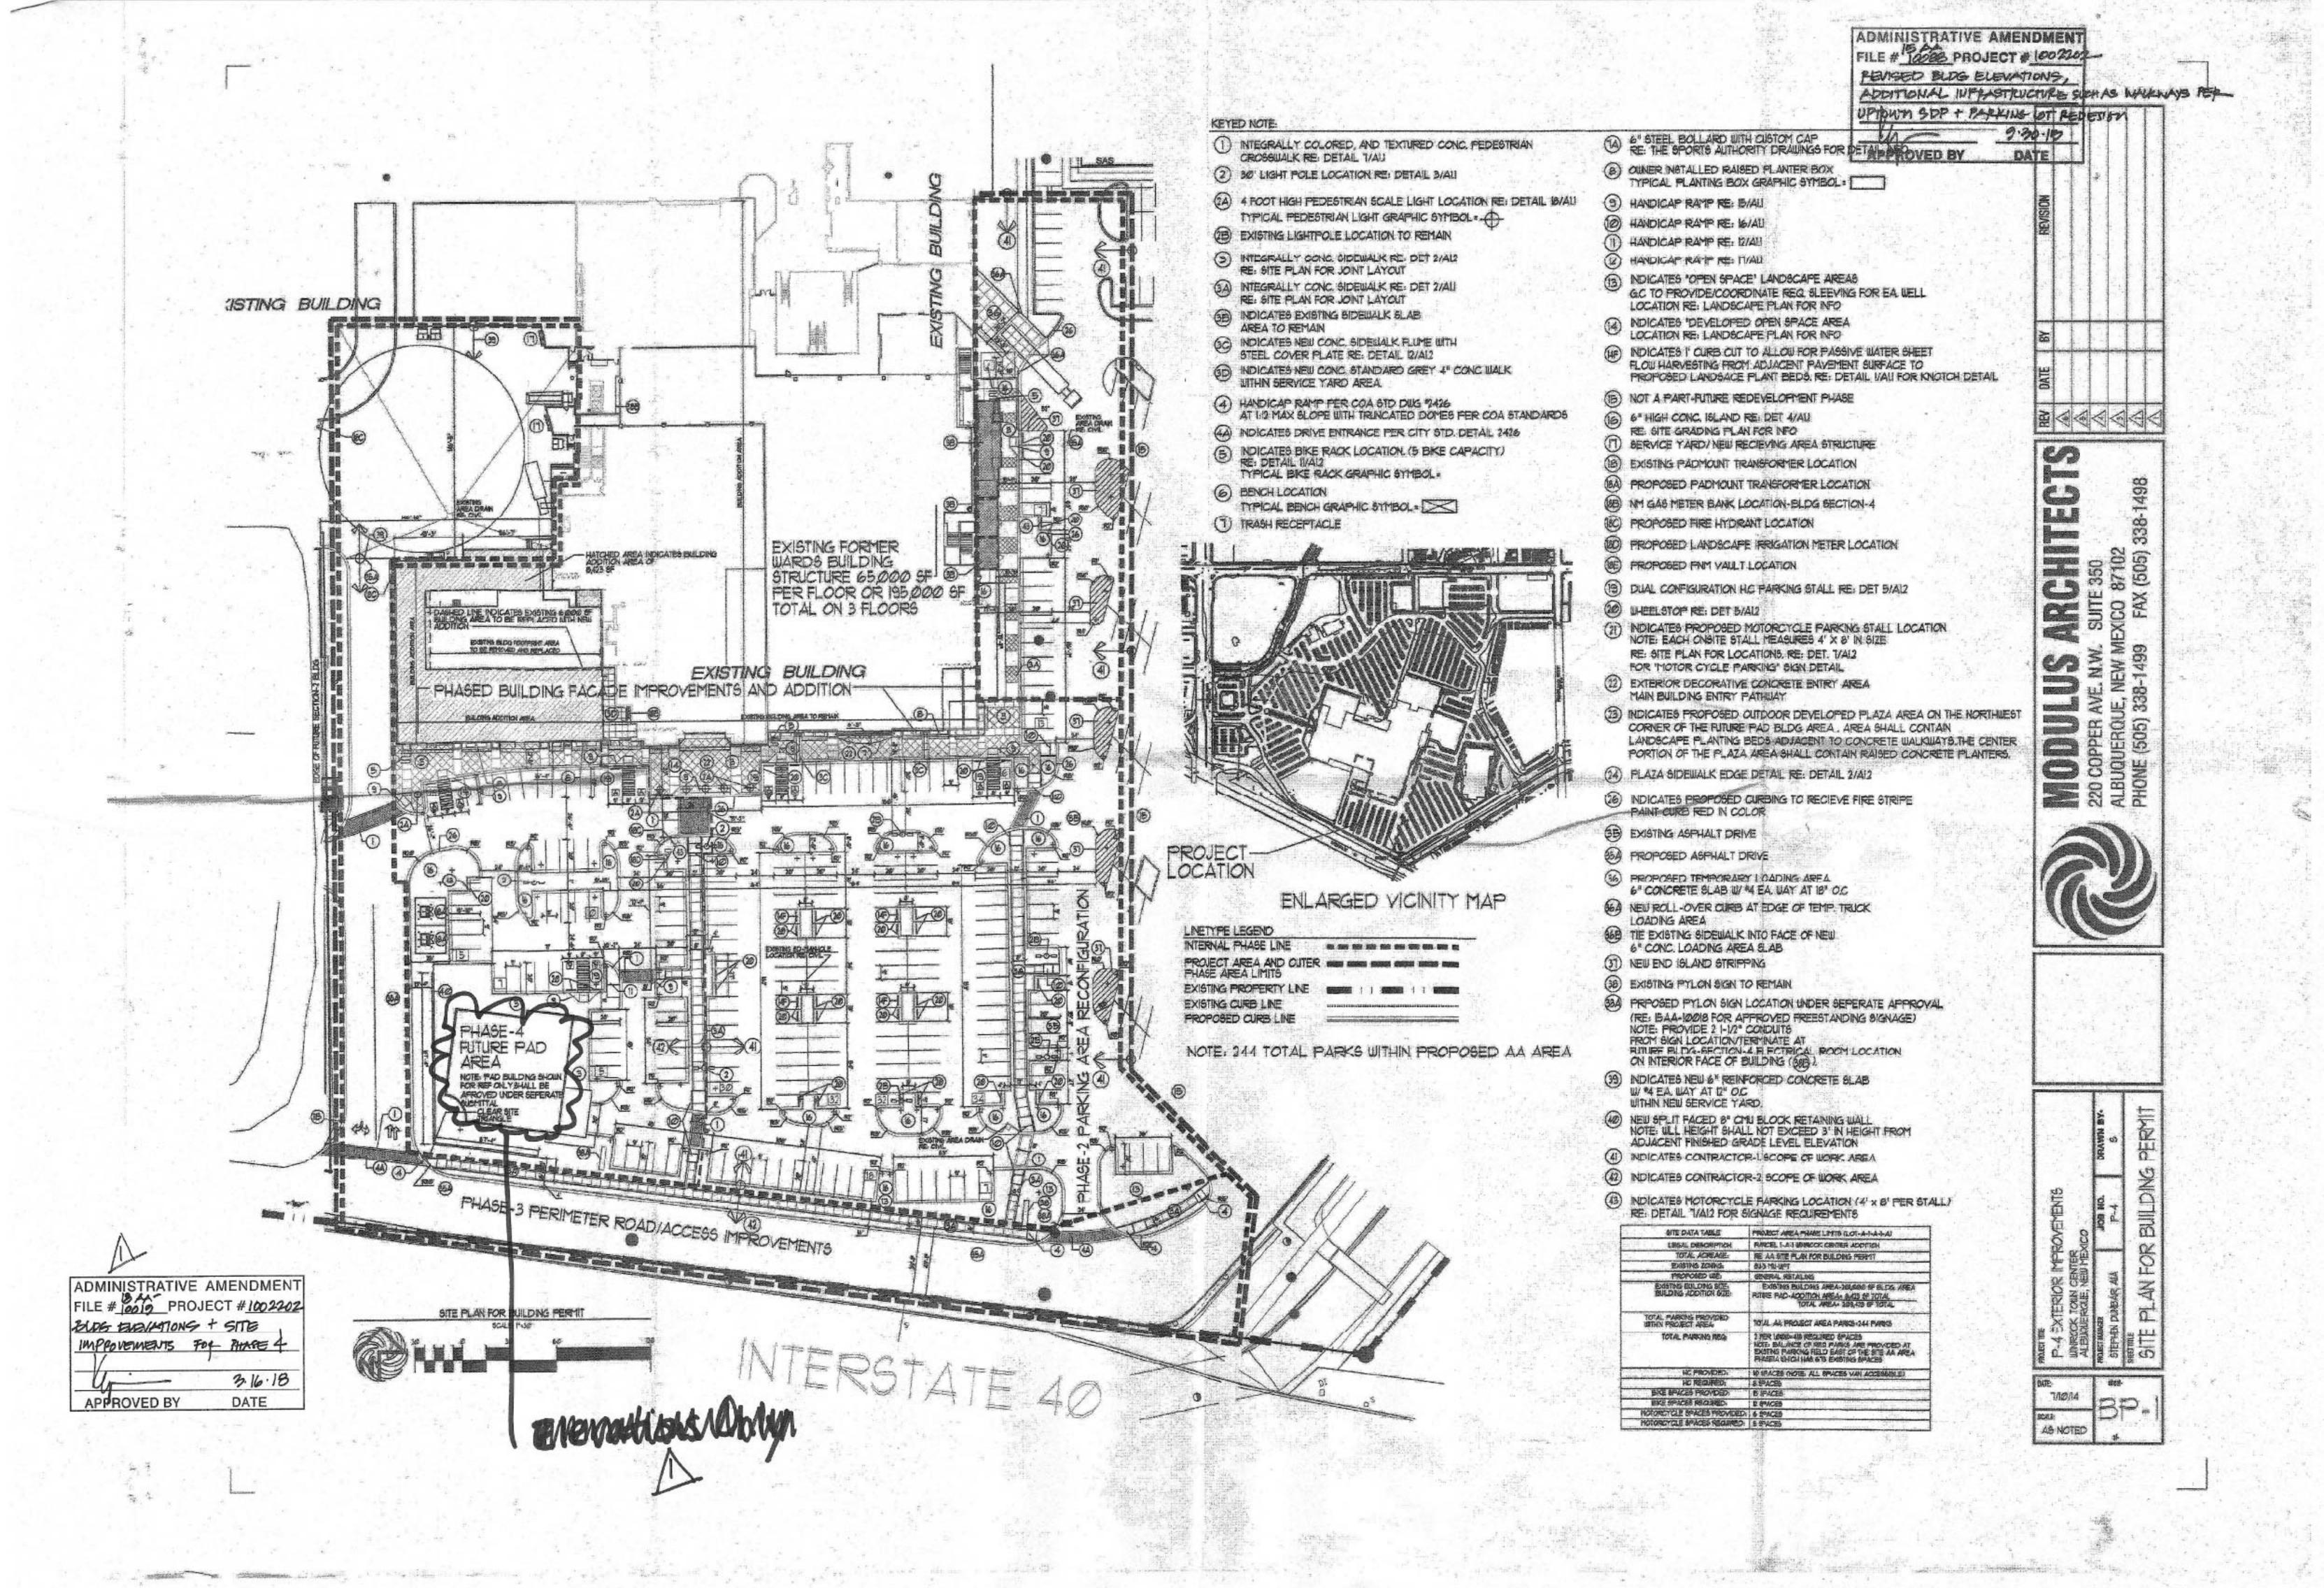

(1) INTEGRALLY COLORED, AND TEXTURED CONC. PEDESTRIAN CROSSIJALK RE: DETAIL 1/AU

(2) 30' LIGHT POLE LOCATION RE: DETAIL 3/ALI

(A) 4 FOOT HIGH PEDESTIRIAN SCALE LIGHT LOCATION RE: DETAIL 18/ALL

TYPICAL PEDESTRIAN LIGHT GRAPHIC SYMBOL: +

(3) CONC. SIDEBALK RE: DET 2/AU RE: SITE PLAN FOR JOINT LAYOUT

4 HANDICAP RAMP PER COA STD DILG 2426 AT 1:12 MAX SLOPE WITH TRINCATED DOMES PER COA STANDARDS

(A) INDICATES DRIVE ENTRANCE PER CITY STD. DETAIL 2426

B NDICATES BIKE RACK LOCATION (5 BIKE CAPACITY)
TYPICAL BIKE RACK GRAPHIC SYMBOL.

TYPICAL BENCH GRAPHIC SYMBOL . []

1 TRASH RECEPTACLE

(8) 18" HIGH INTEGRALLY COLORED CONC. RAISED BED/SEATING LANDSCAPE AREA RE: DETAIL 9/AU TYPICAL PLANTING BED GRAPHIC SYMBOL.

3) HANDICAP RAMP RE: IS/ALI

HANDICAP RAMP RE- 16/AU

HANDICAP RAMP RE DIAL

(12) HANDICAP RAMP RE: IT/AU

(B) NDICATES "OPEN SPACE" LANDSCAPE AREAS GC TO PROVIDE/COORDINATE REQ. SLEEVING FOR EA. WELL LOCATION RE: LANDSCAPE PLAN FOR NEO

M INDICATES DEVELOTED OPEN SPACE AREA LOCATION RE: LANDSCAPE PLAN FOR LANDSCAPING INFO

INDICATES I CURB OUT TO ALLOW FOR PASSIVE WATER SHEET
FLOW HARVESTING FROM ADJACENT PAVEMENT SURFACE TO
PROPOSED LANDSACE PLANT BEDS. RE: DETAIL VAU FOR KNOTCH DETAIL
NOTE, FINAL LOCATIONS SHALL BE COORDINATED WITH APPROVED
GRADING PLAN

(B) NOT A PART-RUTURE REDEVELOPMENT PHASE

RE: SITE GRADING PLAN FOR NFO

(T) SERVICE YARD.

(IB) PROPOSED PADMOUNT TRANSFORMER LOCATION

(9) DUAL CONFIGURATION HC PARKING STALL RE- DET SVALZ

20 UNEELSTOP RE: DET B/AL2

(1) NOIGATES PROPOSED MOTORCYCLE PARKING STALL LOCATION NOTE: EACH ONSITE STALL MEASURES 4" X 8" IN SIZE RE: SITE PLAN FOR LOCATIONS. RE: DET. 1/ALZ FOR "MOTOR CYCLE PARKING" SIGN DETAIL

(22) EXTERIOR DECORATIVE CONCRETE ENTRY AREA ALONG MAIN BULDING ENTRY PATHUAY

(23) INDICATES PROPOSED CUIDOOR DEVELOPED PLAZA AREA ON THE EASTERN AND SOUTH WESTERN CORNER OF THE FUTURE PAD BLDG AREA . AREA SHALL CONTAIN LANDSCAPE PLANTING BEDS ADJACENT TO CONCRETE MALKMAYS.

(24) PLAZA SIDEWALK EDGE DETAIL RE: DETAIL 2/AL2

(25) PROPOSED FIRE HYDRANT LOCATION

INDICATED ON VERTICAL FACE OF CURB WITH 4" HIGH LETTERING (21) INDICATES OVERHEAD VEHICLE CLEARANCE BAR

65 EXISTING ASPHALT DRIVE

64 PROPOSED ASPHALT DRIVE

NOTE: WALL PROTECTION AT ALL RAMP ACCESS POINTS SHALL BE MIN 42" ABOVE HIGH SIDE GRADE ELEVATION. (31) NDICATES RETAINING WALL STRUCTURE, RE: CIVIL FOR WALL DETAILS

GENERAL NOTES:

LANDSCAPE IRRIGATION PLAN SHALL BE PROVIDED WITH ANDSCAPE PLAN DURING BUILDING PERMIT SUBMITTAL 2. MILCH SHALL BE PROVIDED IN AREAS AROUND LIVING PLANTS TO REDUCE HEAT AND CONSERVE MOISTURE. NOTE: ROCK SHALL BE USED AS MULCH ALTERNATIVE IN AREAS

OF DRANAGE AND SEVERE SLOPE. 3. 16% PERCENT OF ALL LANDSCAPE PLANTING STRIPS SHALL CONTAIN FLOWERING PLANTS AND SURVES.

4. MINIMUM ACCEPTABLE SIZES OF PLANTS, TREES, OR AMOUNTS OF SEED AT THE TIME OF PLANTING ARE AS FOLLOUS.

DECIDUOUS TREES SHALL BE TWO INCHES IN CALIFER CONFEROUS TREES SHALL BE A MIN OF 6 TALL.

B. SHRUBS AND LOW GROWING EVERGREENS SHALL BE A MIN. OF I

C. GROUND COVER AND TURF MUST BE ADEQUATE TO PROVIDE TS% GROUND COVERAGE WITHIN TWO GROWING SEASONS AFTER PLANTING.

5. ALL LANDSCAPING SHALL BE MAINTAINED IN SUCH A WAY AS TO KEEP PLANTS AND TREES HEALTY, LANDSCAPING WHICH DIES SHALL BE REPLACED BY THE OWNER AS EXPEDITIOUSLY AS POSSIBLE, BUT IN NO CASE LONGER THAN 60 DAYS AFTER BEING MADE AMARE OF THE ISSUE BY THE CITY OF ALBUQUERGUE.

APLANTING STRIPS SHALL BE A MIN OF 4' WIDE AND COVERED WITH LIVE YEGATATIVE MATERIALS SHUCH AS GRASSES, VNESPLOWERS AND/OR SHRUBS OVER 60%.

OF THE PLANTING STRIP IF IT IS DIRECTLY BETWEEN PARKING AND A WALKWAY.

IT THE PLANTING STRIP IS REQUIRED FOR STREET TREES, IT SHALL BE COVERED WITH LIVING VEGATATIVE MATERIALS SUCH AS GRASSES, VNESPLOWERS/AND OR SHRUBS OVER 18% OF THE PLANTING STRIP, COVERAGE SHALL BE CALCULATED FROM THE ANTICIPATED SIZE OF THE PLANTS AT MATURITY.

B. IN ORDER TO FACILITATE THE TRANSITION BETWEEN PARKING SPACES, AND ADJACENT WALKWAYS DECORATIVE PAYERS SHALL BE USED WITHIN 40% OF THE PLANTING STRIP.

8. ALL REQUIRED TREES SHALL BE PLANTED PRIOR TO FINAL BUILDING INSPECTION. 9. DECIDUOUS TREES SHALL BE A MIN OF 2" IN CALIFER AT THE TIME OF PLANTING. CONFEROUS TREES

W. TREES SHALL BE PLANTED IN TREE WELLS OR PERFEABLE PAYERENT TO MAXIMIZE THE OPPORTUNITY TO THRIVE THE MINIMUM TREE WELL SIZE SHALL BE 36 SQUARE FEET.


IL TREES SHALL BE IRRIGATED TO SO AS TO ENCOURAGE A DEEP AND WIDE ROOT SYSTEM THAT WILL PROVIDE HEALTY GROWTH AND STRUCTURAL STABILITY.

TYPE LEGEND	
ENAL PHASE LINE	155 MIS 100 MIN 100 MIN
POSED LOT LINE	Management 1 1 Management
JECT AREA AND CLITER SE AREA LIMITS	
TING PROPERTY LINE	
TING CURB LINE	
POSED CURS LINE	

City of Albuquerque Building & Safety HH 12 715

Plan Check Section

SCALE:

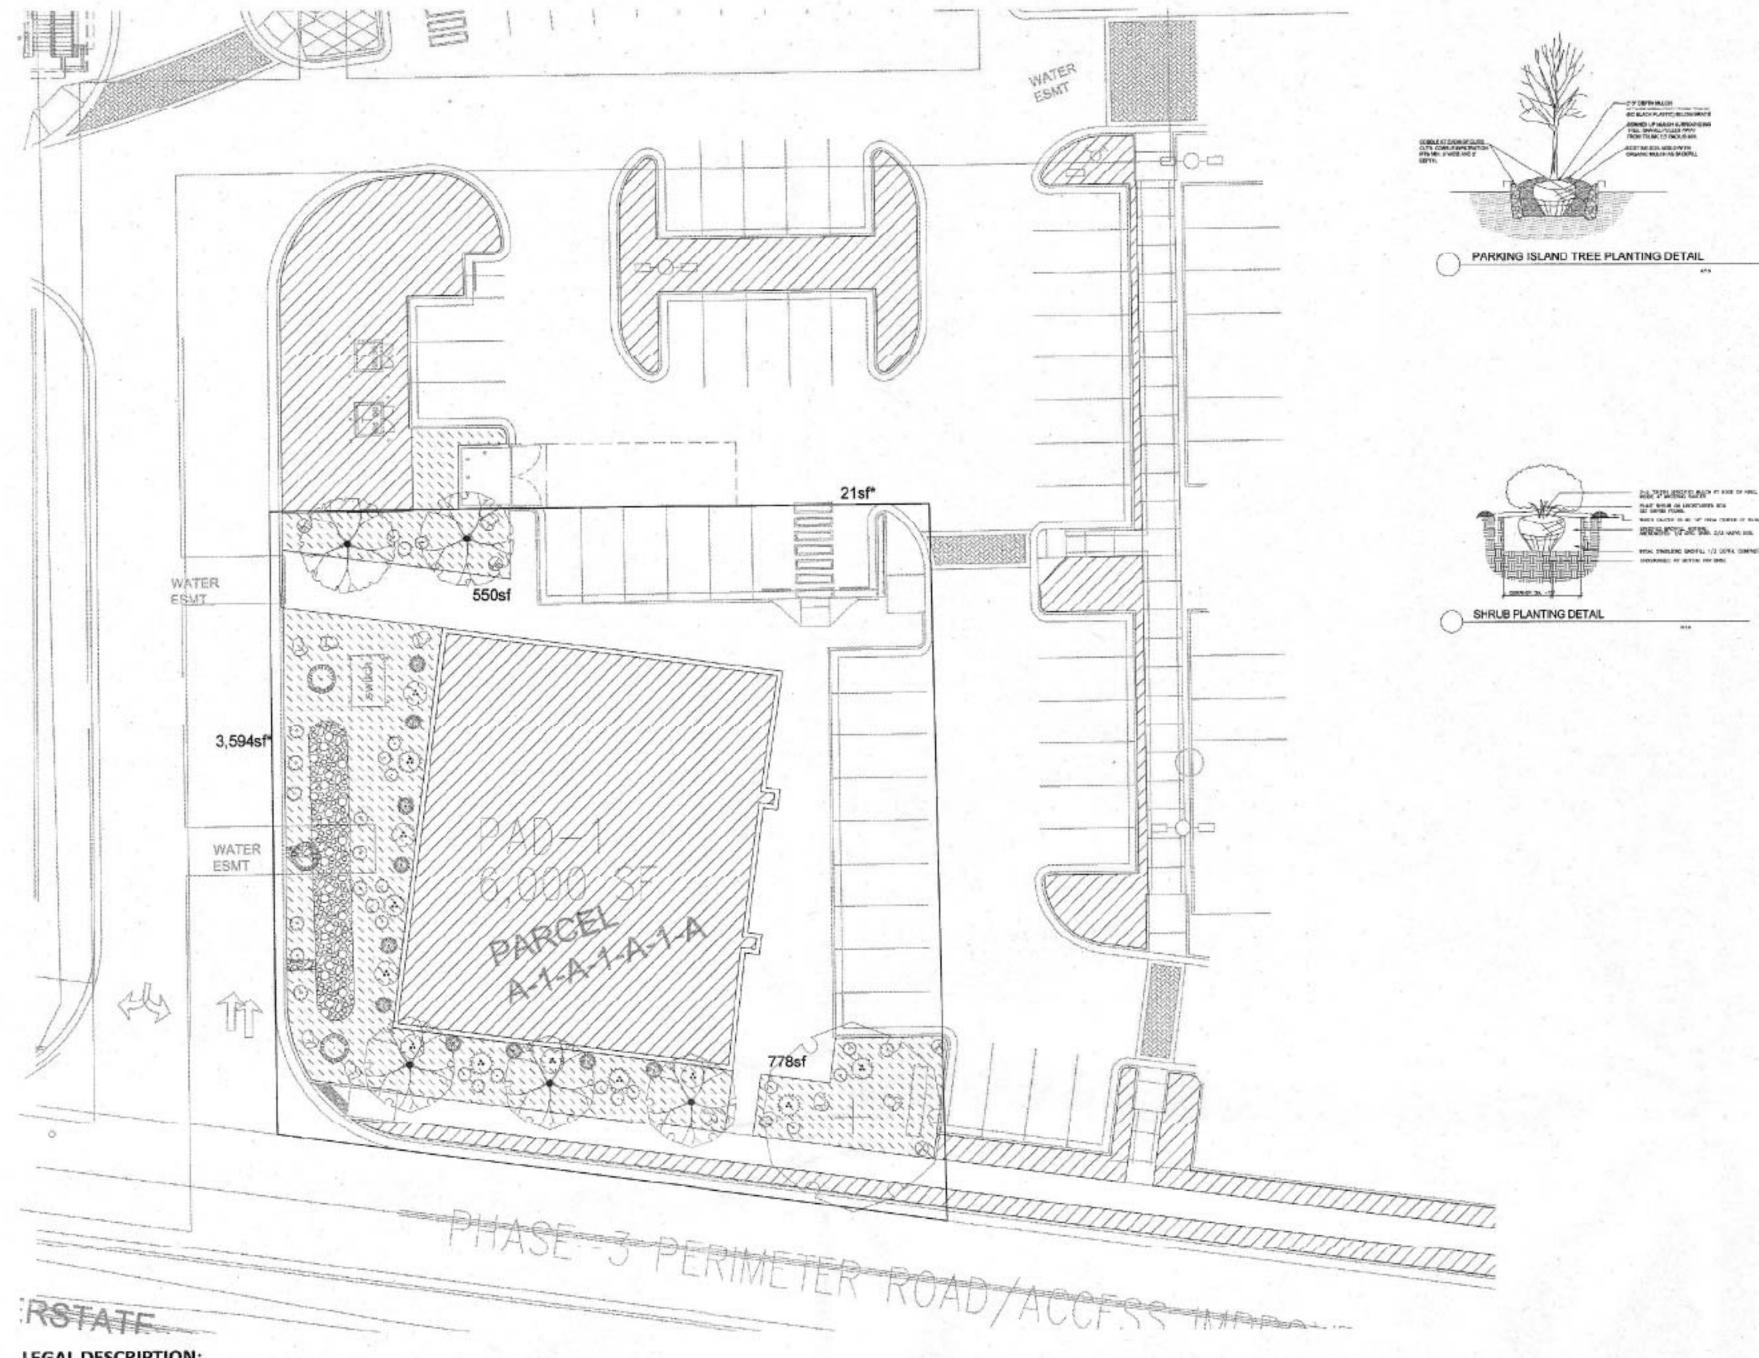

### LEGAL DESCRIPTION:

PARCEL 1-A-1 WINROCK CENTER ADDITION. ZONE SU-3 for MU-UPT.

### **GENERAL NOTES:**

- 1. MAINTENANCE OF THE LANDSCAPE AND IRRIGATION PROVIDED BY THE PROPERTY OWNER.
- 2. LANDSCAPE AREAS SHALL BE DEPRESSED TO PROVIDE POSITIVE DRAINAGE FOR SITE RUN OFF. SEE CIVIL DRAWINGS FOR DRAINAGE INFORMATION AND PLACEMENT OF CURB CUTS.
- 3. THE LANDSCAPE PLAN IS DESIGNED TO MEET ALL CITY OF ALBUQUERQUE AND USDP REQUIREMENTS.
- 4. PLANT MATERIALS AND SIGNING WILL NOT INTERFERE WITH CLEAR SIGHT REQUIREMENTS. THEREFORE SIGNS, WALLS, TREES, AND SHRUBBERY BETWEEN 3 AND 8 FEET TALL (AS MEASURED FROM THE GUTTER PAN) ARE NOT ACCEPTABLE IN 'CLEAR SIGHT' AREAS.
- 5. THE LANDSCAPE PLAN IS DESIGNED TO COMPLY WITH THE GENERAL LANDSCAPING REGULATIONS §14-16-3-10, WATER CONSERVATION LANDSCAPING AND WATER WASTE §6-1-1-1,ABCWUA WATER WASTE §4, INCLUDING PROVISION OF A MINIMUM OF 75% LIVE GROUND COVERAGE, MEASURE AT MATURITY, OF ALL REQUIRED LANDSCAPE AREAS.

### PLANTINGS NOTES:

- 1. THE LANDSCAPE DESIGN SHALL COMPLY WITH THE CITY OF ALBUQUERQUE WASTE WATER CONSERVATION, LANDSCAPE, AND WATER WASTE ORDINANCE AND UPTOWN SECTOR DEVELOPMENT PLAN (USDP).
- 2. THERE IS NO NEW TURF USED IN THE DESIGN OF THE LANDSCAPE.
- 3. STREET TREES ARE PLACED AT A MAXIMUM OF 30 FEET ON CENTER ALONG WINROCK LOOP ROAD. THE R.O.W. (WHEN DEDICATED TO THE PUBLIC) SHALL BE MAINTAINED BY THE PROPERTY OWNER. THE PLAN SHALL FOLLOW THE COA DESIGN GUIDELINES FOR STREET TREES.
- 4. WHERE MULCH IS ADJACENT TO THE CONCRETE, FINISH GRADE OF MULCH SHALL BE APPROXIMATELY 1/2" BELOW THE TOP OF CONCRETE.

## **OPEN SPACE NOTE:**

\*Landscape areas excluded from landscape calculations are any landscape strips along streets, parking lot islands without walkways, or areas of less than 4' width as stated in the USDP. Excluded landscape areas has an asterisk next to the square footage number.

## **IRRIGATION NOTE**

DRIP SYSTEM RUN CYCLES: ESTABLISHMENT AND SUMMER: 1 HOUR/4 DAYS A WEEK SPRING: 1 HOUR/2-3 DAYS A WEEK FALL: 1 HOUR/2-3 DAYS A WEEK

1 HOUR/2 DAYS PER MONTH

WINTER:

### PLANT SCHEDULE

DECIDUOUS TREES	QTY	BOTANICAL NAME / COMMON NAME	SIZE	WATER USAGE	ALLOWANCE
(+)	1	Ulmus parvifolia 'Allee' / Allee Lacebark Elm	2" B&B	Medium	50
RUIT TREES	QTY	BOTANICAL NAME / COMMON NAME	SIZE	WATER USAGE	ALLOWANCE
*	1	Malus domestica 'Golden Delicious' / Golden Delicious Apple	1 1/2" B&B	Medium +	40
3	1	Prunus armeniaca 'Moorpark' / Moorpark Apricot	1 1/2" B&B	Medium +	40
	3	Prunus avium 'Lapins' / Lapins Cherry	1 1/2" R&R	Medium +	40
ECIDUOUS SHRUBS	QTY	BOTANICAL NAME / COMMON NAME	SIZE	WATER USAGE	ALLOWANCE/TOTAL SF
0	21	Lavandula angustifolia / English Lavender	1 gal	Medium	15 x21=315sf
ESERT ACCENTS	QTY	BOTANICAL NAME / COMMON NAME	SIZE	WATER USAGE	ALLOWANCE/TOTAL SF
	6	Dasylirion texanum / Texas Sotol	5 gal	RW	30 x6=180sf
(a)	6	Yucca baccata / Banana Yucca	5 gal	RW	30 x6=180sf
VERGREEN SHRUBS	QTY	BOTANICAL NAME / COMMON NAME	SIZE	WATER USAGE	ALLOWANCE/TOTAL SF
(·)	9	Ericameria laricifolia / Turpentine Bush	5 gal	Low	25 x9=225sf
0	3	Pinus mugo / Mugo Pine	5 gal	Medium	35 x3=105sf
8	4	Rhaphiolepis indica / Indian Hawthorn	5 gal	Medium	20 x4=80st
GRASSES	QTY	BOTANICAL NAME / COMMON NAME	SIZE	WATER USAGE	ALLOWANCE/TOTAL SF
0	10	Miscanthus sinensis 'Gracillimus' / Maiden Grass	5 gal	Medium+	20 x13=260sf
GRAVEL MULCH	QTY	BOTANICAL NAME / COMMON NAME	TYPE	10	TAL SF= 1,345sf
	1,545 sf	3/8"-1/2 Amaretto Brown Gravel / 3" Depth over Filter Fabric	Gravel Mulch		
	514 sf	Blue Sais 2-4" Cobble / 4" depth	Gravel Mulch		

Existing Landscape

REFERENCE NOTES SCHEDULE

SYMBOL DESCRIPTION QTY DETAIL

Medium Boulder 9

LANDSCAPE	CALCULATIONS
SITE AREA	

..... 19,748 sf = .50 ac SHE AREA REQUIRED OPEN SPACE .... 1,975 sf (10% of the site) PROVIDED OPEN SPACE ..... 2,224 sf (11% of the site) .... 890 sf (40% of open space) REQUIRED LANDSCAPE AREAS ..... 1,333 sf (150% of open space) PROVIDED LANDSCAPE AREAS

\*Landscape areas excluded from landscape calculations are any landscape strips along streets, ponding areas, parking lot islands without walkways, or areas of less than 4' width as stated in the USDP. There are no pedestrian plazas, gardens, playgrounds, parks, or recreational areas proposed.

.... 1,000 sf (75% of provided landscape areas) LIVE COVERAGE REQUIRED A minimum of 75% provided landscape areas shall be covered with live plant material measured at full maturity.

LIVE COVERAGE PROVIDED ..... 1,345 sf (100% of provided landscape areas)

..... 134 sf (10% of provided live coverage) FLOWERING PLANTS REQUIRED A minimum of 10% landscape areas shall have flowering plants or shrubs. .... 410 sf (30% of provided live coverage) FLOWERING PLANTS PROVIDED

COBBLE MULCH

2" - 4" cobble to be placed at curb cuts for site run off and underneath all building downspouts of any new construction.

NUMBER OF PARKING SPACES REQUIRED PARKING LOT TREES

.... 3 (1 per 6 spaces) ....2 new/1 existing PROVIDED PARKING LOT TREES No parking space shall be more than 60 feet from a tree.

TOTAL NUMBER OF TREES SHADE TREES SIGNATURE TREES

The proportion of trees shall be approximately: 1/3 signature trees and 2/3 shade trees.

....4 Existing

....1



PO Box 10597 Albuquerque, NM 87184 505.898.9615 505.898.2105 (fax) design@hulc.com




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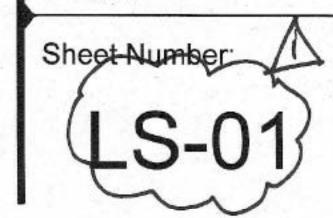



Scale: 1" = 20'




Sheet Title:

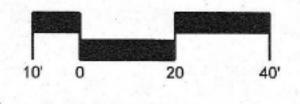Landscape Plan



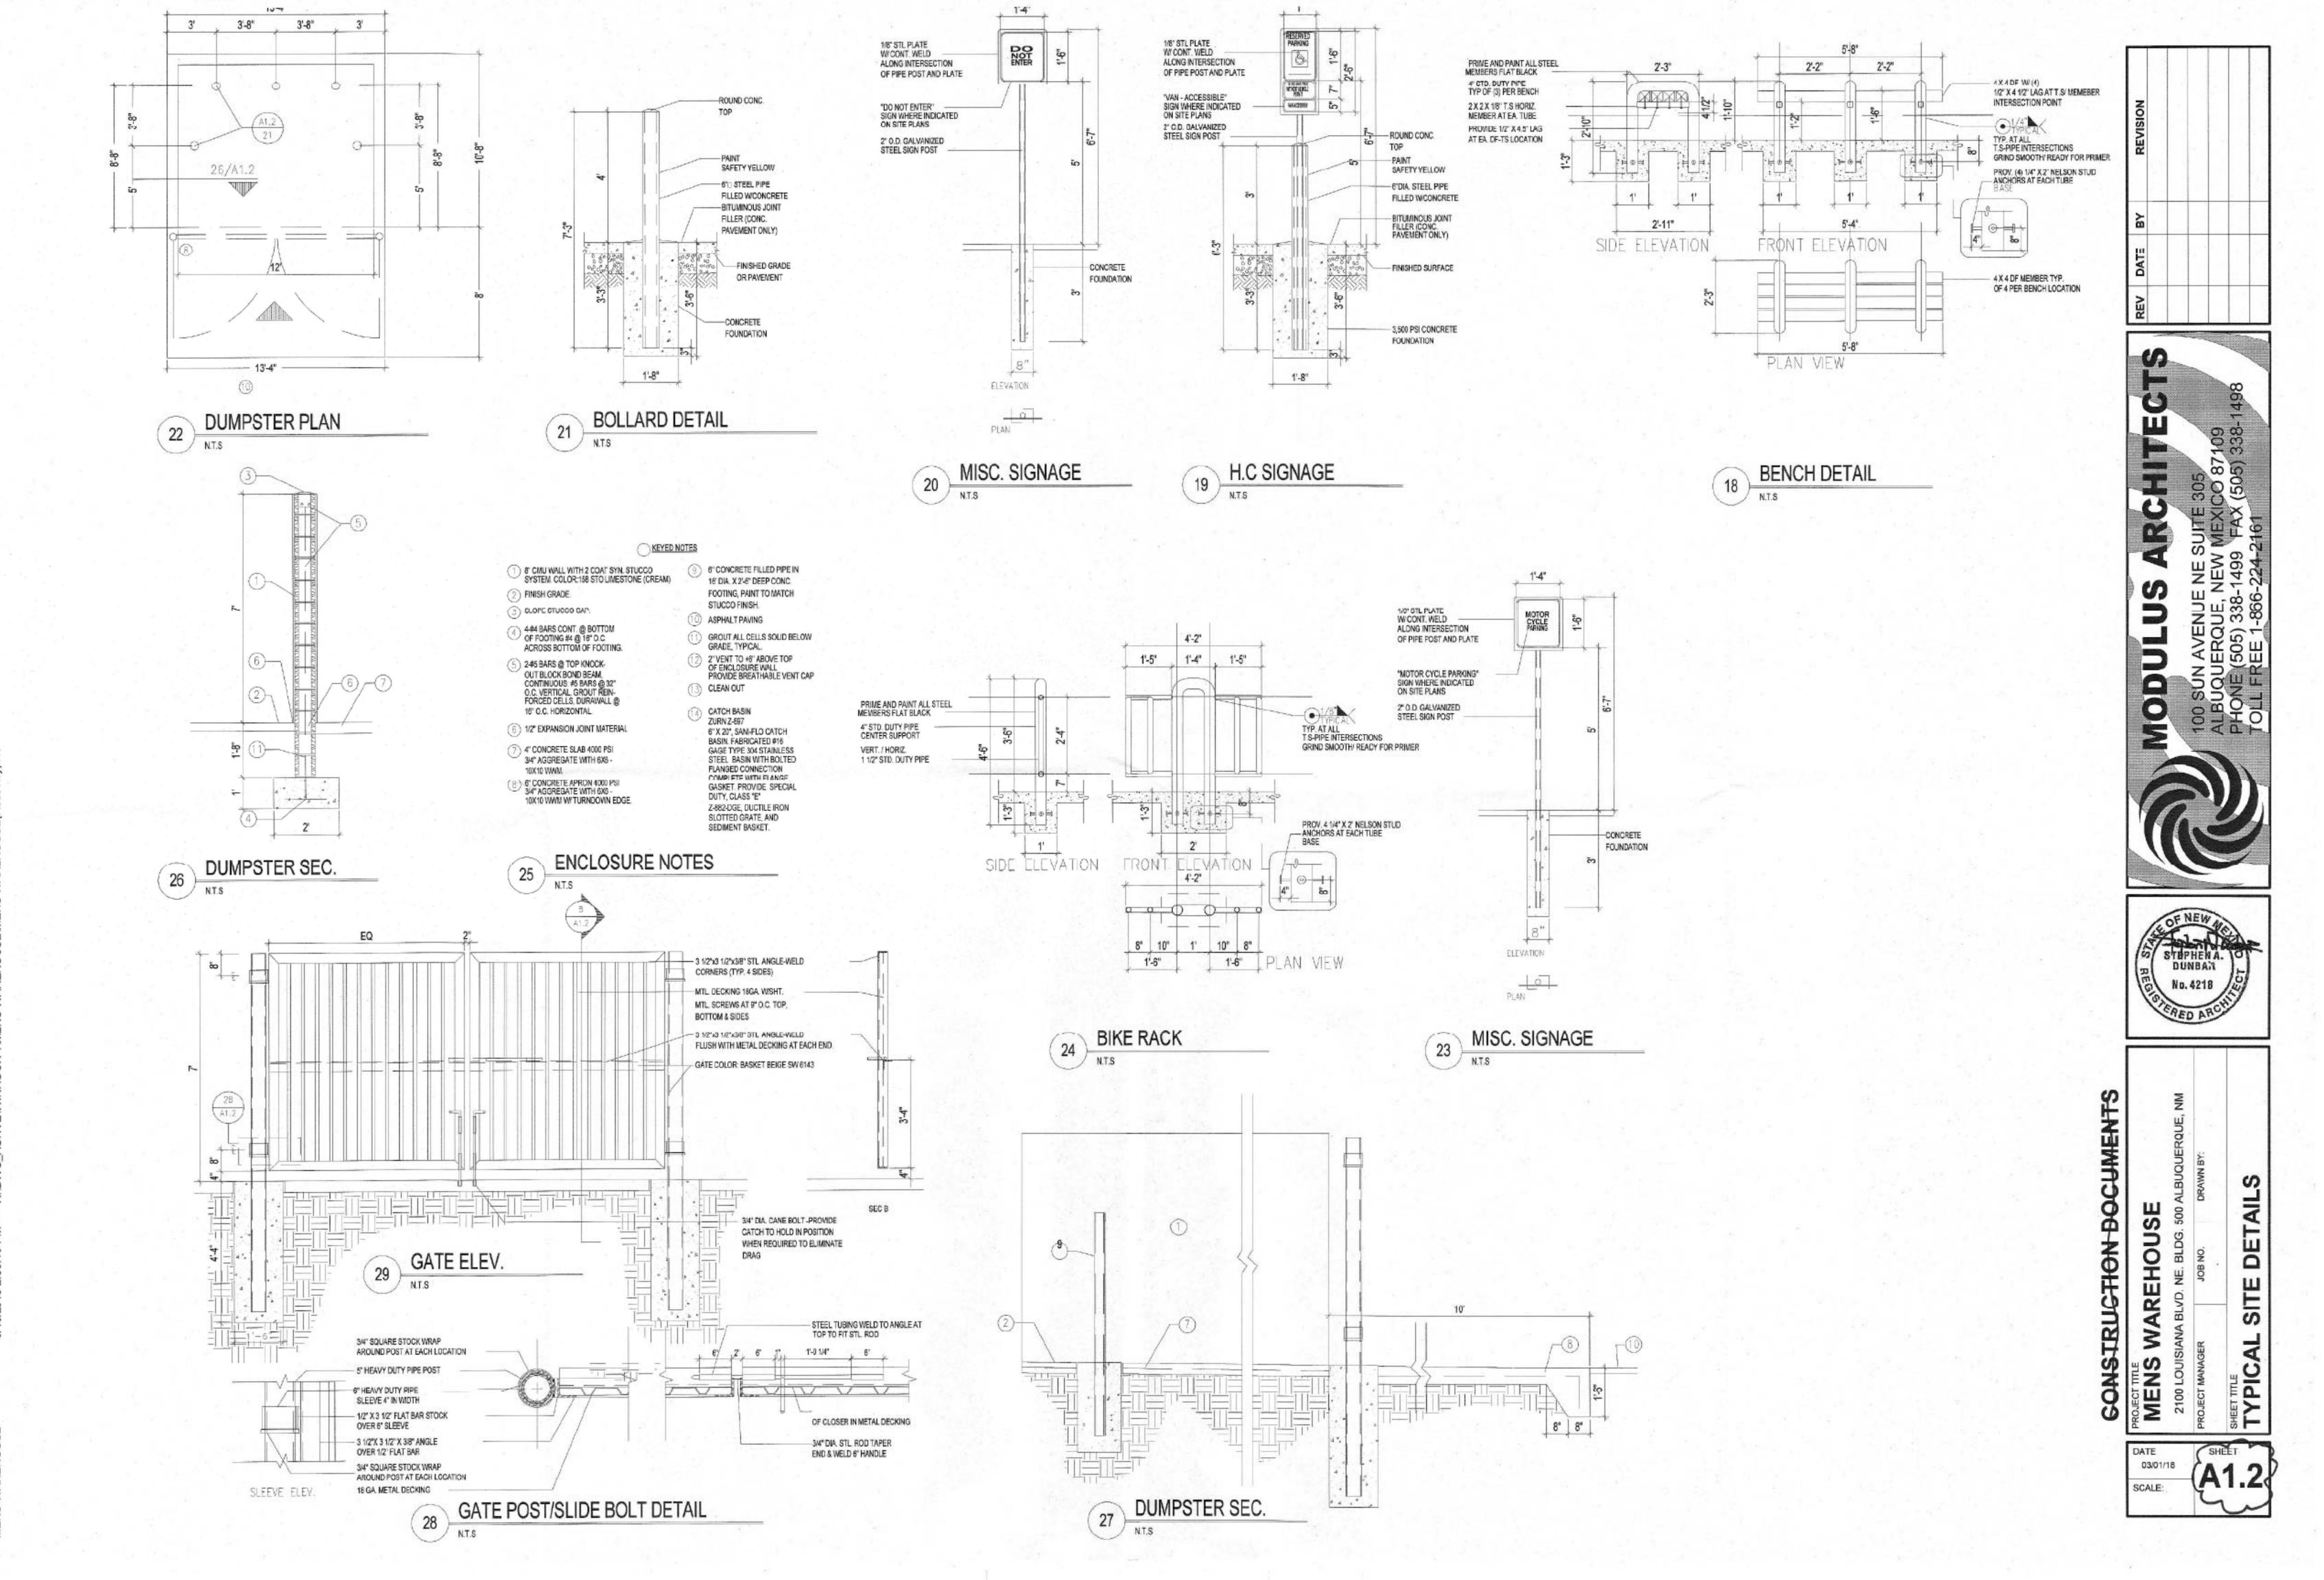

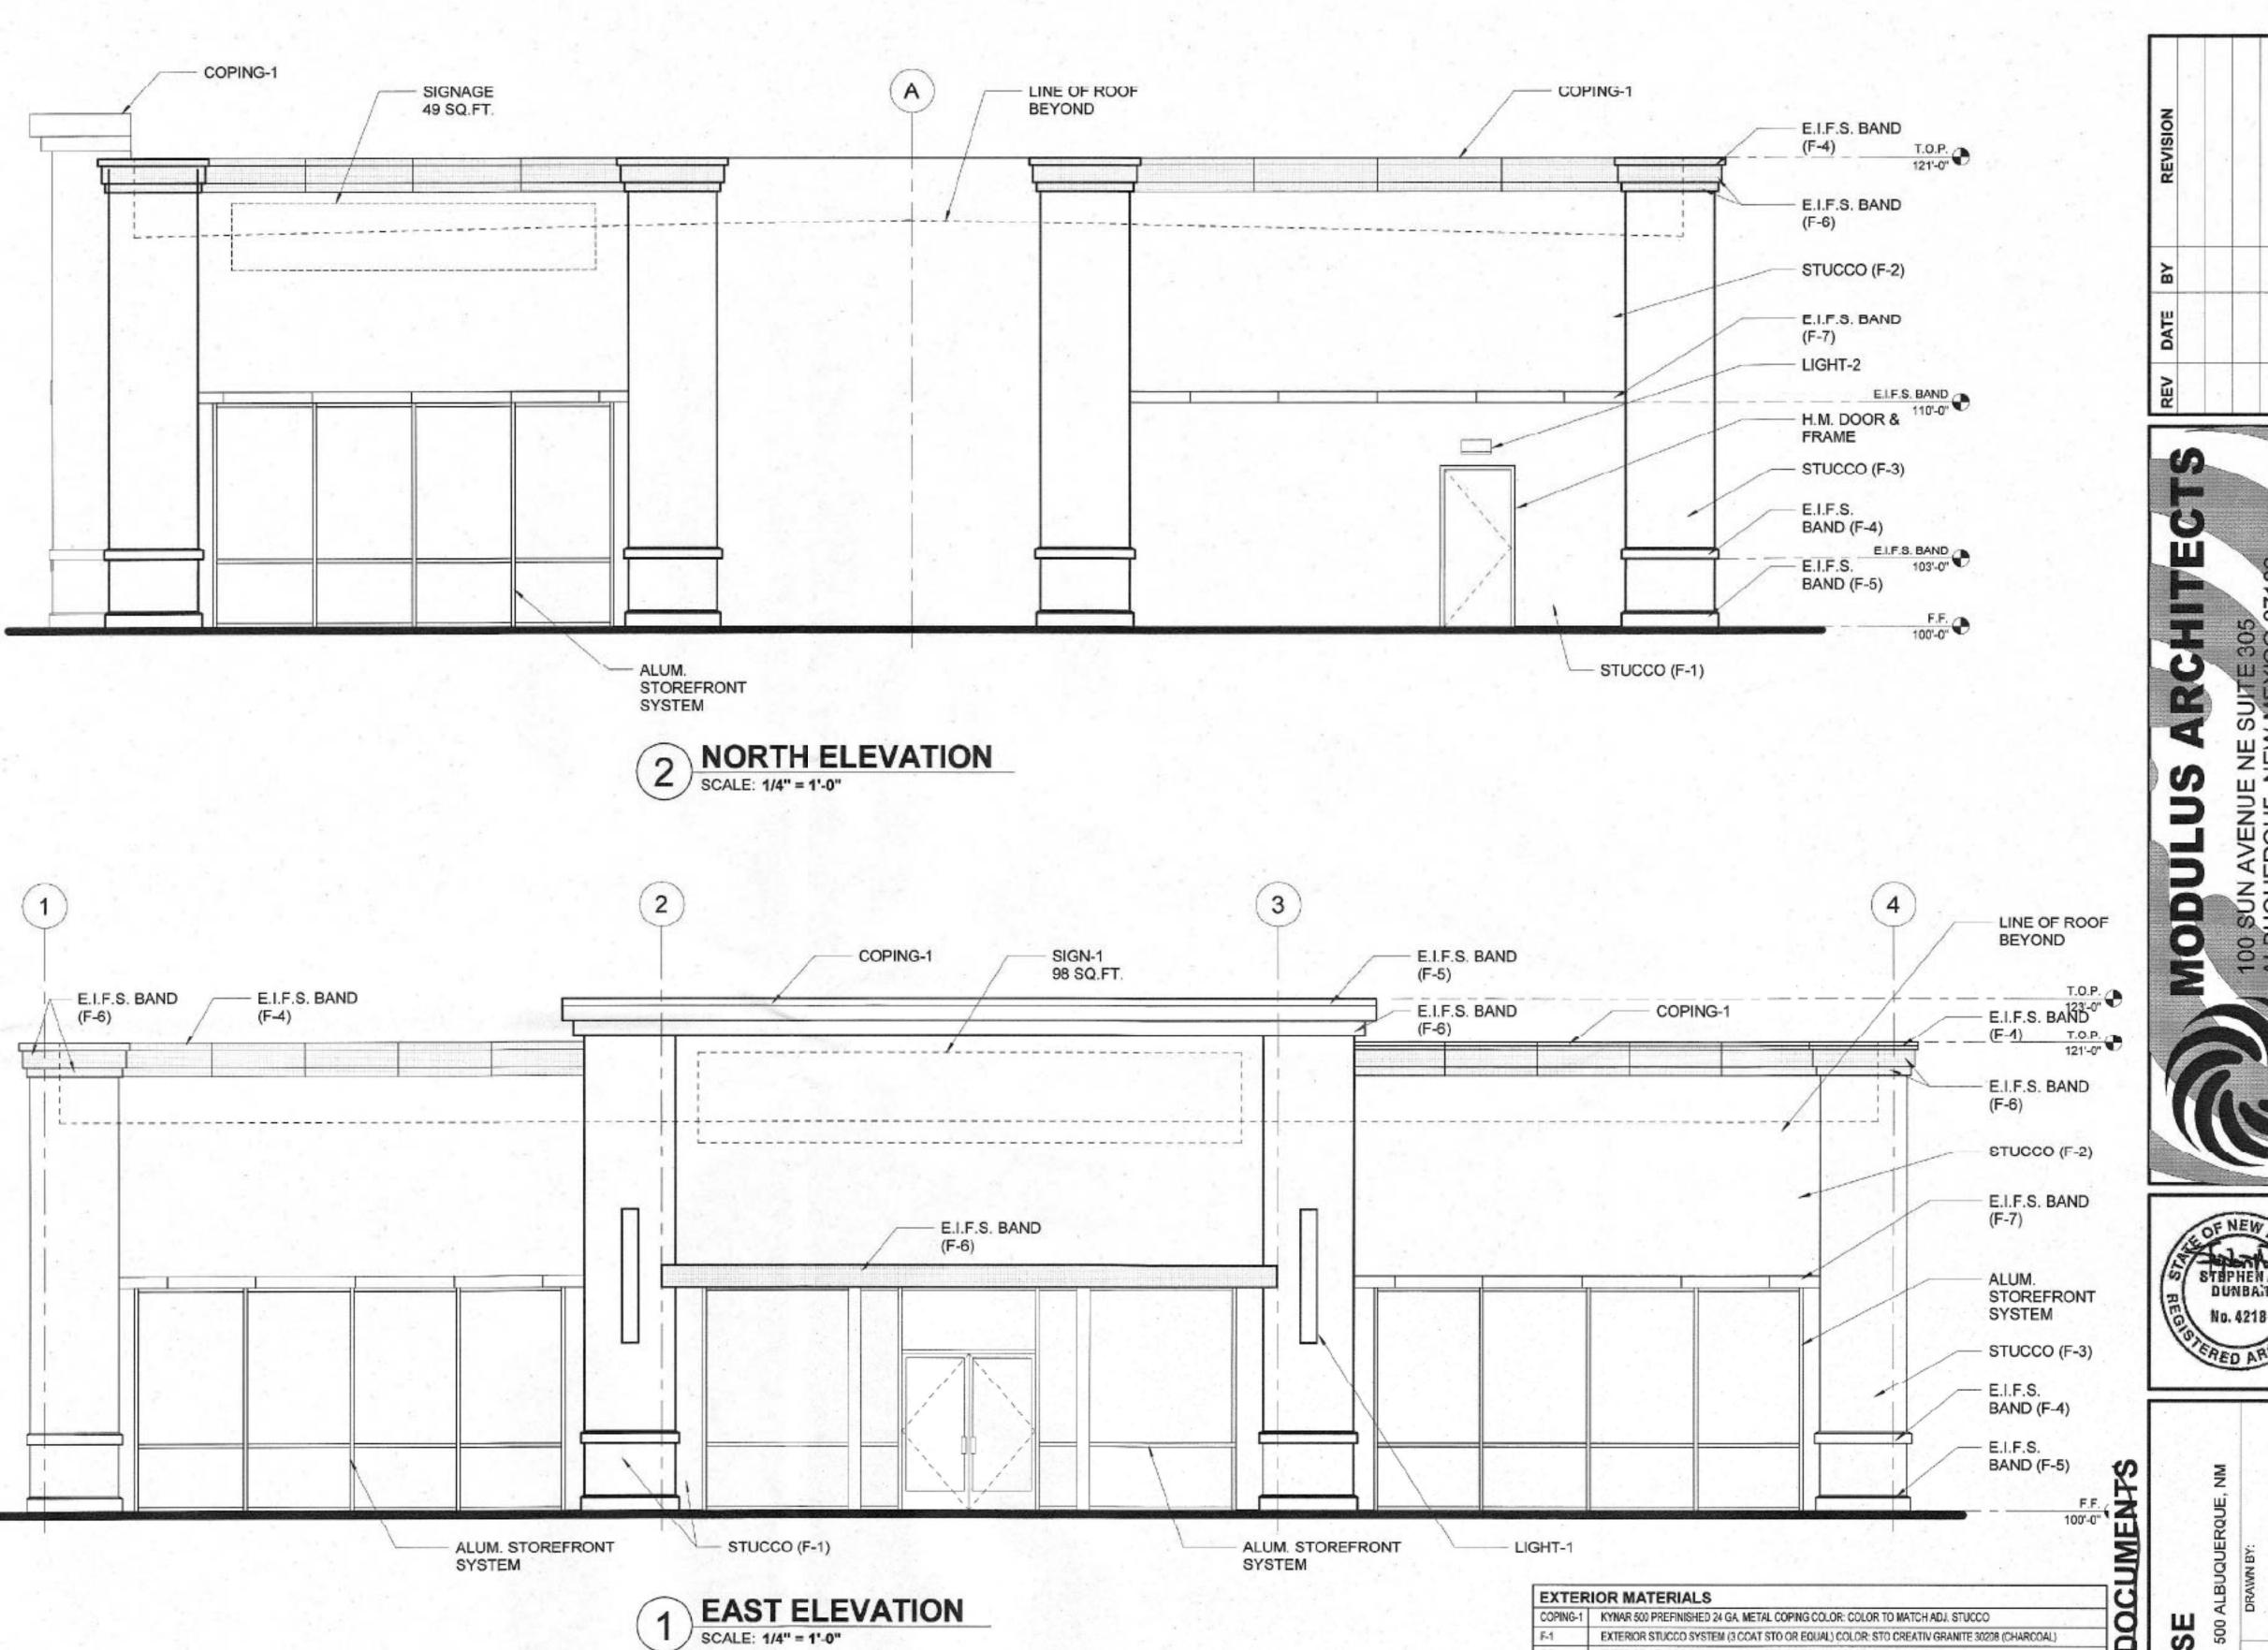

EXTERIOR MATERIALS COPING-1 KYNAR 500 PREFINISHED 24 GA. METAL COPING COLOR: COLOR TO MATCH ADJ. STUCCO EXTERIOR STUCCO SYSTEM (3 COAT STO OR EQUAL) COLOR: STO CREATIV GRANITE 30208 (CHARCOAL) EXTERIOR STUCCO SYSTEM (3 COAT STO OR EQUAL) COLOR: STO 16262 (TAN) EXTERIOR STUCCO SYSTEM (3 COAT STO OR EQUAL) COLOR: 158 STO LIMESTONE CMP18400 (CREAM) E.I.F.S. BAND COLOR: STO 16262 (TAN) E.I.F.S. BAND COLOR: STO CREATIV GRANITE 30208 (CHARCOAL) E.I.F.S. BAND COLOR: 158 STO LIMESTONE 16170 (WHITE) E.I.F.S. BAND COLOR: 158 STO LIMESTONE 16400 (CREAM) GLAZING-1 ALUM. STOREFRONT SYSTEM, KAWNEER TRI-FAB 451T THERMALLY BROKEN BRONZE WI 1" INSUL. LOW E GLAZING UNITS INDIVIDUAL LETTER SIGNAGE W/ INTERNAL ILLUMINATION PROVIDE 5/6" PLY. WD. BACKING AT SIGN AREA BACKING 5/8" TREATED PLY, WD, SIGN BACKING SUBSTRATE LOCATION EXT. SURFACE MOUNT J-BOX LOCATION AS INDICATED PROVIDE TEMP. COVER PLATE. ROUTE 1 1/2" CONDUIT FROM J-BOX LOCATION TO TENANTS PANEL LOCATION. EXTERIOR DECORATIVE WALL SCONCE LIGHT FIXTURE, RE: ELEC. DRAWING FOR INFO. EXTERIOR WALL PACK LIGHT FIXTURE; RE: ELEC. DRAWINGS FOR INFO.

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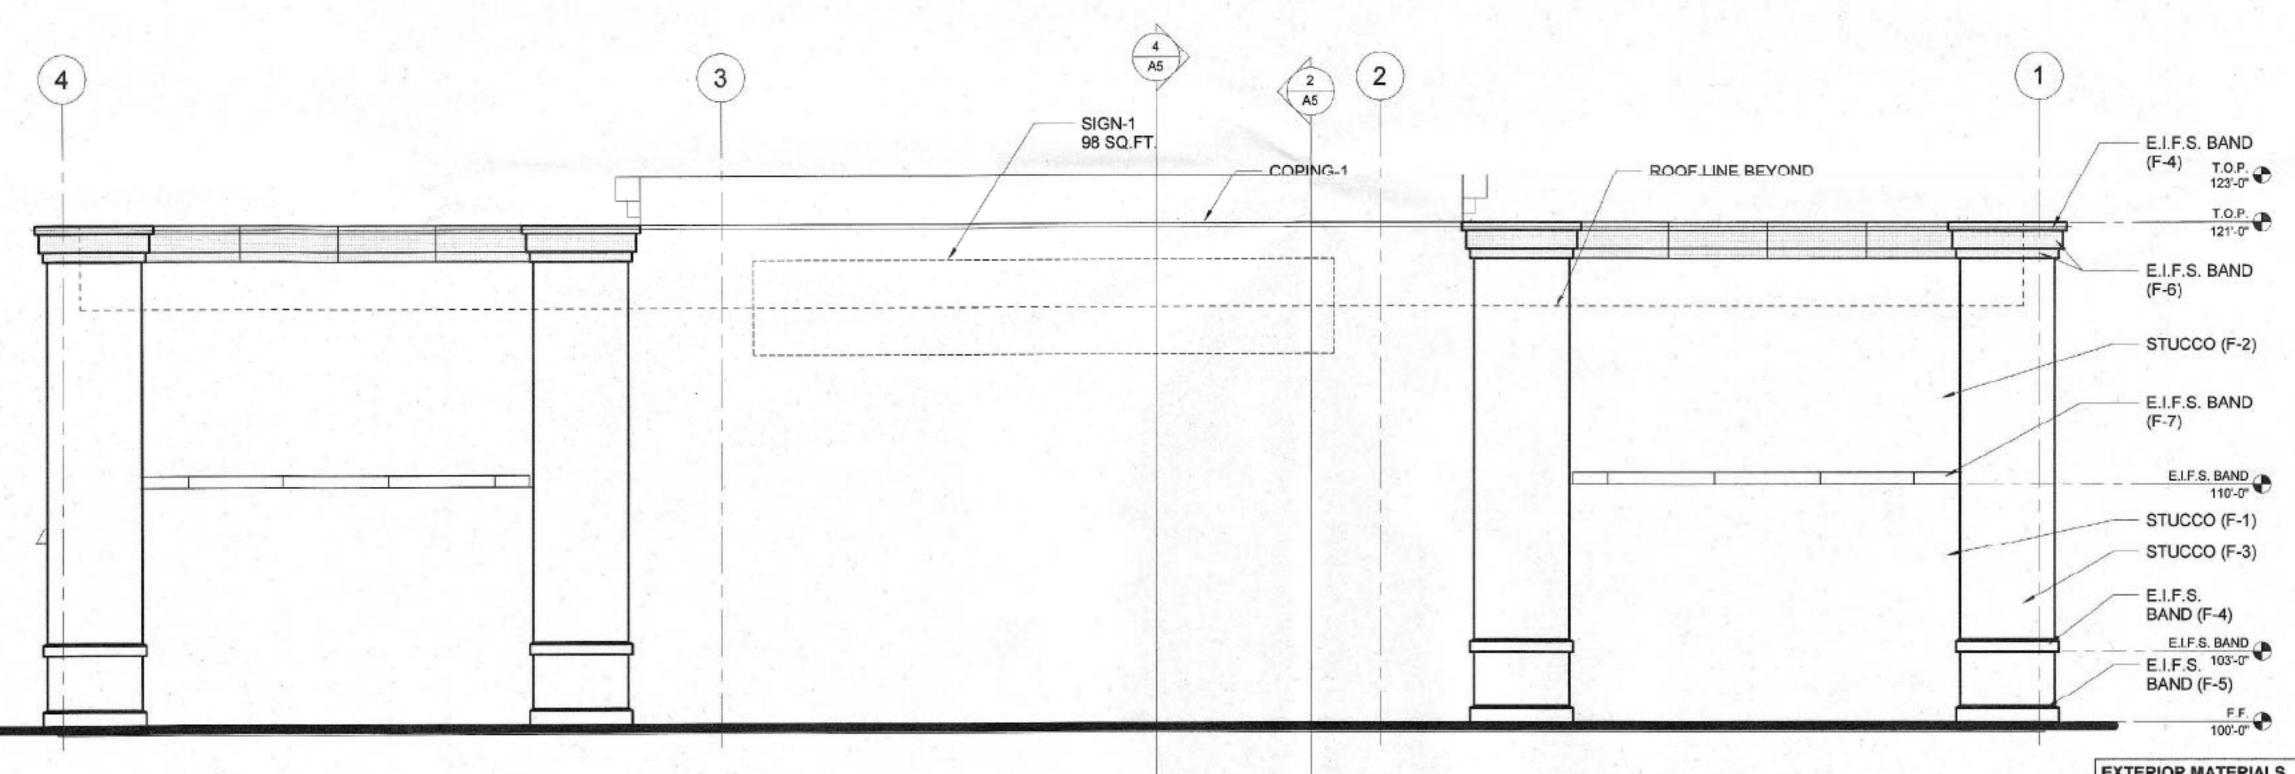
03/01/18

NOTE: ALL EXTERIOR MOUNTED GEAR SHALL BE PAINTED TO MATCH ADJ. EXTERIOR FINISH COLOR.

BLOCK-1 EXTERIOR SPLIT FACED CMU WAINSCOT- PAINTED FINISH

EXTERIOR HOLLOW METAL DOOR AND FRAME, COLOR: PAINT TO MATCH ADJ. STUCCO








2 WEST ELEVATION
SCALE: 1/4" = 1'-0"

**EXTERIOR MATERIALS** COPING-1 KYNAR 500 PREFINISHED 24 GA. METAL COPING COLOR: COLOR TO MATCH ADJ. STUCCO EXTERIOR STUCCO SYSTEM (3 COAT STO OR EQUAL) COLOR: STO CREATIV GRANITE 30208 (CHARCOAL) EXTERIOR STUCCO SYSTEM (3 COAT STO OR EQUAL) COLOR: STO 16262 (TAN) EXTERIOR STUCCO SYSTEM (3 COAT STO OR EQUAL) COLOR: 158 STO LIMESTONE CMP16400 (CREAM) E.I.F.S. BAND COLOR: STO 16262 (TAN) E.I.F.S. BAND COLOR: \$TO CREATIV GRANITE 30208 (CHARCOAL) E.I.F.S. BAND COLOR: 158 STO LIMESTONE 16170 (WHITE) . FIFS BAND COLOR: 158 STO LIMESTONE 18400 (CREAM) GLAZING-1 ALUM. STOREFRONT SYSTEM, KAWINEER TRI-FAB 451T THERMALLY BROKEN BRONZE WI 1" INSUL, LOW E GLAZING UNITS INDIVIDUAL LETTER SIGNAGE W/INTERNAL ILLUMINATION PROVIDE 5/8" PLY. WD. BACKING AT SIGN AREA BACKING 5/6" TREATED PLY, WD. SIGN BACKING SUBSTRATE LOCATION EXT. SURFACE MOUNT J-BOX LOCATION AS INDICATED PROVIDE TEMP. COVER PLATE. ROUTE 1 1/2" CONDUIT FROM J-BOX LOCATION TO TENANTS PANEL LOCATION. EXTERIOR DECORATIVE WALL SCONCE LIGHT FIXTURE, RE: ELEC. DRAWING FOR INFO. EXTERIOR WALL PACK LIGHT FIXTURE, RE: ELEC. DRAWINGS FOR INFO. EXTERIOR HOLLOW METAL DOOR AND FRAME, COLOR: PAINT TO MATCH ADJ. STUCCO BLOCK-1 EXTERIOR SPLIT FACED CMU WAINSCOT- PAINTED FINISH


NOTE: ALL EXTERIOR MOUNTED GEAR SHALL BE PAINTED TO MATCH ADJ. EXTERIOR FINISH COLOR.

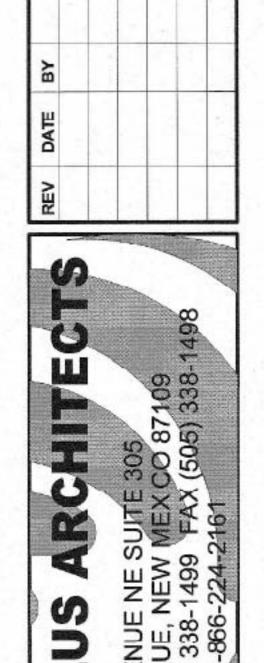


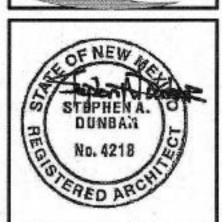


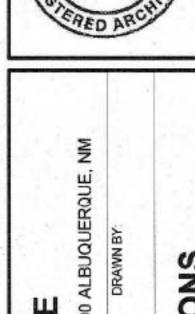




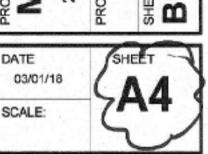

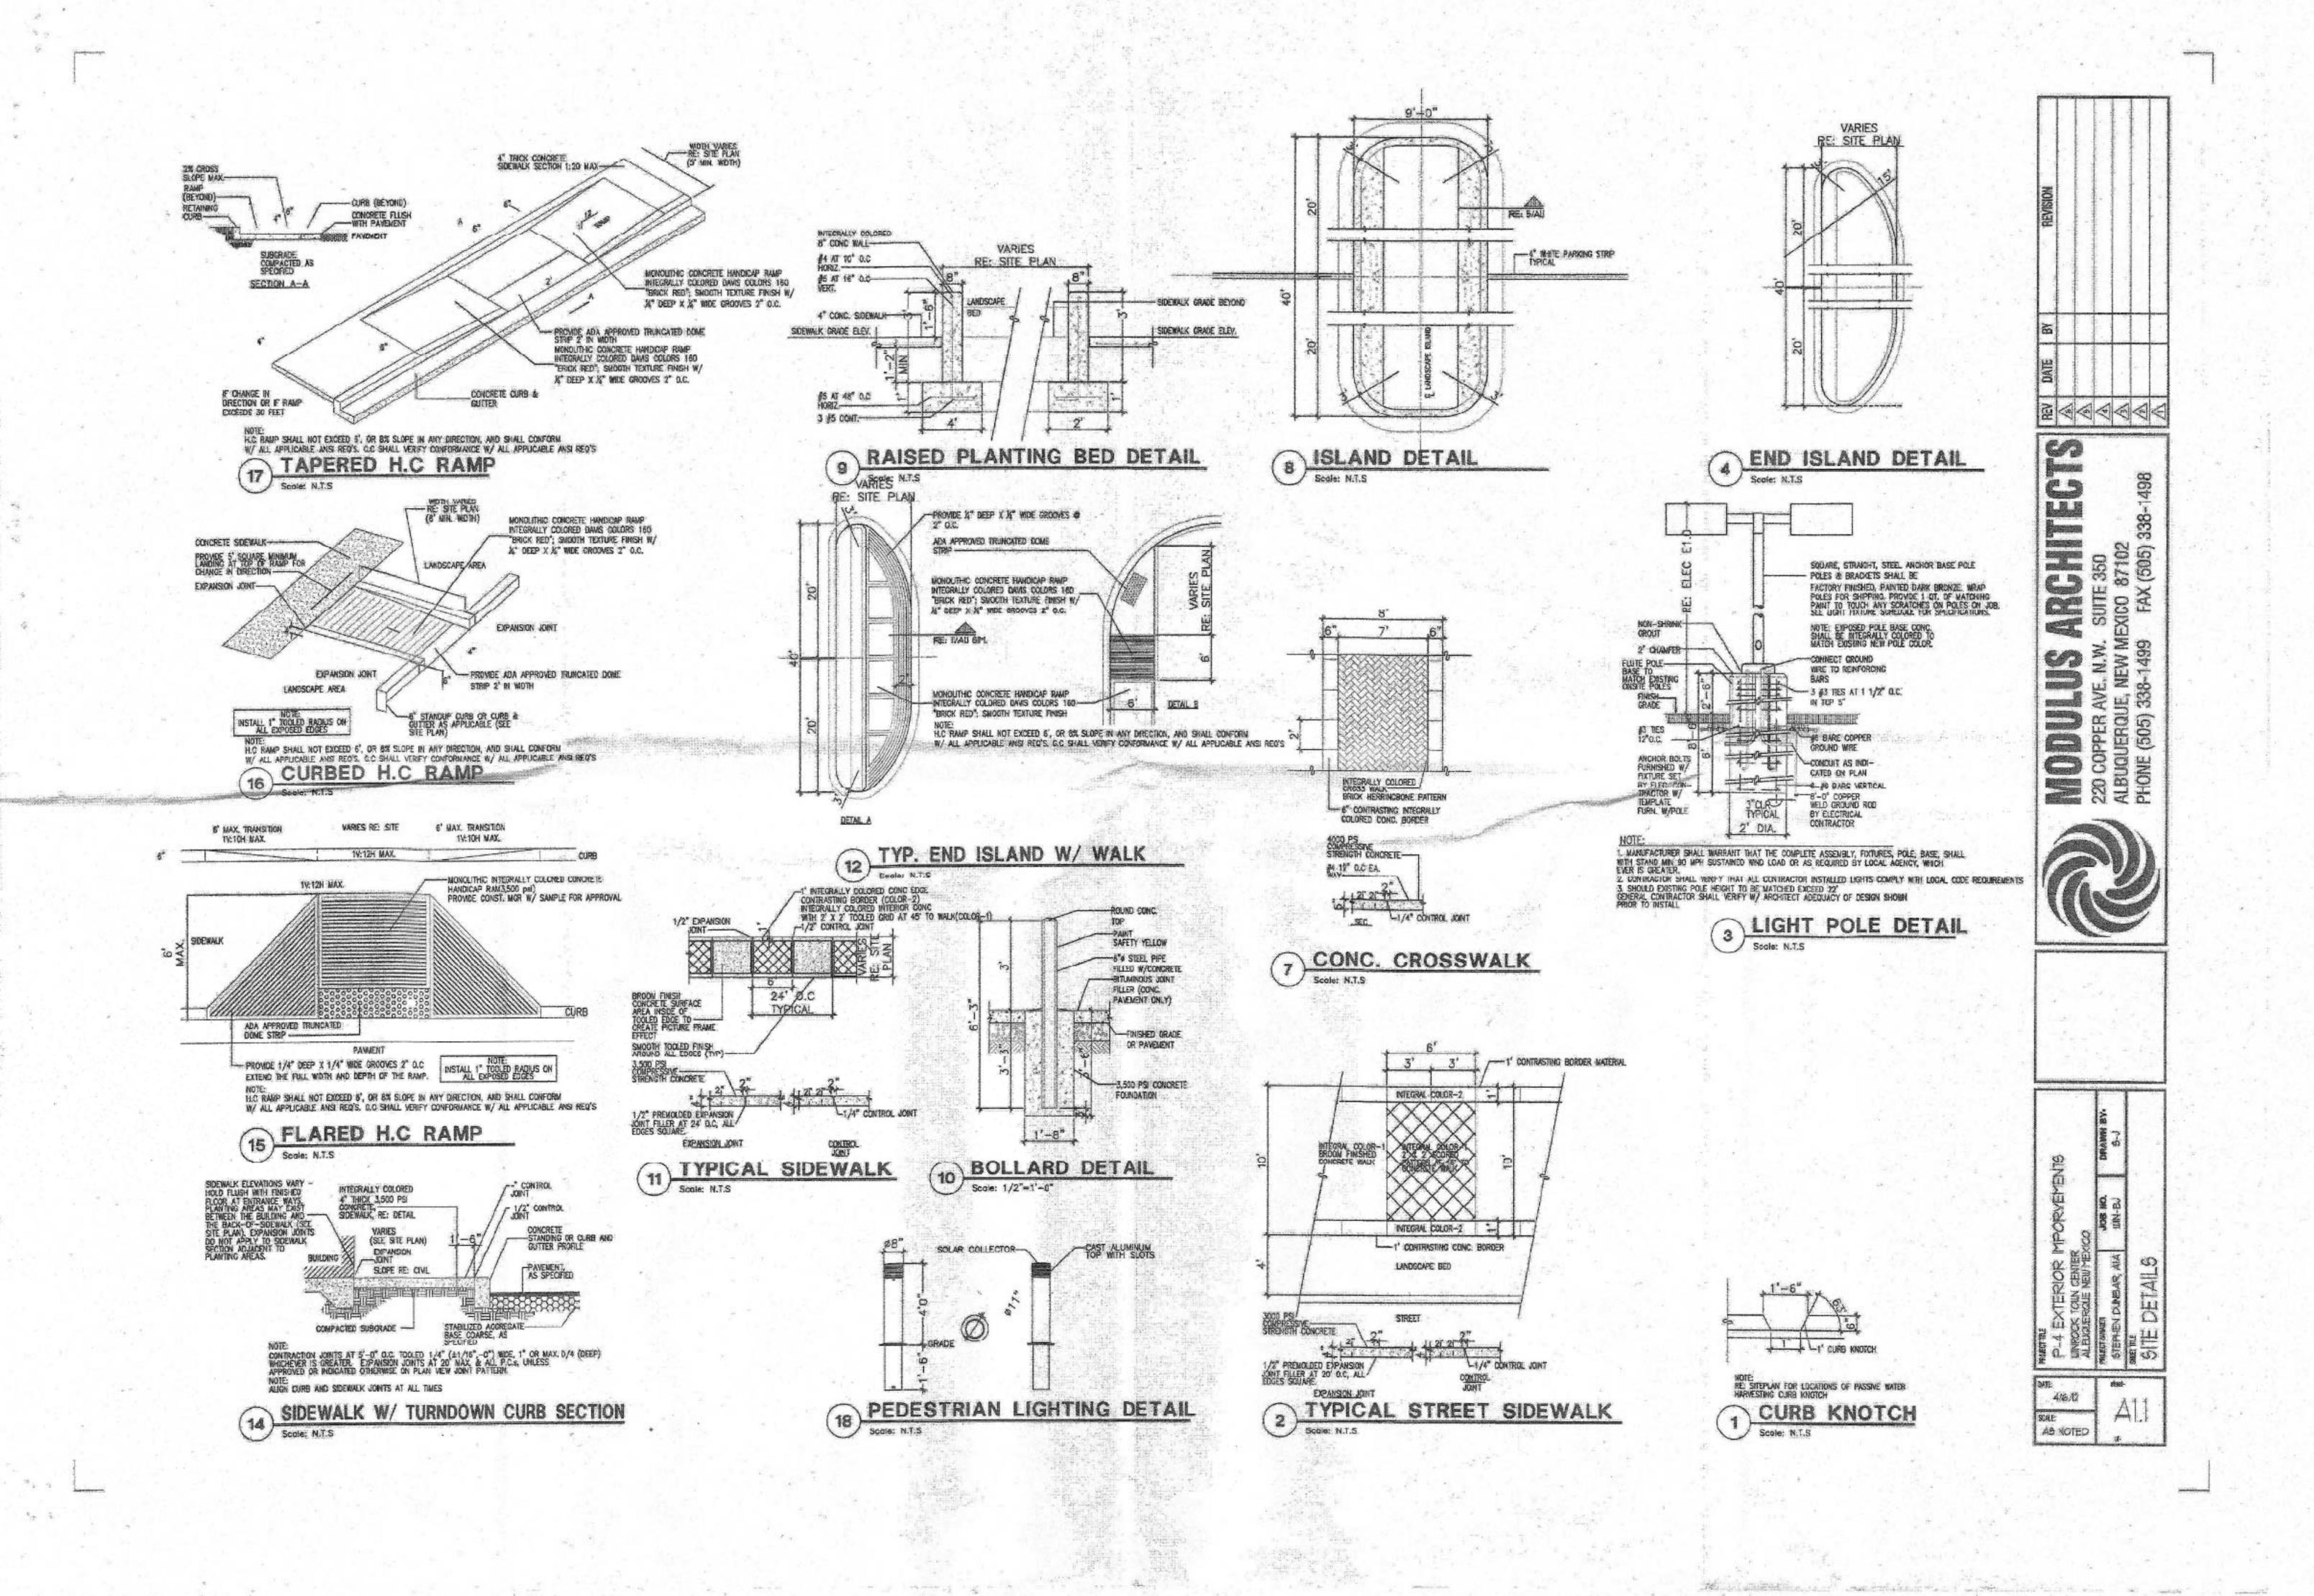


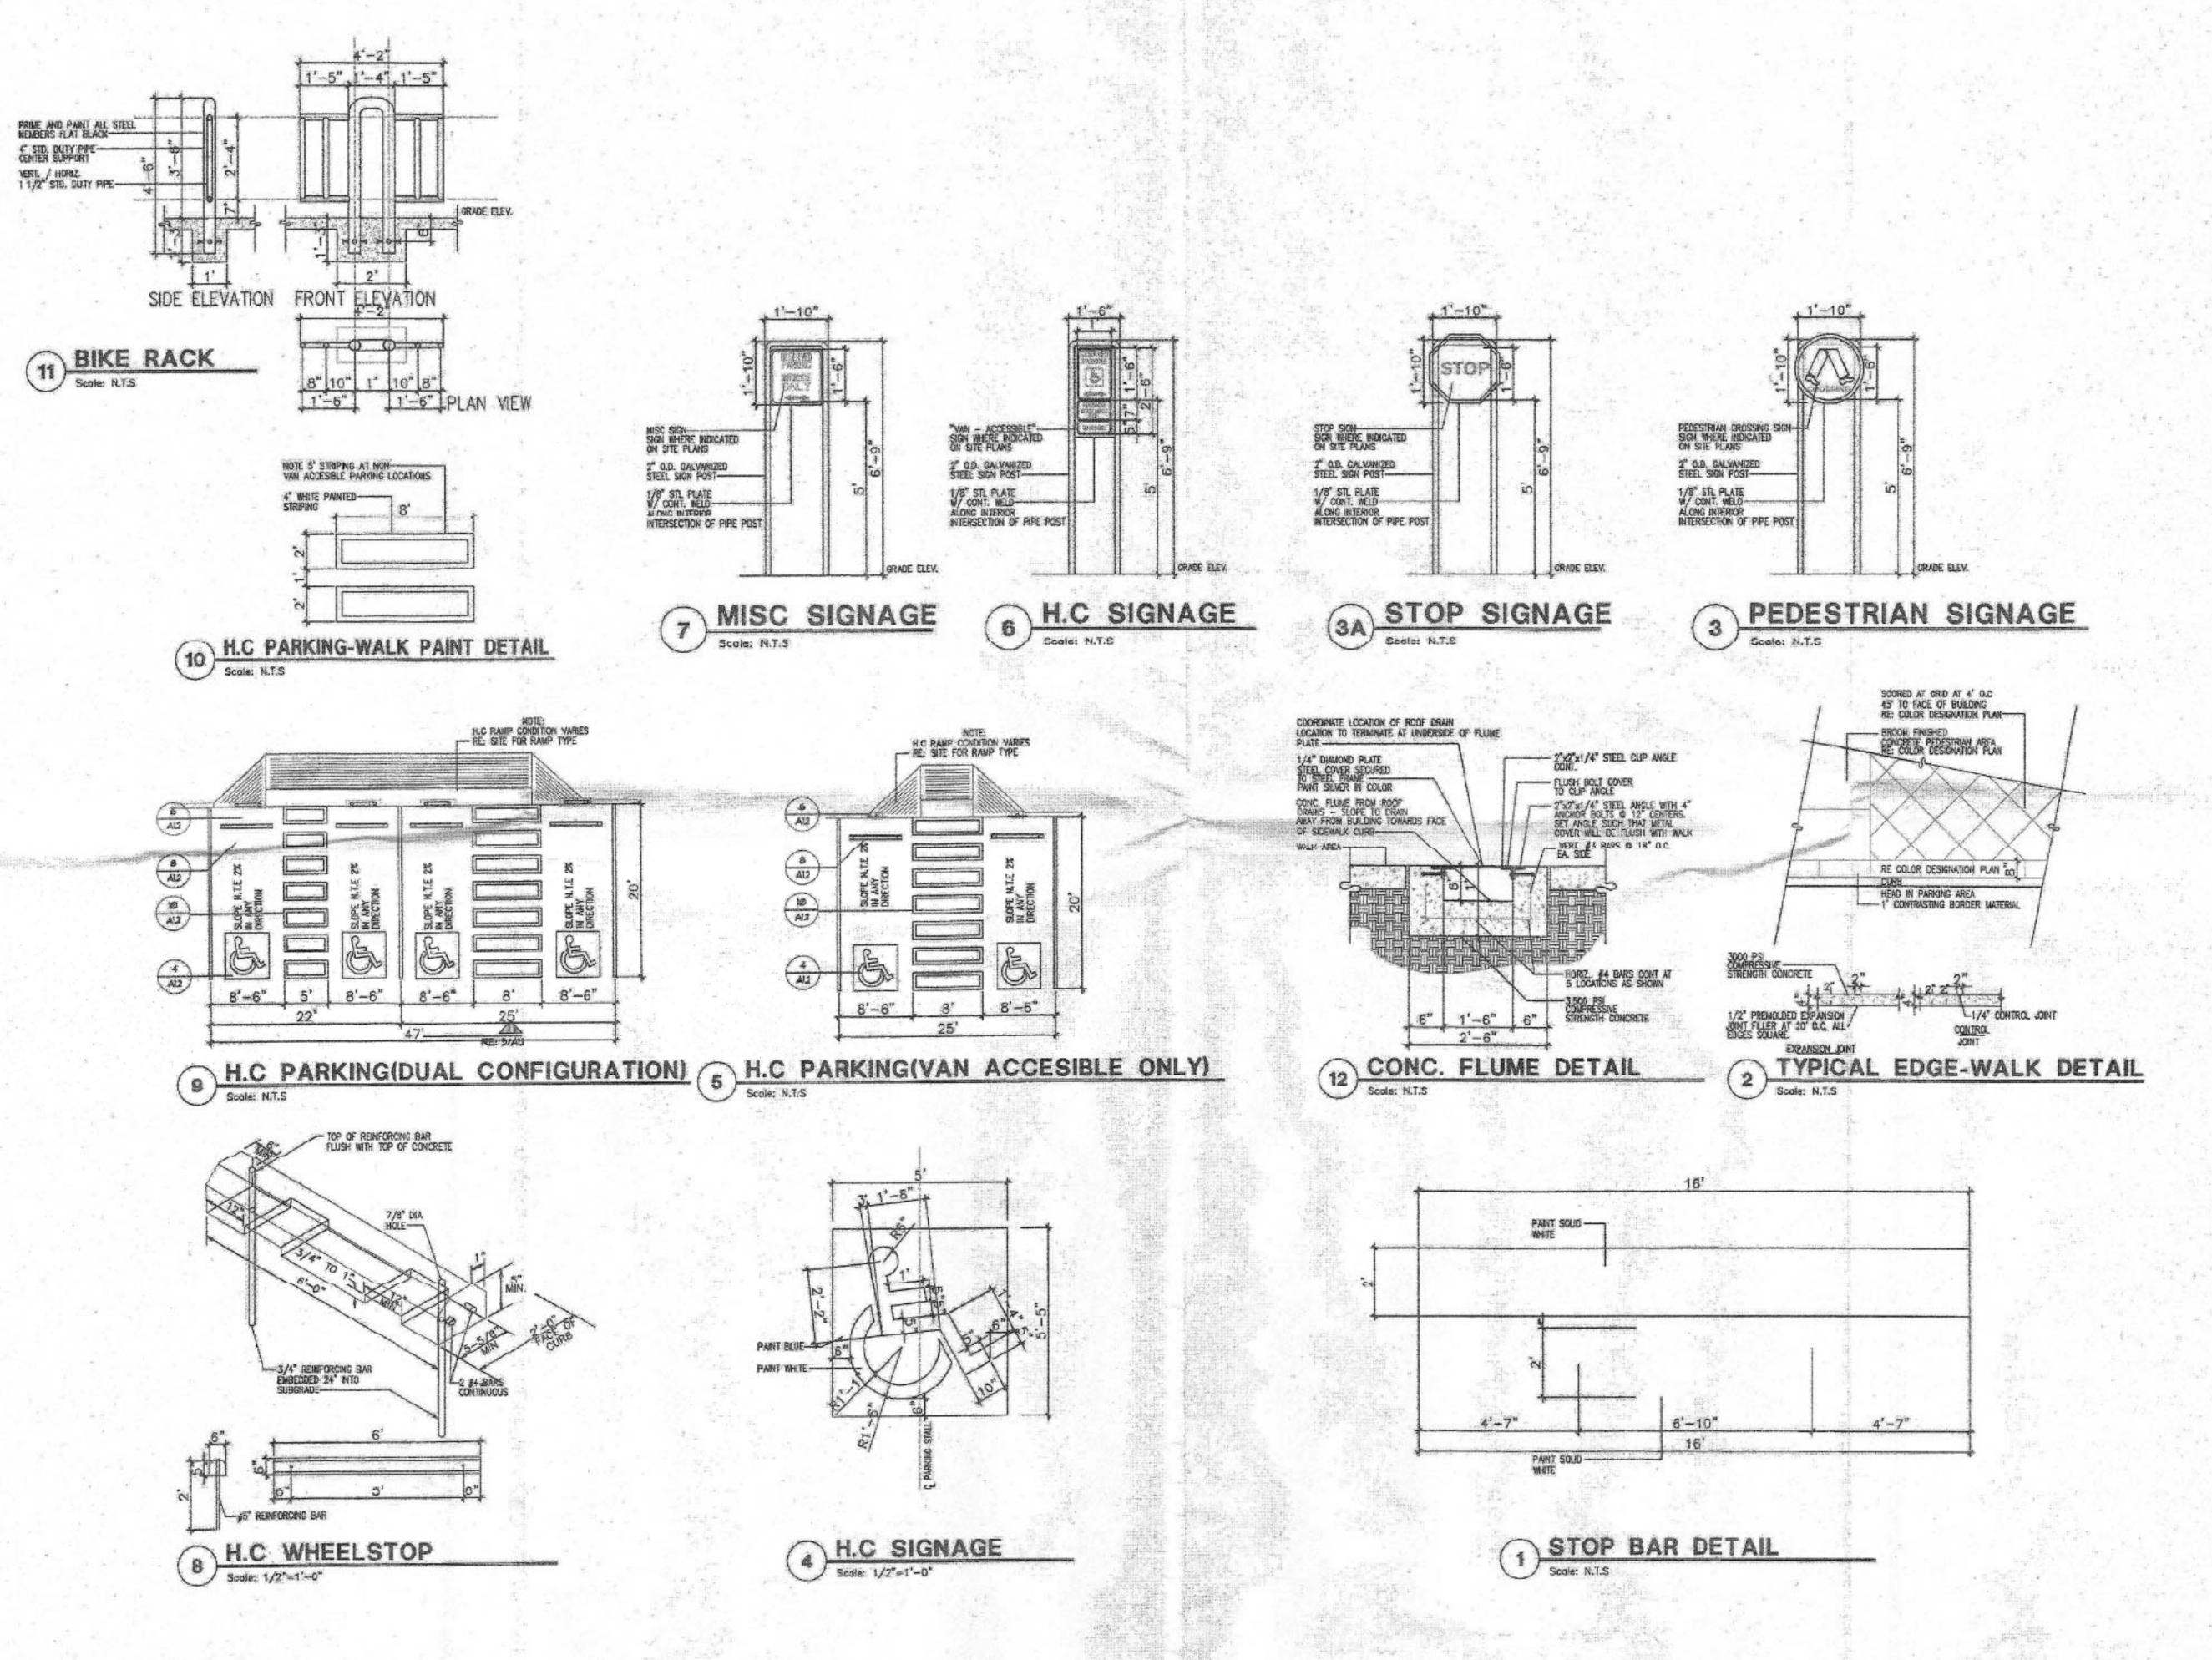

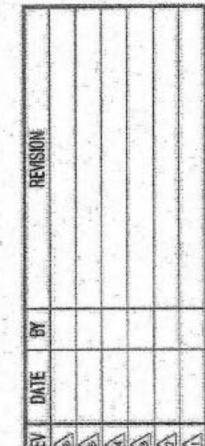

MODULIS 220 COPPER AVE. N.W. ALBUQUERQUE, NEW MI PHONE (505) 338-1499

P.4 EXTERIOR IMPROVEMENTS MNEOCK TOUN CENTER ALBUCIERCHE NEW FEXICO	PROVEME	Š.
ATTENDED OF MAKES	JOB NO.	DRAWN BY:

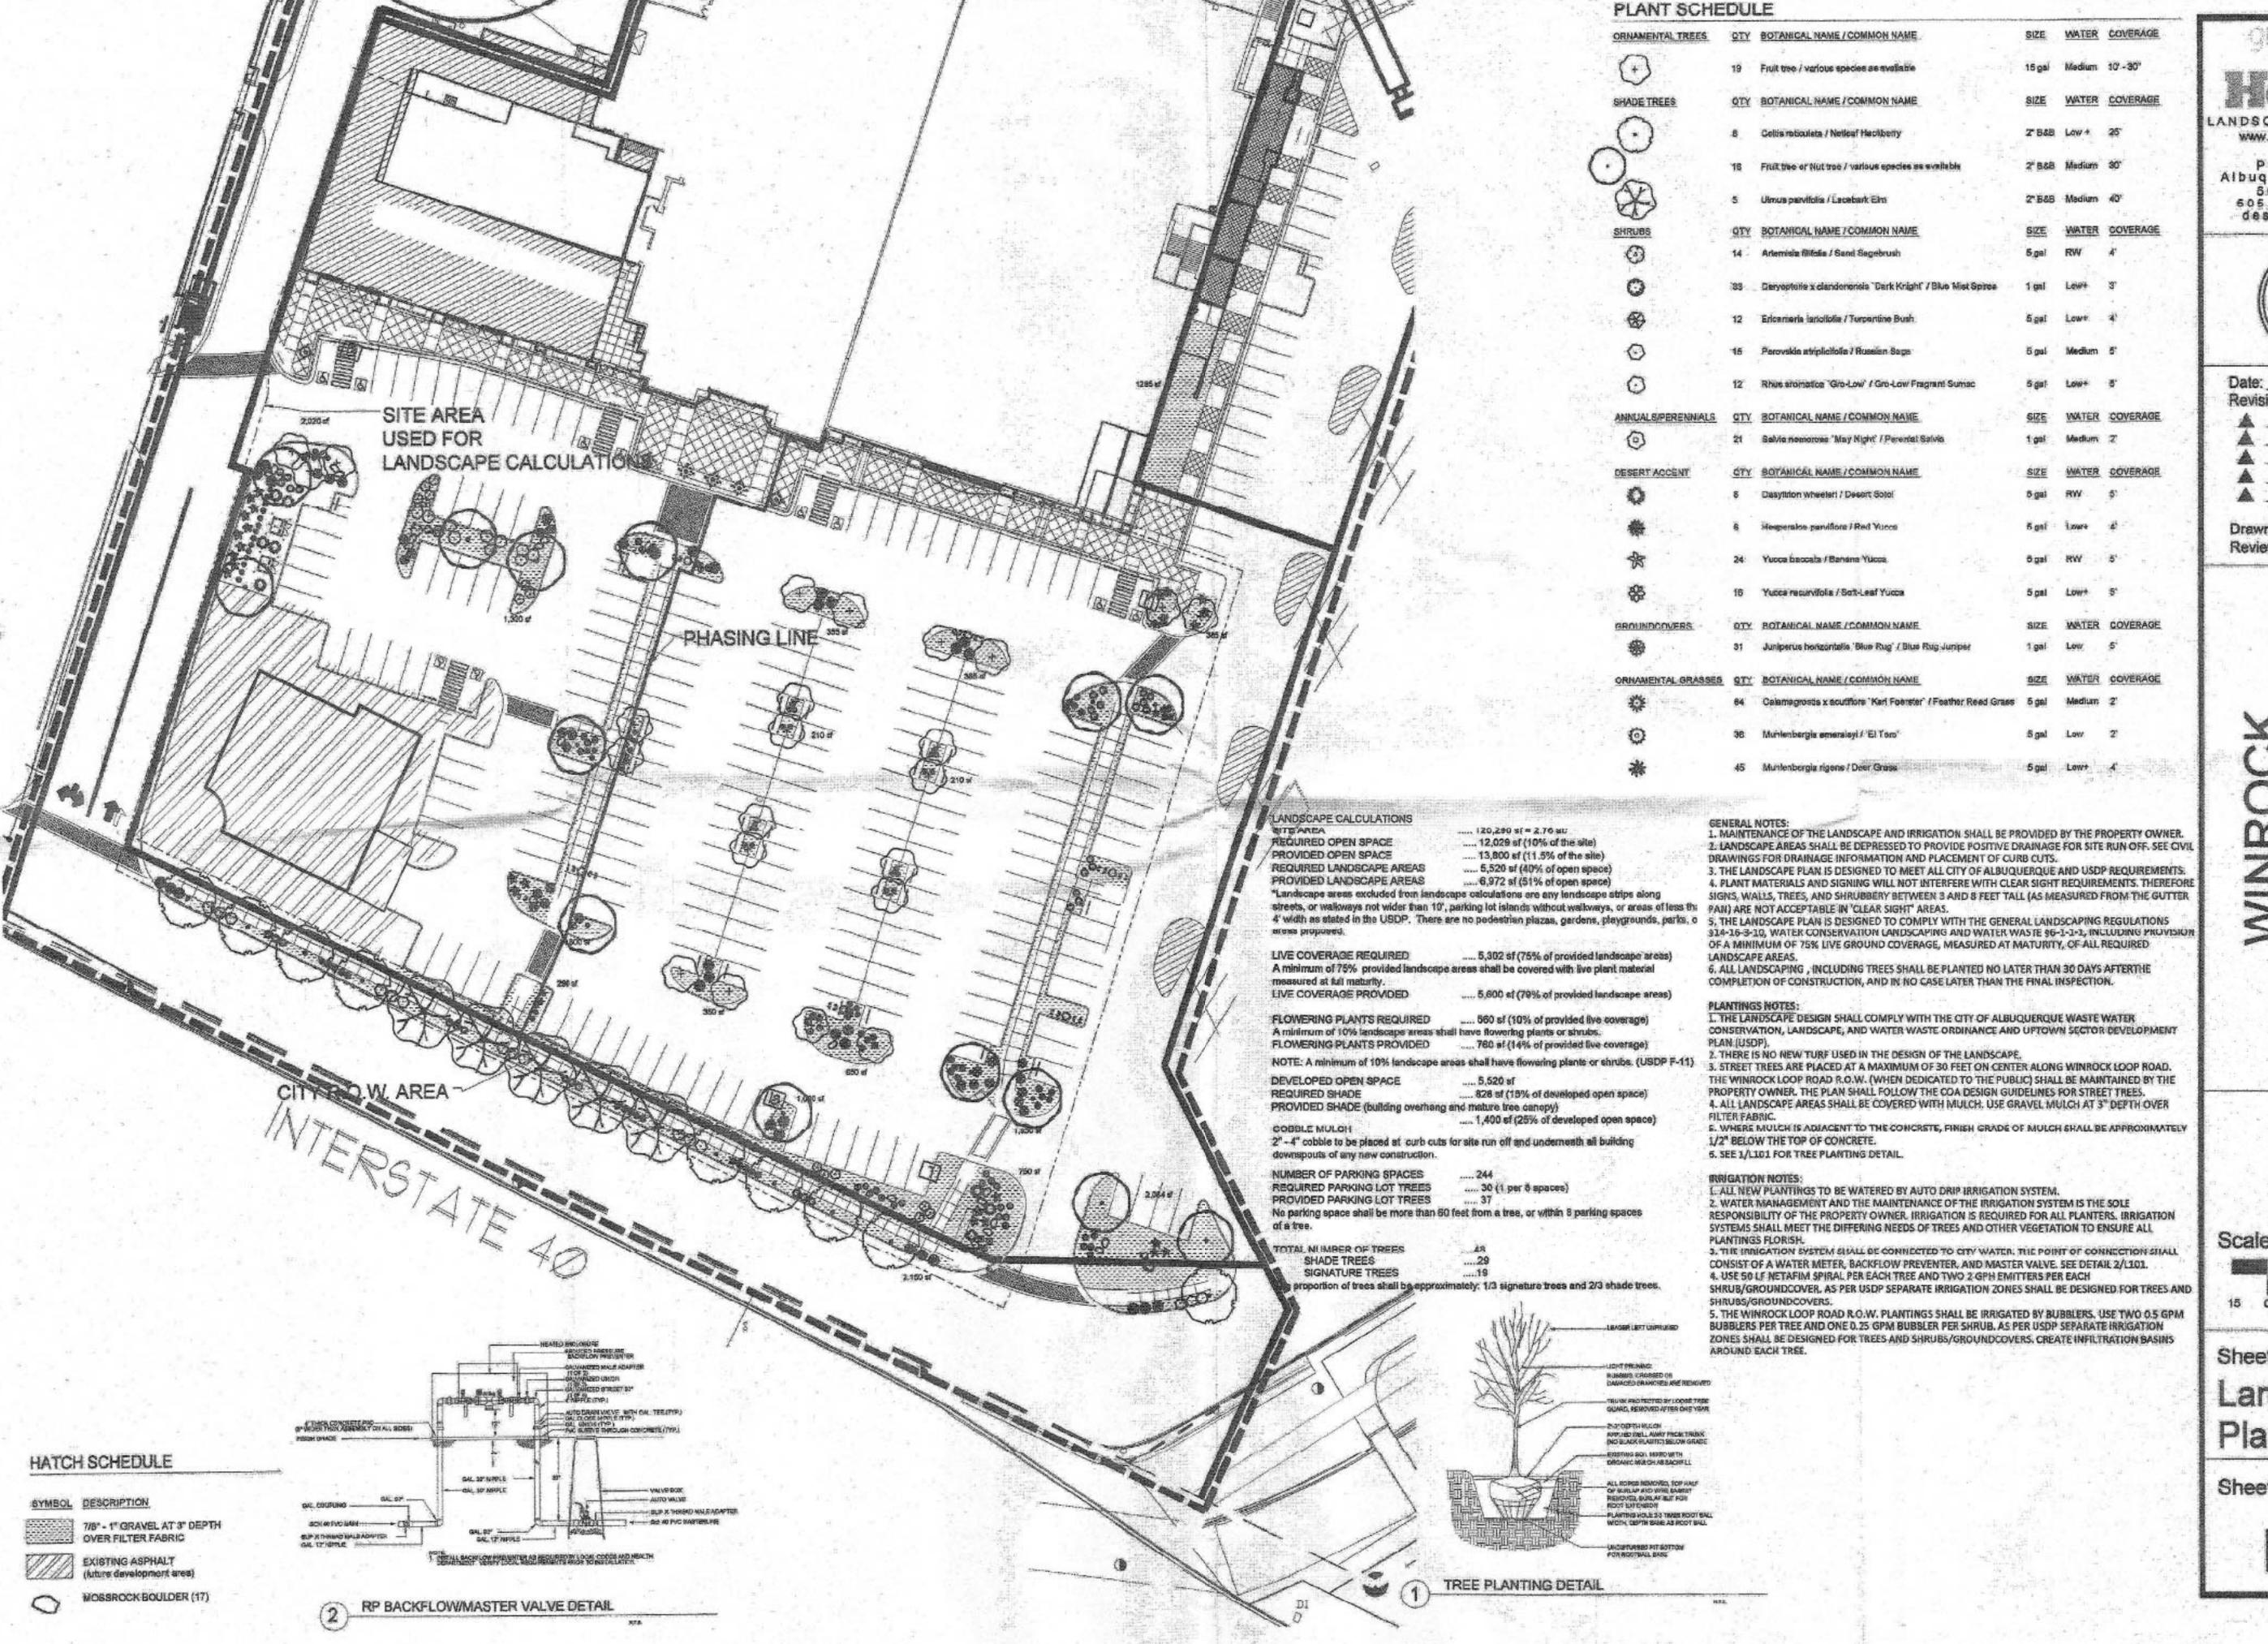



www.headsuplandscape.com

PO Box 10597 Albuquerque, NM 87184 505,898,9615 605,899,2105 (fax) design@hulc.com



Date: 07/08/2014 Revisions:

11/10/2014 01/21/2015 02/27/2015


Drawn by: Jitke Dekojova Reviewed by: Eddie Padilla

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Albuquerque

NORTH

Scale: 1" = 30'

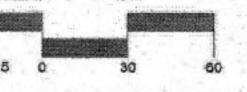

Sheet Title:

Landscape Plan

Sheet Number:

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## GENERAL LANDSCAPE PLAN CONFORMANCE REQUIREMENTS

- D.8 ALL OPEN SPACEAREAS SHALL BE PRIVATLY MAINTAINED OR MAINTAINED THROUGH AN UPTNA BID OR OTHER PRIVATE FUNDING METHOD
- D.13 THE USE OF GRAVEL INCLUDING ROCKS AND CRUSHER FINE AS GROUND COVER IS LIMITED TO A MAXIMUM OF FIVE (5%) PERCENT OF ANY OPEN SPACE INCLUDING ANY GRAVEL USED IN LANDSCAPE AREAS AND/OR PLANTING STRIPS
- NEW CONSTRUCTION AND/OR REDEVELOPMENT SHALL APLLY THE FOLLOWING LANDSCAPE REGULATIONS AND REQUIREMENTS:
- F.1. 40% OF THE "10% OF SITE" OPEN SPACE REQUIREMENT SHALL BE LANDSCAPE AREA. IN ADDITION, EVERY SITE SHALL HAVE A MINIMUM OF FOUR (4) FOOT WIDE PLANTING STRIP ABUTTING A TEN (10) FOOT WIDE WALKWAY.
- F.2. A LANDSCAPE PLAN SHALL BE PROVIDED WITH THE SITE DEVELOPMENT PLAN FOR APPROVAL, REQUIREMENTS FOR THE LANDSCAPE PLAN ARE LISTED IN CHAPTER
- F.3. ALL LANDSCAPES SHALL BE PLANTED AS SHOWN ON THE LANDSCAPE PLAN.
- F.A. ALL LANDSCAPING SHALL BE PLANTED NO LATER THAN 30 DAYS AFTER COMPLETION OF CONSTRUCTION AND IN NO CASE LATER THAN THE FINAL INSPECTION.
- F.5. ALL LANDSCAPING SHOULD BE PLANTED IN ACCORDANCE WITH INSTRUCTIONS PROVIDED IN MOST RECENT CITY STANDARDS NATIONALLY ACCEPTED STANDARDS BY NURSERY, LANDSCAPE, IRRIGATION, AND ARBORICULTURE INDUSTRIES. SEE APPENDIX B
- F.7. IRRIGATION IS REQUIRED FOR ALL PLANTINGS. IRRIGATION SYSTEMS SHALL MEET THE DIFFERING NEEDS OF TREES AND OTHER VEGETATION TO ENSURE ALL PAINTINGS
- F.8. WATER HARVESTING CONSERVATION TECHNIQUES SHALL BE UTILIZED WHERE POSSIBLE AND AS APPROVED BY THE CITY HYDROLOGIST OR CITY ENGINEER. SUCH TECHNIQUES MAY INCLUDE WATER HARVESTING, GRAYWATER, WATER REUSE SYSTEMS AND PERMEABLE PAVEMENT. RAINWATER FROM ROOFS SHOULD BE DIRECTED OR STORED AND USED TO WATER TREES AND OTHER LANDSCAPING WHENEVER POSSIBLE.
- F.9. ORGANIC MULCH SHALL BE PROVIDED IN AREAS AROUND THE LIVING PLANTS TO REDUCE HEAT AND CONSERVE MOISTURE. GRAVEL, ROCKS, CRUSHER FINE AND RUBBER ARE NOT
- F.10. THE USE OF RIVER STONES TO BE USED AS MULCH IN AREAS OF DRAINAGE AND WATER RUNOFF IS ALLOWED IN LANDSCAPE AREAS. THE USE OF GRAVEL, INCLUDING ROCKS AND CRUSHER FINES AS GROUND COVER IS LITTED TO 5 % PERCENT OR LESS OF ANY LANDSCAPE AREA, PLANTING STRIP OR OPEN SPACE.
- F. 13. THE MINIMUM ACCEPTABLE SIZES OF PLANT, TREES OR AMOUNTS OF SEEDS, AT THE TIME OF PLANTING, ARE AS FOLLOWS:
  - A. TREES MUST BE TWO INCHES IN CALIPER. CONIFEROUS TREES SHALL BE A MINIMUM OF
  - B. SHRUBS, BUSHES AND LOW-GROWING EVERGREENS SHALL BE AT LEAST ONE GALLON IN
  - C. GROUND COVER AND TURF MUST BE ADEQUATE TO PROVIDE 75% GROUND COVERAGE WITHIN TWO GROWING SEASONS AFTER PLANTING
- F.15. ALL LANDSCAPING SHALL BE MAINTAINED IN SUCH A WAY AS TO KEEP PLANTS AND TREES HEALTHY, LANDSCAPING WHICH DIES SHALL BE REPLACED BY THE OWNER AS EXPEDITIOUSLY AS POSSIBLE, BUT IN NO CASE LONGER THAN (30) DAYS AFTER BEING MADE AVVARE OF THE ISSUE.
- F.16. FORTY (40%) PERCENT OF REQUIRED OPEN SPACE SHALL BE LANDSCAPED AREA.
  - A. LANDSCAPE AREAS SHALL BE COVERED WITH A MINIMUM OF SEVENTY-FIVE (75%) PERCENT LIVING, VEGETATIVE MATERIALD, DUCH AS TREES, ORASSES, VINES, FLOWERS AND/OR BRUSHES/SHRUBS, COVERAGE SHALL BE CALCULATED FROM THE ANTICIPATED SIZE OF MATURE PLANTS.
  - B. ALL OPEN SPACE AREAS THAT ARE NOT "DEVELOPED OPEN SPACE" AND ARE 25 SIZE OR LARGER SHALL BE PLANTED AS A LANDSCAPE AREA.
  - C. PLANTER BOXES OR LARGER PLANTING POTS MAY ALSO BE COUNTED AS THE
  - OPEN SPACE PROVIDED THEY ARE NOT WITHIN PLANTING STRIPS AND ARE SHOWN ON LANDSCAPE PLAN. THE SURFACE AREA OF PLANTER BOXES AND LARGE PLANTING
  - POTS ARE MEASURED IN ORDER TO CALCULATE THE AMOUNT OF LANDSCAPE AREA THEY EQUAL.
  - D. TREES ARE STRONGLY ENCOURAGED IN LANDSCAPE AREAS. REQUIRED PLANTING STRIPS ARE NOT CONSIDERED AS LANDSCAPE ARE FOR THE
- G.4. ALL REQUIRED TREES SHALL BE PLANTED NO LATER THAN THIRTY (30) DAYS AFTER THE COMPLETION OF CONSTRUCTION AND IN NO CASE LATER THAN THE FINAL INSPECTION.

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PURPOSE OF MEETING THE 40% OF THE 10% OF SITE REQUIREMENT.

- F.16. A. PLANTING STRIPS MUST BE A MINIMUM OF 4 FEET WIDE AND BE COVERED WITH LIVE VEGETATIVE MATERIALS SUCH AS GRASSES, VINES, FLOWERS AND OR BUSHES/SHRBS OVER SIXTY (60%) PERCENT OF THE PLANTING STRIP IF IT IS DIRECTLY BETWEEN PARKING AND A WALKWAY. IF THE PLANTING STRIP IS REQUIRED FOR STREET TREES IT SHALL BE COVERED WITH LIVE VEGETATIVE MATERIAL, SUCH AS GRASSES. VINES, FLOWERS AND OR BUSHES/SHRUBS OVER SEVENT-FIVE (75%) PERCENT OF THE PLANTING STRIP COVERAGESHALL BE CALCULATED FROM ANTICIPATEDSIZE OF THE PLATS AT MATURITY B. IN ORDER TO FACILITATE THE TRANSITION BETWEEN PARKING SPACESAND ADJACENT WALKWAYS, DECORATIVE PAVERS MAY BE USED WITHIN THE FORTY (40%) PERCENT OF THE PLANTING STRIP NOT REQUIRED TO CONTAIN LIVING, VEGETATIVE MATERIALS
- C. PLANTING STRIPS ARE NOT CONTAINED WITHIN WALKWAYS, THEY ABUT WALKWAYS I.S A FOUR(4) FOOT WIDE PLANTING STRIP ABUTS A TEN (10) FOOT WIDE WALKWAY.
- G.4. ALL REQUIRED TREES SHALL BE PLANTED NO LATER THAN THIRTY (30) DAYS AFTER THE
- Q.7. TREES SHALL BE IRRIGATE SO AS TO ENCOURAGE A DEEP AND WIDE ROOT SYSTEM THAT WILL PROVIDE HEALTHY GROWTH AND STRUCTURAL STABILITY. TREES SHALL BE ON SEPARATE IRRIGATION ZONES FROM OTHER VEGATATION BECAUSE TREES REQUIRE WATER OVER A LARGER AREA THAN OTHER PLANTS, DEEPER INTO SOIL, AND LESS FREQUENTLY THAN OTHER VEGETATION.
- G.8. ALL TREES SHALL BE MAINTAINED TO ENSURE THAT THE TREES STAY HEALTHY. MAINTENANCE INCLUDING TRIMMING IS THE RESPONSIBILITY OF THE OWNER OF THE TREE. IN THE CASE OF STREET TREES OR OTHER TREES PLANTED IN THE PUBLIC RIGHT-OF-WAY THE OWNER OF THE LOT ADJACENT AND CLOSEST TO THE TREE IS RESPONSIBLE FOR THE MAINTENANCE.
- G.9. THE REPLACEMENT OF DEAD TREES IS THE RESPONSIBILITY OF THE OWNER OF THE TREE. IN THE CASE OF STREET TREES OR OTHER TREES PLANTED IN THE PUBLIC RIGH-OF-WAY THE OWNER OF THE ADJACENT LOT CLOSEST TO THE TREE IS RESPONSIBLE FOR REPLACING THE DEAD TREE. DEAD TREES SHALL BE REPLACED WITH A TREE OF CONFORMING SPECIES AND LOCATION AS EXPEDITIOUSLY AS POSSIBLE, BUT IN NO CASE LONGER THAN THIRTY (30) DAYS AFTER BEING MADE AWARE OF THE ISSUE. GIGNATURE TREES MAY BE USED TO REPLACE SOME SHADE TREES IN ORDER TO ACHIEVE THE DESIRED SIGNATURE/SHADE TREE PROPORTIONS.
- G.14. PARKING LOT TREES ARE REQUIRED AS FOLLOWS:
  - A. TREES SHALL BE PLANTED AT A RATE OF ONE (1) TREE PER EIGHT (8) PARKING LOT SPACES. B. EACH ROW OF PARKING SHALL HAVE AN END CAP WITH AT LEAST ONE (1) TREE
  - C. TREES SHALL BE PLANTED IN THIRTY SIX (36) SQUARE FOOT TREE WELLS.
- D. NO PARKING SPACE SHALL BE MORE THAN SIXTY (60) FEET FROM A TREE TRUNK.
- G.15. WALKWAY TREES ARE REQUIRED AS FOLLOWS:
- A WALKWAY TREES SHALL BE PLANTED IN PLANTING STRIPS WHEN THE WALKWAY ABUTS A BUILDING AND/OR A PARKING SPACE NOT CONTAINED IN A PARKING LOT, AT A NUMBER EQUAL TO A MAXIMUM OF TWENTY-FIVE (25) FEET ON CENTER.
- B. WALKWAY TREES PLANTED IN A PLANTING STRIP MAY HAVE REGULAR OR IRREGULAR SPACING TO ACCOMMODATE THE ENTRANCES OF THE CORRESPONDING BUILDINGS PROVIDED THAT THE TOTAL NUMBER OF REQUIRED TREES ARE PLANTED.
- C. WALKWAYS TREES SHALL BE PLANTED ALONG WALKWAYS THAT DO NOT ABUT BUILDINGS AND ARE NOT SHADED BY EXISTING TREES AT THE NUMBER EQUAL TO A MAXIMUM TO TWENTY-FIVE (25) FEET ON CENTER. THIS REQUIREMENT INCLUDES WALKWAYS INTERNAL TO PARKING LOTS WHERE TREES WILL BE PLANTED ON ALTERNATING SIDES OF THE WALKWAY.
- D. THREE OR LESS WALKWAY TREES MAY BE GLUSTERED IF SUFFICIENT ROOTING
- VOLUME IS SUPPLIED AND IF THE REQUIREMENT TO SHADE THE WALKWAY IS MET. E. WALKWAY TREES ARE NOT REQUIRED ON THE WEST SIDE OF SAN PEDRO DR. OR THE
- NORTH SIDE OF MENAUL BLVD.
- H.4. THE TEN (10) FOOT WIDE WALKWAYS MAY ACCOMMODATE OCCASIONAL USES SUCH AS UTILITY BOXES, BENCHES AND/OR TRASH RECEPTACLES WHICH ENCROACH UPON THE WIDTH OF THE WALKWAY BUT A MINIMUM SIX (6) FOOT CLEAR PATH SHALL BE MAINTAINED WITHIN THE WALKWAY AT ALL TIMES. THESE OCCASIONAL USES SHALLNOT TAKE UP MORE THAN ONE-THIRD (%) OF THE WIDTH OF ANY BUILDING'S WALKWAY.
- H.7. ALL WALKWAYS MUST COMPLY WITH THE AMERICAN NATIONAL STANDARDS INSTITUTE AND AMERICANS WITH DISABILITY ACT.



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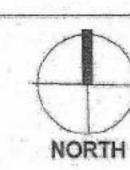


Date: 09/15/2014


Revisions: 10/06/2014 2/27/2015

Drawn by: Jitka Dekojova Reviewed by: Eddie Padilla

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Scale: 1" = 30"



Sheet Title:

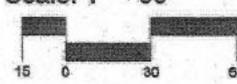Landscape Plan

Sheet Number:

### TRAFFIC CERTIFICATION

I, Stephen Dunbar, NMRA 4218, of the FIRM MODULUS ARCHITECTS INC. Hereby certify that this project is in substantial design compliance with and in accordance with the design intent of the APPROVED PLAN DATED 3/16/18(AA). The record information edited onto the original design document has been obtained by Stephen Dunbar of the firm MODULUS ARCHITECTS INC. I further certify that I have personally visited the site on 7/19/18 and have determined by visual inspection that the survey data provided is representative of actual site conditions and is true and correct to the best of my knowledge and belief. This certification is submitted in support of a request for FINAL CERTIFICATE OF OCCPANCY.

THE RECORD INFORMATION PRESENTED HEREON IS NOT NECESSARILY COMPLETE AND INTENDED ONLY TO VERIFY SUBSTANTIAL COMPLIANCE OF THE TRAFFIC ASPECTS OF THIS PROJECT. THOSE RELYING ON THE RECORD DOCUMENT ARE ADVISED TO OBTAIN INDEPENDENT VERIFICATION OF ITS ACCURACY BEFORE USING IT FOR ANY OTHER PURPOSE.

ARCHITECT'S STAMP

GED AR

DUNBAR

chitect

Date

Signature



# City of Albuquerque

### Planning Department

### Development & Building Services Division

DRAINAGE AND TRANSPORTATION INFORMATION SHEET (REV 3/2018)

Project Title:	Building Pe	rmit #: Hydrology File #:
		Work Order#:
Legal Description:		
City Address:		
Applicant:		Contact:
Address:		
		E-mail:
Other Contact:		Contact:
Address:		
Phone#:	Fax#:	E-mail:
Check all that Apply:		IS THIS A RESUBMITTAL?: Yes No
DEPARTMENT:  HYDROLOGY/ DRAINAGI TRAFFIC/ TRANSPORTAT  TYPE OF SUBMITTAL:  ENGINEER/ARCHITECT CI PAD CERTIFICATION  CONCEPTUAL G & D PLAN GRADING PLAN DRAINAGE MASTER PLAN DRAINAGE REPORT  FLOODPLAIN DEVELOPME ELEVATION CERTIFICATE CLOMR/LOMR  TRAFFIC CIRCULATION L. TRAFFIC IMPACT STUDY  OTHER (SPECIFY)  PRE-DESIGN MEETING?	ERTIFICATION  N ENT PERMIT APPLIC  AYOUT (TCL) (TIS)	TYPE OF APPROVAL/ACCEPTANCE SOUGHT: BUILDING PERMIT APPROVAL CERTIFICATE OF OCCUPANCY PRELIMINARY PLAT APPROVAL SITE PLAN FOR SUB'D APPROVAL SITE PLAN FOR BLDG. PERMIT APPROVAL FINAL PLAT APPROVAL SIA/ RELEASE OF FINANCIAL GUARANTEE FOUNDATION PERMIT APPROVAL GRADING PERMIT APPROVAL SO-19 APPROVAL PAVING PERMIT APPROVAL GRADING/ PAD CERTIFICATION WORK ORDER APPROVAL CLOMR/LOMR FLOODPLAIN DEVELOPMENT PERMIT OTHER (SPECIFY)
DATE SUBMITTED:	By:	_

FEE PAID: