

# CITY OF ALBUQUERQUE

Planning Department  
Brennon Williams, Director



Mayor Timothy M. Keller

March 22, 2021

Scott Eddings, P.E.  
Huitt-Zollars  
333 Rio Rancho Blvd., Suite 101  
Rio Rancho, NM 87124

**RE: Winrock Town Center Park  
2100 Louisiana Blvd.  
Grading and Drainage Plan Stamp Date: 3/5/21  
Hydrology File: J19D058G**

Dear Mr. Eddings:

Based on the submittal received on 3/5/21, the Rough Grading Plan cannot be approved for Grading Permit until the following items are addressed:  
PO Box 1293

Albuquerque

NM 87103

www.cabq.gov

1. These plans are too vague on details. Please provide further information for review.
2. Please provide drainage basin limits with flow arrows showing storm drain runoff direction. The grading limits shown have some flows leaving the graded area and these flows need their SWQV addressed.
3. It appears the roadway and parking lot re-graded on the west portion of the graded area are blocked from the SWQ pond by curb and there are two large areas of ponding where there is parking.
4. The section describing the proposed flows mentions an existing storm drain. Please show this on the plans, show how the flows get there and show calculations showing it is adequately sized to handle these flows.
5. Are the lakes planned to be filled? If so, please state the elevation they are planned to be filled to. Show the available volume for SWQ.
6. Is there a drain on the lakes? How are these to be cleaned as SWQ waters are planned to be retained in here which would create murky water.

# CITY OF ALBUQUERQUE

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Brennon Williams, Director



*Mayor Timothy M. Keller*

If you have any questions, please contact me at 924-3986 or [earmijo@cabq.gov](mailto:earmijo@cabq.gov).

Sincerely,

A handwritten signature in black ink, appearing to read "Ernest Armijo".

Ernest Armijo, P.E.  
Principal Engineer, Planning Dept.  
Development Review Services

PO Box 1293

Albuquerque

NM 87103

[www.cabq.gov](http://www.cabq.gov)



# City of Albuquerque

Planning Department  
Development & Building Services Division

## DRAINAGE AND TRANSPORTATION INFORMATION SHEET (REV 11/2018)

**Project Title:** \_\_\_\_\_ **Building Permit #:** \_\_\_\_\_ **Hydrology File #:** \_\_\_\_\_

**DRB#:** \_\_\_\_\_ **EPC#:** \_\_\_\_\_ **Work Order#:** \_\_\_\_\_

**Legal Description:** \_\_\_\_\_

**City Address:** \_\_\_\_\_

**Applicant:** \_\_\_\_\_ **Contact:** \_\_\_\_\_

**Address:** \_\_\_\_\_

**Phone#:** \_\_\_\_\_ **Fax#:** \_\_\_\_\_ **E-mail:** \_\_\_\_\_

**Owner:** \_\_\_\_\_ **Contact:** \_\_\_\_\_

**Address:** \_\_\_\_\_

**Phone#:** \_\_\_\_\_ **Fax#:** \_\_\_\_\_ **E-mail:** \_\_\_\_\_

**TYPE OF SUBMITTAL:** \_\_\_\_\_ PLAT (\_\_\_\_ # OF LOTS) \_\_\_\_\_ RESIDENCE \_\_\_\_\_ DRB SITE \_\_\_\_\_ ADMIN SITE

IS THIS A RESUBMITTAL?: \_\_\_\_\_ Yes \_\_\_\_\_ No

**DEPARTMENT:** \_\_\_\_\_ TRAFFIC/ TRANSPORTATION \_\_\_\_\_ HYDROLOGY/ DRAINAGE

Check all that Apply:

**TYPE OF SUBMITTAL:**

- ENGINEER/ARCHITECT CERTIFICATION
- PAD CERTIFICATION
- CONCEPTUAL G & D PLAN
- GRADING PLAN
- DRAINAGE MASTER PLAN
- DRAINAGE REPORT
- FLOODPLAIN DEVELOPMENT PERMIT APPLIC
- ELEVATION CERTIFICATE
- CLOMR/LOMR
- TRAFFIC CIRCULATION LAYOUT (TCL)
- TRAFFIC IMPACT STUDY (TIS)
- OTHER (SPECIFY) \_\_\_\_\_
- PRE-DESIGN MEETING?

**TYPE OF APPROVAL/ACCEPTANCE SOUGHT:**

- BUILDING PERMIT APPROVAL
- CERTIFICATE OF OCCUPANCY
- PRELIMINARY PLAT APPROVAL
- SITE PLAN FOR SUB'D APPROVAL
- SITE PLAN FOR BLDG. PERMIT APPROVAL
- FINAL PLAT APPROVAL
- SIA/ RELEASE OF FINANCIAL GUARANTEE
- FOUNDATION PERMIT APPROVAL
- GRADING PERMIT APPROVAL
- SO-19 APPROVAL
- PAVING PERMIT APPROVAL
- GRADING/ PAD CERTIFICATION
- WORK ORDER APPROVAL
- CLOMR/LOMR
- FLOODPLAIN DEVELOPMENT PERMIT
- OTHER (SPECIFY) \_\_\_\_\_

DATE SUBMITTED: \_\_\_\_\_ By: \_\_\_\_\_

COA STAFF:

ELECTRONIC SUBMITTAL RECEIVED: \_\_\_\_\_

FEE PAID: \_\_\_\_\_

## EXISTING DRAINAGE CONDITIONS

THIS SITE IS UNDER THE EXISTING WINROCK DRAINAGE IMPLEMENTATION PLAN. STORM WATER FROM THIS PORTION OF THE SITE ENTERS THE EXISTING STORM DRAIN SYSTEM WHICH OUTFALLS INTO THE I-40 CHANNEL.

## FLOOD ZONE

PER THE FEMA MAP NUMBER 35001 C0352G DATED SEPTEMBER 26, 2008 SHOWS THE SITE IS NOT LOCATED WITHIN A FLOOD HAZARD ZONE AREA.

## MASTER DRAINAGE PLAN

SITE DRAINAGE IS IN ACCORDANCE WITH THE APPROVED WINROCK TOWN CENTER MASTER DRAINAGE PLAN.

## PROPOSED DRAINAGE CONDITIONS

DEVELOPMENT SHALL BE IN ACCORDANCE WITH THE APPROVED DRAINAGE MASTER PLAN FOR WINROCK TOWN CENTER. THE DRAINAGE PLAN IS ONLY FOR THE NEW PARK. **A MORE DETAILED DRAINAGE REPORT FOR THE PUBLIC INFRASTRUCTURE IS FORTHCOMING.**

THE TOTAL SITE AREA IS APPROXIMATELY 4.88 ACRES WITH THE FOLLOWING ESTIMATED LAND TREATMENTS FOR BASIN 300:

A: 0%    B: 30%    C: 30%    D: 40%

## STORM WATER QUALITY

EXISTING SITE IS PARTIALLY PAVED AND THE EXISTING PAVED AREAS DISCHARGE INTO THE EXISTING STORM DRAIN WITHOUT WATER QUALITY.

WATER QUALITY REQUIREMENTS TREATING THE PAVED AREAS.

VOLUME = 85,029 SF \* 0.26IN/12 = 1,842 CUBIC FEET

THIS PROJECT ROUTES STORM WATER THROUGH THE PROPOSED LAKE.

## HYDROLOGY

DRAINAGE AREA 1 AREA = 4.88 ac.

DRAINAGE ZONE 3  
PRECIPITATION: 360 = 2.60 in.  
1140 = 3.10 in.  
10day = 4.90 in.

EXCESS PRECIPITATION: PEAK DISCHARGE:

TREATMENT A 0.66 in. 1.87 cfs/ac.  
TREATMENT B 0.92 in. 2.60 cfs/ac.  
TREATMENT C 1.29 in. 3.45 cfs/ac.  
TREATMENT D 2.36 in. 5.02 cfs/ac.

EXISTING CONDITIONS: PROPOSED CONDITIONS:

AREA  
TREATMENT A 0.00 ac. 0.00 ac.  
TREATMENT B 1.46 ac. 1.46 ac.  
TREATMENT C 1.46 ac. 1.46 ac.  
TREATMENT D 1.95 ac. 1.95 ac.

EXISTING EXCESS PRECIPITATION:

Weighted E = ( 0.66 )( 0.00 ) + ( 0.92 )( 1.46 ) + ( 1.29 )( 1.46 ) + ( 2.36 )( 1.95 ) = 4.88 ac.  
= 1.61 in.  
V100-360 = ( 1.61 )( 4.88 ) / 12 = 0.653513 ac-ft = 28467 cft

EXISTING PEAK DISCHARGE:

Q100 = ( 1.87 )( 0.00 ) + ( 2.60 )( 1.46 ) + ( 3.45 )( 1.46 ) + ( 5.02 )( 1.95 ) = 18.66 cfs

PROPOSED EXCESS PRECIPITATION:


Weighted E = ( 0.66 )( 0.00 ) + ( 0.92 )( 1.46 ) + ( 1.29 )( 1.46 ) + ( 2.36 )( 1.95 ) = 4.88 ac.  
= 1.61 in.  
V100-360 = ( 1.61 )( 4.88 ) / 12 = 0.653513 ac-ft = 28467 cft

V100-1440 = ( 0.65 ) + ( 1.95 )( 3.10 - 2.60 ) / 12 = 0.734847 ac-ft = 32010 cft

V100-10day = ( 0.65 ) + ( 1.95 )( 4.90 - 2.60 ) / 12 = 1.027647 ac-ft = 44764 cft

PROPOSED PEAK DISCHARGE:


Q100 = ( 1.87 )( 0.00 ) + ( 2.60 )( 1.46 ) + ( 3.45 )( 1.46 ) + ( 5.02 )( 1.95 ) = 18.66 cfs

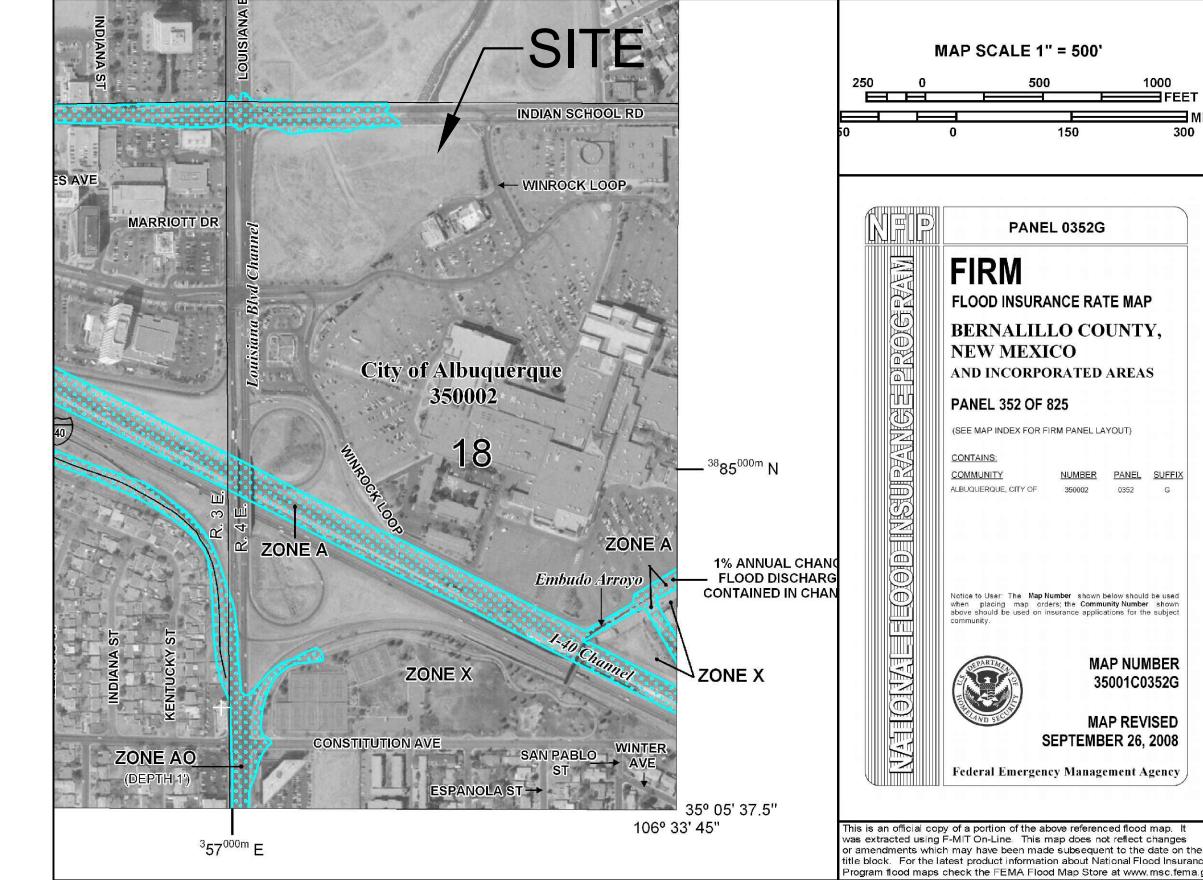


FIRM PANEL 35001C0352G

## LEGEND

- BASIN BOUNDARY
- ← DISCHARGE LOCATION
- ⬤ FLOW DIRECTION
- + + + + ■ LIMITS OF DISTURBANCE

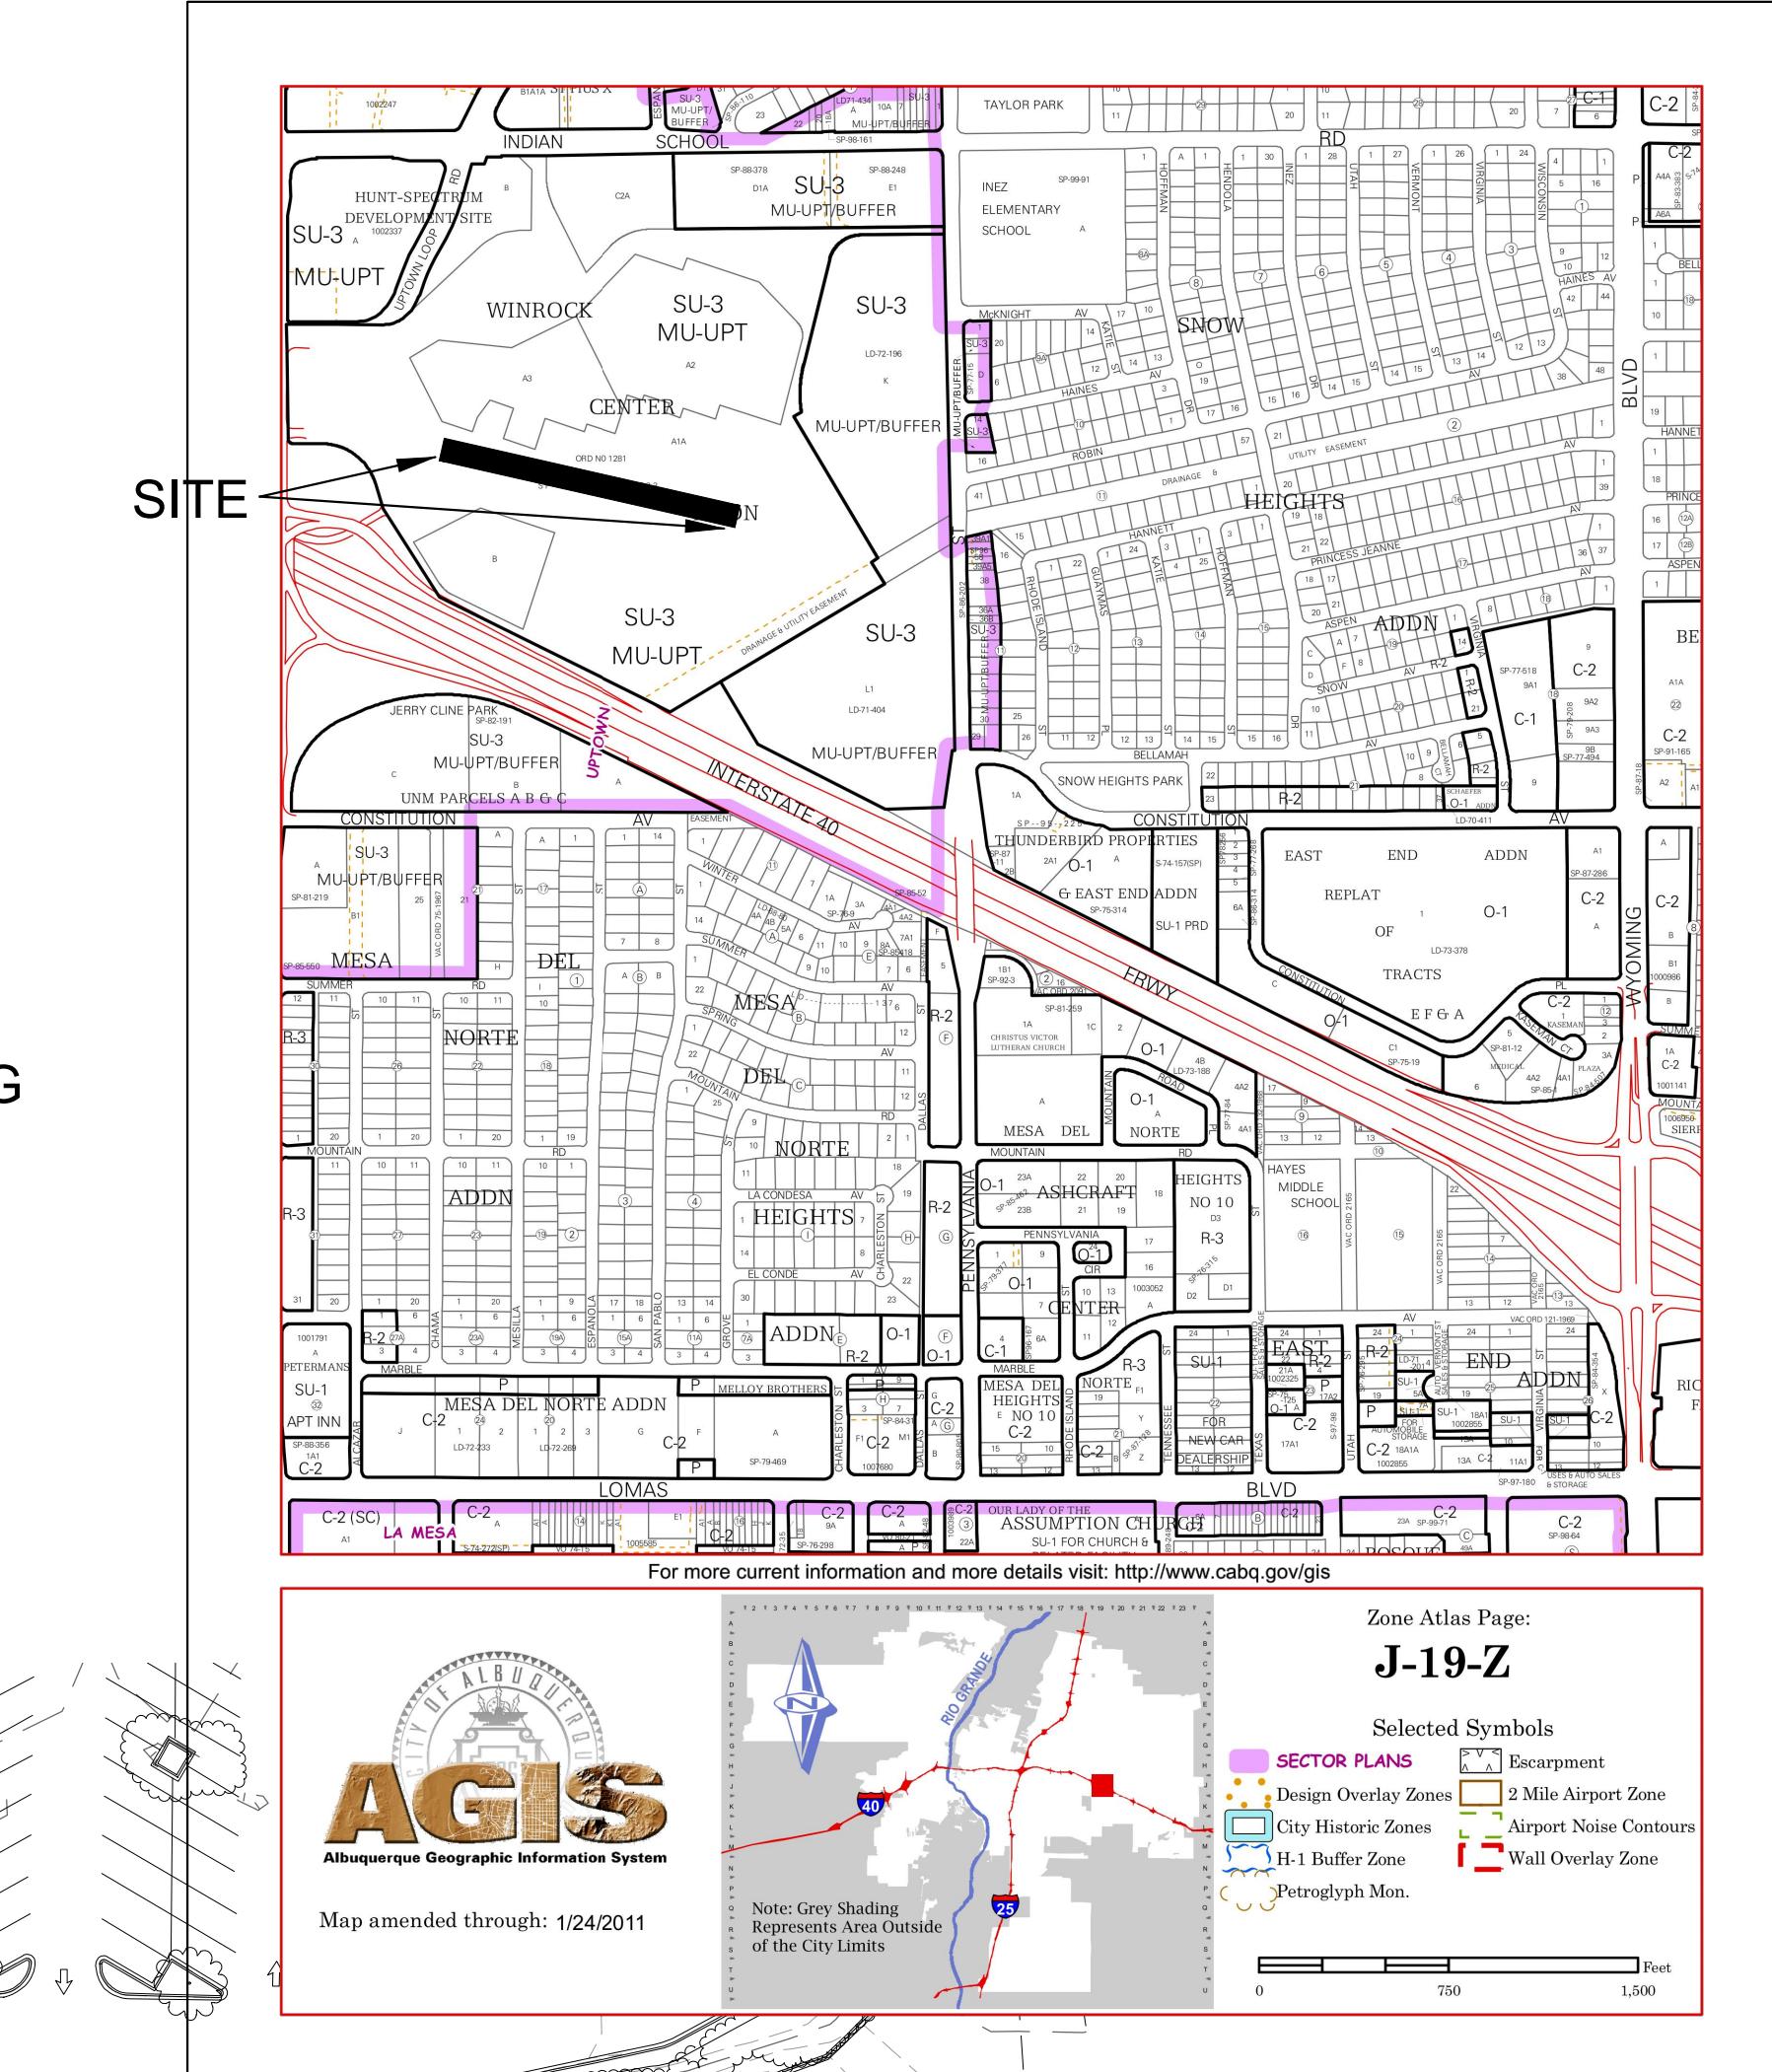

ZONE ATLAS PAGE J-19-Z

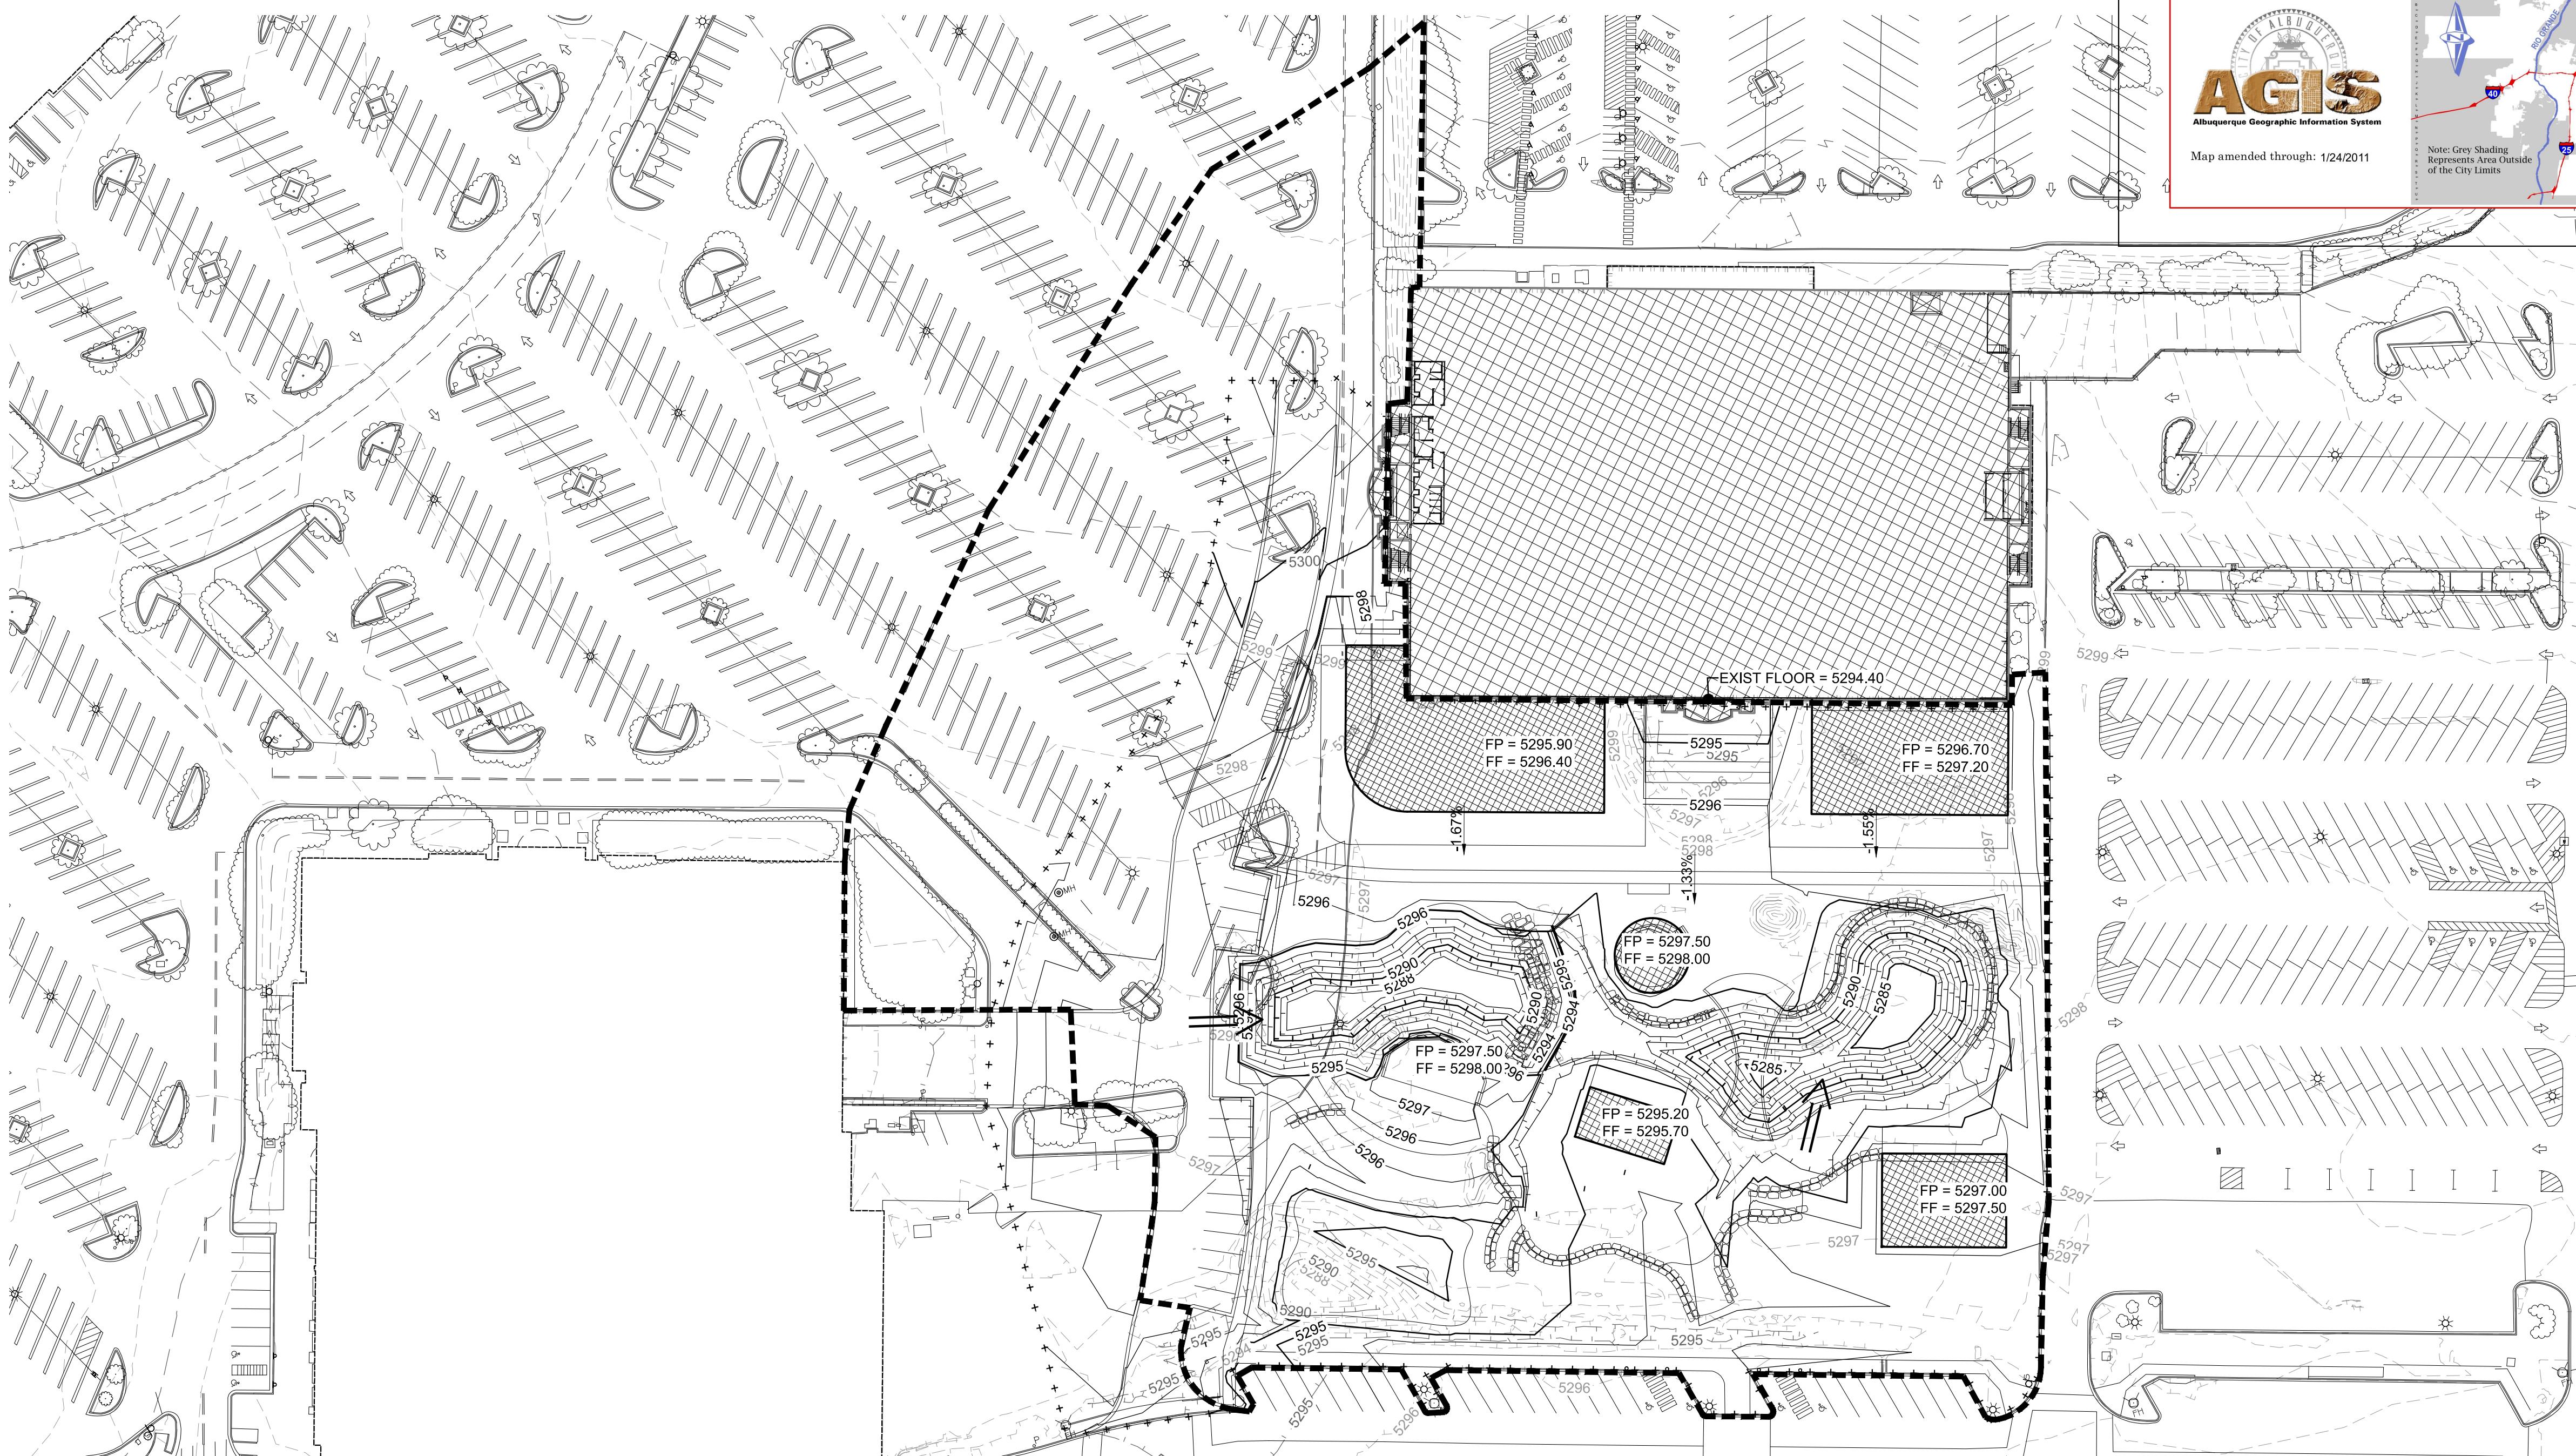

**MODULUS ARCHITECTS**


100 SUN AVE. N.W. SUITE 600  
ALBUQUERQUE, NEW MEXICO 87109  
PHONE (505) 338-1499 FAX (505) 338-1498



3/5/21

PROJECT TITLE	WINROCK TOWN CENTER	JOB NO.	DRAWN BY:
PROJECT MANAGER	2100 LOUISIANA BLVD.	JOB NO.	
SHETLITE	DRAINAGE PLAN		
DATE:	03/05/21	SCALE:	C100
AS NOTED		of	

HUITT-ZOLLARS

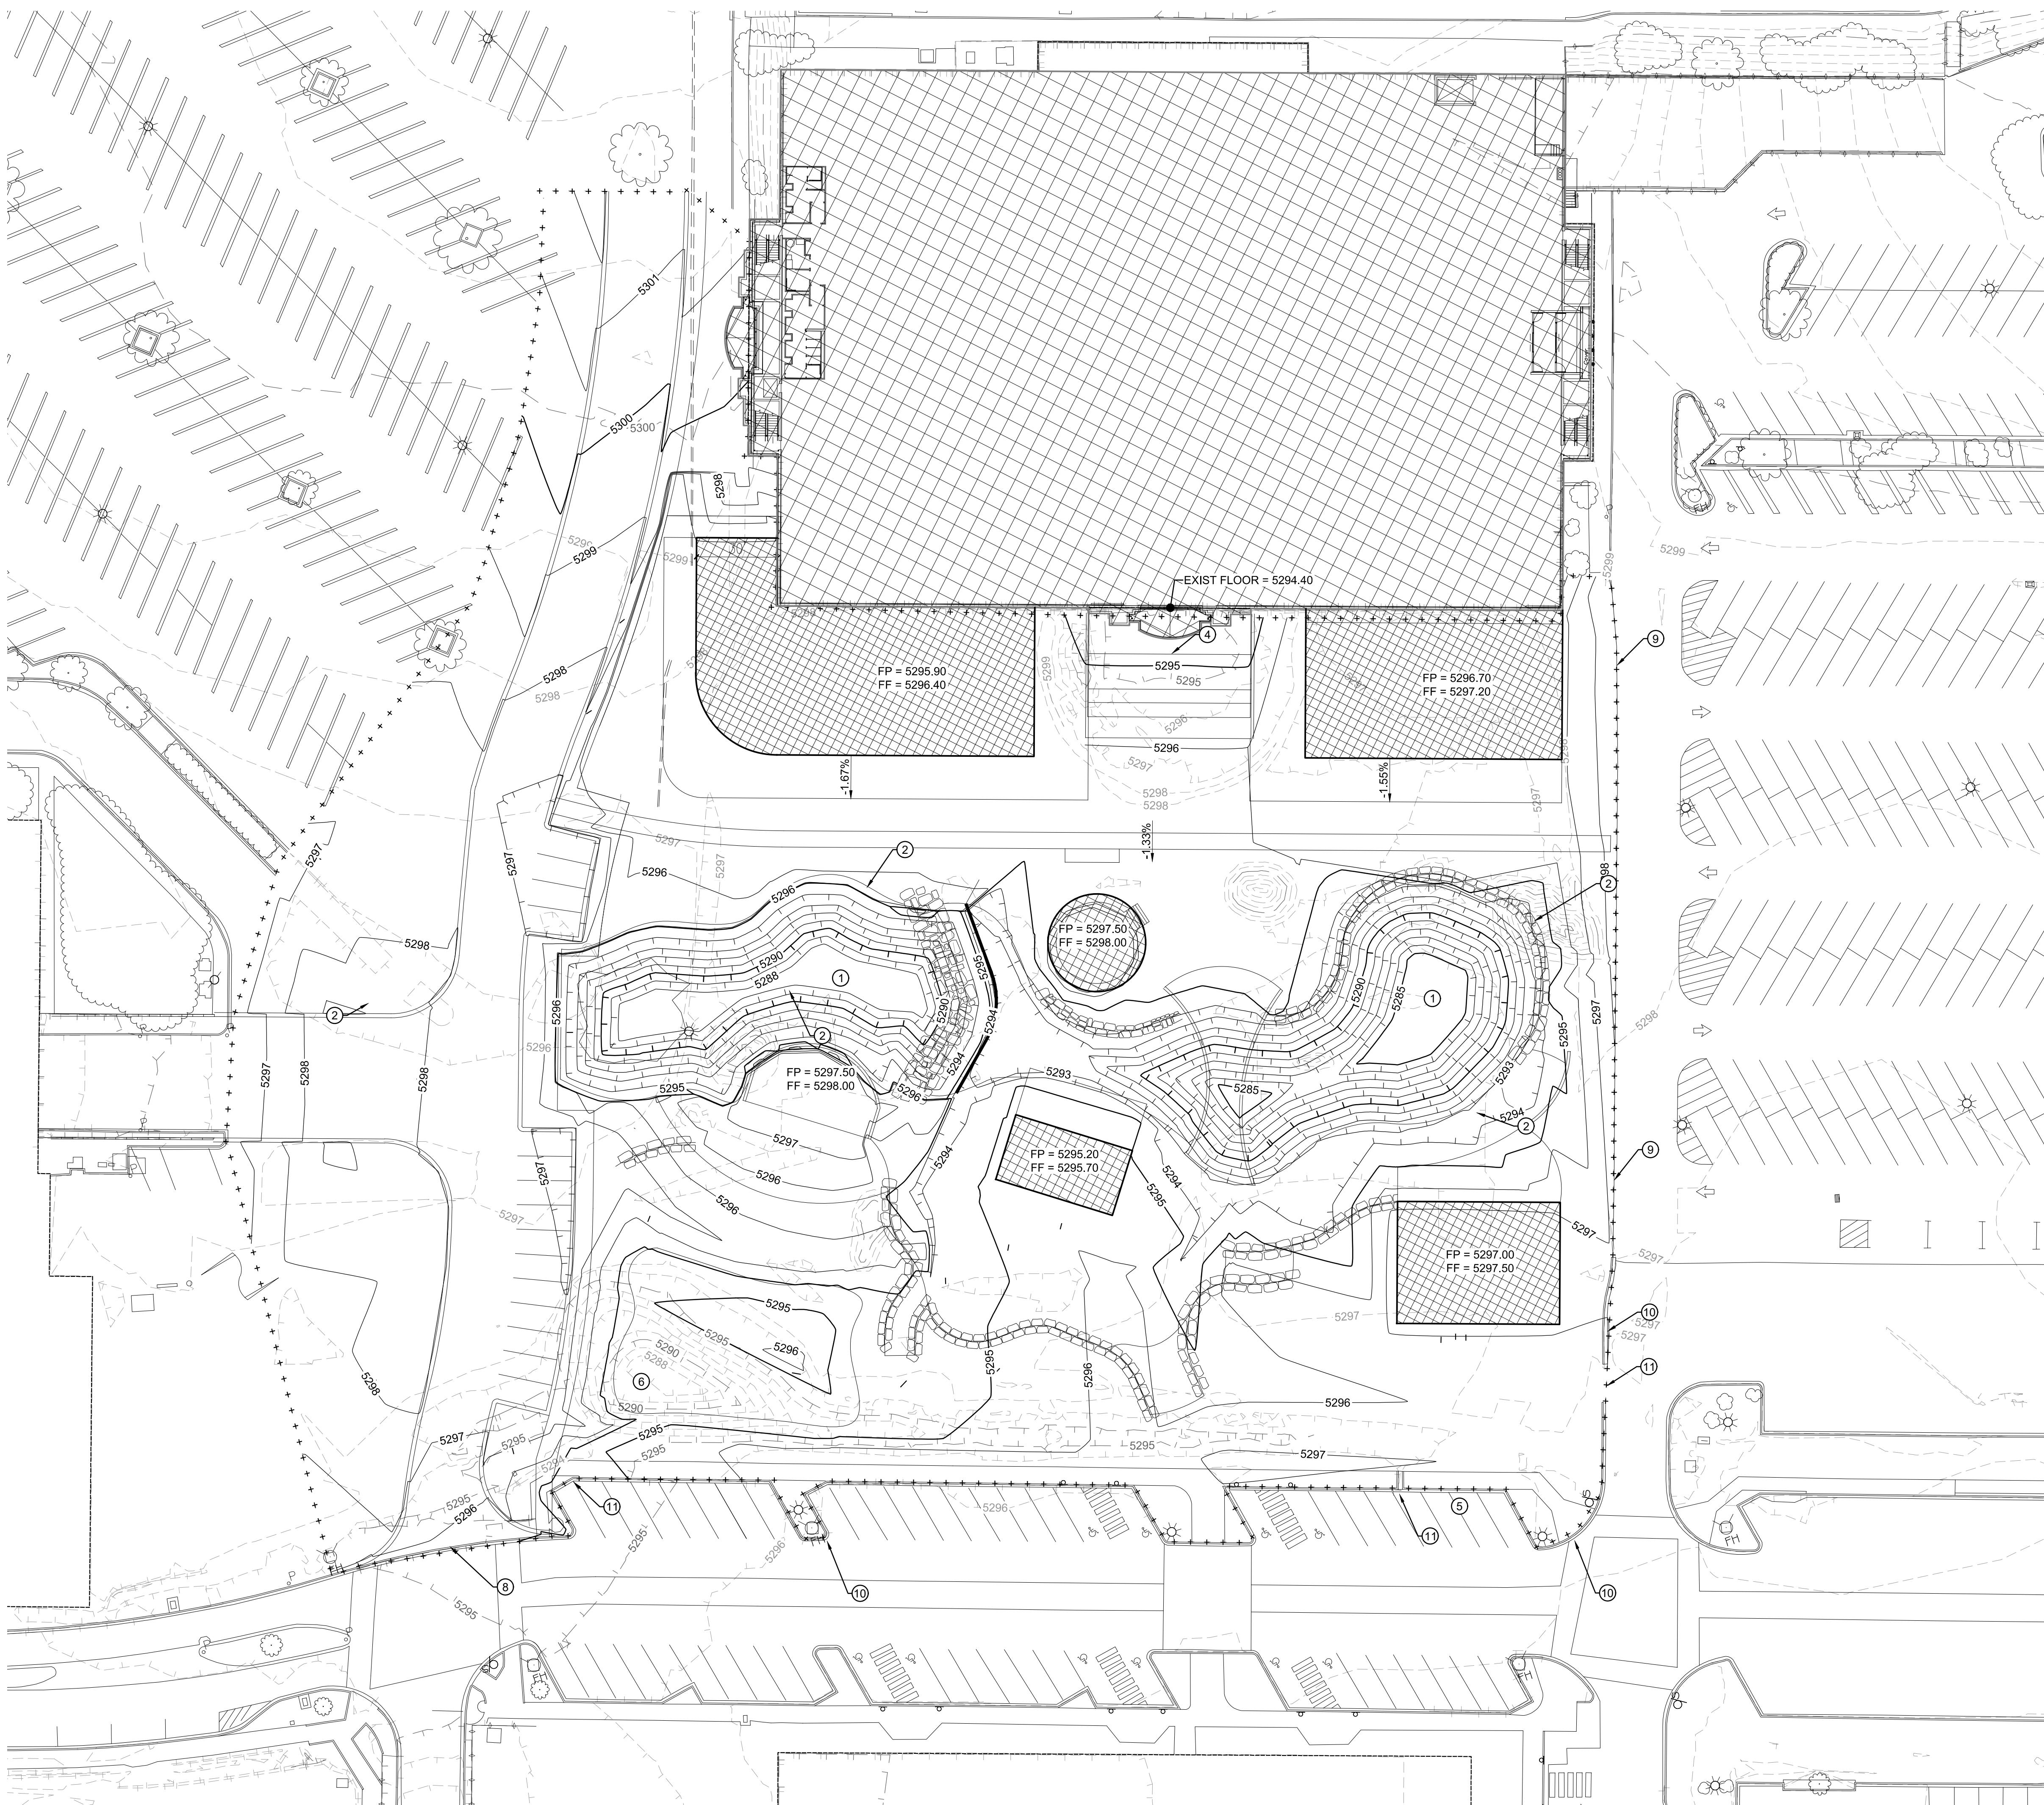

#### CONSTRUCTION NOTES

1. ROUGH CUT LAKE - SEE LAKE PLANS FOR DETAILS
2. EDGE CONDITION- SEE LAKE PLANS
3. BUILDING PAD - OVEREX 4 FEET BELOW FOOTING
4. TRENCH DRAIN AT ENTRY WAY
5. SWALE - DISCHARGE INTO LAKE
6. REMOVE TEMPORARY STORM WATER QUALITY FACILITY
7. LAKE PROVIDES STORM WATER QUALITY FOR WINROCK TOWN CENTER
8. REMOVE EXISTING CURB
9. EXISTING ASPHALT TO REMAIN
10. EXISTING CURB OPENING TO REMAIN
11. EXISTING CURB AND GUTTER TO REMAIN

#### LEGEND

5050	EXISTING (INDEX) CONTOUR
5251	EXISTING (INTERMEDIATE) CONTOUR
5040	PROPOSED (INDEX) CONTOUR
5041	PROPOSED (INTERMEDIATE) CONTOUR
wavy line	WATER BLOCK
solid line	NEW CURB & GUTTER
dashed line	FUTURE CURB & GUTTER
XX.XXTP	TOP OF PAVEMENT
XX.XXTC XX.XXFL	TOP OF CURB ELEVATION FLOW LINE ELEVATION
XX.XXTOC	TOP OF CONCRETE
arrow	FLOW DIRECTION
plus signs	GRADING LIMITS
grey shaded area	SLOPE STABILIZATION

#### GENERAL NOTES



1. ALL DISTURBED COMMERCIAL LOTS AND NON-RESIDENTIAL LOTS AREAS NOT PROPOSED TO BE IMPROVED SHALL BE STRAW CRIMPED W/ NATIVE SEEDING PER COA SPECIFICATION 1011 & 1012.
2. SEE PLAT FOR LOT DIMENSIONS.
3. EARTHWORK SHALL BE PERFORMED IN ACCORDANCE WITH THE GEOTECHNICAL INVESTIGATION FOR THIS PROJECT.
4. CONTRACTOR SHALL PREPARE AND PROCESS DUST CONTROL AND EROSION SEDIMENT CONTROL PLAN THROUGH CITY OF ALBUQUERQUE.
5. THE STORM WATER POLLUTION PREVENTION PLAN SHALL BE MAINTAINED AT ALL TIMES DURING THE CONSTRUCTION PROJECT.

PROJECT TITLE: WINROCK TOWN CENTER  
2100 LOUISIANA BLVD.  
PROJECT MANAGER: DRAWN BY:  
JOB NO.:  
SHEET NUMBER: ROUGH GRADING PLAN

DATE: 03/05/21  
SCALE: AS NOTED  
C101

**MODULUS ARCHITECTS**

100 SUN AVE. N.W. SUITE 600  
ALBUQUERQUE, NEW MEXICO 87109  
PHONE (505) 338-1499 FAX (505) 338-1498

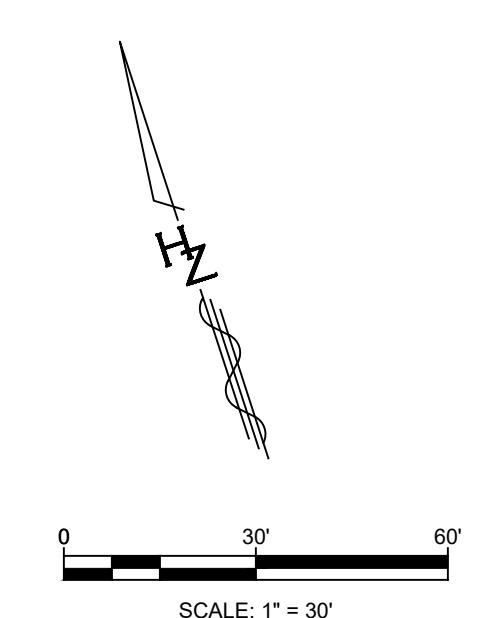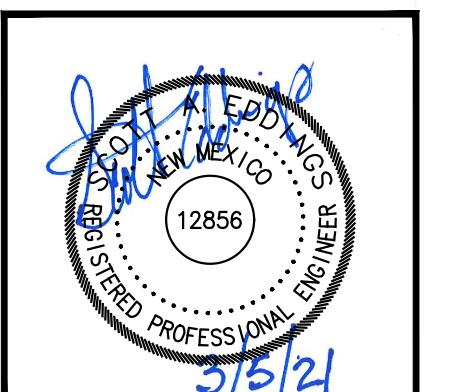

REV	DATE	BY	REVISION
△	△	△	△

HUITT-ZOLLARS