



CPESC CASSANDRA DURKIN No. 9212	
CASSANDRA DURKIN CPESC 9212	

	DRAWN BY: C. DURKIN	CONSTRUCTION ACTIVITIES: NEW CONSTRUCTION	COVER PAGE					
	CHECKED BY:	SCHEDULE: 12 MONTHS FROM START	ESCP	OWNER NAME	MALIK HASAN 919-619-2443 ACCOUNTS@NUVUEPHARMA.COM			
	ORIGINAL DATE: 02/29/2024	AREA OF DISTURBANCE: 1.25 ACRES	PROJECT SIZE: 1.25 ACRES	OPERATOR NAME	HARRISON BUILDING 949-278-1727 HARRISONBUILDINGINC@HOTMAIL.COM			
N	REVISED BY: C. DURKIN	AFTER HOURS CONTACT: PATRICK AUDENIS 949-278-1727	MAP DATUM: GOOGLE EARTH AND CITY OF ABQ	PROJECT NAME	1171 JAFFA RD NE	FIGURE:		
IV	REVISED DATE: 03/05/2024	OTHER:	DATA APPROXIMATE FOR ILLUSTRATIVE PURPOSES ONLY	COORDINATES	13S 358743.95 m E, 3884252.86 m N	1		



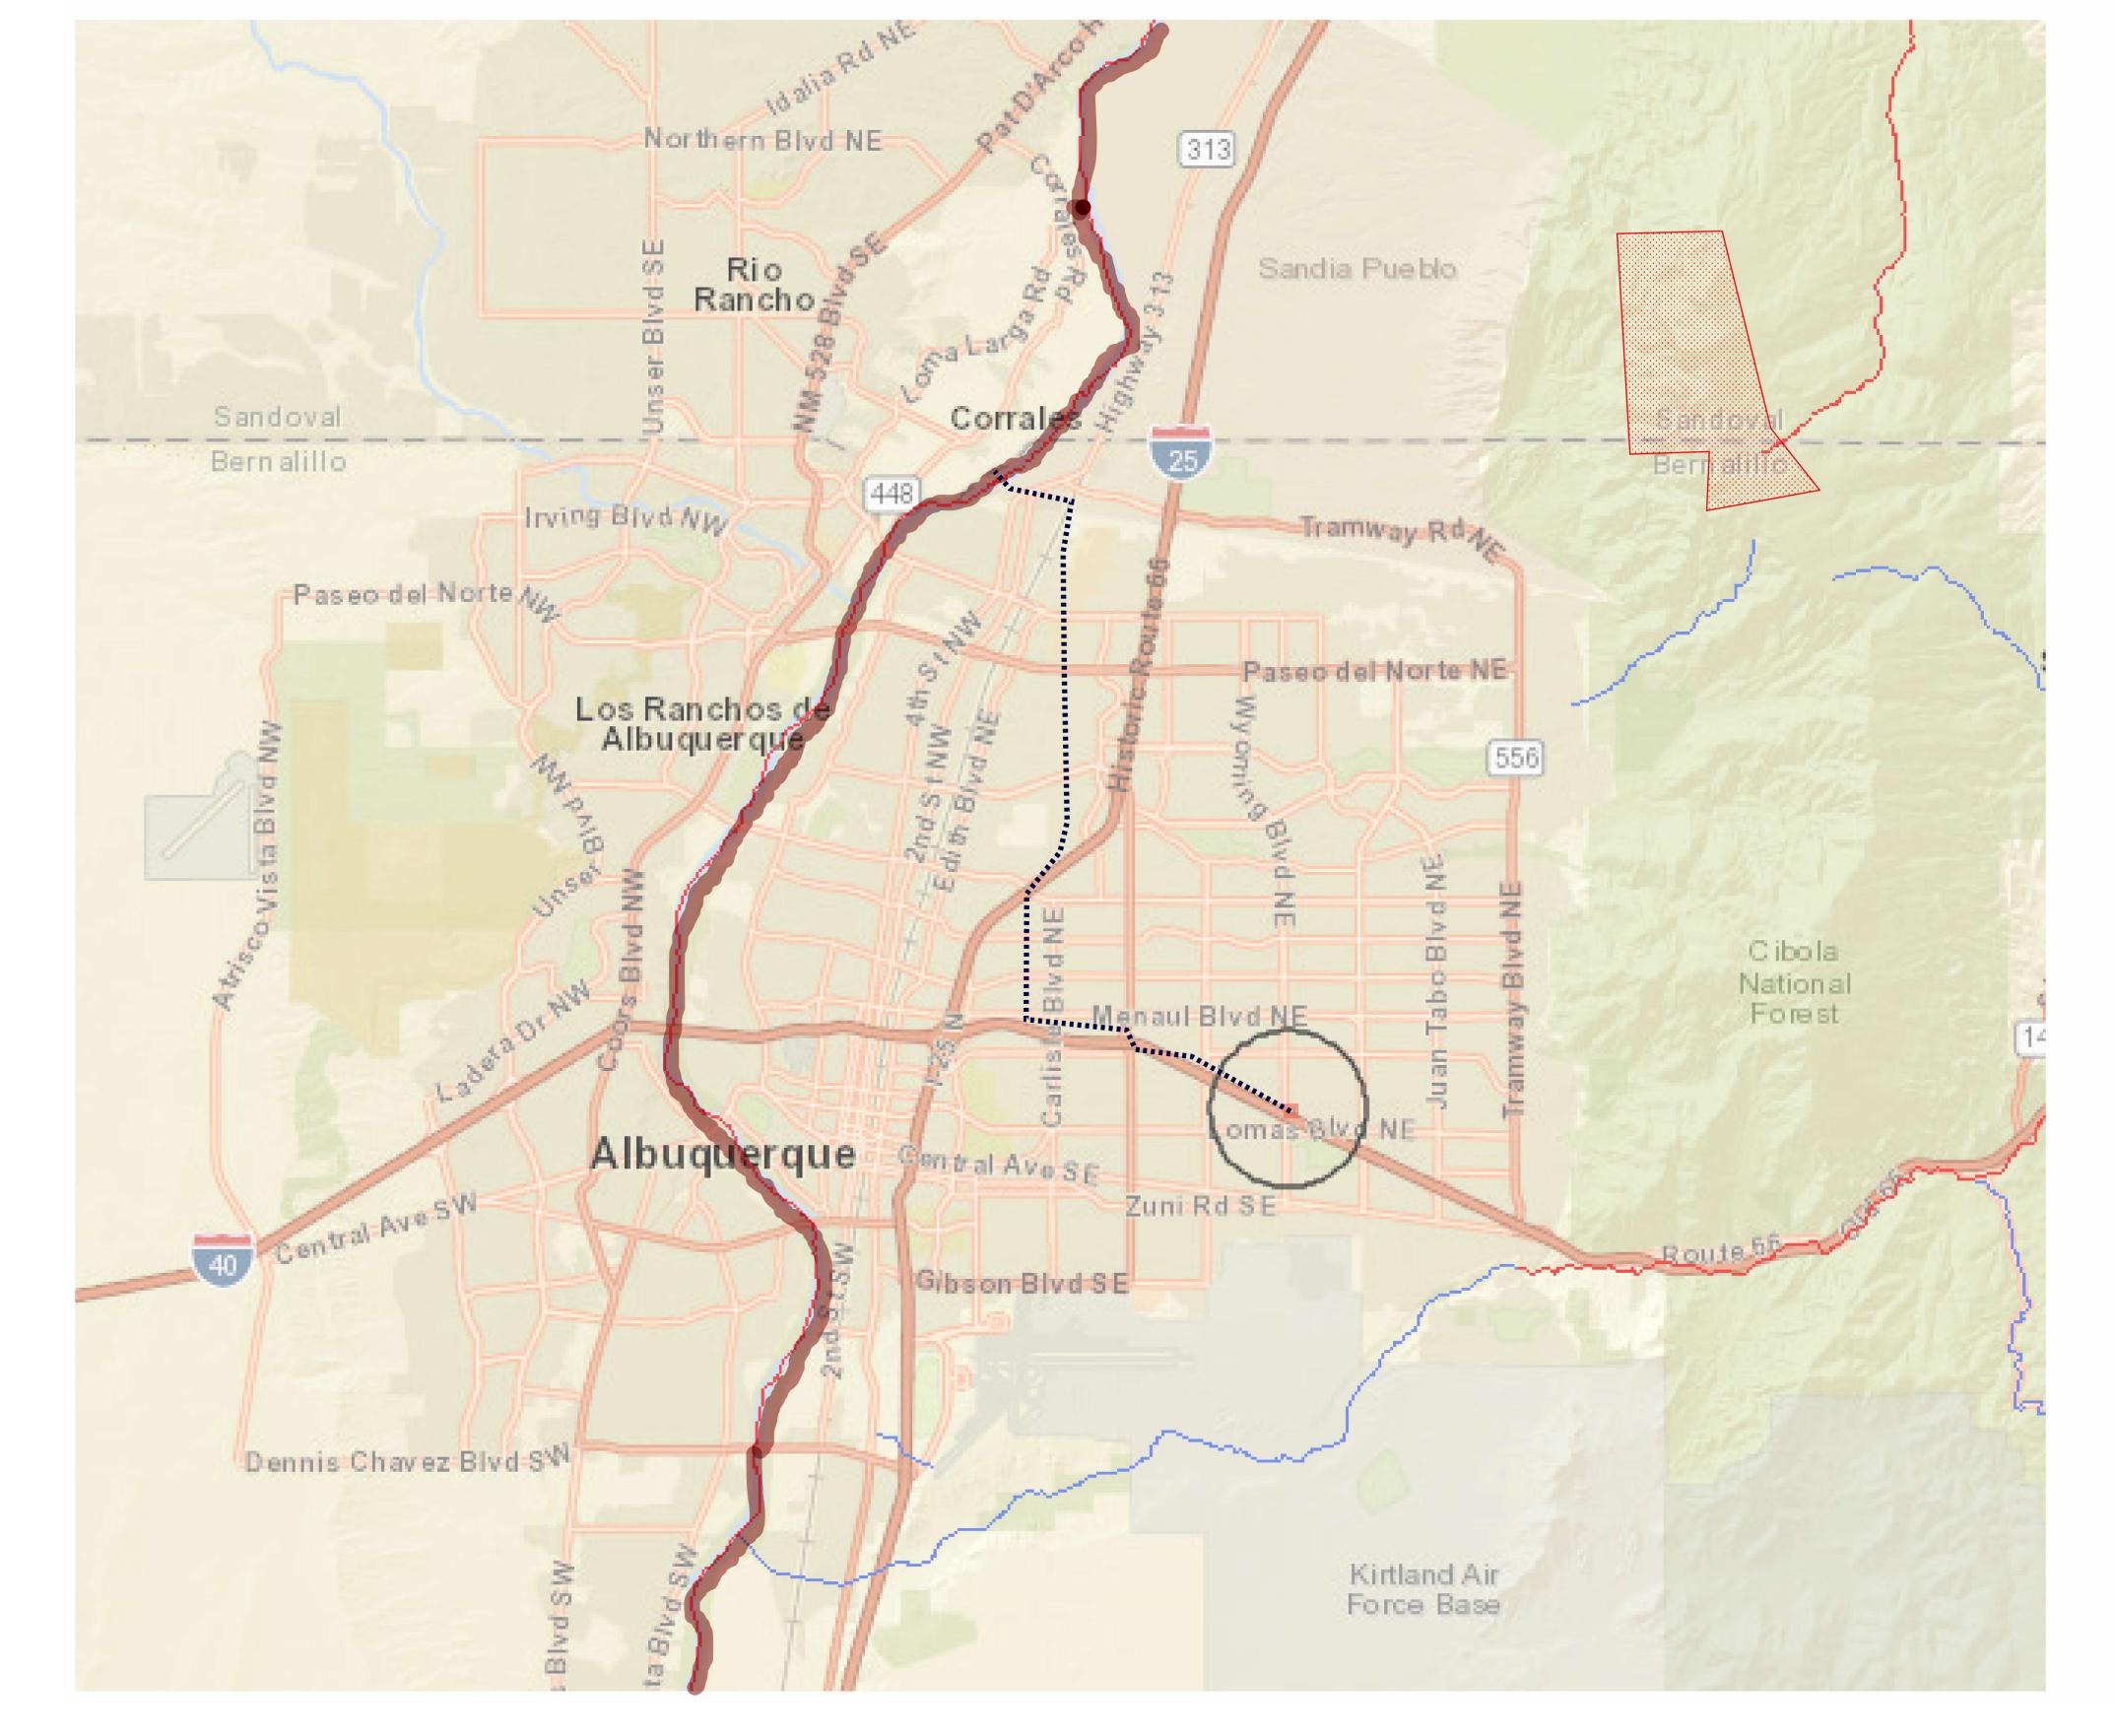

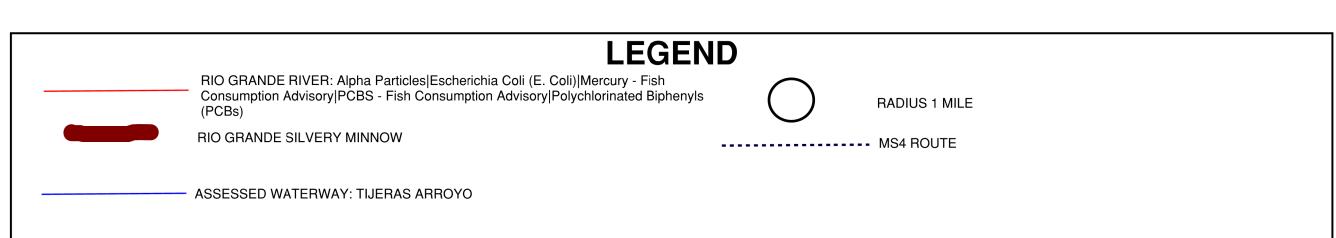

	DRAWN BY: C. DURKIN	CONSTRUCTION ACTIVITIES: NEW CONSTRUCTION	VICINITY MAP OF IMPAIRED WATERS AND ENDANGERED SPECIES				
	CHECKED BY:	SCHEDULE: 12 MONTHS FROM START	ESCP	OWNER NAME	MALIK HASAN 919-619-2443 ACCOUNTS@NUVUEPHARMA.COM		
	ORIGINAL DATE: 02/29/2024	AREA OF DISTURBANCE: 1.25 ACRES	PROJECT SIZE: 1.25 ACRES	OPERATOR NAME	HARRISON BUILDING 949-278-1727 HARRISONBUILDINGINC@HOTMAIL.COM		
N	REVISED BY: C. DURKIN	AFTER HOURS CONTACT: PATRICK AUDENIS 949-278-1727	MAP DATUM: GOOGLE EARTH AND CITY OF ABQ	PROJECT NAME	1171 JAFFA RD NE	FIGURE:	
N	REVISED DATE: 03/05/2024	OTHER:	DATA APPROXIMATE FOR ILLUSTRATIVE PURPOSES ONLY	COORDINATES	13S 358743.95 m E, 3884252.86 m N	2	

PROJECT INPUTS

PROJECT OWNER:

MALIK HASAN - NOI NMR10069N

PHONE NUMBER:

919-619-2443

EMAIL:

ACCOUNTS@NUVUEPHARMA.COM

PROJECT OPERATOR:

HARRISON BUILDING

PHONE NUMBER:

949-278-9909

EMAIL:

HARRISONBUILDINGINC@HOTMAIL.COM

Project/Site Information Project/Site Name: 1171 Jaffa Rd NE

Address Line 2:

Address Line 1: 1171 Jaffa Rd NE

ZIP/Postal Code: 87112

County or Similar Division: Bernalillo

Latitude/Longitude: 35.091147°N, 106.549782°W

Latitude/Longitude Data Source: Map

Project End Date: 11/29/2024 Estimated Area to be Disturbed: 1.25

Horizontal Reference Datum: WGS 84

City: Albuquerque

Project Start Date: 02/01/2024

Will there be demolition of any structure built or renovated before January 1, 1980? No

Will you be discharging dewatering water from your site? No

Was the pre-development land use used for agriculture? No

Have earth-disturbing activities commenced on your project/site? Yes

→ Is your project an "emergency-related project"? No

Is your project/site located on federally recognized Indian Country lands? No

Is your project/site located on a property of religious or cultural significance to an Indian tribe? No

Bernalillo County and Pa	arts of S	Sandoval	and Valer	ncia Counti	es, New	Mexico	Ĭ.										@
Map symbol and soil	Pct.	ct. Slope	USLE	Runoff	E	WEI	WEG	Erosion	Drainage		Hydrologic			Surface	e		
name	of RV map unit	Slope Length ft.		Factor					LCC	Group	Depths in.	Kf Factor	Frag- ments RV	Sand RV	Silt RV	Clay RV	
etC—Embudo-Tijeras complex, 0 to 9 percent slopes																	
Embudo	50	3.0	160	Very low	3	56	5	(= 6	Well drained	7e	А	0 - 3	.24	25	68	21	10
Tijeras	35	5.0	160	Medium	5	56	5	4 7.5 3	Well drained	7c	В	0 - 3	.28	22	70	16	12


CITY OF ALBUQUERUQE STANDARD NOTES


ESC Plan Standard Notes (2023-06-16)

- 1. All Erosion and Sediment Control (ESC) work on these plans, except as otherwise stated or provided hereon shall be permitted, constructed, inspected, and maintained in accordance with:
 - a. The City Ordinance § 14-5-2-11, the ESC Ordinance,
 - b. The EPA's 2022 Construction General Permit (CGP), and
 - c. The City Of Albuquerque Construction BMP Manual.
- 2. All BMP's must be installed prior to beginning any earth moving activities except as specified hereon in the Phasing Plan. Construction of earthen BMP's such as sediment traps, sediment basins, and diversion berms shall be completed and inspected prior to any other construction or earthwork. Self-inspection is required after installation of the BMPs and prior to beginning construction.
- 3. Self-inspections In accordance with City Ordinance § 14-5-2-11(C)(1), "at a minimum a routine self-inspection is required to review the project for compliance with the Construction General Permit once every 14 days and after any precipitation event of 1/4 inch or greater until the site construction has been completed and the site determined as stabilized by the city. Reports of these inspections shall be kept by the person or entity authorized to direct the construction activities on the site and made available upon request.
- 4. Corrective action reports must be kept by the person or entity authorized to direct the construction activities on the site and made available upon request.
- 5. Final Stabilization and Notice of Termination (NOT) In accordance with City Ordinance § 14-5-2-11(C)(1), self-inspections must continue until the site is "determined as stabilized by the city." The property owner/operator is responsible for determining when the "Conditions for Terminating CGP Coverage" per CGP Part 8.2 are satisfied and then for filing their Notice of Termination (NOT) with the EPA. Each operator may terminate CGP coverage only if one or more of the conditions in Part 8.2.1, 8.2.2, or 8.2.3 has occurred. After filing the NOT with the EPA, the property owner is responsible for requesting a Determination of Stabilization from the City.
- 6. When doing work in the City right-of-way (e.g. sidewalk, drive pads, utilities, etc.) prevent dirt from getting into the street. If dirt is present in the street, the street should be swept daily or prior to a rain event or contractor induced water event (e.g. curb cut or water test).
- 7. When installing utilities behind the curb, the excavated dirt should not be placed in the street.
- 8. When cutting the street for utilities the dirt shall be placed on the uphill side of the street cut and the area swept after the work is complete. A wattle or mulch sock may be placed at the toe of the excavated dirt pile if site constraints do not allow placing the excavated dirt on the uphill side of the street cut.
- 9. ESC Plans must show longitudinal street slope and street names. On streets where the longitudinal slope is steeper than 2.5%, wattles/mulch socks or j-hood silt fence shall be shown in the front yard swale or on the side of the street.

CPESC CASSANDRA DURKIN NO. 9212
CASSANDRA DURKIN CPESC 9212

	DRAWN BY: C. DURKIN CONSTRUCTION ACTIVITIES: NEW CONSTRUCTION				PROJECT INPUTS AND NOTES		
	CHECKED BY:	SCHEDULE: 12 MONTHS FROM START	ESCP OWNER NAME MALIK HASAN 919-619-2443 , ACCOUNTS@		MALIK HASAN 919-619-2443 , ACCOUNTS@NUVUEPHARMA.COM		
C N	ORIGINAL DATE: 02/29/2024	AREA OF DISTURBANCE: 1.25 ACRES	PROJECT SIZE: 1.25 ACRES	OPERATOR NAME	HARRISON BUILDING 949-278-1727 HARRISONBUILDINGINC@HOTMAIL.COM		
	REVISED BY: C. DURKIN	AFTER HOURS CONTACT: PATRICK AUDENIS 949-278-1727	MAP DATUM: GOOGLE EARTH AND CITY OF ABQ	PROJECT NAME	1171 JAFFA RD NE	FIGURE:	
	REVISED DATE: 03/05/2024	OTHER:	DATA APPROXIMATE FOR ILLUSTRATIVE PURPOSES ONLY	COORDINATES	13S 358743.95 m E, 3884252.86 m N	3	

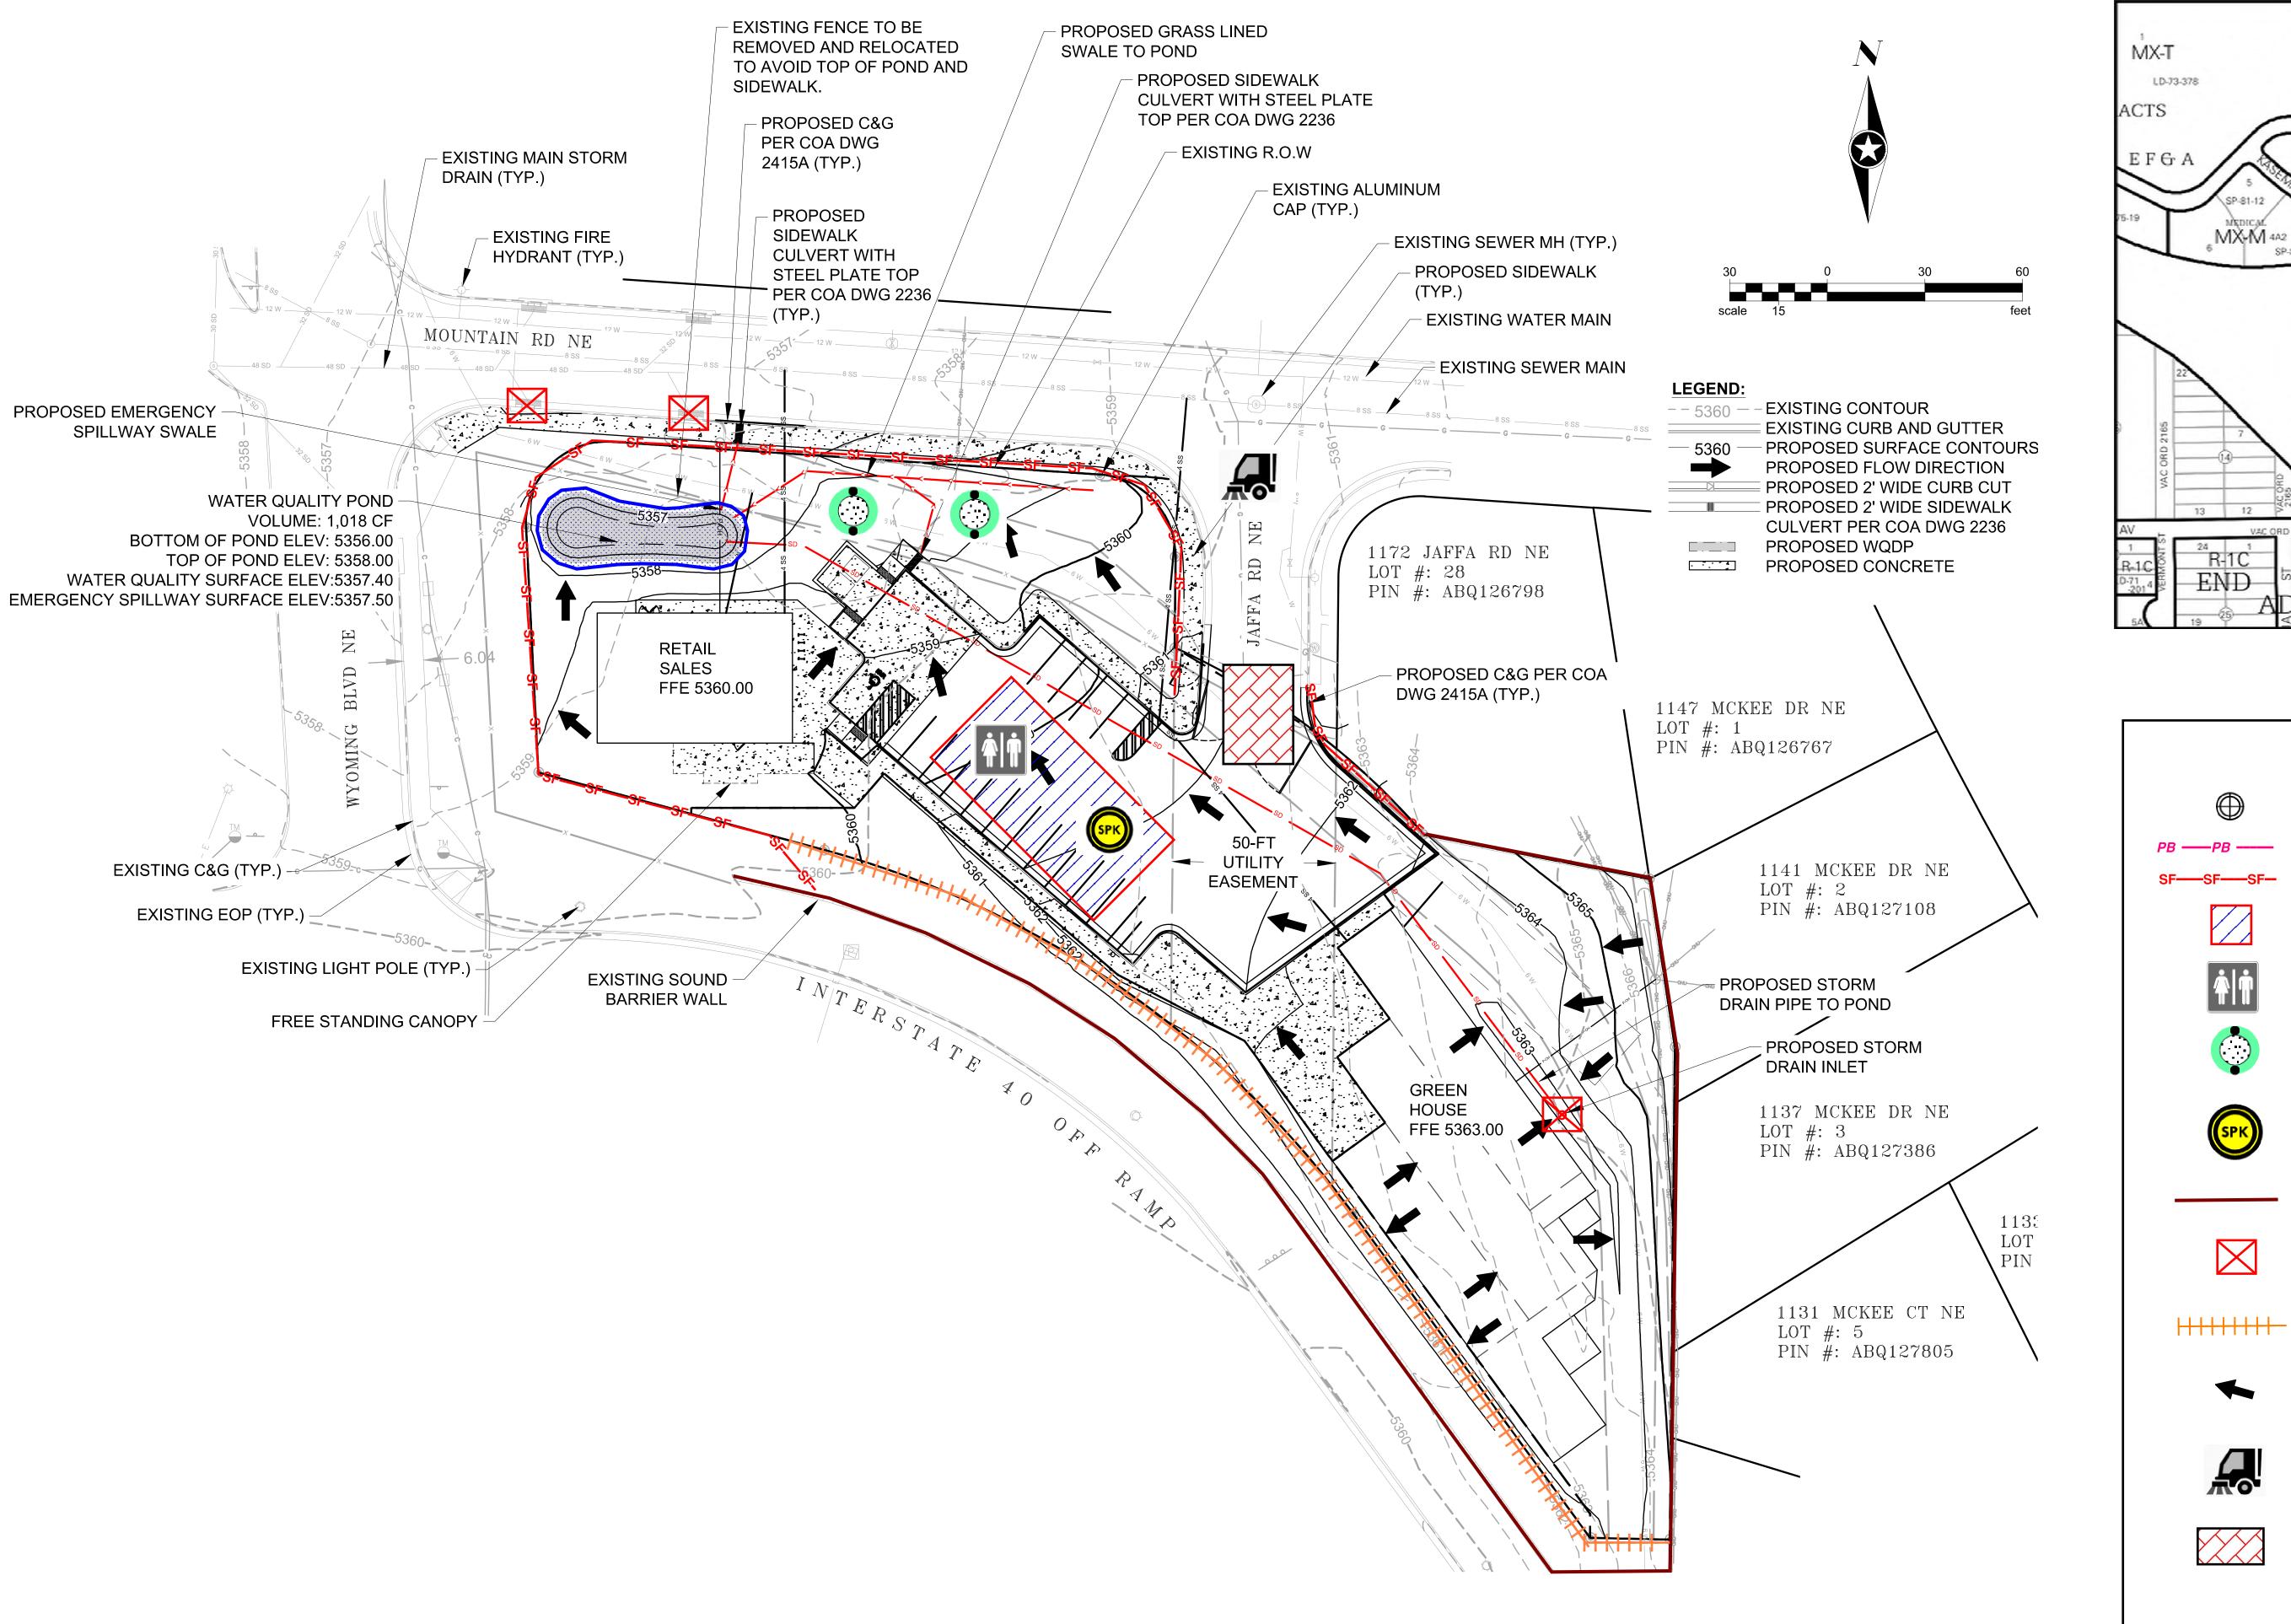

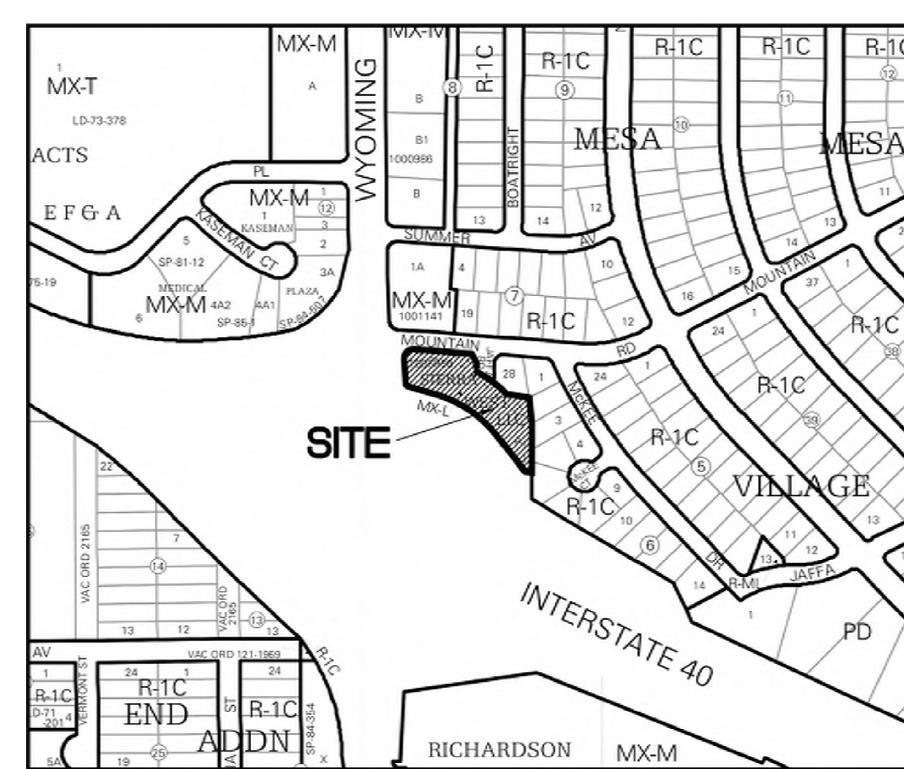

VICINITY MAP

	LEGEND
	UTM LOCATOR 13S 358743.95 m E, 3884252.86 m N PERIMITER BOUNDARY SILT FENCE
	STAGING AREA
* †	PORTABLE TOILET
	TEMPORARY STOCKPILE
SPK	SPILL KIT
	EXISITING WALL
	INLET PROTECTION
 	WEIGHTED MULCH SOCK
	FLOW DIRECTION
	STREET SWEEPING AS NEEDED
	STABILIZED ASPHALT ENTRANCE



	DRAWN BY: C. DURKIN	CONSTRUCTION ACTIVITIES: NEW CONSTRUCTION	WATER POLLUTION CONTROL DRAWING				
	CHECKED BY:	SCHEDULE: 12 MONTHS FROM START	ESCP	OWNER NAME	MALIK HASAN 919-619-2443 ACCOUNTS@NUVUEPHARMA.COM		
	ORIGINAL DATE: 02/29/2024	AREA OF DISTURBANCE: 1.25 ACRES	PROJECT SIZE: 1.25 ACRES	OPERATOR NAME	HARRISON BUILDING 949-278-1727 HARRISONBUILDINGINC@HOTMAIL.COM		
<u> </u>	REVISED BY: C. DURKIN	AFTER HOURS CONTACT: PATRICK AUDENIS 949-278-1727	MAP DATUM: GOOGLE EARTH AND CITY OF ABQ	PROJECT NAME	1171 JAFFA RD NE	FIGURE:	
V	REVISED DATE: 03/05/2024	OTHER:	DATA APPROXIMATE FOR ILLUSTRATIVE PURPOSES ONLY	COORDINATES	13S 358743.95 m E, 3884252.86 m N	 4	


SILT FENCE




BMP Objectives

- Sediment Control
- Sheet Flow Runoff Control
- Wind Erosion Control

Stabilized Construction Entrance

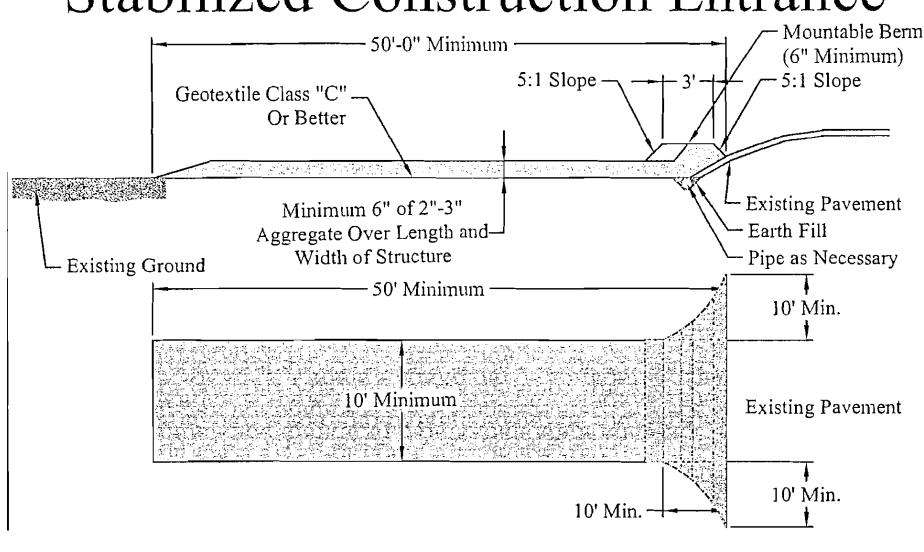

MULCH SOCK/STRAW WATTLE

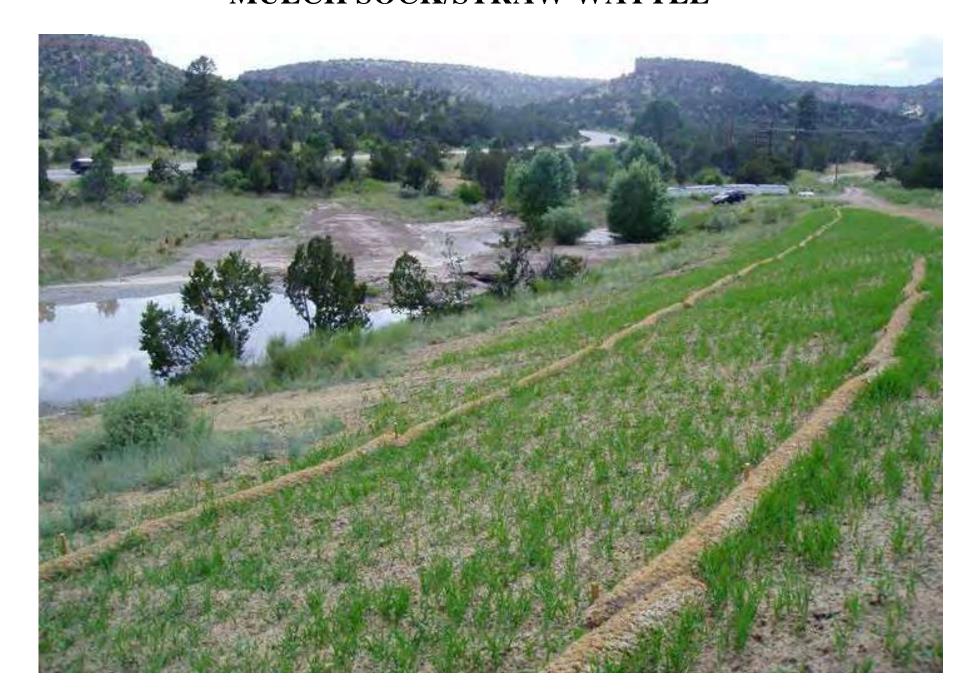

BMP Objectives

- Sediment Control
- Reduce Runoff Velocity
- Inlet Protection

CONSTRUCTION STAGING

- 1: BMPs and Stormwater Pond
- 2: Infrastructure
- 3: Concrete Work and Structures
- 4: Landscaping
- 5: Final Stabilization

INLET PROTECTION









BMP Objectives

- Sediment Control
- Sheet Flow Runoff Control
- Wind Erosion Control

E CPESC O CASSANDRA DURKIN No. 9212
CASSANDRA DURKIN CPESC 9212

	DRAWN BY: C. DURKIN	CONSTRUCTION ACTIVITIES: NEW CONSTRUCTION	CONSTRUCTION STAGING AND EROSION & SEDIMENT CONTROLS					
	CHECKED BY:	SCHEDULE: 12 MONTHS FROM START	ESCP OWNER NAME MA		MALIK HASAN 919-619-2443 ACCOUNTS@NUVUEPHARMA.COM			
	ORIGINAL DATE: 02/29/2024	AREA OF DISTURBANCE: 1.25 ACRES	PROJECT SIZE: 1.25 ACRES	OPERATOR NAME	HARRISON BUILDING 949-278-1727 HARRISONBUILDINGINC@HOTMAIL.COM			
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N	REVISED DATE: 03/05/2024	OTHER:	DATA APPROXIMATE FOR ILLUSTRATIVE PURPOSES ONLY	COORDINATES	13S 358743.95 m E, 3884252.86 m N	5		

SITE DATA

GROSS LOT AREA 48,999 SF **BUILDING AREA** 2,400 SF 46,599 SF NET LOT AREA (NET.)

LANDSCAPE AREA (LAN.)

REQUIRED 6,990 SF (15% OF NET.) 30,732 SF (66% OF NET.) PROPOSED **VEGETATION COVERAGE (VEG.)**

5,243 SF (75% OF LAN.) REQUIRED 24,139 SF (345% OF LAN.) PROPOSED

GROUND-LEVEL PLANTS COVERAGE REQUIRED 1,311 SF (25% OF VEG.) PROPOSED 1,775 SF (34% OF VEG.)

STREET TREES (1 PER 25 LF)

REQUIRED

PROPOSED PARKING LOT TREES

(1 PER 10 PARKING SPACES) REQUIRED PROPOSED

REQUIRED 13 TREES 34 TREES PROPOSED

1. MAINTENANCE OF THE LANDSCAPE AND IRRIGATION PROVIDED BY THE PROPERTY OWNER. 2. THE LANDSCAPE PLAN IS DESIGNED TO MEET ALL CITY OF ALBUQUERQUE, AND IDO

REQUIREMENTS. 3. PLANT MATERIALS AND SIGNING WILL NOT INTERFERE WITH CLEAR SIGHT REQUIREMENTS. THEREFORE SIGNS, WALLS, TREES, AND SHRUBBERY BETWEEN 3 AND 8 FEET TALL (AS MEASURED FROM THE GUTTER PAN) ARE NOT ACCEPTABLE IN 'CLEAR SIGHT' AREAS.

4. THE LANDSCAPE PLAN IS DESIGNED TO COMPLY WITH THE GENERAL IDO LANDSCAPING REGULATIONS(section 14-16-5-6) INCLUDING PROVISION OF A MINIMUM OF 75% LIVE GROUND COVERAGE, MEASURED AT MATURITY, OF ALL REQUIRED LANDSCAPE AREAS, AND A MINIMUM OF 25% REQUIRED VEGETATIVE COVERAGE OF GROUND LEVEL PLANTS.

1. ALL PLANTINGS WILL BE UNDER WARRANTY BY CONTRACTOR FOR 1 YEAR.

2. THE LANDSCAPE DESIGN SHALL COMPLY WITH THE CITY OF ALBUQUERQUE WASTE WATER CONSERVATION, LANDSCAPE, IDO, AND WATER WASTE ORDINANCE.

3. THERE IS NO NEW TURF USED IN THE DESIGN OF THE LANDSCAPE. 4. THE R.O.W. (WHEN DEDICATED TO THE PUBLIC) SHALL BE MAINTAINED BY THE PROPERTY OWNER.

THE PLAN SHALL FOLLOW THE COA DESIGN GUIDELINES FOR STREET TREES UNLESS OBSTRUCTED BY UTILITY EASEMENTS. 5. ALL LANDSCAPE AREAS SHALL BE COVERED WITH MULCH. USE GRAVEL MULCH AT 3" DEPTH OVER

6. WHERE MULCH IS ADJACENT TO THE CONCRETE, FINISH GRADE OF MULCH SHALL BE

APPROXIMATELY 1/2" BELOW THE TOP OF CONCRETE. 7. PLANTINGS IN CLEAR SIGHT TRIANGLE NOT TO OBSTRUCT LINE OF VISION FROM 3' HEIGHT TO 8'

PLANT SCHEDULE


	PLANT SCH	=DU	LE .			
	DECIDUOUS TREES	<u>QTY</u>	BOTANICAL / COMMON NAME	SIZE	<u>H X W</u>	COVERAGE
		3	CHILOPSIS LINEARIS / DESERT WILLOW	25 GAL	20` X 25`	491
	•	6	FORESTIERA NEOMEXICANA / NEW MEXICAN PRIVET	24"BOX	15` X 15`	177
		3	FRAXINUS AMERICANA `AUTUMN PURPLE` / AUTUMN PURPLE ASH	2" B&B	45` X 30`	707
		5	PISTACIA CHINENSIS / CHINESE PISTACHE	2" B&B	60, X 60,	2826
		3	PYRUS CALLERYANA `CLEVELAND SELECT` / CLEVELAND SELECT PEAR	2" B&B	25` X 15`	177
_		3	VITEX AGNUS-CASTUS / CHASTE TREE	24"BOX	20` X 20`	314
	EVERGREEN TREES	QTY	BOTANICAL / COMMON NAME	SIZE	<u>H X W</u>	COVERAGE
)	A CATY LONG OF THE WANTER WANT	8	JUNIPERUS MONOSPERMA / ONESEED JUNIPER	15 GAL	20` X 10`	79
	O WINDLE STATE OF THE STATE OF	2	PINUS ELDARICA / AFGHAN PINE	6`	40` X 25` SUBTOTAL	491 22,364 SF
	DECIDUOUS SHRUBS	QTY	BOTANICAL / COMMON NAME	SIZE	<u>H X W</u>	COVERAGE
		6	CHAMAEBATIARIA MILLEFOLIUM `FERNBUSH` / FERNBUSH	5 GAL	5` X 6`	28
	+	14	SALVIA GREGGII / AUTUMN SAGE CHERRY	5 GAL	2` X 3`	7
	DESERT ACCENTS	QTY	BOTANICAL / COMMON NAME	SIZE	<u>H X W</u>	COVERAGE
	(*)	18	HESPERALOE PARVIFLORA / RED YUCCA	5 GAL	3` X 4`	13
	EVERGREEN SHRUBS	QTY	BOTANICAL / COMMON NAME	SIZE	<u>H X W</u>	COVERAGE
		19	ARTEMISIA FILIFOLIA / SAND SAGEBRUSH	5 GAL	4` X 4`	13
	Samorough of Samor	15	CERCOCARPUS INTRICATUS / LITTLE LEAF MOUNTAIN MAHOGONY	5 GAL	6, X 6,	28
	o o	6	ERICAMERIA LARICIFOLIA / TURPENTINE BUSH	5 GAL	3` X 4`	13
		13	FALLUGIA PARADOXA / APACHE PLUME	5 GAL	6` X 7`	38
	FLOWERING PLANTS	QTY	BOTANICAL / COMMON NAME	SIZE	<u>H X W</u>	COVERAGE
		6	ACHILLEA X `MOONSHINE` / MOONSHINE YARROW	1 GAL	2` X 2`	3
		6	NEPETA X FAASSENII `SELECT BLUE` / CATMINT	1 GAL	1` X 2` SUBTOTAL	3 1,775 SF
			1.1			044000=

MATERIAL SCHEDULE

DESCRIPTION

LARGE BOULDER **SYMBOL** DESCRIPTION MOUNTAINAIR BROWN 7/8" GRAVEL

2-4" BLUE SAIS COBBLE

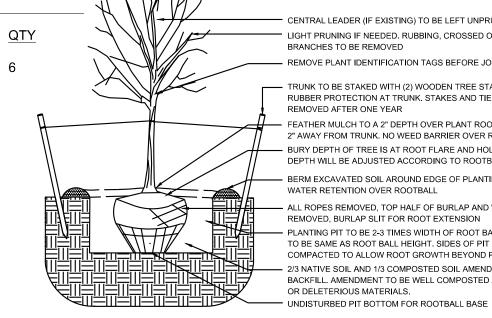

CENTRAL LEADER (IF EXISTING) TO BE LEFT UNPRUNED LIGHT PRUNING IF NEEDED. RUBBING, CROSSED OR DAMAGED BRANCHES TO BE REMOVED REMOVE PLANT IDENTIFICATION TAGS BEFORE JOB IS COMPLETE

TOTAL 24,139 SF

RUBBER PROTECTION AT TRUNK. STAKES AND TIES TO BE REMOVED AFTER ONE YEAR - FEATHER MULCH TO A 2" DEPTH OVER PLANT ROOTBALL, KEEP MULCH 2" AWAY FROM TRUNK. NO WEED BARRIER OVER ROOTBALL. BURY DEPTH OF TREE IS AT ROOT FLARE AND HOLE DEPTH WILL BE ADJUSTED ACCORDING TO ROOTBALL HEIGHT

PLANTING PIT TO BE 2-3 TIMES WIDTH OF ROOT BALL, DEPTH OF PIT TO BE SAME AS ROOT BALL HEIGHT. SIDES OF PIT NOT TO BE OVERLY - 2/3 NATIVE SOIL AND 1/3 COMPOSTED SOIL AMENDMENT TO BE USED AS BACKFILL. AMENDMENT TO BE WELL COMPOSTED AND FREE OF DEBRIS

N.T.S.

TREE PLANTING DETAIL




www.yellowstonelandscape.com PO Box 10597 Albuquerque, NM 87184 505.898.9615

design@yellowstonelandscape.com




Date: <u>7/5/2023</u> Revisions:

Reviewed by: MH

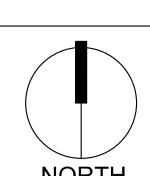

Scale: 1" = 20'

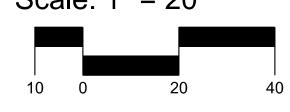

Sheet Title:

Landscape Plan

Sheet Number:

LS-01