CITY OF ALBUQUERQUE

Planning Department
Brennon Williams, Director



Mayor Timothy M. Keller

March 10, 2022

Andrew Doerfler, P.E Burkhardt Engineers, Surveyors 28 North Cherry St. Germantown,, OH 45327

Re: Champion Xpress Car Wash 1520 Juan Tabo Blvd. NE Traffic Circulation Layout Engineer's Stamp 01-28-22 (J22-D031)

Dear Mr. Doerfler,

The TCL submittal received 03-4-2022 is approved for Building Permit with. A copy of the stamped and signed plan will be needed for each of the building permit plans. Please keep the original to be used for certification of the site for final C.O. for Transportation.

PO Box 1293

When the site construction is completed and an inspection for Certificate of Occupancy (C.O.) is requested, use the original City stamped approved TCL for certification. Redline any minor changes and adjustments that were made in the field. A NM registered architect or engineer must stamp, sign, and date the certification TCL along with indicating that the development was built in "substantial compliance" with the TCL. Submit this certification, the TCL, and a completed <u>Drainage and Transportation Information Sheet</u> to front counter personnel for log in and evaluation by Transportation.

Albuquerque

Once verification of certification is completed and approved, notification will be made to Building Safety to issue Final C.O. To confirm that a final C.O. has been issued, call Building Safety at 924-3690.

NM 87103

Sincerely,

www.cabq.gov

Jeanne Wolfenbarger, P.E. Traffic Engineer, Planning Dept. Development Review Services

sanne Wolfenbarger

\xxx via: email C: CO Clerk, File

GENERAL SITE NOTES 1. Building dimensions shown on the Civil Engineering Plans are for reference purposes only. The Contractor shall use the Architectural and Structural Plans for exact building dimensions. 2. All site and radii dimensions are referenced to the face of curbs or edge of paving unless otherwise noted. 3. All dimensions to the building are referenced to the outside face of the structure's facade. 4. All sidewalks, curb and gutter, street paving, curb cuts, driveway approaches, handicap ramps, etc. constructed outside the property line in the right-of-way shall conform to all Local and/or State specifications and requirements. 5. All proposed handicap ramps, parking areas, and accessible routes shall strictly comply with current Local, State, and Federal regulations, including but not necessarily limited to the ADA Accessibility Guidelines (ADAAG). 6. All ADA accessible routes shall have detectable warnings installed as required by the ADAAG. Detectable warnings shall consist of raised truncated domes which contrast visually with the adjoining surfaces, either light-on-dark, or dark-on-light. drainage. 8. All concrete pavement shall have joints in accordance with ACI 330R-08,

7. Contractor shall sawcut existing pavement to provide a clean, straight joint where new pavement meets existing pavement and ensure positive

Section 3.7 and Appendix C. Contraction joints shall be 1/4 of the slab thickness. Isolation joints shall be placed between pavement and foundations, inlets, and other fixed structures. Contraction joints shall be tool finished and spaced as follows:

> Curbing: 10'-0" (max) spacing. Sidewalks: 5'-0" (max) spacing.

Vehicular Traffic Areas: 24 x Concrete Pavement

Thickness (feet), 15'-0" (max) spacing.

PLANNING AND ZONING REQUIREMENTS

Reference: City of Albuquerque Integrated Development Code Zone: "MX-L" Mised Use - Low Intensity Zone District Proposed Use: Car Wash

Building Setbacks Front: 5 ft. (min.) Side, Interior: 0 ft. (min.) Side, Street: 5 ft. (min.)

Rear:15 ft. (min.)

12" WIDE SECTION OF ASPHALT PAVEMENT ADJACENT TO NEW CURB AND GUTTER SHALL BE SAWCUT, REMOVED, AND REPLACED AS PER CITY OF ALBUQUERQUE STANDARD SPECIFICATIONS. PAVEMENT SECTION PER DETAIL / SHEET C-2.2 OR MATCH EXISTING SECTION. PER CITY OF ALBUQUERQUE STANDARD DETAIL DRAWING No. 2407 & 2408

PERMITTING CONTACT INFORMATION:

PLANNING / ZONING / BUILDING

City of Albuquerque - Planning Department Contact: Brennon Williams

Telephone: 505.924.3860

Email: bnwilliams@cabq.gov

UTILITY CONTACT INFORMATION:

SANITARY SEWER / WATER

Albuquerque Bernalillo County Water Utility Authority

Contact: Robert Strong

Telephone: 505.261.4429 Email: rstrong@abcwua.org

STORM SEWER

City of Albuquerque - Planning Hydrology Department Contact: Renee Brissette

Telephone: 505.924.3995

Email: rbrissett@cabq.gov

New Mexico Gas Company Contact: Jacob Gallegos Telephone: 505.697.3120

Email: Jacob.Gallegos@nmgco.com

Email: Andrew.Gurule@pnm.com

ELECTRIC


Know what's **below.**

Call before you dig.

PNM (Public Service Company of New Mexico) Contact: Andrew Gurule Telephone: 505.241.0589

TELECOM

CenturyLink Contact: Customer Service Telephone: 865.465.2313

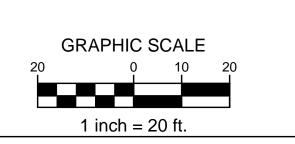

APPROVAL FOR


TRAFFIC CIRCULATION LAYOUT

Jeanne Wolfenbarger


VERTICAL & HORIZONTAL CONTROL

BM#1: Description: Chiseled 'X' in Sidewalk Elevation: 5605.91' BM#2: Description: Chiseled 'X' in Sidewalk

Elevation: 5610.51'

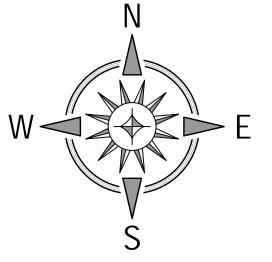

TAKE CAUTION DURING EXCAVATION:

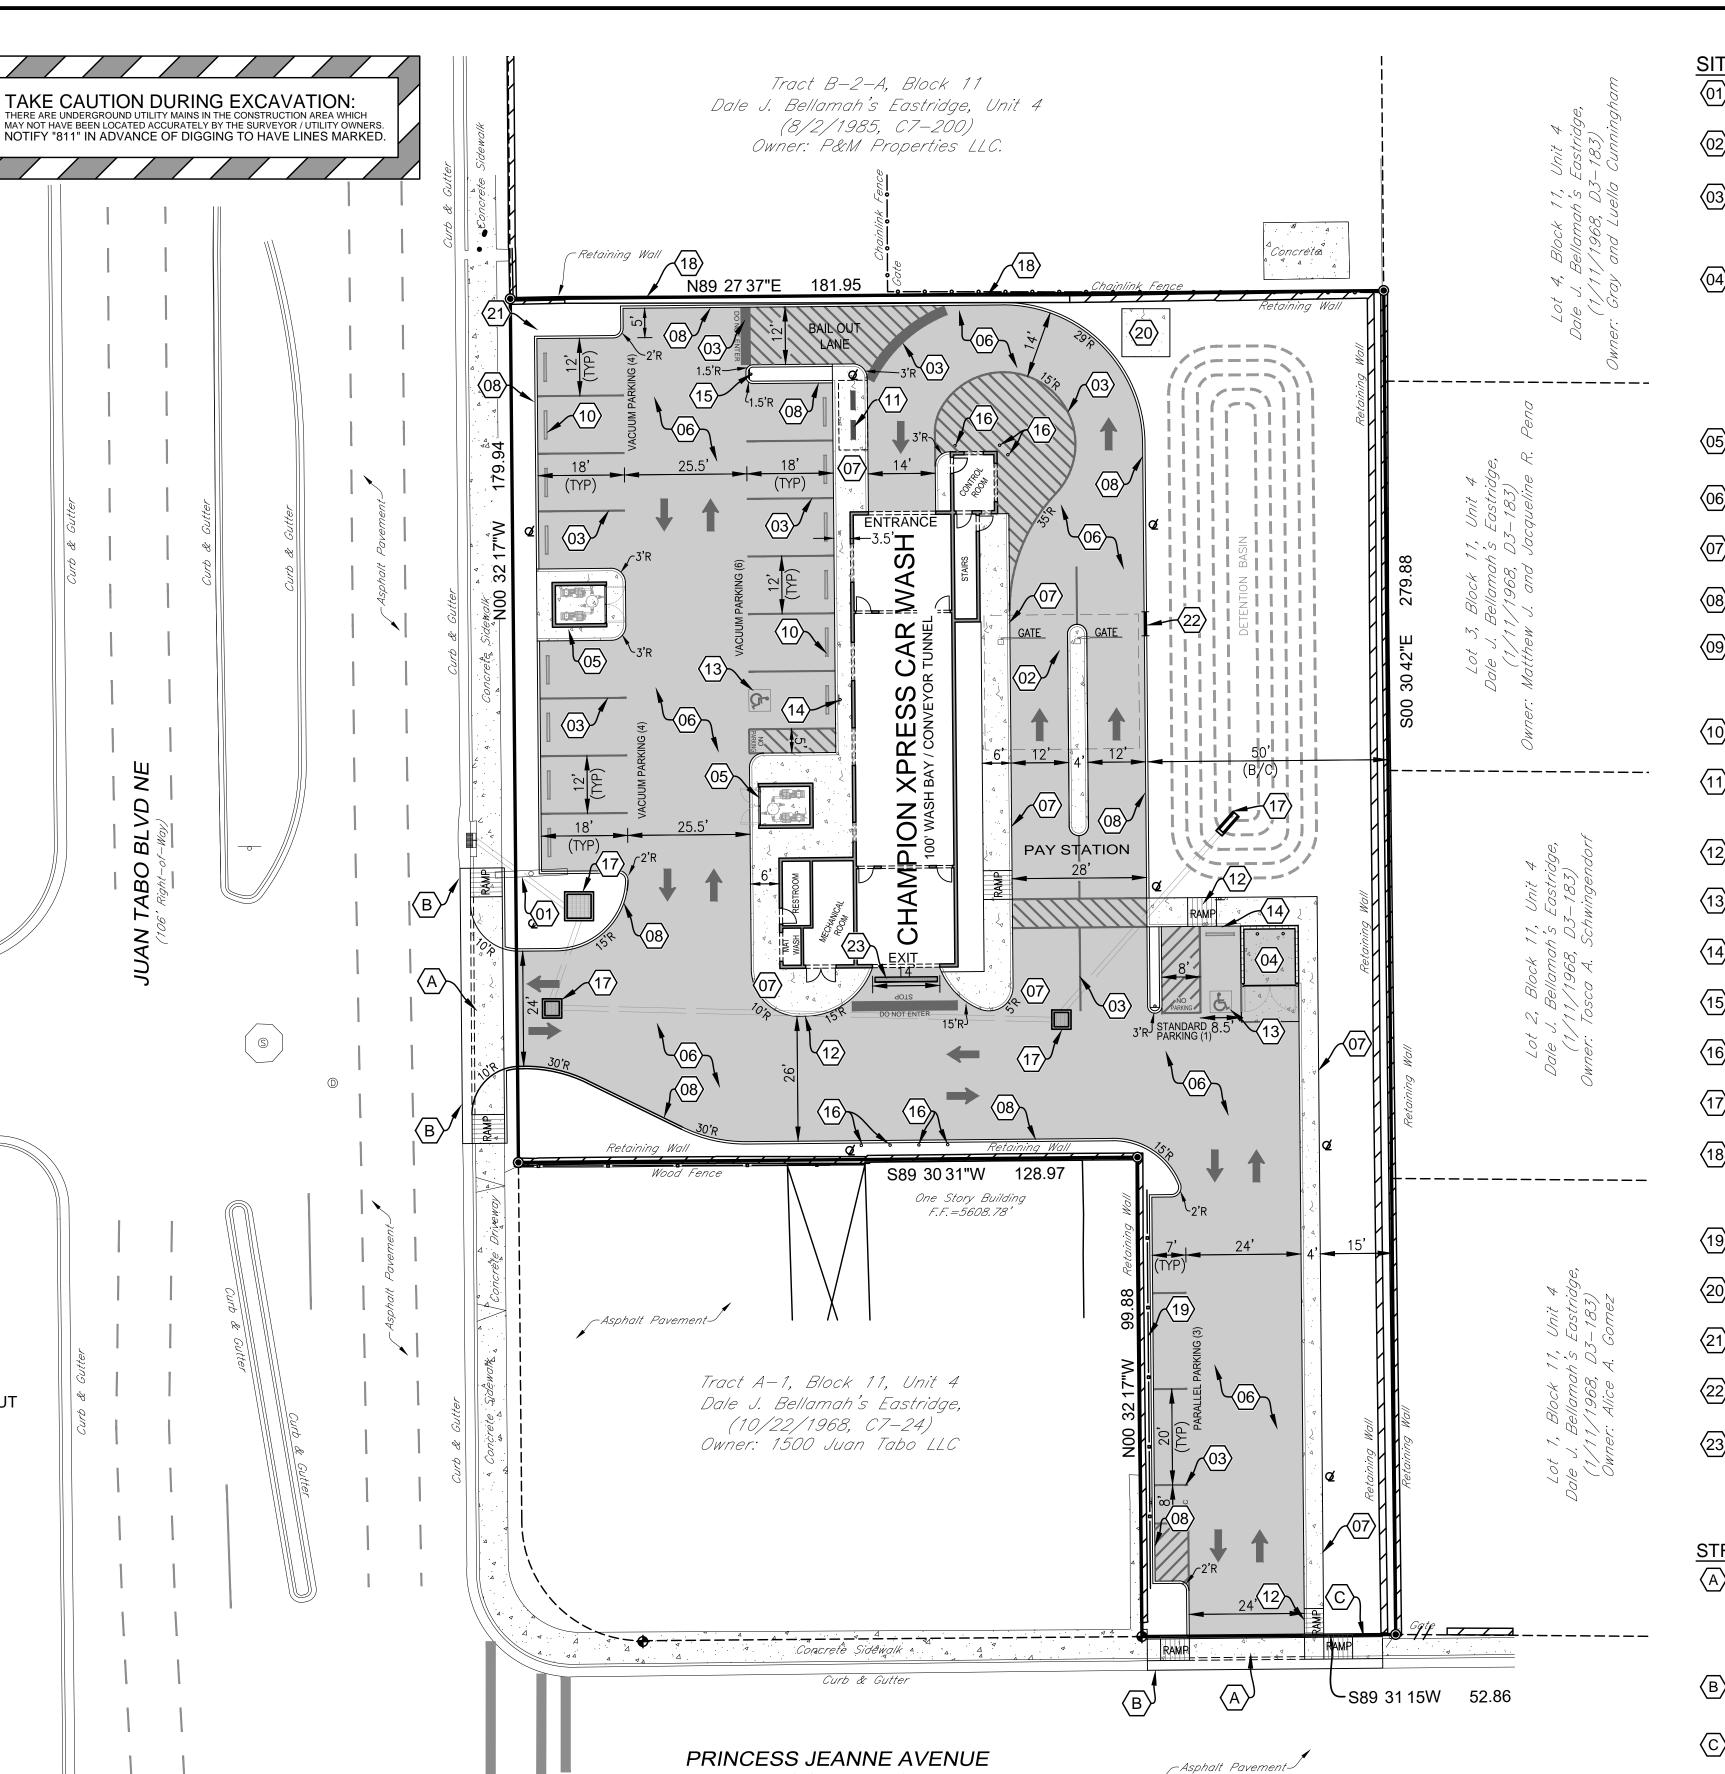

(50' Right-of-Way)

Curb & Gutter Approved for access by the Solid Waste Department 1 trash dumpster

Herman Gallegos 03-10-22 Herman Gallegos

WORK WITHIN PUBLIC RIGHT-OF-WAY REQUIRES DRC-APPROVED PLANS.

Additional site elements are necessary to service the auto wash such as gates, floor mat cleaners, vending machines, vacuum equipment enclosures, vacuums, canopies, signage, etc. which may not be shown on this plan. Locations and details of these elements can be provided by the owner at the request of the contractor or the City of Albuquerque.

ACCESSIBLE PARKING SYMBOL & MARKING NOTES A paved accessible parking space must include:

-The International Symbol if Accessibility conspicuously on the surface in a color that contrasts the pavement. The words "NO PARKING" painted on any access aisle adjacent to

Words must be painted in all capital letters with a letter height of at least twelve inches, a stroke width of at least two inches, and centered within each access aisle adjacent to the parking space.

SITE KEYNOTES

(01) REUSE EXISTING PYLON SIGN - RETAIN AND PROTECT EXISTING PYLON SIGN FOR REUSE.

(02) PAY STATION CANOPY - SEE ARCHITECTURAL PLANS FOR DETAILS.

(03) PARKING STRIPE / HATCH - 4" WIDE PAINTED STRIPES / 24" FOR STOP BAR. - HATCHING TO BE AT 45 DEGREE AND 2'-0" O.C.

- STRIPING ON CONCRETE PAVEMENT TO BE PAINTED YELLOW. (04) CONCRETE DUMPSTER PAD & APRON 12'x20' PAD TO BE CONSTRUCTED OF MIN. 8 IN. THICK 4000 PSI CONCRETE REINFORCED WITH MIN. 6X6-10/10WWM @ 12 IN. O.C. IN EACH DIRECTION LOCATED IN THE UPPER THIRD OF SLAB. - PAD DIMENSIONS: 14' WIDE x 26' LONG

- PROVIDE PIPE BOLLARDS PER DETAIL / SHEET C-5.0 - PROVIDE ONE (1) DUMPSTER. - SEE ARCHITECTURAL PLANS FOR TRASH ENCLOSURE DETAILS AND PIPE BOLLARD LAYOUT.

(05) VACUUM EQUIPMENT ENCLOSURE SEE ARCHITECTURAL PLANS FOR DETAILS.

CONCRETE PAVEMENT - TRAFFIC - PER PAVEMENT SECTION / SHEET C-5.0

(07) CONCRETE SIDEWALK

PER DETAILS / SHEET C-5.0

PER DETAILS / SHEET C-5.0

(08) MONOLITHIC CONCRETE BARRIER CURB

(09) CURBED ISLAND FOR TRAFFIC CONTROL - INSTALL PER CONCRETE MOUNTABLE MEDIAN CURB AND CONCRETE SIDEWALK, PER DETAIL / SHEET C-5.0 - FACE OF CURB TO BE PAINTED YELLOW.

(10) CONCRETE WHEEL STOP PER DETAILS / SHEET C-5.0

(11) BICYCLE PARKING (2 RACKS) - 30" RECOMMENDED SPACING. - PER DETAIL / SHEET C-5.0

(12) ADA ACCESSIBLE RAMP - PER DETAIL / SHEET C-5.0

(13) ADA PARKING SYMBOL - PER DETAIL / SHEET C-5.0

(14) ADA PARKING SIGNAGE - PER DETAIL / SHEET C-5.0

15 TRAFFIC CIRCULATION SIGNAGE "DO NOT ENTER" PER DETAIL / SHEET C-5.0

(16) PIPE BOLLARD - PER DETAIL / SHEET C-5.0

(17) DRAINAGE STRUCTURE - SEE UTILITY PLAN / SHEET C-4.0 FOR INSTALLATION DETAILS.

(18) CONCRETE BLOCK RETAINING WALL - CONTRACTOR TO COORDINATE INSTALLATION OF NEW RETAINING WALL WITH NEIGHBORING PROPERTY OWNER. SEE SHEET C-1.1 FOR DEMOLITION

(19) 6' WOOD FENCE

- PER DETAIL / SHEET C-5.0

20 ELECTRIC TRANSFORMER PAD - SEE SHEET C-4.0 FOR DETAILS

(21) MOTORCYCLE PARKING SIGNAGE - PER DETAIL / SHEET C-5.0

5' CURB CUT FOR CROSS DRAINGE PER DETAIL / SHEET C-5.0

(23) TRENCH DRAIN - PER DETAIL / SHEET C-5.0

STREET IMPROVEMENT KEYNOTES

(A) CITY DRIVEPAD WITH SIDEWALK AT BACK OF CURB MAINTAIN EXISTING DRIVEPAD IN RIGHT-OF-WAY. INSTALL NEW SIDEWALK / DRIVEPAD PER CITY DETAILS. - PER CITY OF ALBUQUERQUE STANDARD DETAIL DRAWING No. 2426 AND 2420

(B) CITY STANDARD CURB & GUTTER PER CITY OF ALBUQUERQUE STANDARD DETAIL DRAWING No. 2415

(C) CITY CONCRETE SIDEWALK - PER CITY OF ALBUQUERQUE STANDARD DETAIL DRAWING No. 2430

SITE AND PAVEMENT LEGEND

(B/C) BACK-OF-CURB

TYPICAL PARKING STALL WIDTH

RADIUS - FACE OF CURB

CONCRETE WHEEL STOP


ADA PARKING SYMBOL

PROPOSED LIGHT POLE

DIRECTIONAL PARKING LOT ARROW

CONCRETE SIDEWALK

CONCRETE PAVEMENT - TRAFFIC

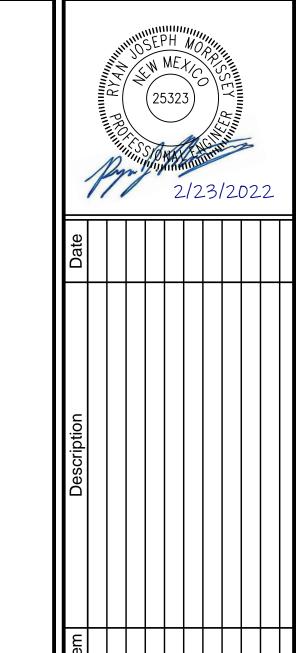

52 ≥ E



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Scale: 1" = 20'

02.23.2022

SITE PLAN

Sheet No.:

GENERAL UTILITY NOTES:

- 1. All utilities shown are approximate locations only and have been compiled from the latest available mapping. The exact location of all underground utilities shall be verified by the Contractor prior to the start of construction.
- 2. Contractor to coordinate with the local utility companies for all locations and connections. A preconstruction meeting with the various utility companies may be required prior to the start of any construction activity.
- 3. The Contractor shall visit the site and verify the location, elevation, and condition of all existing utilities by various means prior to beginning any excavation. Test pits shall be dug at all locations where existing and proposed utility lines cross, and the horizontal and vertical locations of the utilities shall be determined. The Contractor shall contact the Engineer in the event of any unforeseen conflicts between existing and proposed utilities so that an appropriate modification may be made.
- 4. The Contractor shall ensure that all utility companies and local standards for materials and construction methods are met. The Contractor shall perform proper coordination with the respective utility company. The Contractor shall coordinate work to be performed by the various utility companies and shall pay all fees for connections, disconnection, relocations, inspections, and demolition.
- 5. This plan details pipes up to 5' from the building face. Refer to the building drawings for building connections. Supply and install pipe adapters as
- 6. All valve boxes and curb boxes shall be adjusted to the final grades and located in grassed areas unless indicated otherwise on the plans.
- 7. The Contractor shall provide traffic bearing concrete collars and lids for all cleanouts, manholes, inlets, valves, etc. which are located in paved areas.
- 8. All existing pavement within the rights-of-way where utility piping is to be installed shall be saw cut and replaced or directionally bored in accordance with Local and/or State requirements. Existing pavement shall be repaired as
- 9. All utility lines and trenches shall be installed, bedded and backfilled according to manufacturer's specifications and to the satisfaction of Local and State Authorities.
- 10. Sanitary sewer laterals shall maintain (10' min. horizontal, 1.5' min. vertical) separation distance from water lines unless otherwise shown, or additional protection measures will be required. Where water line crosses above sanitary lateral by less than 2' vertical, a concrete encasement shall be installed, Contractor shall center one joint of pipe at crossing.
- 11. Roof drains, foundation drains, and other clean water connections to the sanitary sewer system are prohibited.

PLANNING AND ZONING REQUIREMENTS

Reference: City of Albuquerque Integrated Development Code Zone: "MX-L" Mised Use - Low Intensity Zone District Proposed Use: Car Wash

PERMITTING CONTACT INFORMATION:

PLANNING / ZONING / BUILDING City of Albuquerque - Planning Department Contact: Brennon Williams

Telephone: 505.924.3860 Email: bnwilliams@cabq.gov

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SANITARY SEWER / WATER Albuquerque Bernalillo County Water Utility Authority Contact: Robert Strong Telephone: 505.261.4429

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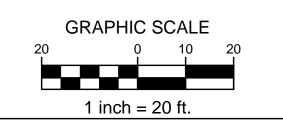
TELECOM

Know what's **below.**

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CenturyLink Contact: Customer Service


Telephone: 865.465.2313



VERTICAL & HORIZONTAL CONTROL

BM#1: Description: Chiseled 'X' in Sidewalk Elevation: 5605.91' BM#2: Description: Chiseled 'X' in Sidewalk

Elevation: 5610.51'

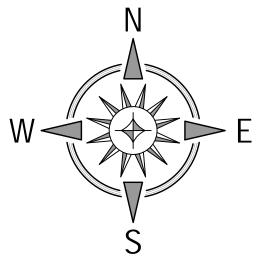

TAKE CAUTION DURING EXCAVATION:

NOTIFY "811" IN ADVANCE OF DIGGING TO HAVE LINES MARKED.

DOMESTIC & IRRITATION WATER SERVICES: CONTRACTOR TO COORDINATE WITH THE ABUQUERQUE BERNALILLO COUNTY WATER

AUTHORITY FOR 2" DOMESTIC SERVICE METER WITH

Catch Basin — Grate=5606.10

12"Inv.=5603.60

— — G — I

BACKFLOW PREVENTION, 1" IRRIGATION SERVICE METER WITH BACKFLOW PREVENTION, AND CONNECTION TO EXISTING WATER LINE LATERALS.

STORM SEWER CONNECTION: CONTRACTOR TO CORDINATE WITH THE CITY OF ALBUQUECOUNT FOR

12"INV.=5603.65 TOP OF PIPE=5604.65 CONNECT FOR WATER TIGHT SEAL.

Grate=5606.50'

Inv.=5595.90'(S)

12"Inv.=5598.20'(NW)

Ganitary MH— Rim=5606.70°

Inv. =5596.20'

-FO<u>Fiber Optic</u>FO-

SANITARY SEWER SERVICE: CONTRACTOR CONNECT TO EXISTING SANITARY MANHOLE PER ALBUQUERQUE BERNALILLO COUNTY WATER UTILITY AUTHORITY

CONTRACTOR TO COORDINATE CONNECTION INSPECTION AS NEEDED WITH ALBUQUERQUE BERNALILLO COUNTY WATER AUTHORITY

PROP. 6"INV.=5602.60

CONNECTION TO EXISTING CATCH BASIN.

SANITARY SEWER NOTES:

Tract B-2-A, Block 11

Dale J. Bellamah's Eastridge, Unit 4

(8/2/1985, C7-200)

Owner: P&M Properties LLC.

100'~12"HDPE@0.50%

Tract A-1, Block 11, Unit 4

Dale J. Bellamah's Eastridge,

(10/22/1968, C7–24)

Owner: 1500 Juan Tabo LLC

PRINCESS JEANNE AVENUE

Curb & Gutter

(50' Right-of-Way)

Concrete Sidewalk A. A. A.

TRENCH DRAIN— GRATE=5609.60

4"INV.=5608.00

N89 27 37"E 181.95

–5' Exclusive

Water Easement

—5' Exclusive

Retaining Wall

NATURAL GAS SERVICE: CONTRACTOR TO COORDINATE WITH NEW MEXICO GAS COMPANY FOR CONNECTION, METER SET, ROUTING, SIZE, ETC.

SEE IRRIGATION PLAN

SHEET L-2.0 FOR INSTALLATION DETAILS

12"INV.=5603.75

TYPE D CATCH BASIN GRATE=5606.95

45'~6"PVC@3.00%

Retainina Wall

1"M

7' Utility Easement V

Concrete

SINGLE HOPE PIPE CONCRETE BLANKET WITHOUT SAFETY GRATE.

TELECOM SERVICE

ELECTRIC & TELECOM SERVICES: CONTRACTOR TO COORDINATE WITH LOCAL UTILITY PROVIDERS FOR 3-PHASE ELECTRIC, ROUTING, TRANSFORMER LOCATION, DROP CONNECTIONS, ETC.

ELECTRIC TRANSFORMER PAD

-HVAC EQUIPMENT SEE MECH PLANS

~12"x4"TEE

S89 30 31"W 128.97

One Story Building F.F.=5608.78

ELECTRIC SERVICE
TELECOM SERVICE

12"INV.=5604.35

_Asphalt Pavement~

Contractor to provide 6" (min.) sanitary sewer service line from building to public sewer main. Install tap, manholes, cleanouts and other appurtenances as required by the local utility provider. Coordinate building connection with plumbing plans.

All sanitary sewer pipe shall be P.V.C. SDR 35, ASTM D-3034 with joints conforming to ASTM 3212. All pipe shall be installed in accordance with the manufacturer's recommended procedures and shall maintain a minimum slope

Sanitary sewer clean-outs shall be installed at all sewer pipe bends, angles, and junctions, unless a manhole is indicated. All cleanouts in pavement areas shall be installed with traffic bearing lids and concrete collars. Cleanout spacing should not exceed 100'. Per detail / Sheet C-5.0.

Sanitary sewer service connection, permit and construction to be coordinated with Albuquerque Water Utility Authority.

WATER NOTES:

+-----

H-+----

1 ______

S89 31 15W 52.86

WORK WITHIN PUBLIC RIGHT-OF-WAY

REQUIRES DRC-APPROVED PLANS.

7' Utility Easement

Contractor to provide 2" domestic water service line from public water main to building. Install tap, meter, backflow preventer, and other appurtenances as required by the local utility provider. Coordinate building connection with plumbing plans.

Contractor to provide 1" irrigation service line from public water main to existing meter. Install tap, meter, backflow preventer, and other appurtenances as required by the local utility provider. Coordinate with Irrigation Contractor, irrigation plans and plumbing/electrical plans.

Water service lines shall be Polyethylene PE4710 or Albuquerque Water Utility Authority approved material, installed per manufacturer's recommended procedures. Lines shall be installed with a minimum cover of 42" or below frost line, whichever is greater.

Water service connection, meter, permit and construction to be coordinated with Albuquerque Water Utility Authority.

STORM SEWER NOTES:

All storm sewer shall be reinforced concrete pipe (ASTM C76 - Class III, minimum) or high-density polyethylene pipe (ADS N-12 or equivalent), unless otherwise noted on plans. All pipe shall be installed according to Local, State, and manufacturer's specifications. All storm sewer catch basins to have H-20 Traffic rated grates.

Storm sewer connection, permit and construction to be coordinated with City of Albuquerque.

GAS NOTES:

Coordinate gas service lines, meter, and connections with mechanical plans and local utility provider. Contractor shall verify both location and availability of service prior to the start of construction.

ELECTRIC NOTES:

Coordinate electric service lines, meter, and connections with electrical plans and local utility provider. Contractor shall verify both location and availability of service prior to the start of construction.


Coordinate site lighting, signage wiring, conduit locations, connections, etc. with electrical plans. Notify Engineers of any potential conflicts.

TELECOM NOTES:

Coordinate telecommunication service lines and connections with electrical plans and local utility provider. Contractor shall verify both location and availability of service prior to the start of construction.

25 25 25 25 25 26 27

UTILITY LEGEND PROP. LIGHT POLE PROP. WATER METER ss PROP. SANITARY SEWER SERVICE ----- W ------ W ------ PROP. WATER LINE ---- G ----- G ----- PROP. GAS SERVICE PROP. ELECTRIC SERVICE — T — T — PROP. TELECOM SERVICE

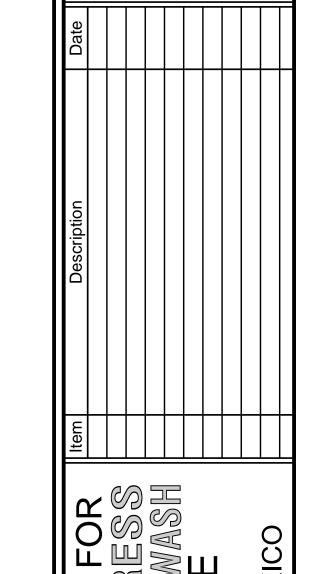

25323)




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02.23.2022


UTILITY PLAN

Sheet No.:



Know what's **below.**

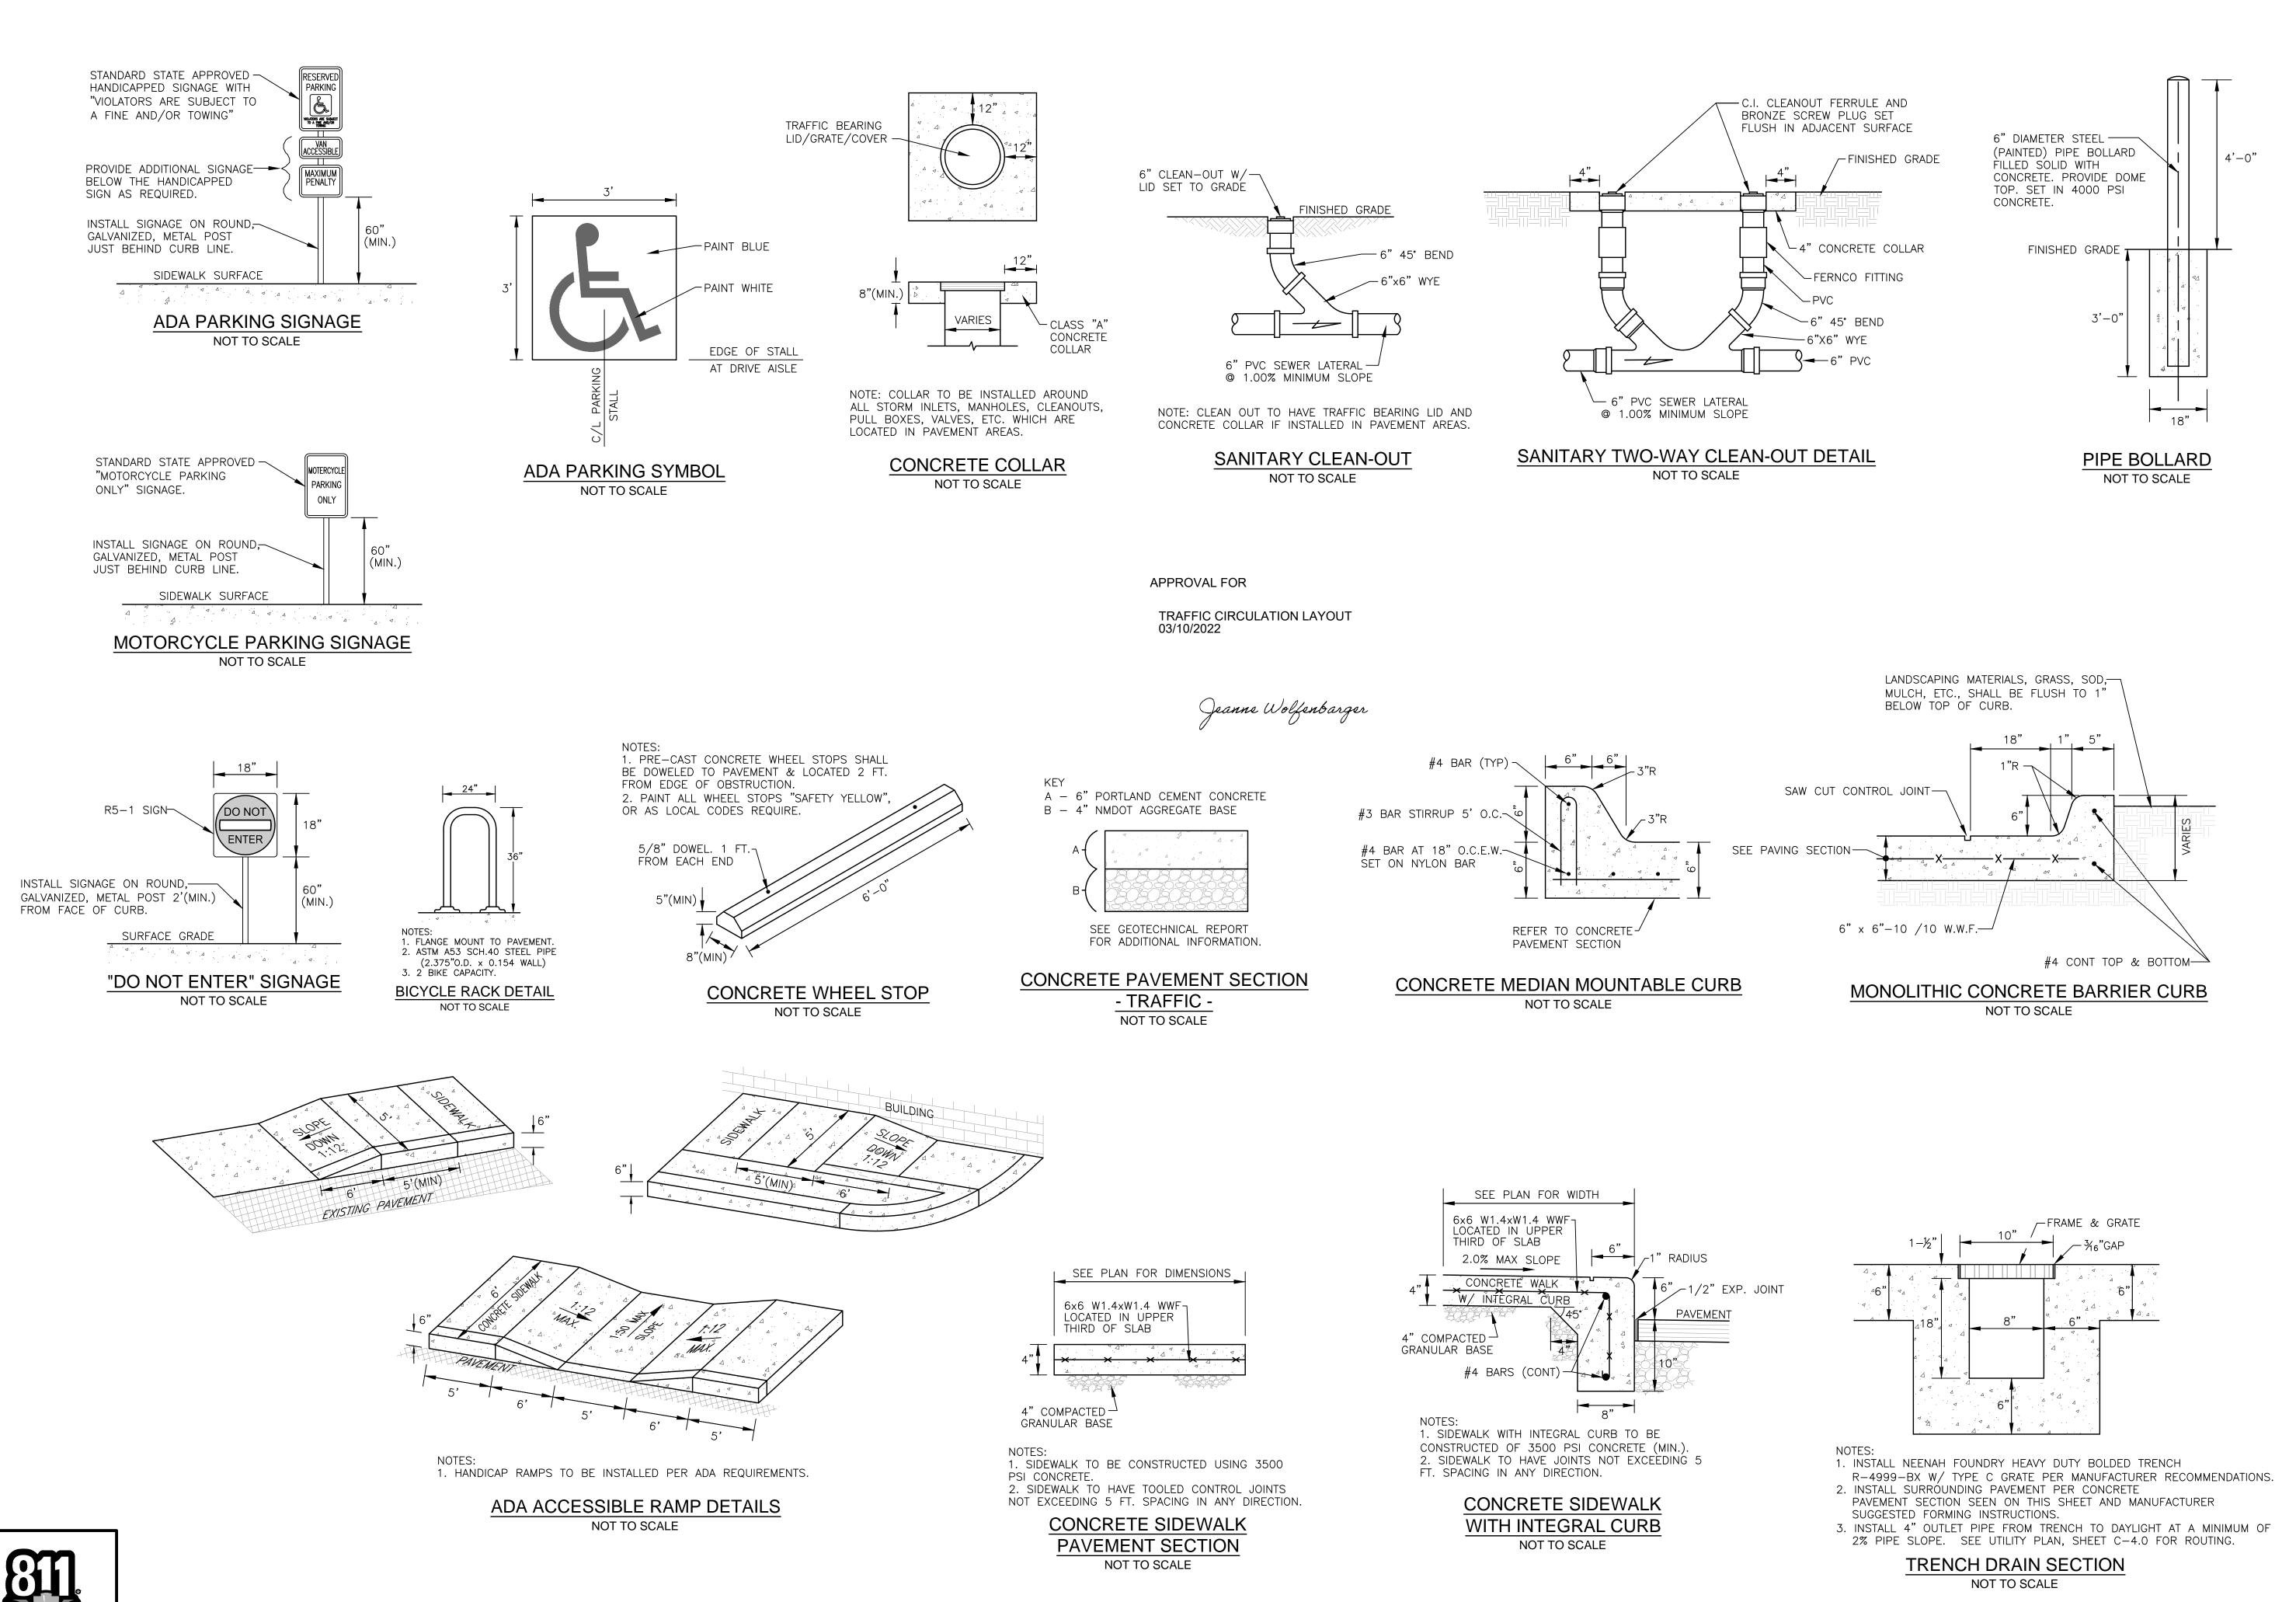Call before you dig.

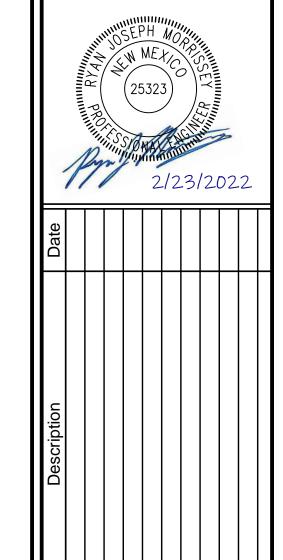

FOR ESS MASH

Design: AFD Proj: 21.215 Draw: AFD Dwg: 21.215.dwg Check: RJM Tab: C5.0-DET

Scale: N/A

02.23.2022

SITE DETAILS

C-5.0

FIRE PLAN NOTES 1. Existing fire hydrant south of the site meets spacing requirements as determined by IFC Table C102.1 -- hose lay from hydrant to fire apparatus road does not exceed 250'. The fire hydrant is assumed to meet fire flow requirements as determined by IFC Table B105.1. 2. Fire apparatus route shown per IFC 503.2.1 requirements -- 20' wide & 28' radii. Route is within 150' of all portions of the building. Route is less than 150' -- no turn around required. 3. The Fire Apparatus Access Road shall have a minimum of 13'-6" unobstructed height clearance. 4. Public water main sizes not shown on plans due to lack of information provided from ALTA survey and City of Albuquerque GIS. 5. Contractor / Geotechnical Engineer shall confirm pavement installation within the Fire Apparatus Access Road to support imposed load of fire apparatus weighing at least 75,000 lbs. 6. Pavement grades do not exceed 10% along Fire Apparatus Route. 7. Fire lane to be designated by curb painted red with "NO PARKING" and "FIRE LANE" text spaced per City of Albuquerque standards. See Fire 2 Plan for information regarding building address location and Knox 9. Premise ID: Building shall have approved address numbers or building identification placed in a position plainly legible and visible from the street or road fronting the property. CODE CRITERIA **BUILDING AREA:** 2,927 sq. ft. BUILDING HEIGHT: 2 Story 30'-0" (2nd Story Floor Height = 15'-6" A.F.F.) Business - Car Wash OCCUPANCY TYPE: V-B CONSTRUCTION TYPE: OCCUPANT LOAD: 11 people EXITS PROVIDED(REQUIRED): 4 City of Albuquerque Integrated Zoning Code ZONING ORDINANCE: "MX-L" - Low Intensity Zone District ZONE: **USE CATEGORY:** Car Wash Non-sprinklered SPRINKLER SYSTEM:

DEVELOPMENT / DESIGN TEAM OWNER / DEVELOPER 7B Building and Development Contact: Derrick Merchant Phone: 806.368.7843 Email: derrick@7bdev.com CIVIL ENGINEER / CONSULTANT Burkhardt Engineering Contact: Ryan Morrissey Phone: 937.388.0060 Email: rmorrissey@burkhardtinc.com ARCHITECT / STRUCTURAL / MEP C.L. Helt Architect

1,500 GPM

REQUIRED FIRE FLOW:

Contact: Diana Myers

Phone: 704.342.1686


Email: dianam@clhelt.com

LANDSCAPE ARCHITECTURE Yellow Springs Design Contact: Roger Beal Phone: 937.767.8199

Know what's **below**.


Call before you dig.

Email: yellowspringsdesign@bizwoh.rr.com

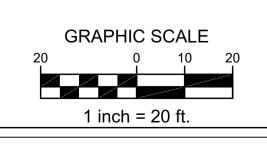




BM#1: Description: Chiseled 'X' in Sidewalk Elevation: 5605.91' BM#2: Description: Chiseled 'X' in Sidewalk Elevation: 5610.51'

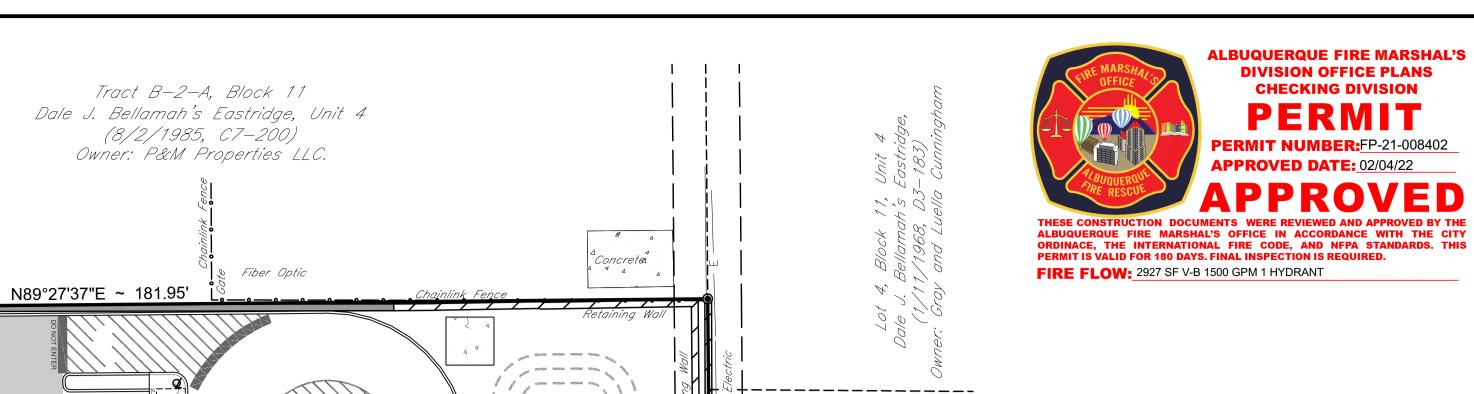

CURBED ISLAND FOR TRAFFIC CONTROL - FOR RIGHT OUT TRAFFIC CONTROL - INSTALL PER CONCRETE MOUNTABLE MEDIAN CURB AND CONCRETE SIDEWALK, PER DETAIL / SHEET C-5.0 - FACE OF CURB TO BE PAINTED YELLOW.

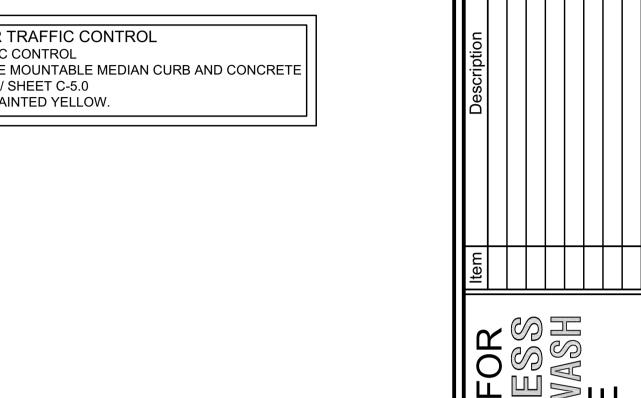






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01.28.2022

FIRE 1 PLAN

Sheet No.:

C-2.

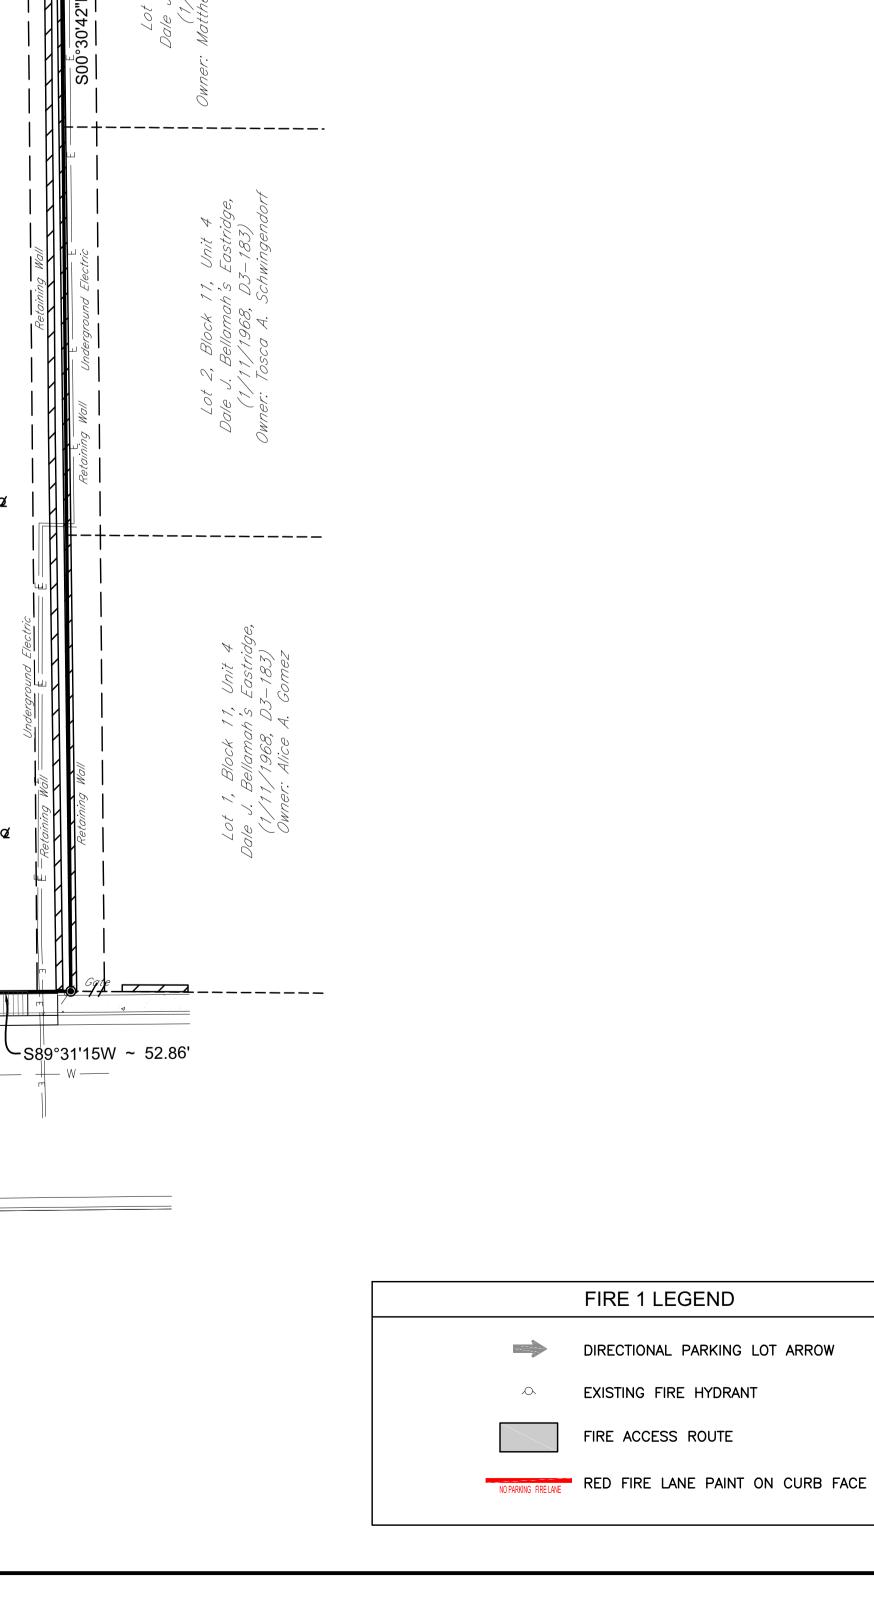

TAKE CAUTION DURING EXCAVATION:

Fiber Optic

THERE ARE UNDERGROUND UTILITY MAINS IN THE CONSTRUCTION AREA WHICH MAY NOT HAVE BEEN LOCATED ACCURATELY BY THE SURVEYOR / UTILITY OWNERS. NOTIFY "811" IN ADVANCE OF DIGGING TO HAVE LINES MARKED.

Retaining Wall

S

\$89°30'31"W ~ 128.97'

One Story Building F.F.=5608.78'

_Asphalt Pavement

Concrete Sidewalk A A

Curb & Gutter

PRINCESS JEANNE AVENUE

Curb & Gutter

(50' Right-of-Way)

Tract A-1, Block 11, Unit 4

Dale J. Bellamah's Eastridge,

(10/22/1968, C7-24) Owner: 1500 Juan Tabo LLC

