

# City of Albuquerque

Planning Department
Development Review Services Division

## Traffic Scoping Form (REV 05/2024)

J22D074

•		
	DFT/DHO #:	
	s:	
(If no City Address include	a Vicinity Map with site highlighted and le	egible street names)
A P 4		
	E-mail:	
<b>Development Information</b>		
Build out/Implementation Yea	r:	
Existing Use:		
Describe Proposed Developme		
Days and Hours of Operation (	(if known):	
Facility		
Building Size (sq. ft.):		
Number of Residential Units:		
Traffic Considerations	(C)	
	sitors/Patrons (if known):*	
	es (if known):*	
Expected Number of Delivery	Trucks/Buses per Day (if known):*	
Trip Generations during PM/A	M Peak Hour and ITE # (if known):*	
Driveway(s) Located on: Street N	iame	
Adjacent Roadway(s) Posted S	Speed: Street Name	Speed_
	Street Name	Speed_

<sup>\*</sup> If these values are not known, assumptions will be made by City staff. Depending on the assumptions, a full TIS may be required.

<b>Roadway Information (</b>	adjacent to site)	
	dor Designation (e.g. Main Street, Major Trans: ebappviewer/index.html?id=53bf716981b14d25a31e	it, N/A):
Comprehensive Plan Cente	**	/A):
	ation (e.g. Principal Arterial, Collector): <u>bappviewer/index.html?id=53bf716981b14d25a31e</u>	7 <u>a2549c2d61b</u>
Jurisdiction of roadway (N	MDOT, City, County):	
Adjacent Roadway(s):		
Name:	Traffic Volume:	Volume-to-Capacity Ratio (v/c):
Name:	Traffic Volume:	Volume-to-Capacity Ratio (v/c):
Traffic Volume and V/C Rationm.gov/574/Transportation-A		-Flow-Maps-and-Busiest-Intersecti and https://mrcog-
Adjacent Transit Service(s) https://www.cabq.gov/gis/advanced-r	NearestNearest	Transit Stop(s):
	emium Transit?:_ ebappviewer/index.html?id=53bf716981b14d25a31e	7a2549c2d61b
	nfrastructure :gov/544/Long-Range-System-maps	
Current/Proposed Sidewalk Sidewalk and buffer width: D		
Submit by email to Traffic	Engineer Curtis Cherne: ccherne@cab	oq.gov. Email or call 505-924-3986 for information.
For City Personnel Use	:	
TIS Determination		
Note: Changes made to dev TIS determination.	/elopment proposals / assumptions, fro	om the information provided above, will result in a new
Traffic Impact Study (TIS	S) Required: Yes [ ] No [X]	Transportation concurs with
Thresholds Met? Yes [ ]	No [X]	the trips on the form.
Mitigating Reasons for Not	Requiring TIS and/or Notes:	AM Trips 0 PM Trips 78
Curtis A Char	ne	

DATE

TRAFFIC ENGINEER

## **Automated Car Wash**

(948)

Vehicle Trip Ends vs: Car Wash Tunnels

On a: Weekday,

Peak Hour of Adjacent Street Traffic, One Hour Between 4 and 6 p.m.

Setting/Location: General Urban/Suburban

Number of Studies: 3
Avg. Num. of Car Wash Tunnels: 1


Directional Distribution: 50% entering, 50% exiting


### **Vehicle Trip Generation per Car Wash Tunnel**

Average Rate	Range of Rates	Standard Deviation
77.50	50.00 - 104.50	33.07


### **Data Plot and Equation**


#### Caution - Small Sample Size

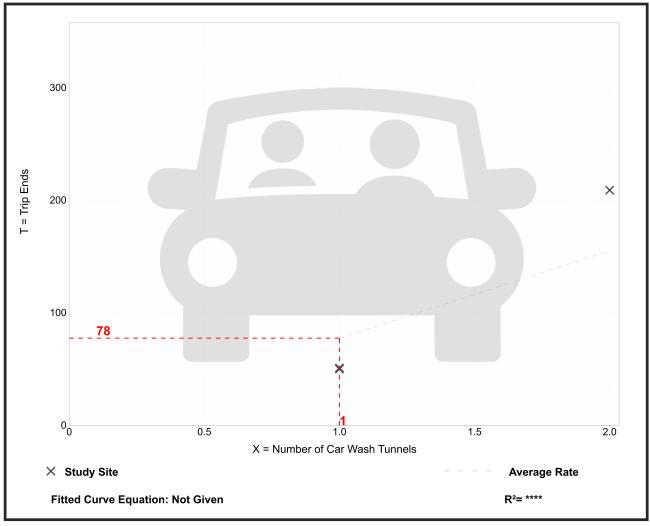

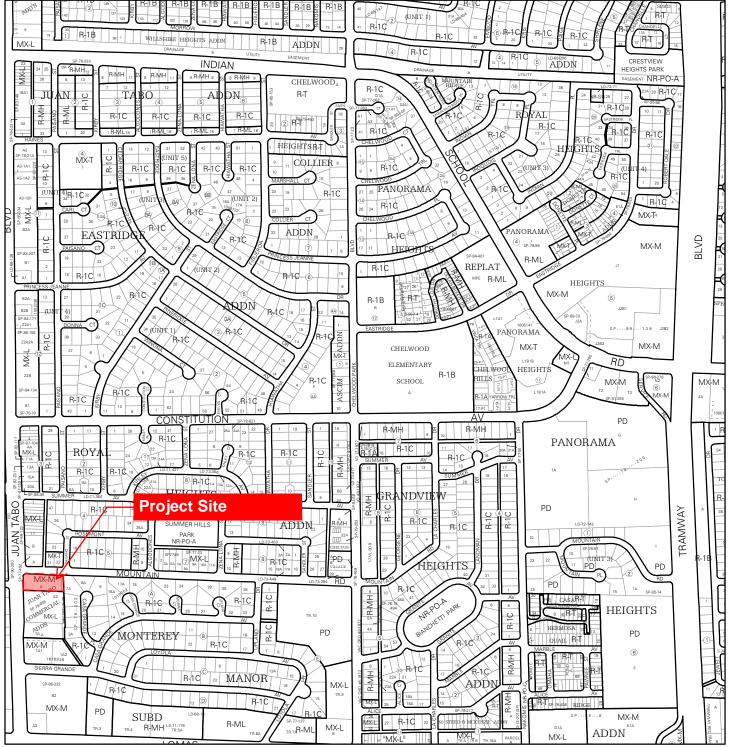

For more details about the Integrated Development Ordinance visit: http://www.cabq.gov/planning/codes-policies-regulations/integrated-development-ordinance

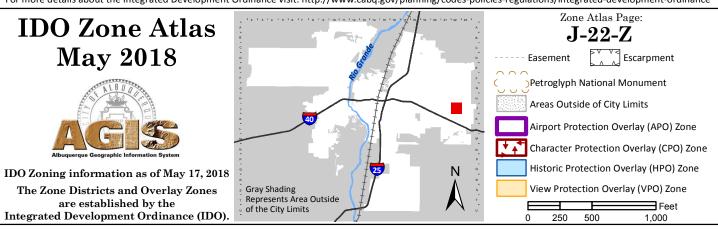

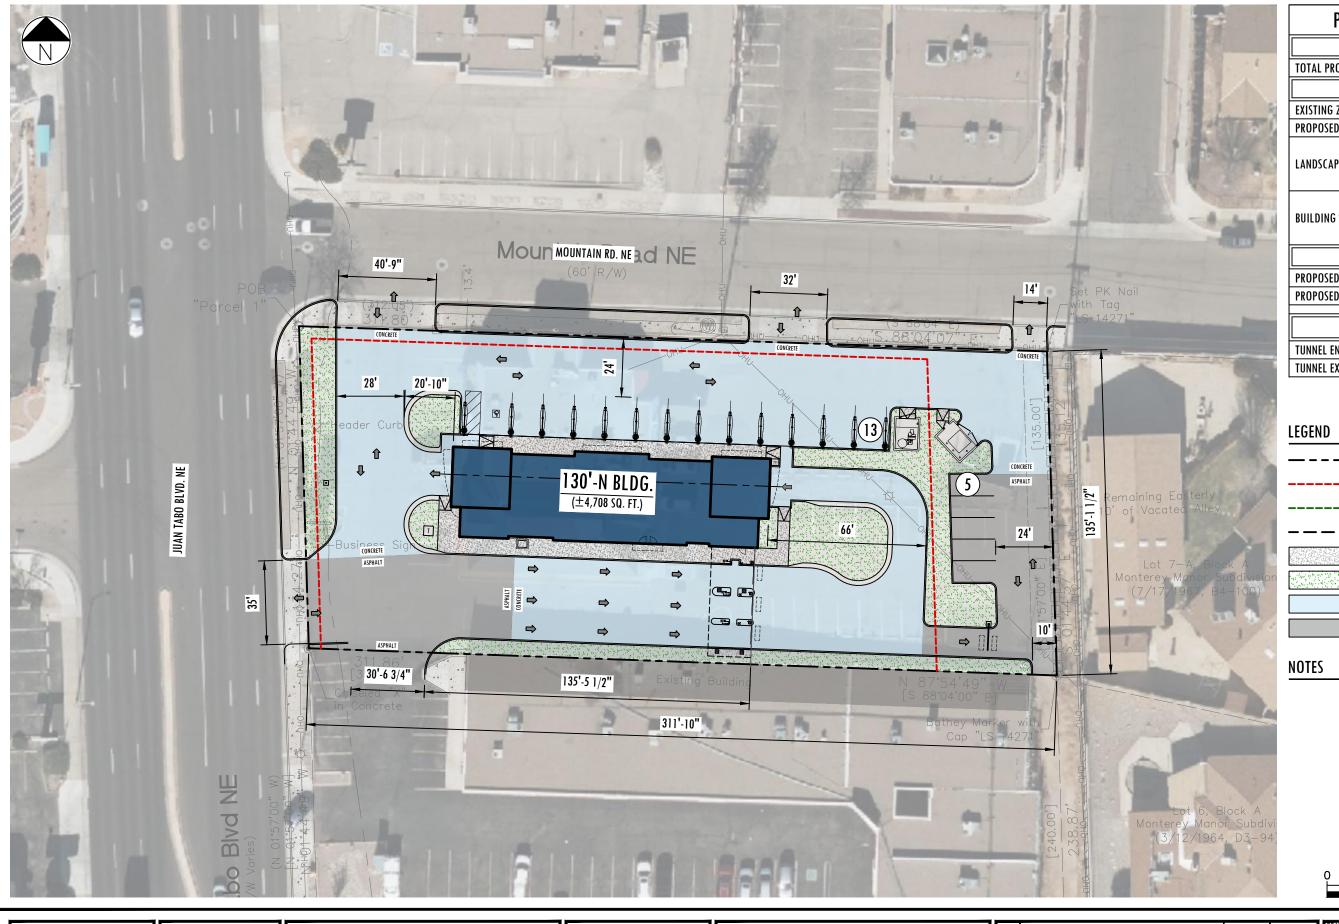

PROPERTY SUMMARY		
ALBUQUERQUE, NM		
TOTAL PROPERTY AREA	0.96 AC	
ZONING SUMMARY		
EXISTING ZONING MX-M		
PROPOSED ZONING	MX-M	
	FRONT:	
LANDSCAPE SETBACKS	SIDE:	
	REAR:	
	FRONT: 5'	
BUILDING SETBACKS	SIDE: 5'/0'	
	REAR: 50'	
PARKING		
PROPOSED VACUUM STALLS 13		
PROPOSED EMPLOYEE STALLS	5	
BUILDING TOWER(S)		
TUNNEL ENTRANCE	YES	
TUNNEL EXIT	YES	

PROPERTY LINE
BUILDING SETBACK LINE
LANDSCAPE SETBACK LINE
EASEMENT
PROPOSED CONCRETE SIDEWALK
PROPOSED LANDSCAPING

PROPOSED CONCRETE
PROPOSED ASPHALT

0 40' 80'



222 E. 5TH STREET TUCSON, AZ 85705 www.mistercarwash.com NM XXXX JUAN TABO 2

1020 JUAN TABO BLVD NE - ALBUQUERQUE, NM 87112

Disclaimer: Property of Mister Car Wash. Not to scale. Not for construction. Verification of site specific conditions and compliance with Federal, State & local building codes is the exclusive responsibility of the Customer and/or Architect & Engineer. These drawings reflect requirements for MISTER CAR WASH ONLY unless otherwise noted. Please refer to other manufacturers, if any, for their requirements.

APPROVED LAYOU	Γ

SITE PLAN

NO:	REVISIONS:	DRAWN BY:	DATE:
•	-	1	-
•	-	-	-
	-	-	-

DRAWN BY:	KL
DATE:	10/28/2024
SCALE:	1"=40'

