



OVERALL PLANTS AND MATERIAL SCHEDULE

TREES	CODE	QTY	BOTANICAL / COMMON NAME	CALIPER	SPACING	AREA	DECIDUOUS OR EVERGREEN
	Gd	2	CHILOPSIS LINEARIS DESERT WILLOW	2" CAL	AS SHOWN ON PLAN	981 SF	DECIDUOUS TREE
	Pg	13	PROSOPIS GLANDULOSA HONEY MESQUITE	2" CAL	25' O.C.	13,738 SF	DECIDUOUS TREE
	Qg	14	QUERCUS GRISEA GRAY OAK	2" CAL	25' O.C.	38,936 SF	DECIDUOUS TREE
	Sm	16	SAMBUCUS MEXICANA MEXICAN ELDER	2" CAL	25' O.C.	38,936 SF	DECIDUOUS TREE
	Up	23	ULMUS PARVIFOLIA LACEBARK ELM	2" CAL	25' O.C.	16,250 SF	DECIDUOUS TREE
	Pe	16	PINUS ELDARICA AFGHAN PINE	2" CAL	25' O.C.	15,543 SF	EVERGREEN TREE
	Pn	19	PINUS NIGRA AUSTRIAN PINE	2" CAL	25' O.C.	16,250 SF	EVERGREEN TREE
SHRUBS	CODE	QTY	BOTANICAL / COMMON NAME	CONTAINER	SPACING	AREA	DECIDUOUS OR EVERGREEN
	Cl	49	CERCOCARPUS LEDIFOLIUS CURLLEAF MOUNTAIN MAHOGANY	8" - 10" HT.	72" O.C.	1,328 SF	EVERGREEN SHRUB
	Fp	87	FALLUGIA PARADOXA APACHE PLUME	1 GAL	60" O.C.	1,590 SF	EVERGREEN SHRUB
	Fp2	35	FALLUGIA PARADOXA APACHE PLUME	5 GAL	72" O.C.	989 SF	EVERGREEN SHRUB
	Lf	69	LEUCOPHYLLUM FRUTESCENS TEXAS RANGER	1 GAL	60" O.C.	1,276 SF	SEMI-EVERGREEN SHRUB
	Lf2	35	LEUCOPHYLLUM FRUTESCENS TEXAS RANGER	5 GAL	72" O.C.	989 SF	SEMI-EVERGREEN SHRUB
	Pps	99	PENSTEMON PSEUDOSPECTABILIS DESERT PENSTEMON	1 GAL	24" O.C.	311 SF	SEMI-EVERGREEN SHRUB
	Pp	101	PENSTEMON PINIFOLIUS PINELAF PENSTEMON	1 GAL	24" O.C.	317 SF	DECIDUOUS SHRUB
	Rw	90	ROSA WOODSII WOODS' ROSE	1 GAL	24" O.C.	283 SF	DECIDUOUS SHRUB
	Cm	81	CHAMAEBATIARIA MILLEFOLIUM FERNBUSH	1 GAL	60" O.C.	1,511 SF	DECIDUOUS SHRUB
	En	35	ERICAMERIA NAUSEOSA CHAMISA	5 GAL	72" O.C.	989 SF	DECIDUOUS SHRUB
	Rt	90	RHUS TRILOBATA THREE-LEAF SUMAC	1 GAL	60" O.C.	1,649 SF	DECIDUOUS SHRUB
	Sw	11	SPOROBOLUS WRIGHTII GIANT SACATON	5 GAL	72" O.C.	311 SF	DECIDUOUS SHRUB
SHRUB AREAS	CODE	QTY	BOTANICAL / COMMON NAME	CONTAINER	SPACING	AREA	DECIDUOUS OR EVERGREEN
	Cs	1,327	CALYLOPHUS SPECIES SUNDROPS	1 GAL	18" O.C.	1,600 SF	DECIDUOUS
	Ps	208	PENSTEMON PSEUDOSPECTABILIS DESERT BEARDTONGUE	1 GAL	36" O.C.	1,650 SF	EVERGREEN
	Sg	200	SALVIA GREGGII AUTUMN SAGE	1 GAL	36" O.C.	1,750 SF	EVERGREEN
GROUND COVERS	CODE	QTY	BOTANICAL / COMMON NAME	CONTAINER	REMARKS		
	Gr	17,050 SF 4.88%	GRAVEL GRAVEL	NA	4" THICK, BROWN COLOR		
	Gr2	29,820 SF 8.53%	GRAVEL2 GRAVEL2	NA	8" THICK, BROWN COLOR		
	Bd2	160,143 SF 45.83%	NATIVE SEED NATIVE SEED	NA	SEE LANDSCAPE SEED SPEC		
	Om	18,791 SF 5.38%	ORGANIC MULCH ORGANIC MULCH	NA			
	Rr	28,048 SF 8.03%	RIVER ROCK RIVER ROCK	NA	3/4" IRONWOOD PEBBLE		
	STEEL EDGER	2,400 LF					

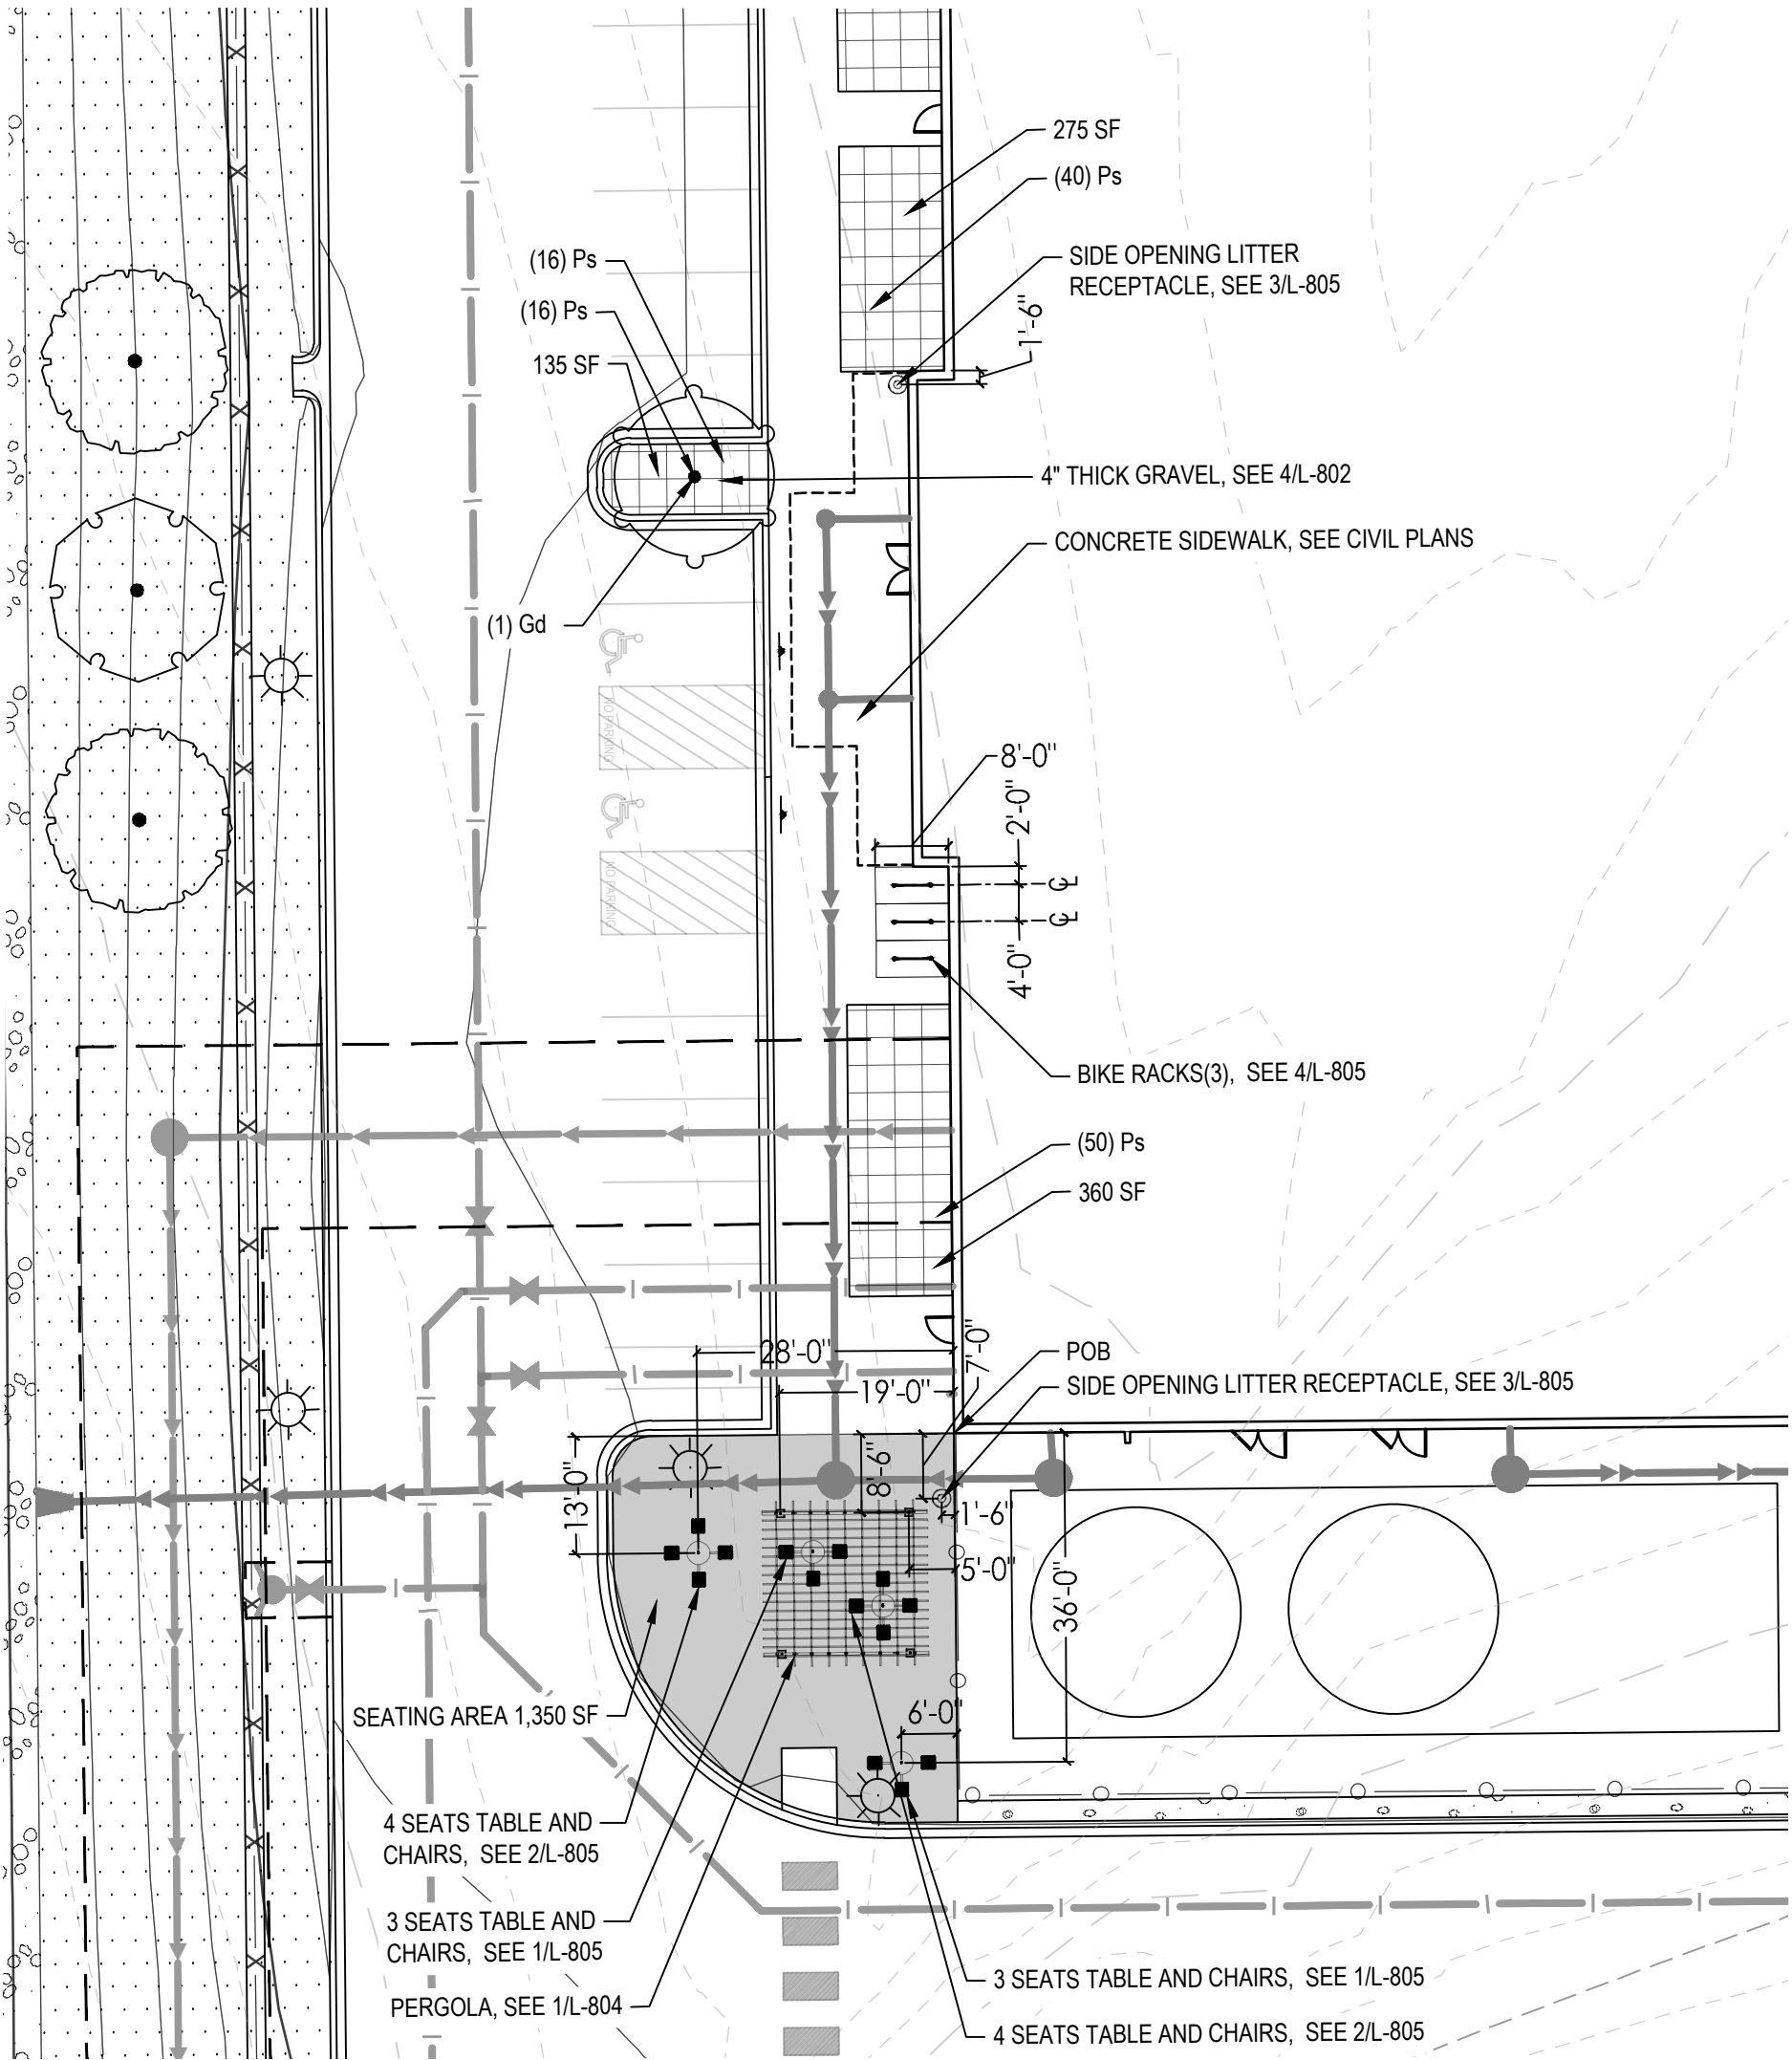

1
L-102
PLAN: ENLARGEMENT PLANTING PLAN
1 inch = 20 ft.

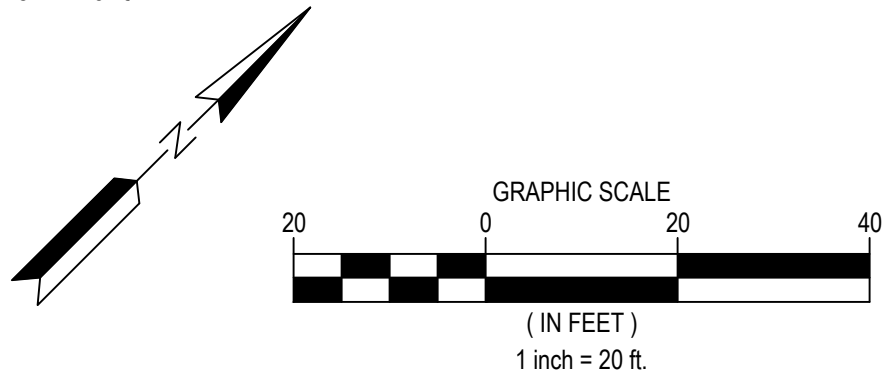

WARNING:
THE CONTRACTOR SHALL BE RESPONSIBLE FOR CALLING FOR LOCATIONS OF ALL EXISTING UTILITIES. THEY SHALL COOPERATE WITH ALL UTILITY COMPANIES IN MAINTAINING THEIR SERVICE AND/OR RELOCATION OF LINES.

THE CONTRACTOR SHALL CONTACT NM11 (811 OR 1-800-321-2537) AT LEAST 2 FULL BUSINESS DAYS IN ADVANCE (EXCLUDING HOLIDAYS AND WEEKENDS) FOR THE LOCATIONS OF ALL UNDERGROUND WIRES, CABLES, CONDUITS, PIPES, MANHOLES, VALVES OR OTHER BURIED STRUCTURES BEFORE DIGGING. THE CONTRACTOR SHALL REPAIR OR REPLACE THE ABOVE WHEN DAMAGED DURING CONSTRUCTION AT NO COST TO THE OWNER.



733 MARQUETTE AVE
SUITE 1000
MINNEAPOLIS, MN 55402
WWW.STANTEC.COM

CLIENT:




ALBUQUERQUE 10 MW
DATA CENTER
DAYTONA RD NW
ALBUQUERQUE, NEW MEXICO 87121

PROJECT TITLE

ISSUE NO.:

DATE	DESCRIPTION	ISSUE NO.
01/08/2024	PRE APPLICATION SUBMITTAL	0
03/08/2024	DRB SUBMITTAL	1
03/20/2024	BID SET	2
05/10/2024	DFT RESUBMITTAL	3
06/03/2024	PERMIT SET	4
06/07/2024	SIDEWALK UPDATE PER ABCNWA	5
09/13/2024	ASB04	6

CERTIFICATION:

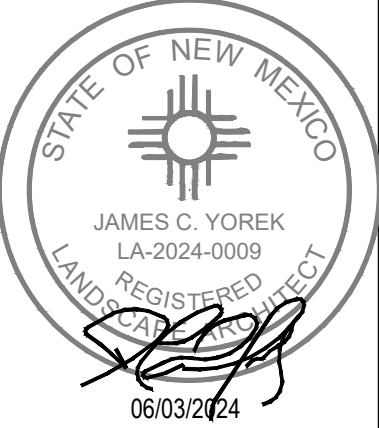

PROJECT NO.: 193806697

DWN BY: SY
CHK'D BY: TH
APP'D BY: CY
ISSUE DATE: 09/13/2024

ISSUE NO.: 6

SHEET TITLE:
ENLARGEMENT
PLANTING PLAN

SHEET NO.:
L-102

INSPECTION AND ACCEPTANCE

- LANDSCAPE WORK WILL BE INSPECTED FOR ACCEPTANCE IN PARTS AGREEABLE TO THE OWNER, PROVIDED WORK OFFERED FOR INSPECTION IS COMPLETE, INCLUDING MAINTENANCE, FOR THE PORTION IN QUESTION.
- AT THE CONCLUSION OF THE ESTABLISHMENT PERIOD, WHICH WILL BE ONE YEAR FOLLOWING INITIAL INSTALLATION, A FINAL INSPECTION OF PLANTING WILL BE MADE TO DETERMINE THE CONDITIONS OF AREAS SPECIFIED FOR LANDSCAPING.
- WHEN INSPECTED LANDSCAPE WORK DOES NOT COMPLY WITH REQUIREMENTS, REPLACE REJECTED WORK AND CONTINUE SPECIFIED MAINTENANCE UNTIL RE-INSPECTED BY OWNER AND FOUND TO BE ACCEPTABLE. REMOVE REJECTED PLANTS AND MATERIALS FROM SITE.

PLANTING NOTES

- CONTRACTOR SHALL PROVIDE STAKED LOCATION OF PLANT MATERIAL PRIOR TO PERFORMING ANY PLANT INSTALLATION WORK. UPON APPROVAL OF STAKING LOCATIONS, CONTRACTOR SHALL EXCAVATE PLANTING HOLES CENTERED AT STAKED LOCATIONS.
- PERFORM PLANT HOLE EXCAVATION AS DETAILED AND TO A DIAMETER A MINIMUM OF TWO TIMES THE DIAMETER OF THE ROOT BALL OR CONTAINER.
- REMOVE STICKS, RUBBISH, FOREIGN MATERIALS AND UNDESIRABLE PLANTS AND THEIR ROOTS. REMOVE STONES MEASURING OVER 1-1/2 INCHES IN ANY DIMENSIONS.
- SET BALLED AND BURLAPPED (B&B) STOCK ON LAYER OF COMPACTED PLANTING SOIL MIXTURE, B&B SHALL BE PLUMB AND IN CENTER OF PIT OR TRENCH WITH TOP OF ALL EXCAVATED EDGES AT SAME ELEVATION AS ADJACENT FINISHED LANDSCAPE GRADES.
- ROOT FLARE OF THE TREE MUST BE ABOVE FINISHED GRADE PER DETAILS.
- CUT ALL CORDS AND TWINE AND REMOVE WIRE BASKET AND BURLAP FROM TOP AND SIDES OF BALLS; RETAIN BURLAP ON BOTTOMS.
- WHEN SET, PLACE ADDITIONAL PLANTING SOIL BACKFILL AROUND BASE AND SIDES OF BALL, AND WORK EACH LAYER TO SETTLE BACKFILL AND ELIMINATE VOIDS AND AIR POCKETS.
- WHEN EXCAVATION IS APPROXIMATELY 2/3 FULL, WATER THOROUGHLY BEFORE PLACING REMAINDER OF BACKFILL.
- REPEAT WATERING UNTIL NO MORE IS ABSORBED. WATER AGAIN AFTER PLACING FINAL LAYER OF BACKFILL.
- FOR CONTAINER GROWN STOCK, SAME AS FOR BALLED AND BURLAPPED STOCK, EXCEPT CUT CONTAINERS ON SIDES INTO QUARTERS WITH SPLIT. REMOVE CONTAINER BEFORE SETTING PLANT SO AS NOT TO DAMAGE ROOT BALLS.
- WATER EACH PLANT WITHIN 2 HOURS OF PLANTING.
- ALL PLANTINGS TO BE MULCHED UNLESS OTHERWISE NOTED ON THE PLAN.
- PLACE 3-INCH THICKNESS OF MULCH AROUND TREES AND SHRUBS WITHIN A PERIOD OF 48 HOURS AFTER THE SECOND WATERING.
- DO NOT PLACE MULCH IN DIRECT CONTACT WITH TRUNKS OR STEMS.
- ROCK MULCH BEDS SHALL RECEIVE 4" DEPTH MIN. LOCALLY AVAILABLE ¾" IRONWOOD PEBBLE ROCK MULCH, OR APPROVED EQUAL, OVER NEEDLE PUNCHED POLYPROPYLENE WEED BARRIER FABRIC. WITHIN GENERATOR COURTYARD AREA, ROCK MULCH BEDS SHALL RECEIVE 8" DEPTH MIN. SEE CIVIL PLANS. SUBMIT MULCH SAMPLE FOR OWNER APPROVAL.
- NEEDLE PUNCHED POLYPROPYLENE WEED BARRIER FABRIC UNDER FABRIC ENDS SHALL BE OVERLAPPED 3 INCHES, MINIMUM 4 ONCE. EDGES OF FABRIC SHALL BE TURNED DOWN 6 INCHES. EDGE RESTRAINT BETWEEN PLANTING BEDS AND SEEDING AREAS SHALL BE BLACK COMMERCIAL GRADE LANDSCAPE EDGING BY COL-MET OR APPROVED EQUAL, 6"x12 GAUGE STEEL.

MAINTENANCE NOTES

- WHEN INSPECTED LANDSCAPE WORK DOES NOT COMPLY WITH REQUIREMENTS, REPLACE REJECTED WORK AND CONTINUE SPECIFIED MAINTENANCE UNTIL RE-INSPECTED BY OWNER AND FOUND TO BE ACCEPTABLE. REMOVE REJECTED PLANTS AND MATERIALS FROM SITE.
- BEGIN MAINTENANCE IMMEDIATELY AFTER PLANTING.
- MAINTAIN TREES AND BUSHES INCLUDING WATERING FOR ONE YEAR AFTER ACCEPTANCE BY OWNER. IT IS CONTRACTORS RESPONSIBILITY FOR COORDINATE WATERING.
- TRIM, PRUNE, REMOVE CLIPPINGS AND DEAD OR BROKEN BRANCHES, AND TREAT PRUNED AREAS AND OTHER WOUNDS.
- IT IS THE CONTRACTOR'S OPTION WHETHER OR NOT TO STAKE TREES. THE CONTRACTOR IS RESPONSIBLE FOR MAINTAINING TREES IN AN UPRIGHT POSITION THROUGHOUT THE ONE-YEAR GUARANTEE PERIOD.

GUARANTEE AND REPLACEMENTS

- PLANT MATERIAL SHALL BE GUARANTEED FOR ONE FULL YEAR AFTER OWNER ACCEPTANCE AND SHALL BE ALIVE AND IN SATISFACTORY CONDITION AT THE END OF THE GUARANTEE PERIOD. SUCH GUARANTEE EXCLUDES VANDALISM.
- AT THE END OF THE ONE-YEAR GUARANTEE PERIOD, INSPECTION WILL BE MADE BY THE OWNER UPON WRITTEN NOTICE BY THE CONTRACTOR AT LEAST FIVE DAYS BEFORE THE ANTICIPATED DATE. ANY PLANT MATERIAL REQUIRED UNDER THE CONTRACT THAT IS DEAD OR NOT IN SATISFACTORY CONDITION, AS DETERMINED BY THE OWNER, SHALL BE REMOVED FROM THE SITE, AND SHALL BE REPLACED AS SOON AS CONDITIONS PERMIT DURING THE NORMAL PLANTING SEASONS.
- THE OPINION OF THE OWNER SHALL GOVERN IN ANY AND ALL DISPUTES BY THE CONTRACTOR REGARDING THE CONDITION AND DISPOSITION OF UNSATISFACTORY MAINTENANCE PROCEDURES OR REJECTED PLANTS.
- ALL REPLACEMENTS SHALL BE PLANT MATERIAL OF THE SAME KIND AND SIZE AS SPECIFIED IN THE PLANT LIST. REPLACEMENT COSTS SHALL BE BORNE BY THE CONTRACTOR.
- REPLACEMENT PLANTINGS REQUIRED AT THE END OF THE GUARANTEE PERIOD ARE NOT TO BE GUARANTEED. THE PLANT MATERIAL IS SUBJECT TO INSPECTION AND REJECTION BY THE OWNER BEFORE AND AFTER PLANTING.

CODES AND INSPECTION

- THE ENTIRE INSTALLATION SHALL FULLY COMPLY WITH ALL LOCAL AND STATE LAWS AND ORDINANCES AND WITH THE ESTABLISHED CODES ALLOCABLE THERETO.
- THE CONTRACTOR SHALL TAKE OUT ALL REQUIRED PERMITS, ARRANGE FOR ALL NECESSARY INSPECTION, AND PAY ANY FEES AND EXPENSES IN CONJUNCTION WITH THE SAME AS PART OF THE WORK UNDER THIS CONTRACT.

QUALITY ASSURANCE

- ALL WORK AND MATERIALS TO BE IN FULL ACCORDANCE WITH LATEST RULES AND REGULATIONS OF THE DIVISION OF INDUSTRIAL SAFETY, THE UNIFORM PLUMBING CODE, NATIONAL ELECTRIC CODE, AMERICANS WITH DISABILITIES, AND OTHER APPLICABLE LAWS OR REGULATION.
- NOTHING IN THESE DRAWINGS OR SPECIFICATIONS IS TO BE CONSTRUED TO PERMIT WORK NOT CONFORMING TO THESE CODES.
- FURNISH, WITHOUT EXTRA CHARGE, ANY ADDITIONAL MATERIAL AND LABOR AS REQUIRED TO COMPLY WITH THESE RULES AND REGULATIONS, THOUGH THE WORK IS NOT MENTIONED IN THESE PARTICULAR CONSTRUCTION DOCUMENTS.

PROTECTION OF EXISTING CONDITIONS

- BECOME ACQUAINTED WITH ALL SITE CONDITIONS. LOCATE EXISTING UTILITIES AND EQUIPMENT TO REMAIN. SHOULD UTILITIES OR OTHER WORK NOT SHOWN ON THE DRAWINGS BE FOUND DURING EXCAVATIONS, PROMPTLY NOTIFY ENGINEER. FAILURE TO DO SO WILL MAKE CONTRACTOR LIABLE FOR ANY AND ALL DAMAGE ARISING FROM OPERATIONS SUBSEQUENT TO DISCOVERY OF SUCH UTILITIES NOT SHOWN ON DRAWINGS.
- TAKE NECESSARY PRECAUTIONS TO PROTECT EXISTING SITE CONDITIONS. REPAIR ANY DAMAGED ITEM TO ITS ORIGINAL CONDITION OR FURNISH AND INSTALL EQUIVALENT REPLACEMENT AT NO ADDITIONAL COST TO OWNER.

COORDINATION

- SCHEDULE AND COORDINATE WORK WITH OTHER TRADES TO FACILITATE WORK AND AVOID CONFLICTS IN CONSTRUCTION SEQUENCE AND EQUIPMENT INSTALLATION.
- REVIEW ENTIRE PLAN SET AND COORDINATE WITH OTHER TRADES AS REQUIRED BY SEQUENCE OF CONSTRUCTION TO ENSURE PROVISION OF MAINLINE AND ELECTRICAL CONDUIT STUB-OUTS AT ALL REQUIRED LOCATIONS.

LANDSCAPE NOTES

- TREES AND SHRUBS SHALL BE PROVIDED IN THE QUANTITY, SIZE, GENUS, SPECIES, AND VARIETY AS CHOSEN BY THE OWNER/OWNER AS LISTED IN THE PLANT SCHEDULE.
- TREES AND SHRUBS SHALL BE HEALTHY, VIGOROUS STOCK, GROWN IN RECOGNIZED NURSERY IN ACCORDANCE WITH GOOD HORTICULTURAL PRACTICE AND FREE OF DISEASE, INSECTS, EGGS, LARVAE, AND DEFECTS.
- OWNER RETAINS THE RIGHT TO INSPECT TREES AND SHRUBS FOR SIZE AND CONDITION OF BALLS AND ROOT SYSTEMS, INSECTS, INJURIES, AND LATENT DEFECTS, AND TO REJECT UNSATISFACTORY OR DEFECTIVE MATERIAL AT ANY TIME DURING PROGRESS OF WORK.
- NURSERY STOCK SHALL BE DELIVERED DIRECTLY FROM NURSERY. HEEL IN IMMEDIATELY UPON DELIVERY IF NOT TO BE PLANTED WITHIN FOUR HOURS, COVERING WITH MOIST SOIL OR MULCH TO PROTECT FROM DRYING. STORE PLANTS IN SHADE AND PROTECT FROM WEATHER.
- PROTECTION FROM EXTREMES IN EXPOSURE AND ROUGH HANDLING SHALL BE PROVIDED FOR ALL PLANT MATERIALS DURING TRANSPORT AND STORAGE.
- THE CONTRACTOR SHALL NOTIFY THE OWNER 48 HOURS PRIOR TO PLANTING SO THAT A MUTUALLY AGREEABLE TIME MAY BE ARRANGED FOR INSPECTION.
- LAY OUT INDIVIDUAL TREE AND SHRUB LOCATIONS WITH STAKES CENTERED AT PROPOSED PLANTING LOCATIONS FOR APPROVAL BY OWNER.
- DO NOT START PLANTING WORK UNTIL LAYOUT IS APPROVED BY THE OWNER.
- THE LANDSCAPE CONTRACTOR MUST PROVE THE OPEN SUB-GRADE OF ALL PLANTING AREAS AFTER THEIR EXCAVATION IS CAPABLE OF INFILTRATING A MINIMUM REQUIREMENT OF 1/4-INCH OF WATER PER HOUR PRIOR TO INSTALLATION OF PLANT MATERIALS, TOPSOIL, IRRIGATION, WEED MAT, AND MULCH. PLANTING AREAS NOT CAPABLE OF MEETING THIS REQUIREMENT SHALL HAVE 4" DIAMETER X 48" DEPTH HOLES AUGURED EVERY 36" ON-CENTER AND FILLED WITH IDOT FREE-DRAINING COARSE FILTER AGGREGATE. RE-TEST SUB-GRADE PERCOLATION FOR COMPLIANCE TO INFILTRATION MINIMUM REQUIREMENT.
- ALL GRADED AREAS OF THE SITE THAT ARE DESIGNATED FOR SHRUBS, TREES AND PERENNIALS SHALL HAVE NO LESS THAN 12" OF IMPORTED TOP SOIL, MEETING IDOT CLASSIFICATIONS FOR PLANTING SOIL FOR TREES, SHRUBS, AND TURF.

LANDSCAPING GENERAL NOTES

- ALL VEGETATION SHALL COMPLY WITH ARTICLE 9-12 AND PARTS 6-1-1 AND 6- 6-2 OF ROA 1994 (POLLEN CONTROL, WATER CONSERVATION LANDSCAPING AND WATER WASTE, AND STREET TREES) AND SECTION 4 OF THE ALBUQUERQUE BERNALILLO COUNTY WATER AUTHORITY (ABCWUA) LEGISLATION AND ORDINANCES (WATER WASTE REDUCTION ORDINANCE) AS APPLICABLE. PER 5-6(C)(4)(g).
- ALL REQUIRED PLANT MATERIALS SHALL BE FREE OF DISEASE AND INSECTS AND SHALL CONFORM TO THE AMERICAN STANDARD FOR NURSERY STOCK (ASNA) OF THE AMERICAN NURSERY AND LANDSCAPE ASSOCIATION. PER 5-6(C)(4)(h).
- ALL VEGETATED MATERIAL REQUIRED BY THIS SECTION 14-16-5-6 SHALL BE PLANTED IN UNCOMPACTED SOIL. PER 5-6(C)(5)(a).
- IF USED, WEED BARRIERS SHALL BE PERMEABLE TO OPTIMIZE STORMWATER INFILTRATION AND PREVENT RUNOFF. PER 5-6(C)(5)(b).
- A MINIMUM OF 2 INCHES OF ORGANIC MULCH IS REQUIRED IN ALL PLANTING AREAS, WITH 3-4 INCHES RECOMMENDED. PER 5-6(C)(5)(d).

PLANTING IN/OVER THE PUBLIC RIGHT-OF-WAY

- ALL PLANTING OF VEGETATED MATERIAL OR INSTALLATION OF ANY LANDSCAPING, BUFFERING, OR SCREENING MATERIAL IN THE PUBLIC RIGHT-OF-WAY SHALL REQUIRE THE PRIOR APPROVAL OF THE CITY. THE PROPERTY OWNER SHALL BE RESPONSIBLE FOR THE MAINTENANCE, REPAIRS, OR LIABILITY FOR ALL THE LANDSCAPING PLACED IN OR OVER THE PUBLIC RIGHT-OF-WAY. PER 5-6(C)(9)(a).
- ANY TREES THAT OVERHANG A PUBLIC SIDEWALK OR MAJOR PUBLIC OPEN SPACE SHALL BE TRIMMED TO MAINTAIN AN 8-FOOT CLEARANCE OVER THE SIDEWALK. ANY TREES THAT OVERHANG A PUBLIC STREET SHALL BE TRIMMED TO MAINTAIN A 9-FOOT CLEARANCE OVER THE STREET SURFACE. PER 5-6(C)(9)(b).
- WHERE LANDSCAPING IS INSTALLED IN THE PUBLIC RIGHT-OF-WAY, THE APPLICANT SHALL INSTALL AN ADEQUATE IRRIGATION SYSTEM THAT MEETS THE MINIMUM TECHNICAL REQUIREMENTS IN ARTICLE 6-6 OF ROA 1994 (TREES, VEGETATION AND LANDSCAPING) AND THE DPM, WITH A SEPARATE METER FOR THE LANDSCAPE AREA IN THE PUBLIC RIGHT-OF-WAY, OR A SEPARATE VALVE(S) AT THE PROPERTY LINE ALLOWING ISOLATION OF THE IRRIGATION TO THE LANDSCAPE WITHIN THE PUBLIC RIGHT-OF-WAY. DRIP IRRIGATION SYSTEMS AND ARTIFICIAL TURF SHALL NOT BE ALLOWED WITHIN THE PUBLIC RIGHT-OF-WAY. PER 5-6(C)(9)(c).

IRRIGATION SYSTEMS

- IRRIGATION SYSTEMS SHALL COMPLY WITH SECTION 8 OF THE ABCWUA LEGISLATION AND ORDINANCES (CROSS CONNECTION PREVENTION AND CONTROL ORDINANCE). PER 5-6(C)(14)(a).
- ALL IRRIGATION SYSTEMS SHALL BE DESIGNED TO MINIMIZE THE USE OF WATER. PER 5-6(C)(14)(b).
- ALL NON-RESIDENTIAL LANDSCAPE IRRIGATION SHALL HAVE AUTOMATIC TIMERS AND/OR PROGRAMMABLE SETTINGS TO AVOID OVERWATERING. PER 5-6(C)(14)(c).
- THE IRRIGATION SYSTEM SHALL NOT SPRAY OR IRRIGATE IMPERVIOUS SURFACES, INCLUDING SIDEWALKS, DRIVEWAYS, DRIVE AISLES, STREETS, AND PARKING AND LOADING AREAS. PER 5-6(C)(14)(d).

INSTALLATION

- ANY DAMAGE TO UTILITY LINES RESULTING FROM THE NEGLIGENCE OF THE ABUTTING PROPERTY OWNER OR THE PROPERTY OWNER'S AGENTS OR EMPLOYEES IN THE INSTALLATION AND MAINTENANCE OF ANY LANDSCAPING, SCREENING, OR BUFFERING IN A PUBLIC RIGHT-OF-WAY, PRIVATE WAY, OR EASEMENT SHALL BE THE RESPONSIBILITY OF SUCH PROPERTY OWNER. ANY DAMAGE TO UTILITY LINES RESULTING FROM THE GROWTH OF PLANT MATERIALS THAT HAVE BEEN APPROVED BY THE APPLICABLE PUBLIC UTILITY AS PART OF A PLAN FOR LANDSCAPING, SCREENING, OR BUFFERING ON THE PUBLIC RIGHT OF WAY SHALL BE THE RESPONSIBILITY OF SUCH PUBLIC UTILITY. IF A PUBLIC UTILITY DISTURBS LANDSCAPING, SCREENING, OR BUFFERING IN A PUBLIC RIGHT-OF-WAY, PRIVATE WAY, OR EASEMENT, IT SHALL MAKE EVERY REASONABLE EFFORT TO PRESERVE THE LANDSCAPING MATERIALS AND RETURN THEM TO THEIR PRIOR LOCATIONS AFTER THE UTILITY WORK. IF THE PLANT MATERIALS DIE DESPITE THOSE EFFORTS, IT IS THE OBLIGATION OF THE ABUTTING PROPERTY OWNER TO REPLACE THE PLANT MATERIALS. PER 5-6(C)(15)(c).
- PROPERTY OWNERS ACKNOWLEDGE THAT APPROVED LANDSCAPING AND TREES INSTALLED AND MAINTAINED IN A PUBLIC RIGHT-OF-WAY, PRIVATE WAY, OR EASEMENT ABUTTING PRIVATE PROPERTIES ARE THE PROPERTY OF THE CITY, AND THAT THAT THE CITY RESERVES THE RIGHT TO REMOVE THEM IF NECESSARY FOR A TRANSPORTATION PROJECT WITHOUT COMPENSATION, BUT AT NO COST TO THE PROPERTY OWNER. LANDSCAPING INSTALLED IN AN ABUTTING PUBLIC RIGHT-OF-WAY, PRIVATE WAY, OR EASEMENT BY PROPERTY OWNERS AND LATER REMOVED BY THE CITY SHALL NOT IMPACT PREVIOUSLY APPROVED NET LOT AREA CALCULATIONS FOR REQUIRED LANDSCAPING. PER 5-6(C)(15)(d).

IRRIGATION CONTRACTORS RESPONSIBILITY

- THE IRRIGATION SYSTEM CONTRACTOR SHALL BE RESPONSIBLE FOR THE FOLLOWING:
- AN AUTOMATIC IRRIGATION SYSTEM SHALL BE PROVIDED FOR THE LANDSCAPE IMPROVEMENTS.
 - AUTOMATIC CONTROL VALVES SHALL BE RAIN BIRD PEB PLASTIC BODY AUTOMATIC VALVE OR AS APPROVED BY THE CITY DEPARTMENT RESPONSIBLE FOR MAINTENANCE.
 - ALL VALVES SHALL BE INSTALLED IN VALVE BOXES PER CITY OF ALBUQUERQUE STANDARD SPECIFICATIONS FOR PUBLIC WORKS CONSTRUCTION (CITY STANDARD SPECIFICATIONS).
 - VALVE BOXES SHALL BE LOCATED SO EDGE OF VALVE BOX IS MINIMUM TWO FEET FROM THE EDGE OF THE MATURE SPREAD OF A SHRUB AND MINIMUM SIX FEET FROM THE EDGE OF A TREE ROOT BALL.
 - VALVE BOXES AND LIDS SHALL BE TAN COLOR.
 - A MINIMUM OF 36 INCHES SHALL BE PROVIDED BETWEEN ADJACENT VALVE BOXES.
 - IRRIGATION SYSTEM SHALL BE A BUBBLER SYSTEM. DRIP AND/OR SPRAY IRRIGATION IS NOT ACCEPTABLE. BUBBLERS SHALL BE PROVIDED AS FOLLOWS:
 - TREE: 3 EACH 1.0 GALLON PER MINUTE (GPM) BUBBLERS
 - VERTICAL SHRUB: 2 EACH 0.5 GPM BUBBLERS
 - SHRUB: 1 EACH 0.5 GPM BUBBLER
 - YUCCA AND OTHER VERY LOW WATER-USE SHRUBS: 1 EACH 0.25 BUBBLER
 - BUBBLERS SHALL BE LOCATED 3 FEET FROM THE CENTER OF THE TREE TRUNK, TRIANGULATED AROUND THE ROOT BALL.
 - WHERE A TREE IS LOCATED ON A SLOPE, TWO (2) OF THE BUBBLERS SHALL BE LOCATED ON THE HIGH SIDE OF THE TREE.
 - IF A LANDSCAPED AREA IS TOO NARROW TO TRIANGULATE 3 BUBBLERS AROUND THE ROOT BALL, TWO (2) BUBBLERS SHALL BE INSTALLED, ONE ON EACH SIDE OF THE ROOT WHERE A TREE IS LOCATED ON A SLOPE, THE 2 BUBBLERS SHALL BE LOCATED ON THE HIGH SIDE OF THE TREE.
 - BUBBLERS SHALL BE LOCATED 12 INCHES TO 18 INCHES FROM THE CENTER OF THE WHERE A SHRUB IS LOCATED ON A SLOPE. BUBBLERS SHALL BE LOCATED ON THE HIGH SIDE OF THE SHRUB.
 - WHERE THERE ARE SIGNIFICANT CHANGES IN ELEVATION, IN-LINE CHECK VALVES SHALL BE INSTALLED ON LATERAL LINES AS REQUIRED TO EVENLY DISTRIBUTE LOW HEAD DRAINAGE.
 - AN AIR RELIEF VALVE SHALL BE INSTALLED AT EACH HIGH POINT ON THE MAIN LINE.
 - THE IRRIGATION SYSTEM SHALL BE INDEPENDENT OF OTHER PROPERTIES AND SHALL HAVE DEDICATED UTILITIES. IRRIGATION SYSTEM SHALL CONNECT TO A PUBLIC WATER SYSTEM NON-POTABLE LINE IF AVAILABLE AND IF RELIABLY CHARGED.
 - THE IRRIGATION SYSTEM SHALL HAVE A CROSS CONNECTION DEVICE, INSTALLED AND LOCATED IN ACCORDANCE WITH CITY AND ABCWUA STANDARDS.
 - BACKFLOW PREVENTER ENCLOSURE SHALL BE A "HOT ROK" OR EQUALLY INSULATED ENCLOSURE, WITH HEAT TAPE AND ELECTRICAL POWER, HINGED LID, CLASP FOR LOCK, AND L-SHAPED METAL CLASP REINFORCEMENT. BACKFLOW PREVENTER AND ENCLOSURE SHALL BE INSTALLED IN ACCORDANCE WITH CITY STANDARD SPECIFICATIONS.
 - IRRIGATION CONTROLLER SHALL BE PROVIDED IN ACCORDANCE WITH CURRENT CITY STANDARD SPECIFICATIONS AND AS APPROVED BY THE CITY DEPARTMENT RESPONSIBLE FOR MAINTENANCE.
 - IRRIGATION CONTROLLER SHALL BE INSTALLED IN A UL-RATED ENCLOSURE PER CITY STANDARD SPECIFICATIONS OR AS APPROVED BY THE CITY DEPARTMENT RESPONSIBLE LAST PRINTED: SEPTEMBER 4, 2020 LANDSCAPE AND IRRIGATION 11-5 D M FOR MAINTENANCE. ENCLOSURE SHALL BE POWDER COATED, COLOR TAN. ENCLOSURE SHALL BE MOUNTED ON A 6 INCHES THICK SLAB OF CONCRETE WITH 4 INCHES WIDE LIP ON ALL SIDES, SLOPED AWAY FROM THE CONTROLLER ENCLOSURE.
 - A MASTER VALVE AND FLOW SENSOR SHALL BE PROVIDED AND INSTALLED PER CITY STANDARD SPECIFICATIONS. COMMUNICATION WIRE FOR THE FLOW SENSOR SHALL BE BLACK COMMUNICATION CABLE (WITH INTERNAL CONTROL WIRE AND GROUND) DEDICATED TO THE FLOW SENSOR.
 - ELECTRIC SERVICE SHALL BE PROVIDED TO THE IRRIGATION CONTROLLER AND BACKFLOW PREVENTER OR AS APPROVED BY THE CITY DEPARTMENT RESPONSIBLE FOR MAINTENANCE.
 - THE IRRIGATION CONTROLLER, BACKFLOW PREVENTER, AND RELATED EQUIPMENT SHALL BE LOCATED ADJACENT TO THE DESIGNATED MAINTENANCE PARKING PAD ON THE SIDE OF ONCOMING TRAFFIC.
 - MAIN LINE AND LATERAL LINES SHALL BE LOCATED A MINIMUM OF 5 FEET AWAY FROM TRUNKS OF TREES.
 - ONE BUBBLER SHALL BE INSTALLED AT EACH GROUNDING ROD AT THE IRRIGATION CONTROLLER.

LANDSCAPING, BUFFERING, AND SCREENING

- LANDSCAPING, SCREENING AND BUFFERING AREAS SHALL BE MAINTAINED IN COMPLIANCE WITH ARTICLES 6-6 AND 9-8 OF ROA 1994 (TREES, VEGETATION, AND LANDSCAPING AND WEEDS, LITTER, AND SNOW) AND SECTION 4 OF THE ALBUQUERQUE BERNALILLO COUNTY WATER AUTHORITY (ABCWUA) LEGISLATION AND ORDINANCES (WATER WASTE REDUCTION ORDINANCE). PER 5-13(B)(7)(a) ALL LANDSCAPED AREAS SHALL BE MAINTAINED WITH A NEAT AND ORDERLY APPEARANCE, WHICH INCLUDES PRUNING, REMOVAL AND REPLACEMENT OF DEAD OR DISEASED PLANTS AND TREES, DISPOSAL OF LITTER, REPAIR OF DAMAGED WALLS AND HARD SURFACE AREAS, AND UPKEEP OF IRRIGATION SYSTEMS. PER 5-13(B)(7)(b).
- WHERE LANDSCAPING WAS INSTALLED PURSUANT TO A SITE PLAN OR DEVELOPMENT APPROVAL, THE LANDSCAPING SHALL BE REPLACED ACCORDING TO ANY LANDSCAPING AND MAINTENANCE PLAN UNDER THAT APPROVAL. PER 5-13(B)(7)(d).
- TREES OR PLANTS THAT DIE SHALL BE REPLACED BY THE OWNER AS EXPEDITIOUSLY AS POSSIBLE, BUT IN NO CASE LONGER THAN 60 CALENDAR DAYS AFTER NOTICE FROM THE CITY. THE REPLACEMENT OF DEAD VEGETATION IS THE RESPONSIBILITY OF THE PROPERTY OWNER. PER 5-13(B)(7)(e).
- STREET TREES SHALL BE MAINTAINED ALIVE AND HEALTHY. MAINTAINING AND REPLACING STREET TREES OR OTHER TREES PLANTED IN THE PUBLIC RIGHT-OF-WAY ARE THE RESPONSIBILITY OF ABUTTING PROPERTY OWNERS. PER 5-13(B)(7)(f).

LANDSCAPE REQUIREMENTS

A. GENERAL LANDSCAPE REQUIREMENT: Part 14-16-5 Development Standards, 5-6(C)				
NET LOT AREA(SF)	PERCENTAGE OF COVERAGE	REQUIRED LANDSCAPE AREA(SF)	PROPOSED LANDSCAPE AREA(SF)	
437,408	15%	65,611	TREES	77,421 22.16%
			SHRUBS	11,817 3.38%
			GROUNDCOVER (PLANTING MATERIAL)	5,000 1.43%
			GROUNDCOVER (GRAVEL OR CRUSHER)	74,918 21.44%
			SEED	160,143 45.83%
			ORGANIC MULCH	18,791 5.38%
			OUTDOOR SEATING AREA	1,350 0.39%
			TOTAL	349,439 100%
REQUIRED LANDSCAPE AREA(SF)	PERCENTAGE OF COVERAGE*	REQUIRED VEGETATIVE COVERAGE AREA(SF)	PROPOSED VEGETATIVE COVERAGE AREA(SF)	
65,611	75%	55,772	94,237	
PROPOSED VEGETATIVE COVERAGE AREA(SF)	PERCENTAGE OF COVERAGE**	REQUIRED GROUND-LEVEL PLANTS AREA(SF)	PROPOSED GROUND-LEVEL PLANTS AREA(SF)	
55,772	25%	13,943	16,817	
PROPOSED TREE SPECIES	QUANTITY	AREA (SF)	WATER USE	
DESERT WILLOW	2	981	LOW TO MEDIUM	
AFGHAN PINE	16	11,304	LOW	
AUSTRIAN PINE	19	9,322	LOW	
HONEY MESQUITE	13	9,185	LOW	
GRAY OAK	14	9,891	LOW TO MEDIUM	
MEXICAN ELDER	16	7,850	LOW TO MEDIUM	
LACEBARK ELM	23	28,888	LOW TO MEDIUM	
TOTAL QUANTITY AND COVERAGE AREA	103	77,421		
PROPOSED SHRUBS SPECIES	QUANTITY	AREA (SF)	WATER USE	
CURLLEAF MOUNTAIN MAHOG	47	1,328	LOW	
FERNBUSH	80	1,570	LOW	
CHAMISA	35	989	LOW	
APACHE PLUME (1 GAL)	88	1,727	LOW	
APACHE PLUM (5 GAL)	35	989	LOW	
TEXAS RANGER (1 GAL)	65	1,276	LOW	
TEXAS RANGER (5 GAL)	35	989	LOW	
PINELEAF PENSTEMON	101	317	LOW	
DESERT PENSTEMON	99	311	LOW	
THREE-LEAF SUMAC	88	1,727	LOW	
WOODS' ROSE	90	283	LOW	
GIANT SACTAGON	11	311	LOW	
TOTAL QUANTITY AND COVERAGE AREA	774	11,817		
PROPOSED GROUNDCOVER SPECIES	QUANTITY	AREA (SF)	WATER USE	
SUNDROPS	1327	1,600	LOW	
DESERT BEARDTONGUE	208	1,650	LOW	
AUTUMN SAGE	200	1,750	LOW	
TOTAL QUANTITY AND COVERAGE AREA	1735	5,000		

5-6(C)(2)

A minimum of 15 percent of the net lot area of each development shall contain landscaping.

The mature realistic spread of trees and shrubs will be used to calculate required vegetative coverage as follows.

*1. Tree canopies and ground-level plants shall cover a minimum of 75 percent of the total landscape area as measured by canopy width or the area beneath the drip-line of the mature size of the actual vegetation.

**2. Of the required vegetative coverage, a minimum of 25 percent shall be provided as ground-level plants (shrubs, grasses, etc.) as measured of the mature size of the actual vegetation. (See figure below.)

5-6(C)(4) A minimum of 5 species must be used in the landscaped area.


Only trees and shrubs selected from the Official Albuquerque Plant Palette of low water use, drought tolerant, or xeric species and shown on a landscape plan can count toward the requirements of this Subsection 14-16-5-6(C) (General Landscaping Standards).

5-6(C)(4) Required Plant Materials and Site Amenities


1. A minimum of 5 species must be used in the landscaped area.

B. STREET FRONTAGE LANDSCAPING REQUIREMENT: Part 14-16-5 Development Standards, 5-6(D)									
I-40 STREET FRONTAGE (L.F.), EXISTING INTERSTATE					853				
TREES REQUIRED:		853	/	25 L.F. =	35				
EXISTING STREET TREES PROVIDED :					-				
PROPOSED TREE SPECIES		QTY.	CALIPER		PROPOSED SHRUB SPECIES		QTY.	CONTAINER	
AFGHAN PINE		16	2"		CURLLEAF MOUNTAIN MAHOGANY		36	5 GAL.	
AUSTRIAN PINE		19	2"		CHAMISA		35	5 GAL.	
PROPOSED STREET TREES PROVIDED :		35		APACHE PLUME		35	5 GAL.		
TOTAL STREET TREES PROVIDED :		35		TEXAS RANGER		35	5 GAL.		
					TOTAL SHRUBS PROVIDED :		141		
DAYTONA RD. NW STREET FRONTAGE (L.F.), PROPOSED MAJOR COLLECTOR					730				
TREES REQUIRED:		730	/	25 L.F. =	30				
EXISTING STREET TREES PROVIDED :					-				
PROPOSED TREE SPECIES		QTY.	CALIPER		PROPOSED SHRUB SPECIES		QTY.	CONTAINER	
HONEY MESQUITE		7	2"		FERNBUSH		34	1 GAL.	
GRAY OAK		8	2"		APACHE PLUME		42	1 GAL.	
MEXICAN ELDER		8	2"		TEXAS RANGER		30	1 GAL.	
LACEBARK ELM		8	2"		PINELEAF PENSTEMON		101	1 GAL.	
PROPOSED STREET TREES PROVIDED :		31		DESERT PENSTEMON		99	1 GAL.		
TOTAL STREET TREES PROVIDED :		31		THREE-LEAF SUMAC		40	1 GAL.		
				WOOD'S ROSE		90	1 GAL.		
					TOTAL SHRUBS PROVIDED :		436		
*All development shall comply with Part 6-6-2 of ROA 1994 (Street Trees) and any standards developed by the Parks and Recreation Department or other City department to implement that Ordinance. Trees are generally required along street frontages every 25 feet on center unless specified otherwise in Part 6-6-2 of ROA 1994 (Street Trees). Along street frontages where street trees are required, trees that are planted within 20 feet of the back of curb of the abutting street may fulfill this requirement.									


C. PARKING LOT LANDSCAPING: Part

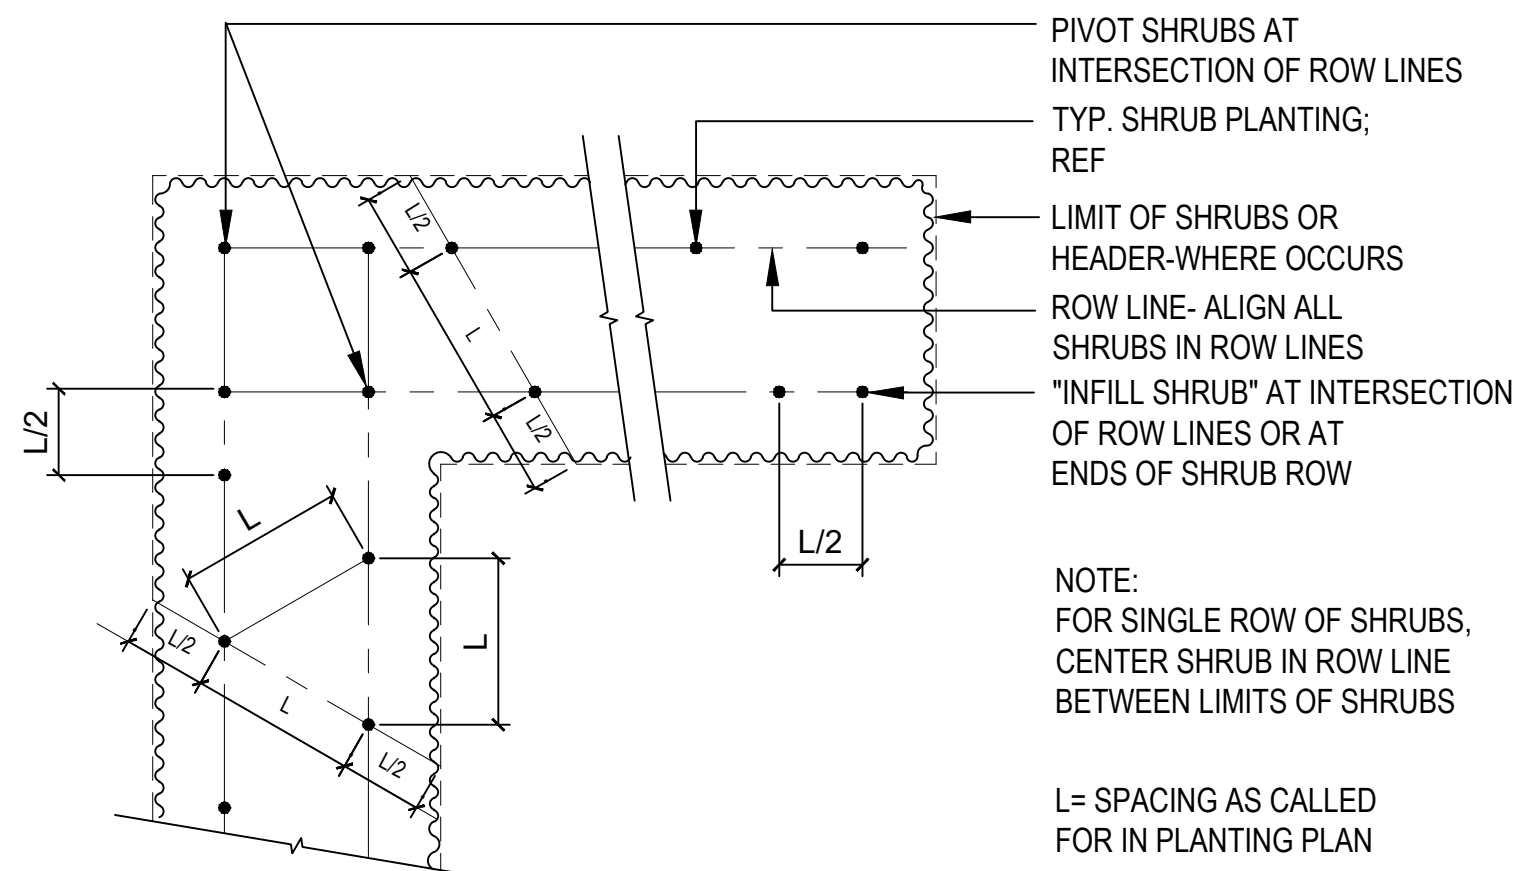

L-802 / NOT TO SCALE

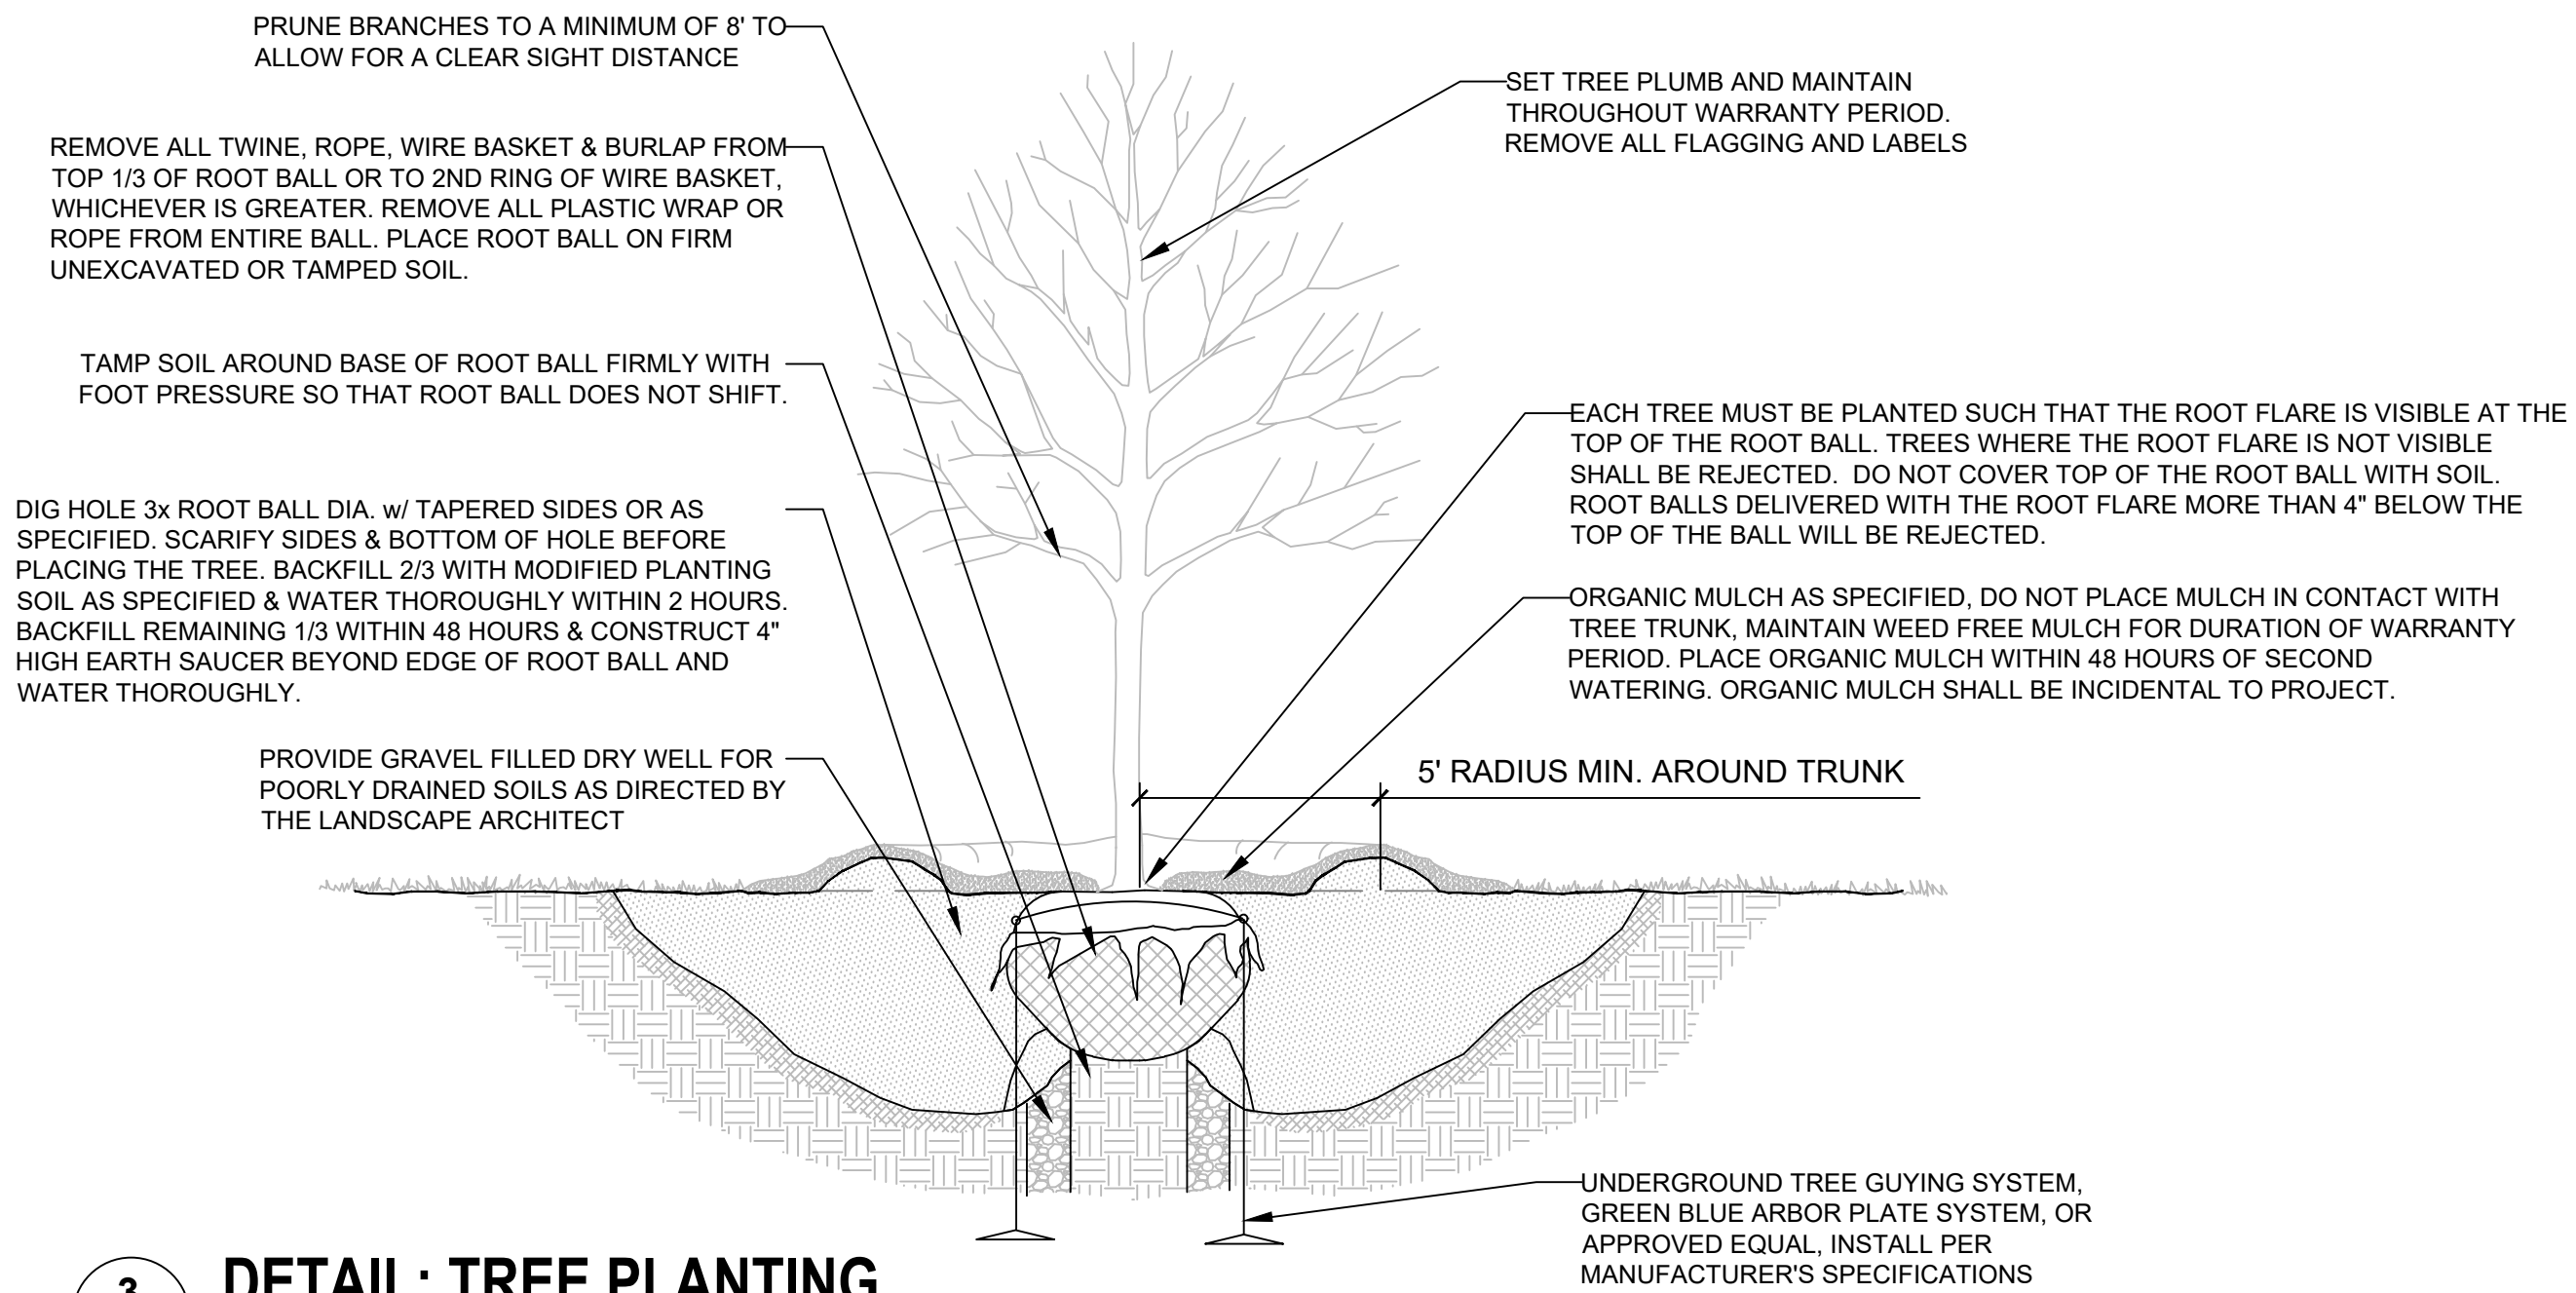

(L-802) NOT TO SCALE

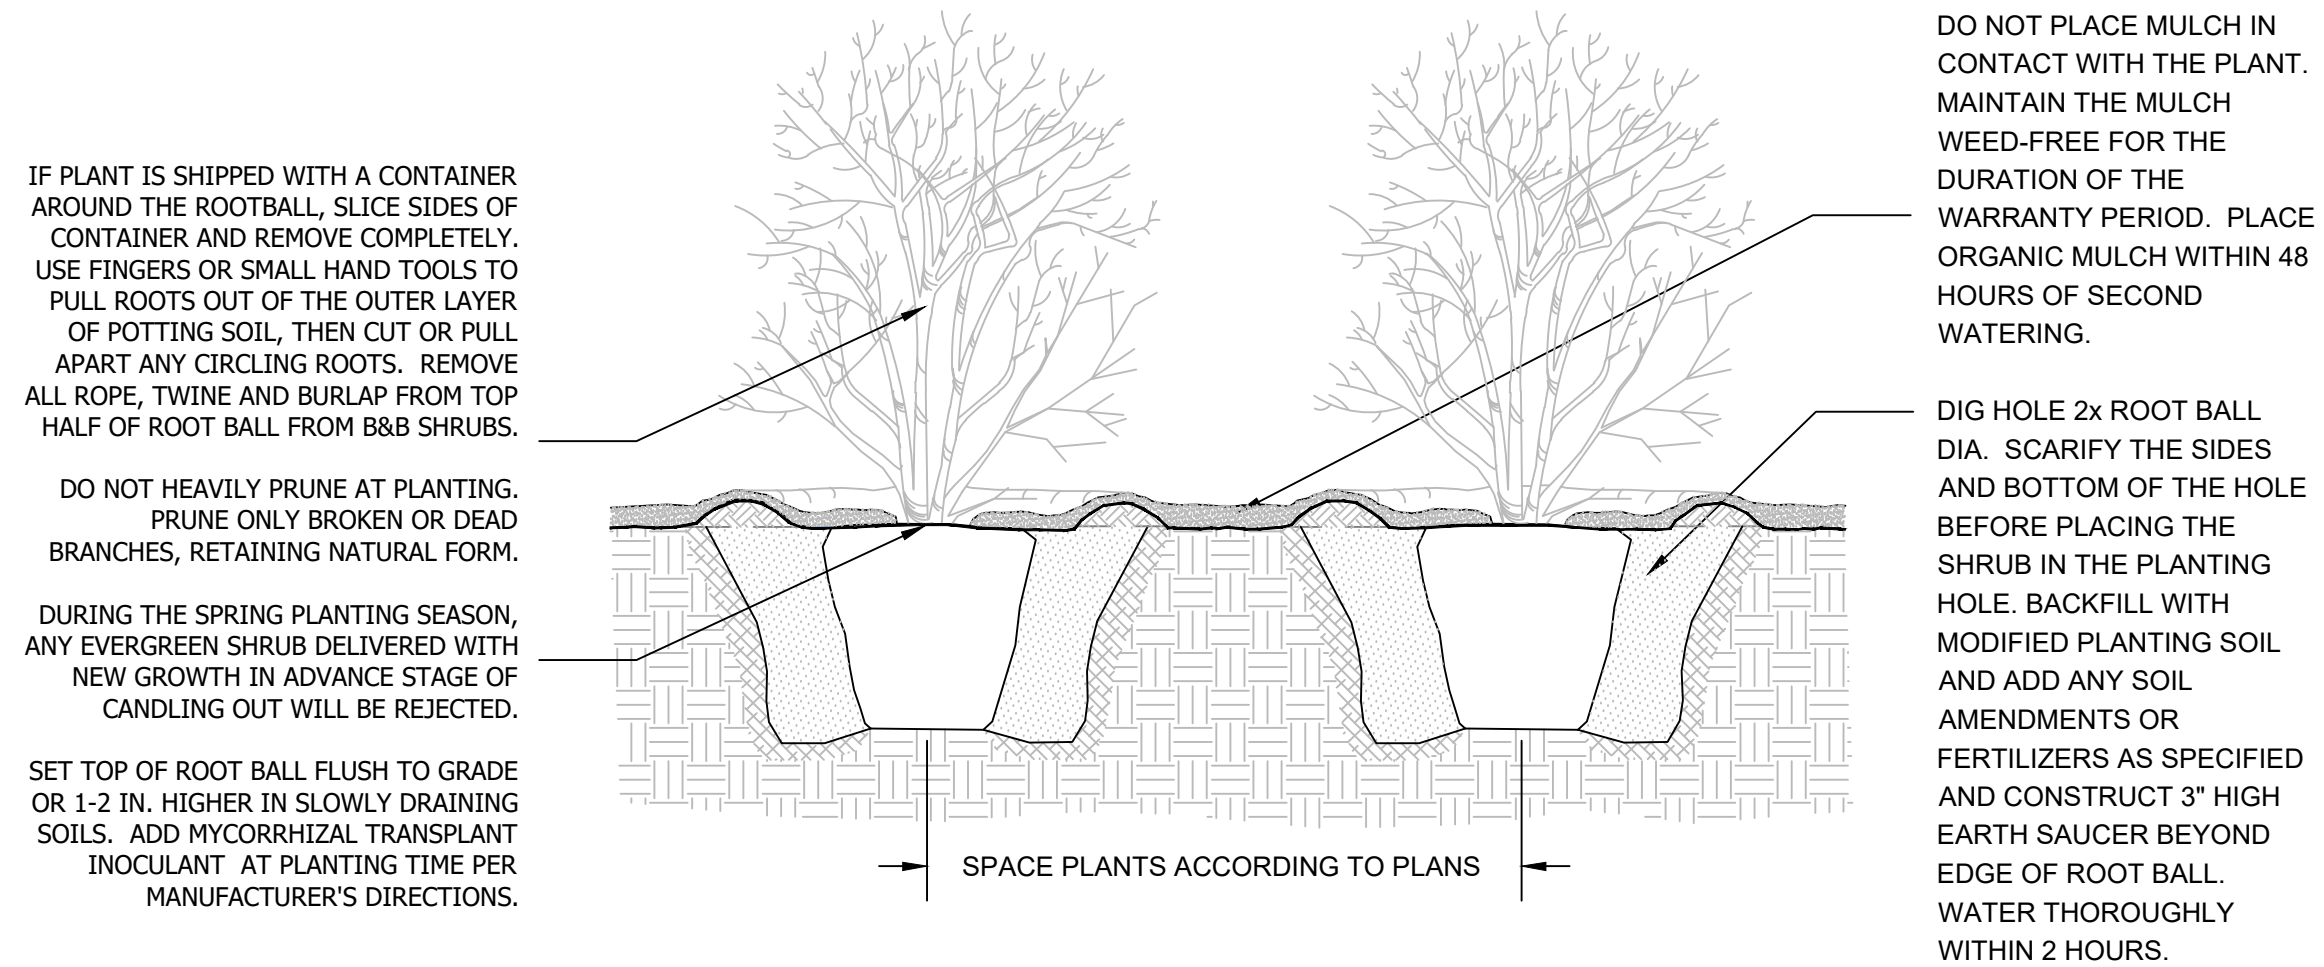

(L-802) NOT TO SCALE



DATE	DESCRIPTION	ISSUE NO.	PROJECT TITLE
01/08/2024	PRE APPLICATION SUBMITTAL	0	PROJECT ALPHA
03/08/2024	D88 SUBMITTAL	1	
03/01/2024	BID SET	2	
05/10/2024	DF1 RESUBMITTAL	3	
08/03/2024	PERMIT SET	4	
08/01/2024	SIDEWALK UPDATE PER ABCNWA	5	
09/15/2024	ASH-004	6	




PROJECT NO.: 193806697		
DWN BY: SY	CHK'D BY: TH	APP'D BY: CY
ISSUE DATE:		09/13/2024

ISSUE NO.:	6
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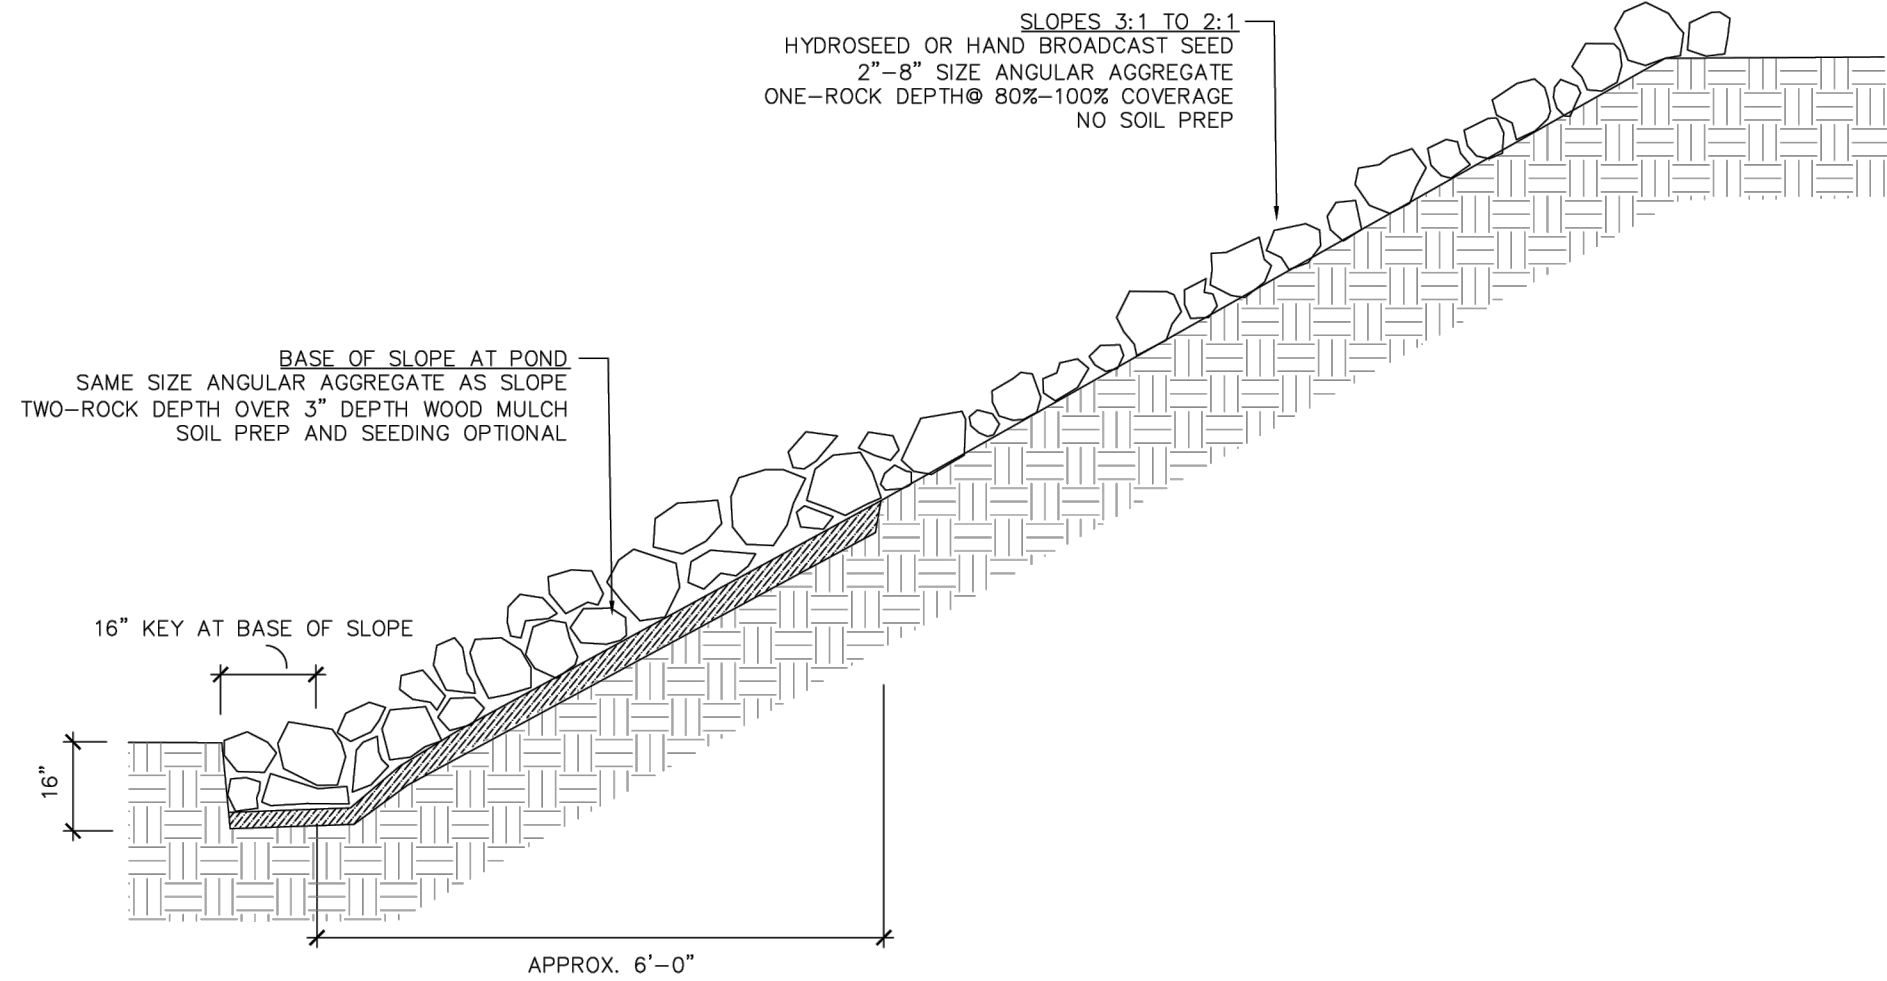
SHEET TITLE:

LANDSCAPE DETAILS


SHEET NO.:
L-802

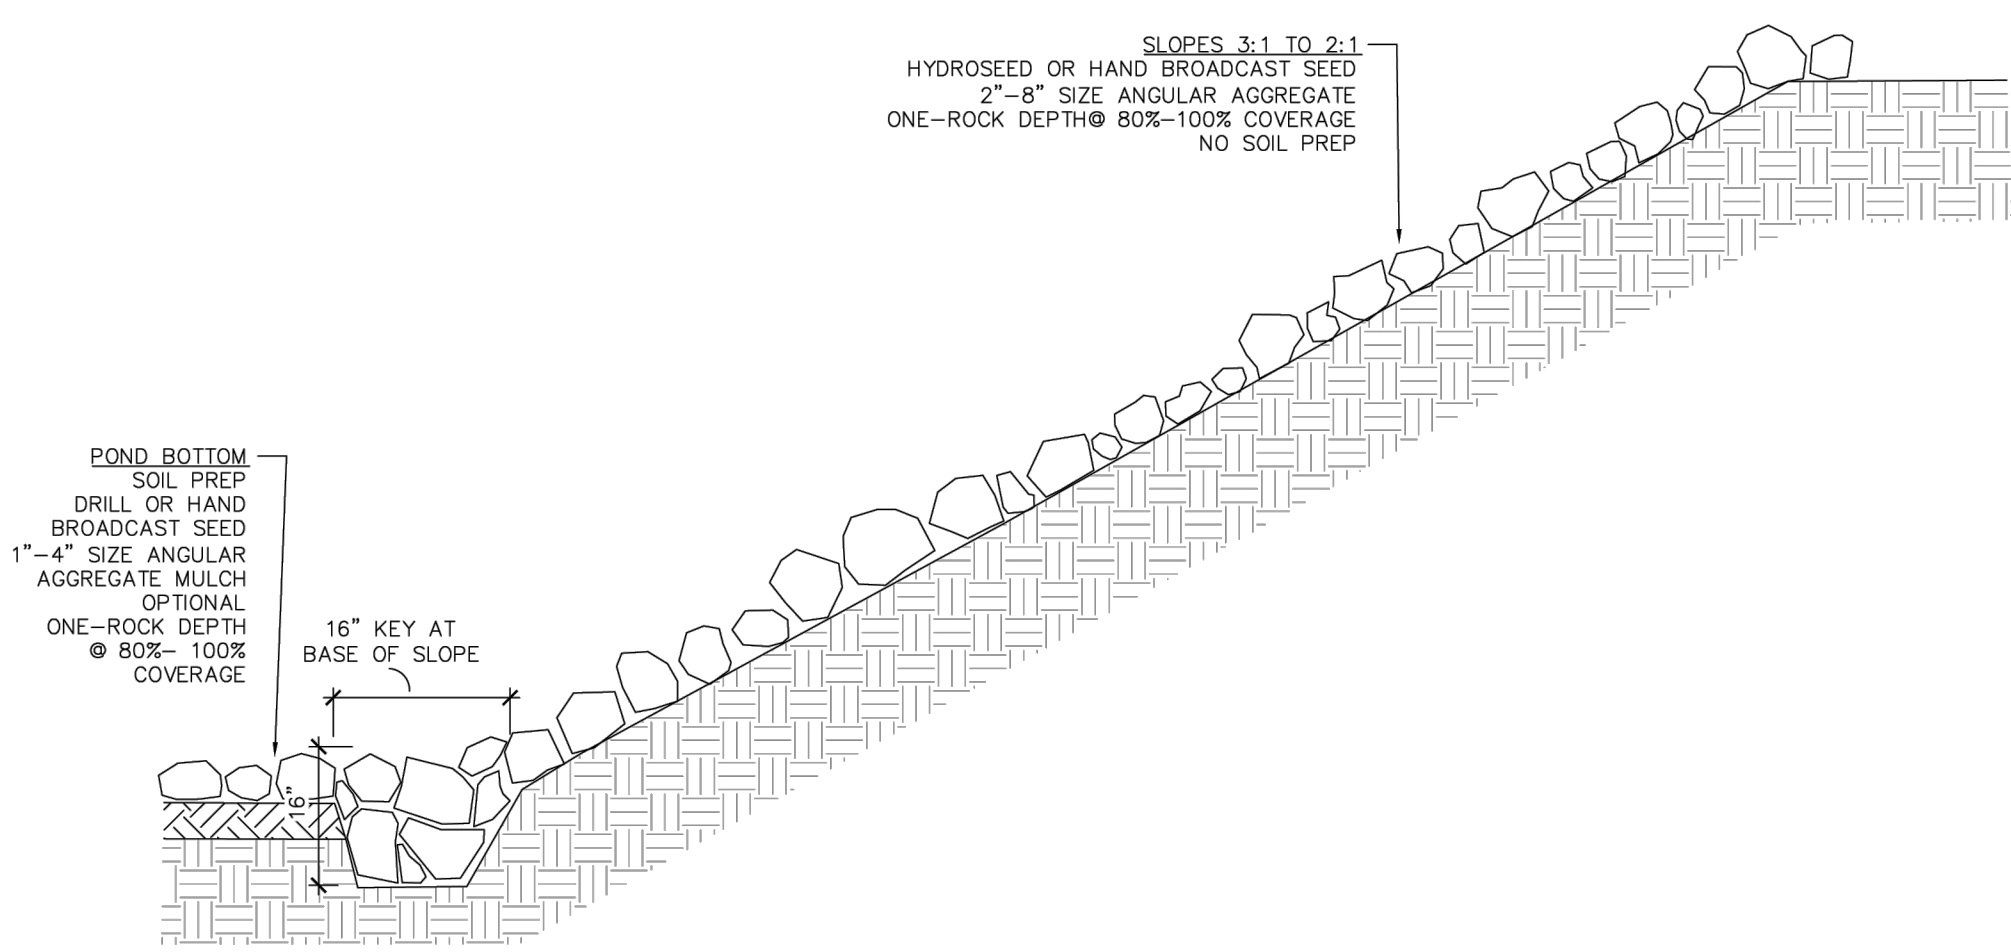


A4 SLOPES 3:1 TO 2:1, PRIVATE PONDS
SCALE: N.T.S.



A2 1013-SKL-2: SLOPES 3:1 TO 2:1
SCALE: N.T.S.

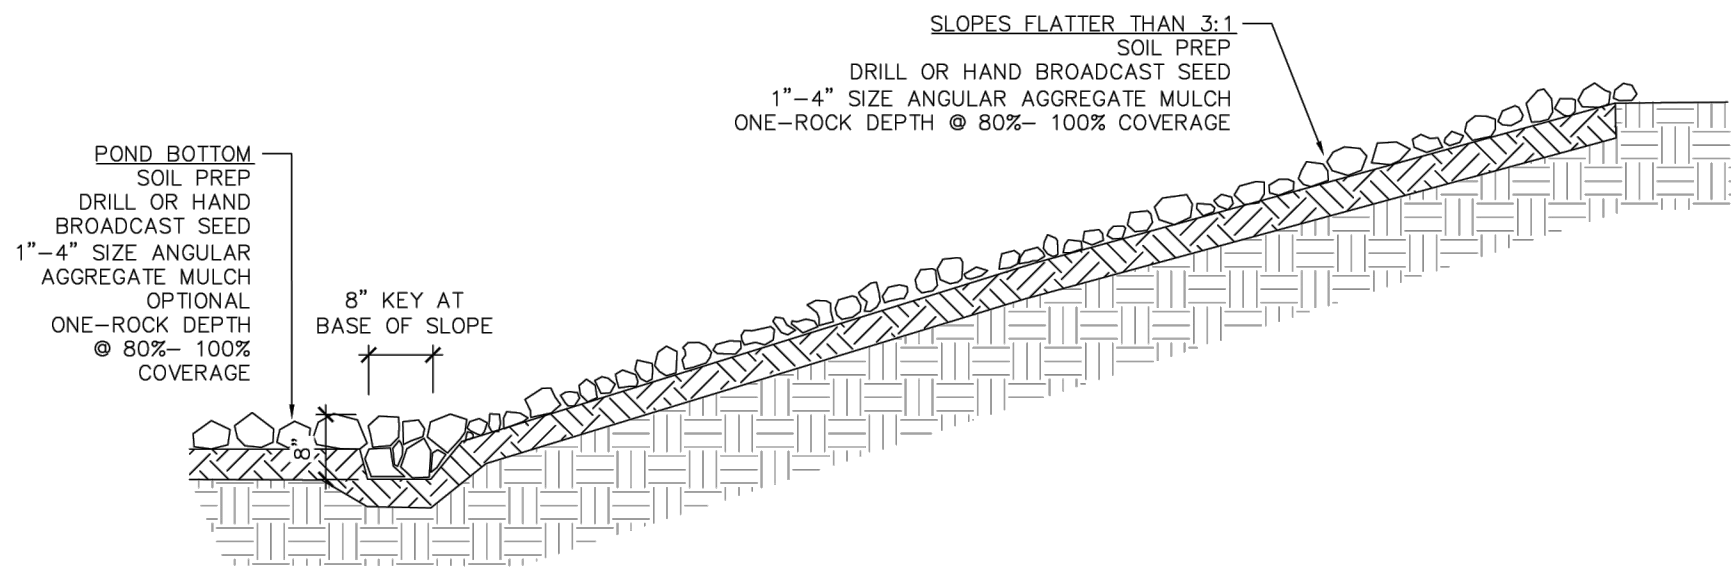

A3 SLOPES FLATTER THAN 3:1, PRIVATE PONDS
SCALE: N.T.S.

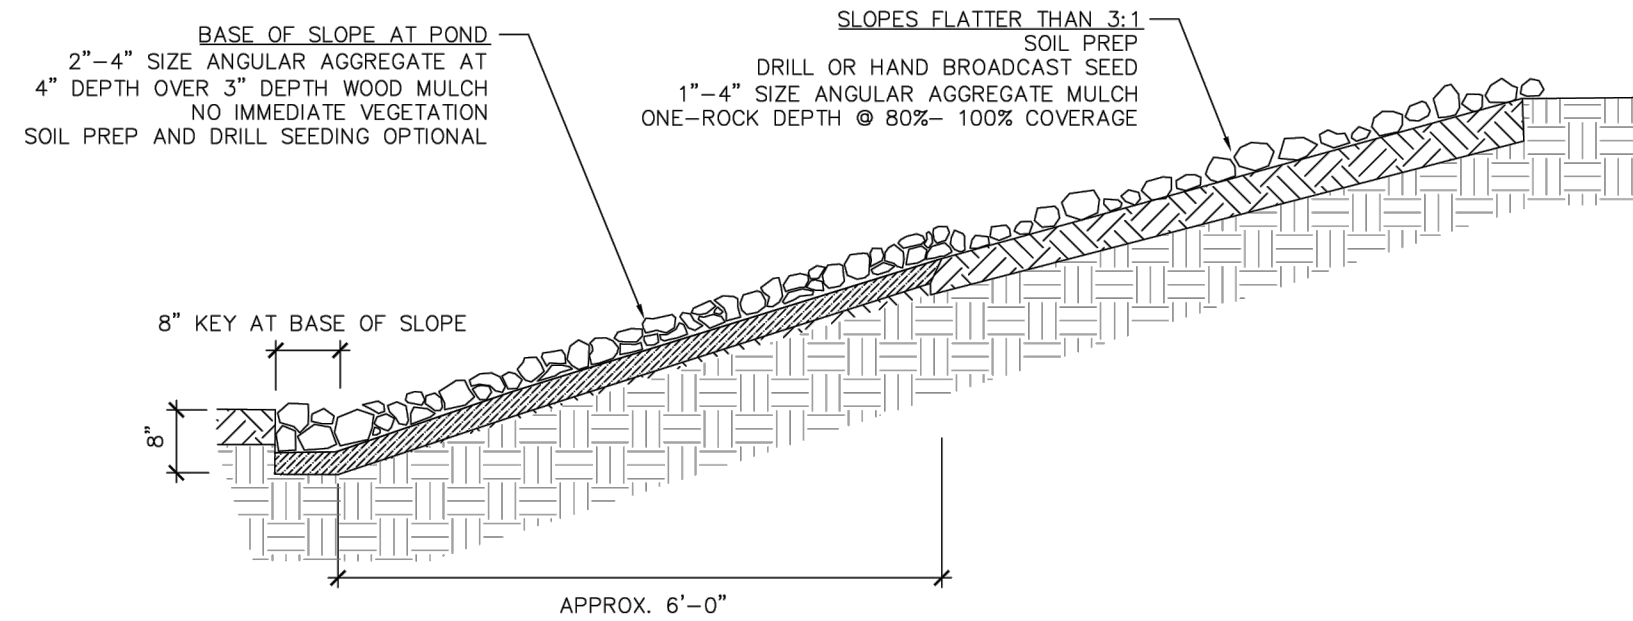

A1 1013-SKL-1: SLOPES FLATTER THAN 3:1
SCALE: N.T.S.



733 MARQUETTE AVE
SUITE 1000
MINNEAPOLIS, MN 55402
WWW.STANTEC.COM

CLIENT:




ALBUQUERQUE 10 MW
DATA CENTER
DAYTONA RD NW
ALBUQUERQUE, NEW MEXICO 87121

PROJECT TITLE

ISSUE NO.:	0	1	2	3	4	5	6
DESCRIPTION:	PRE APPLICATION SUBMITTAL	PRE SUBMITTAL	BID SET	10% RESUBMITTAL	PERMIT SET	SIDEWALK UPDATE PER AECWUA	ASB04
DATE:	01/08/2024	03/08/2024	03/20/2024	05/10/2024	06/03/2024	06/07/2024	09/13/2024

CERTIFICATION:

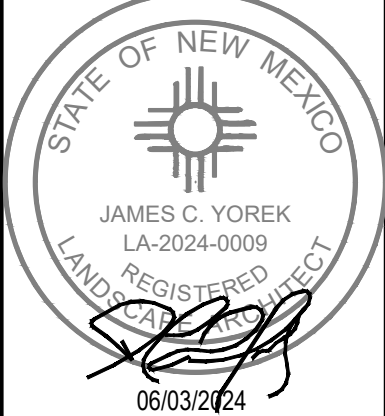

PROJECT NO.: 193800697

DWN BY: SY
CHK'D BY: TH
APP'D BY: CY

ISSUE DATE: 09/13/2024


ISSUE NO.: 6

SHEET TITLE:

LANDSCAPE DETAILS

SHEET NO.:

L-803

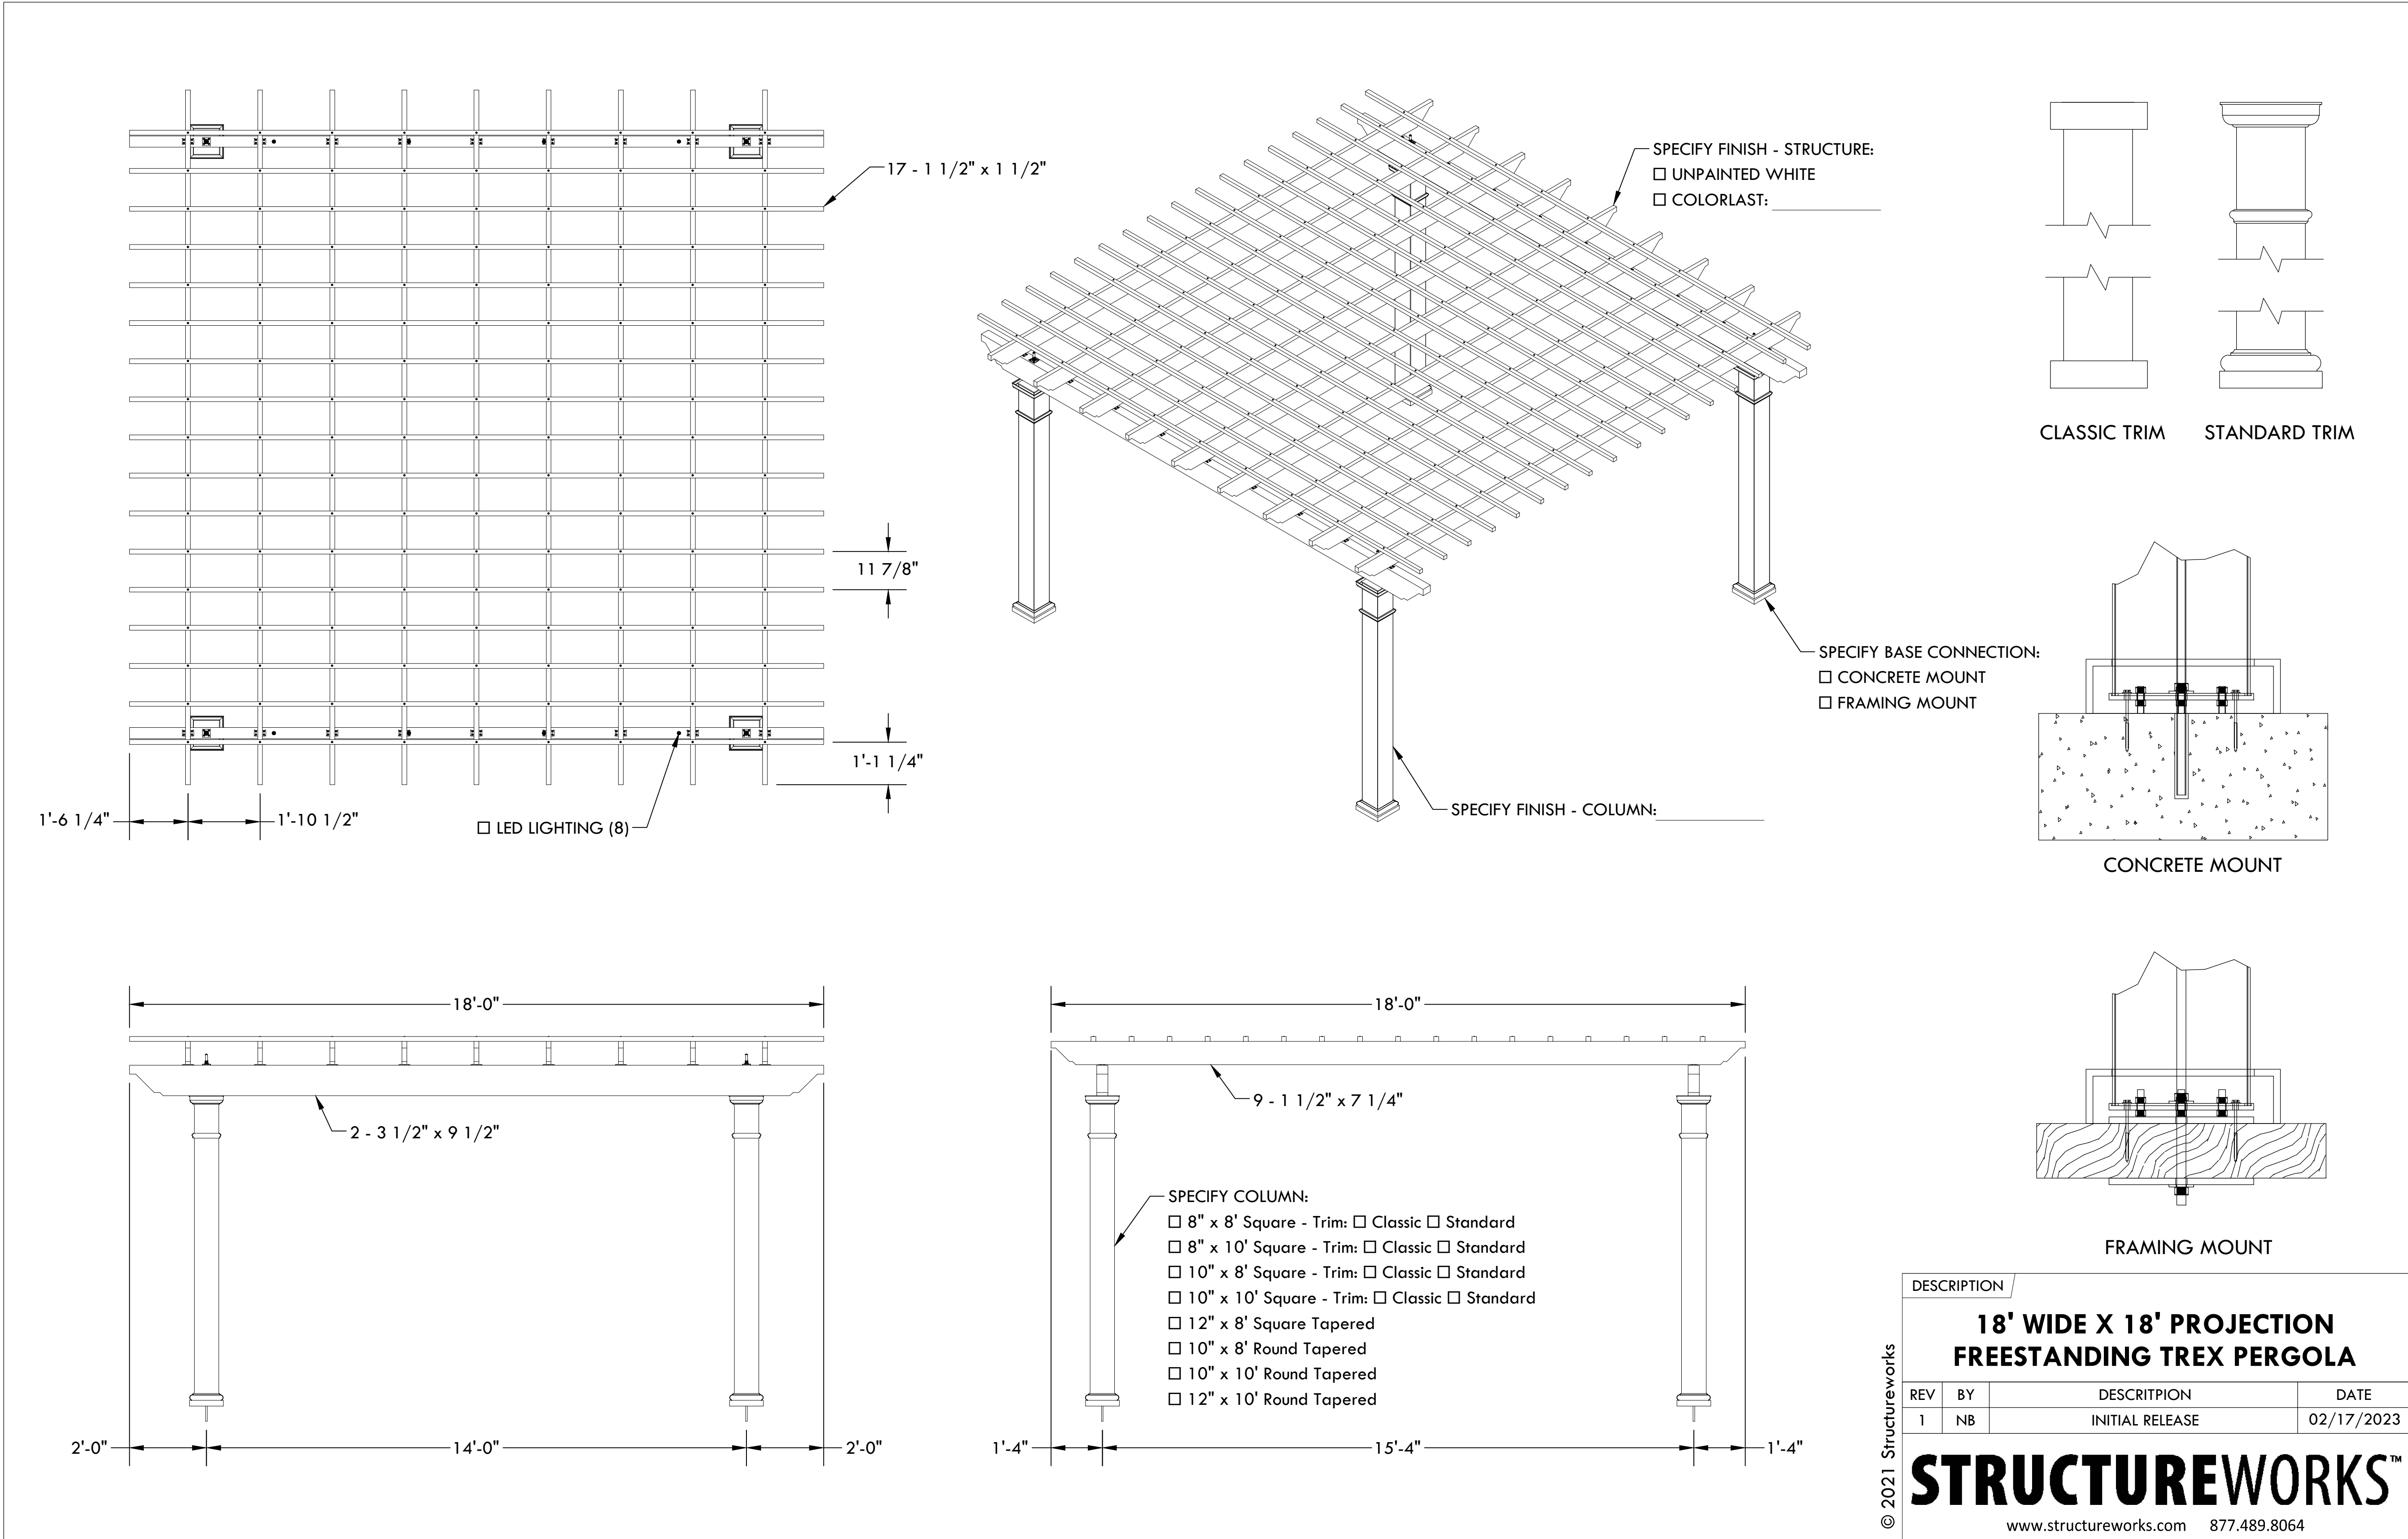

1
L-804
DETAIL: 18' X 18' PERGOLA
NOT TO SCALE

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DESCRIPTION			
18' WIDE X 18' PROJECTION FREESTANDING TREX PERGOLA			
REV	BY	DESCRIPTION	DATE
1	NB	INITIAL RELEASE	02/17/2023

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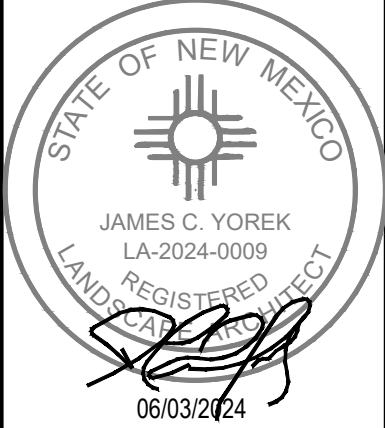


**ALBUQUERQUE 10 MW
DATA CENTER**
DAYTONA RD NW
ALBUQUERQUE, NEW MEXICO 87121

PROJECT TITLE

DATE	DESCRIPTION	ISSUE NO.
01/08/2024	PRE APPLICATION SUBMITTAL	0
03/08/2024	DRG SUBMITTAL	1
03/20/2024	BID SET	2
05/10/2024	DFT RESUBMITTAL	3
06/03/2024	PERMIT SET	4
06/07/2024	SIDEWALK UPDATE PER ABCNWA	5
09/13/2024	ASB04	6

CERTIFICATION:



PROJECT NO.: 19380697

DWN BY: SY
CHK'D BY: TH
APP'D BY: CY

ISSUE DATE: 09/13/2024


ISSUE NO.: 6

SHEET TITLE:
LANDSCAPE DETAILS

SHEET NO.:
L-804

Bola Bike Rack, Embedded
Product Drawing
Date: 3/2/2022
www.landscapeforms.com Ph: 800.521.2546

OVERALL WIDTH DIMENSION MAY VARY
DUE TO MANUFACTURING CAPABILITIES.

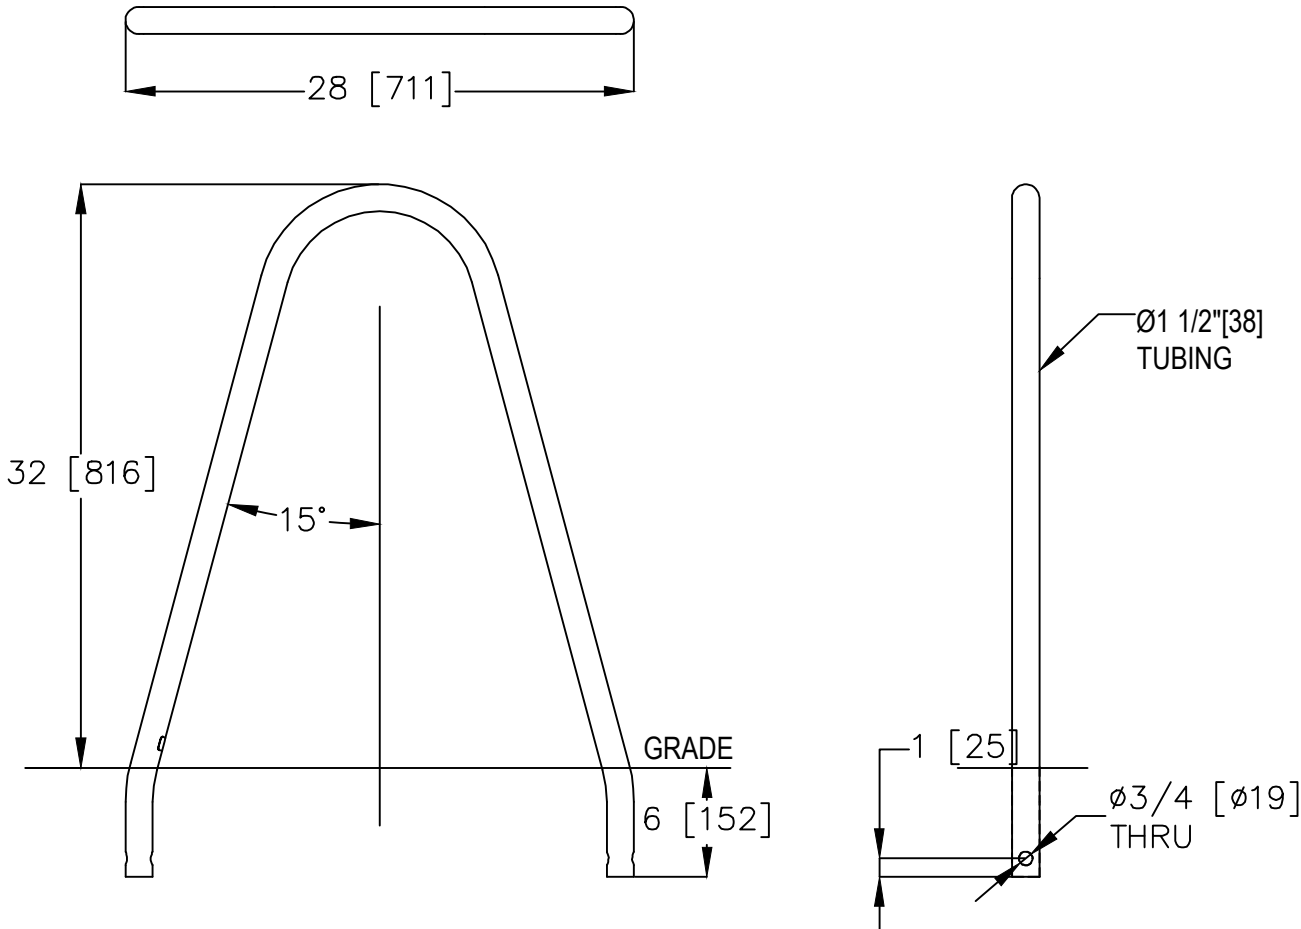


landscapelforms Drawing: B0661-01
Dimensions are in inches [mm]

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4 **DETAIL: BIKE RACK**
L-805 NOT TO SCALE

Chase Park® Side Opening Litter Receptacle, With Sand Pan, With Lock
Product Drawing
Date: 8/22/2019
www.landscapeforms.com Ph: 800.521.2546

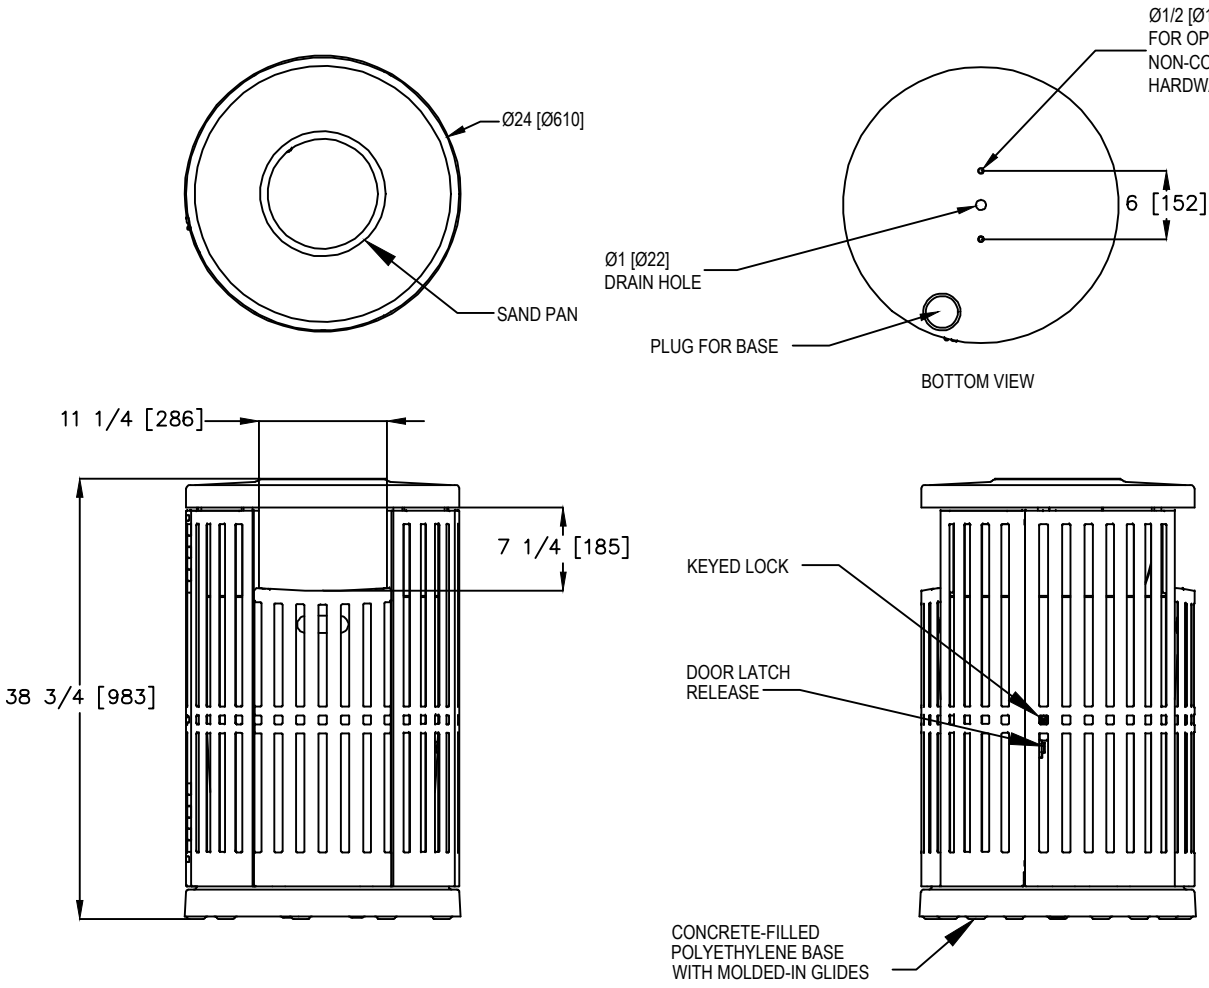


landscapelforms Drawing: CP382-04
Dimensions are in inches [mm]

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3 **DETAIL: SIDE OPENING LITER RECEPTACLE**
L-805 NOT TO SCALE

Carousel™ Table, 4 seat casual height, backless grid seats, Catena 30in dia tabletop
Product Drawing
Date: 9/12/2018
www.landscapeforms.com Ph: 800.521.2546

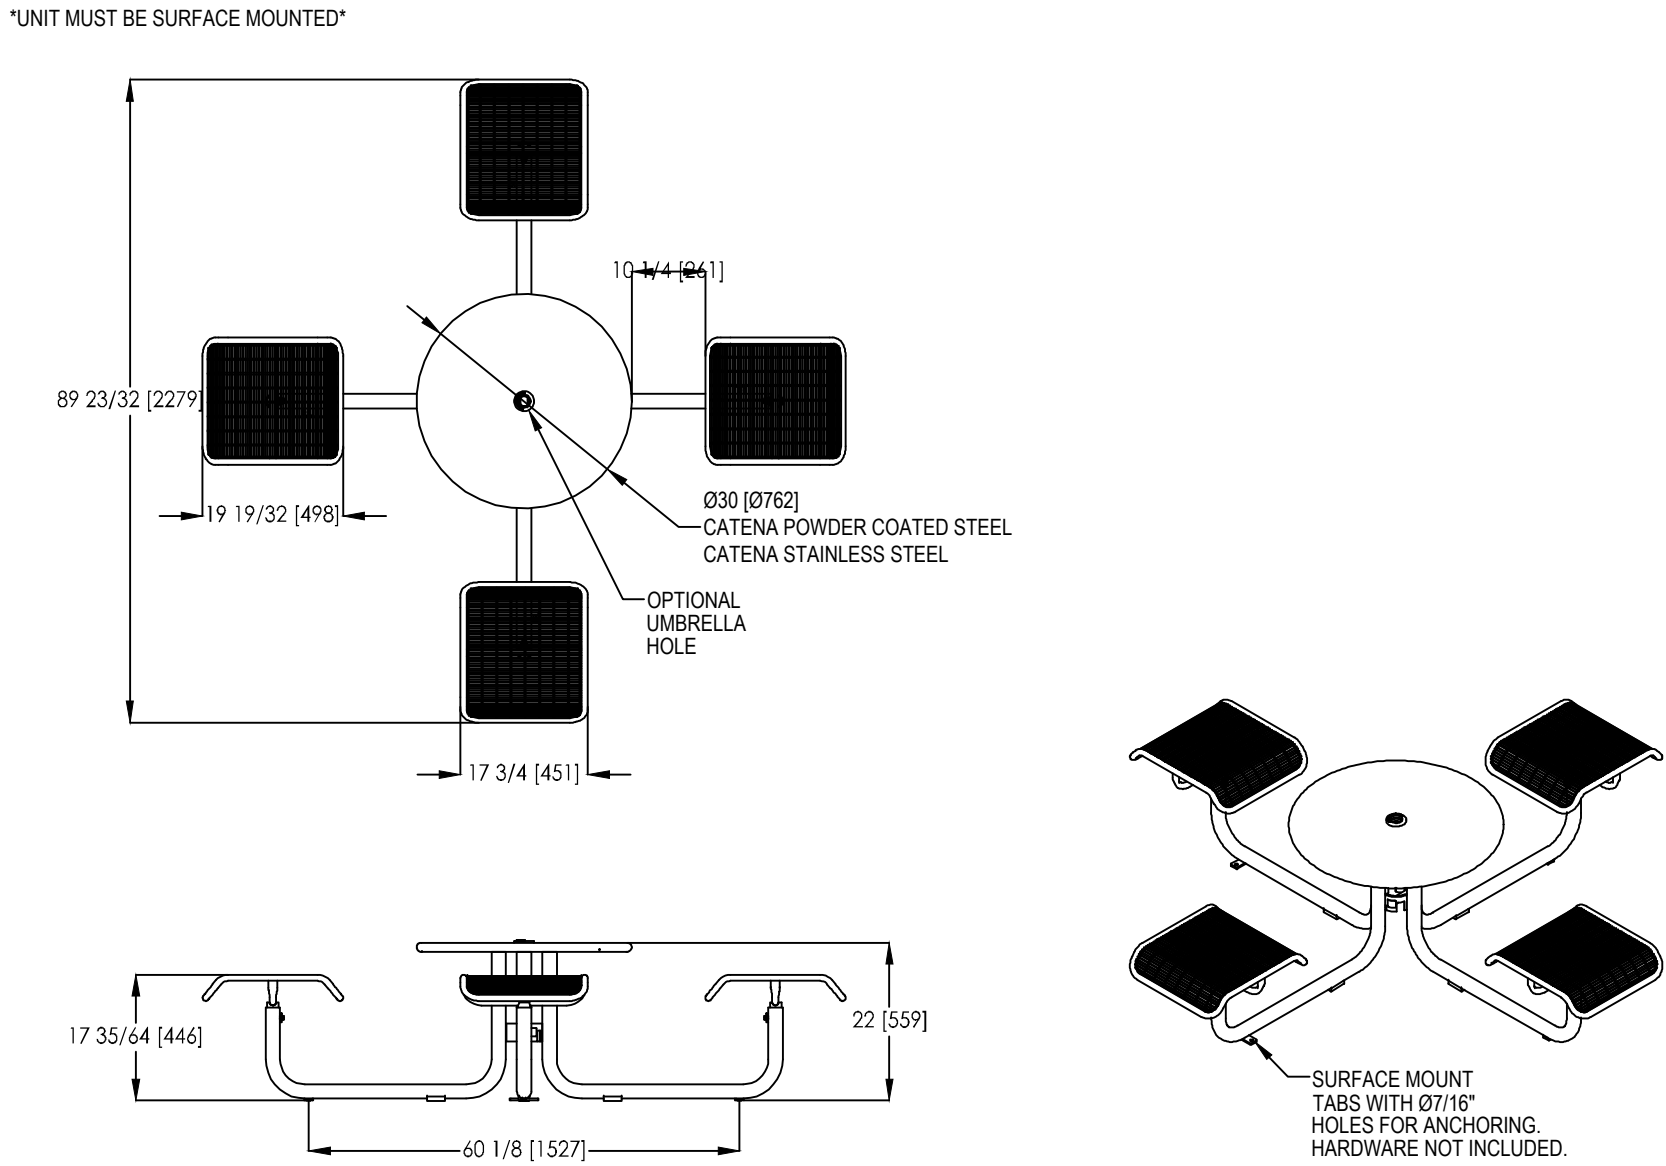


landscapelforms Drawing: CR0050
Dimensions are in inches [mm]

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2 **DETAIL: 4 SEATS TABLE WITH BACKLESS GRID SEATS**
L-805 NOT TO SCALE

Carousel™ Table, 3 seat casual height, backless grid seats, Catena 30in dia tabletop
Product Drawing
Date: 9/12/2018
www.landscapeforms.com Ph: 800.521.2546

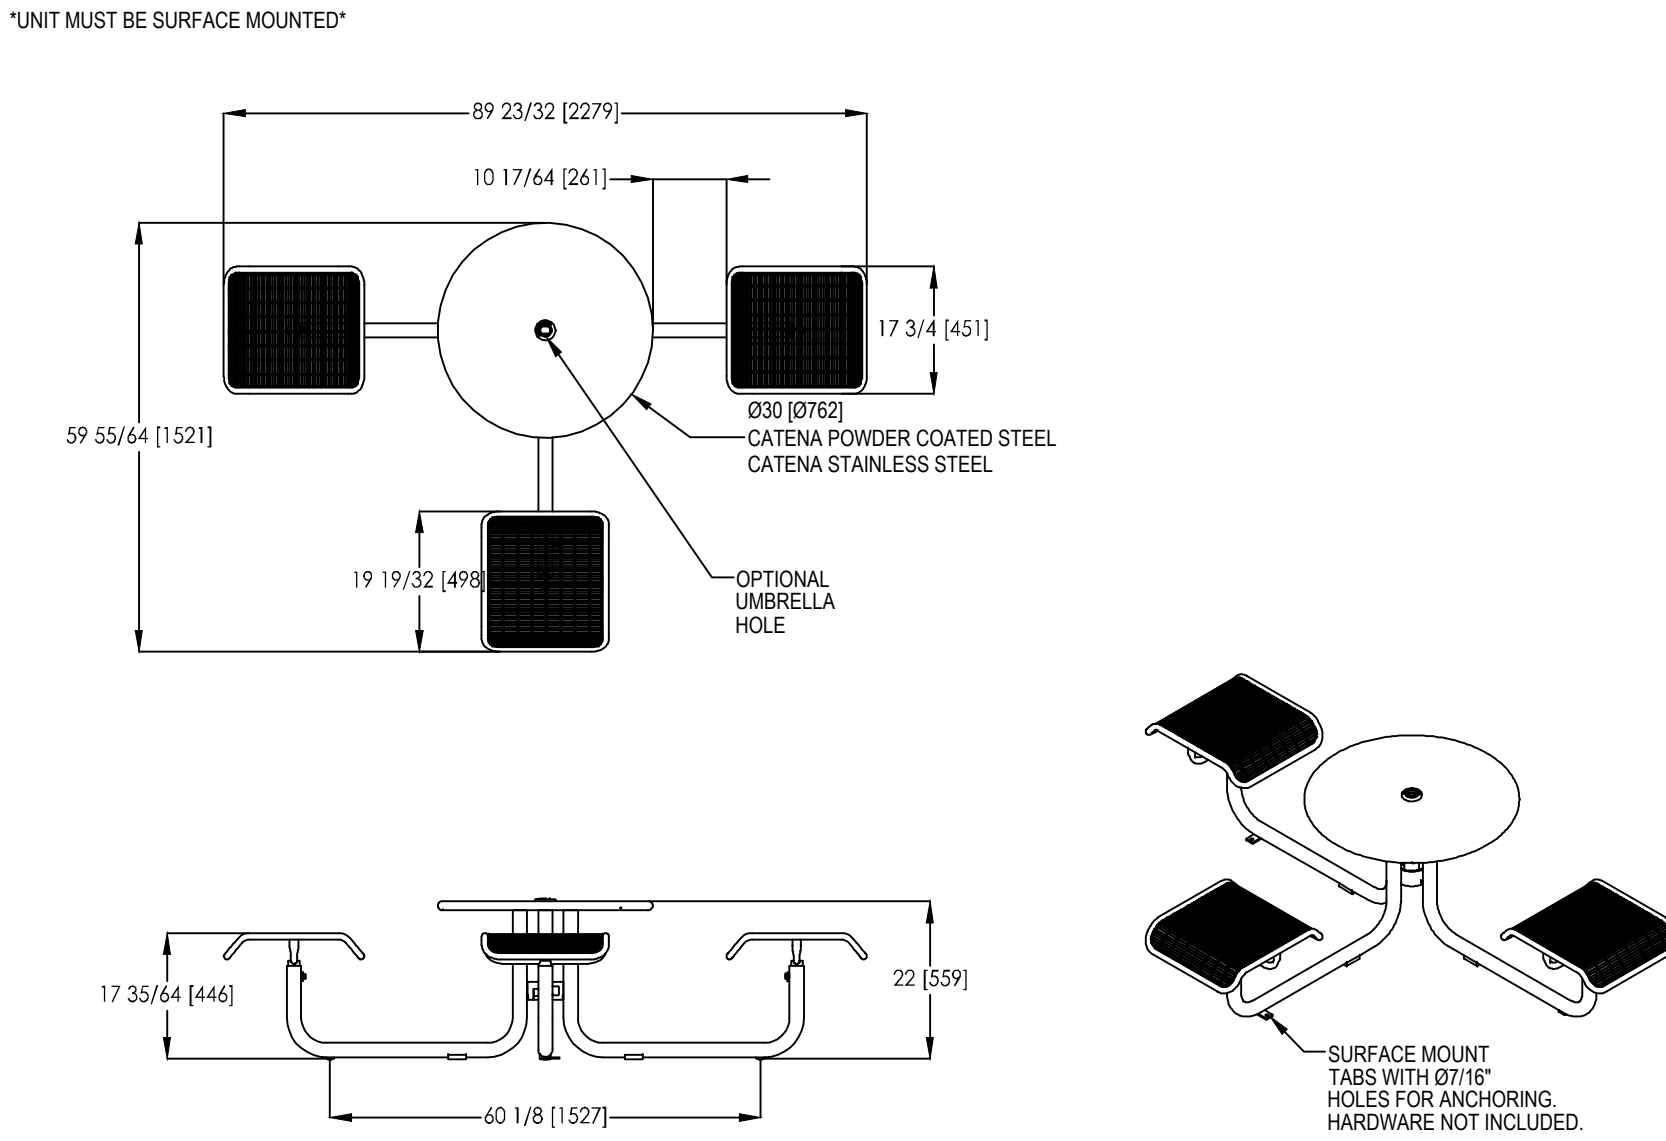

landscapelforms Drawing: CR0001
Dimensions are in inches [mm]

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1 **DETAIL: 3 SEATS TABLE WITH BACKLESS GRID SEATS**
L-805 NOT TO SCALE



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SUITE 1000
MINNEAPOLIS, MN 55402
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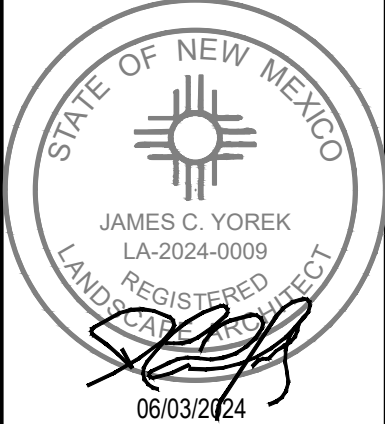


**ALBUQUERQUE 10 MW
DATA CENTER**
DAYTONA RD NW
ALBUQUERQUE, NEW MEXICO 87121

PROJECT TITLE

DATE	DESCRIPTION	ISSUE NO.
01/08/2024	PRE APPLICATION SUBMITTAL	0
03/08/2024	DRB SUBMITTAL	1
03/20/2024	BID SET	2
05/10/2024	IFT RESUBMITTAL	3
06/03/2024	PERMIT SET	4
06/07/2024	SIDEWALK UPDATE PER ABCWA	5
09/13/2024	AS104	6

CERTIFICATION:



PROJECT NO.: 193806697

DWN BY: SY
CHK'D BY: TH
APP'D BY: CY

ISSUE DATE: 09/13/2024

ISSUE NO.: 6

SHEET TITLE:
LANDSCAPE DETAILS

SHEET NO.:
L-805