GENERAL NOTES:

1: ADD 5100 TO SPOT ELEVATIONS TO SHOW TRUE ELEVATION.

2: CONTOUR INTERVAL IS ONE (1) FOOT.

3: ELEVATIONS ARE BASED ON CITY OF ALBUQUERQUE CONTROL STATION 7_K9 HAVING AN ELEVATION OF _5140.082 FEET ABOVE SEA LEVEL.

- 4: UTILITIES SHOWN HEREON ARE IN THEIR APPROXIMATE LOCATION BASED ONLY ON ABOVE GROUND EVIDENCE FOUND IN THE FIELD AND AS—BUILT INFORMATION PROVIDED BY THE CLIENT. UTILITIES SHOWN HEREON, WHETHER INDICATED AS ABANDONED OR NOT, SHALL BE VERIFIED BY OTHERS FOR EXACT LOCATION AND/OR DEPTH PRIOR TO EXCAVATION OR DESIGN CON—SIDERATIONS.
- 5: THIS IS <u>NOT</u> A BOUNDARY SURVEY, BEARINGS ARE ASSUMED, DISTANCES AND FOUND PROPERTY CORNERS ARE FOR <u>INFORMATIONAL PURPOSES ONLY.</u>

EROSION CONTROL PLAN
AND POLLUTION PREVENTION NOTES

- CONTRACTOR IS RESPONSIBLE FOR OBTAINING A TOPSOIL DISTURBANCE PERMIT PRIOR TO BEGINNING WORK.
- 2. CONTRACTOR IS RESPONSIBLE FOR CLEANING ALL SEDIMENT OUT OF EXISTING RIGHT-OF-WAY.
- CONTRACTOR IS RESPONSIBLE FOR MAINTAINING ALL STORM RUNOFF ON SITE.
- 4. REPAIR OF DAMAGED FACILITIES AND CLEAN—UP OF SEDIMENT ACCUMULATION ON ADJACENT PROPERTIES AND IN PUBLIC FACILITIES IS THE RESPONSIBILITY OF THE CONTRACTOR.
- ALL EXPOSED EARTH SURFACES MUST BE PROTECTED FROM WIND AND WATER EROSION PRIOR TO FINAL ACCEPTANCE OF ANY PROJECT.
- 6. ALL THE DISTURBED AREAS MUST BE REVEGETATED.

NOTICE TO CONTRACTORS

1. AN EXCAVATION/CONSTRUCTION PERMIT WILL BE REQUIRED BEFORE BEGINNING ANY WORK WITHIN CITY RIGHT-OF-WAY.

2. ALL WORK DETAILED ON THESE PLANS TO BE PERFORMED, EXCEPT AS OTHERWISE STATED OR PROVIDED HEREON, SHALL BE CONSTRUCTED IN ACCORDANCE WITH CITY OF ALBUQUERQUE INTERIM STANDARD SPECIFICATIONS FOR PUBLIC WORKS CONSTRUCTION,

3. TWO WORKING DAYS PRIOR TO ANY EXCAVATION, CONTRACTOR MUST CONTACT NEW MEXICO ONE CALL FOR LOCATING SERVICE, 260-1990 OR "811", FOR LOCATION OF EXISTING UTILITIES.

4. PRIOR TO CONSTRUCTION, THE CONTRACTOR SHALL EXCAVATE AND VERIFY THE HORIZONTAL AND VERTICAL LOCATIONS OF ALL CONSTRUCTIONS. SHOULD A CONFLICT EXIST, THE CONTRACTOR SHALL NOTIFY THE ENGINEER SO THAT THE CONFLICT CAN BE RESOLVED WITH A MINIMUM AMOUNT OF DELAY.

- 5. BACKFILL COMPACTION SHALL BE ACCORDING TO TRAFFIC/STREET USE.

 6. MAINTENANCE OF THESE FACILITIES SHALL BE THE RESPONSIBILITY OF THE OWNER OF THE PROPERTY SERVED.
- 7. WORK ON ARTERIAL STREETS SHALL BE PERFORMED ON A 24-HOUR BASIS.

LIMITS OF TOP OF EXISTING SLOPE

EXISTING FENCE


PROPOSED GRADE

× 5237.50

EXISTING GRADE (TOP OF ASPHALT)

× 5237.50 EXISTING GRADE (TOP OF ASF × 5237.50 EXISTING GRADE (FLOW LINE)


¥ 39.90 PROPOSED GRADE

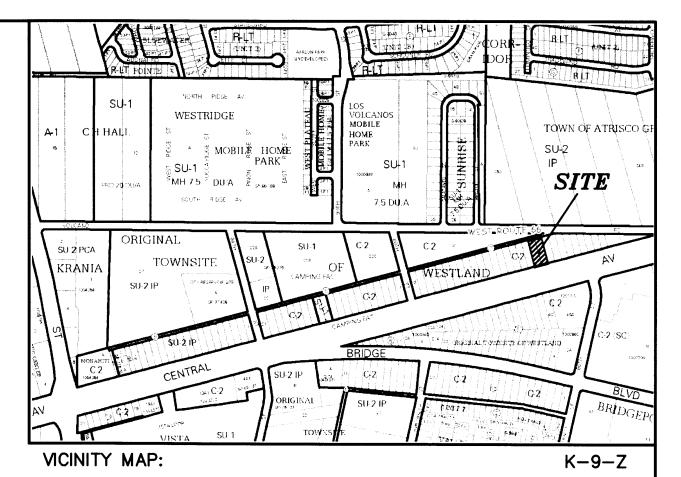

LEGAL DESCRIPTION:

LOT 11 AND 12, BLOCK 7, ORIGINAL TOWNSITE AT WESTLAND CONTAINING 20,000.00 S.F. (0.4500 ACRES) MORE OR LESS

ZONING: C-1 USES

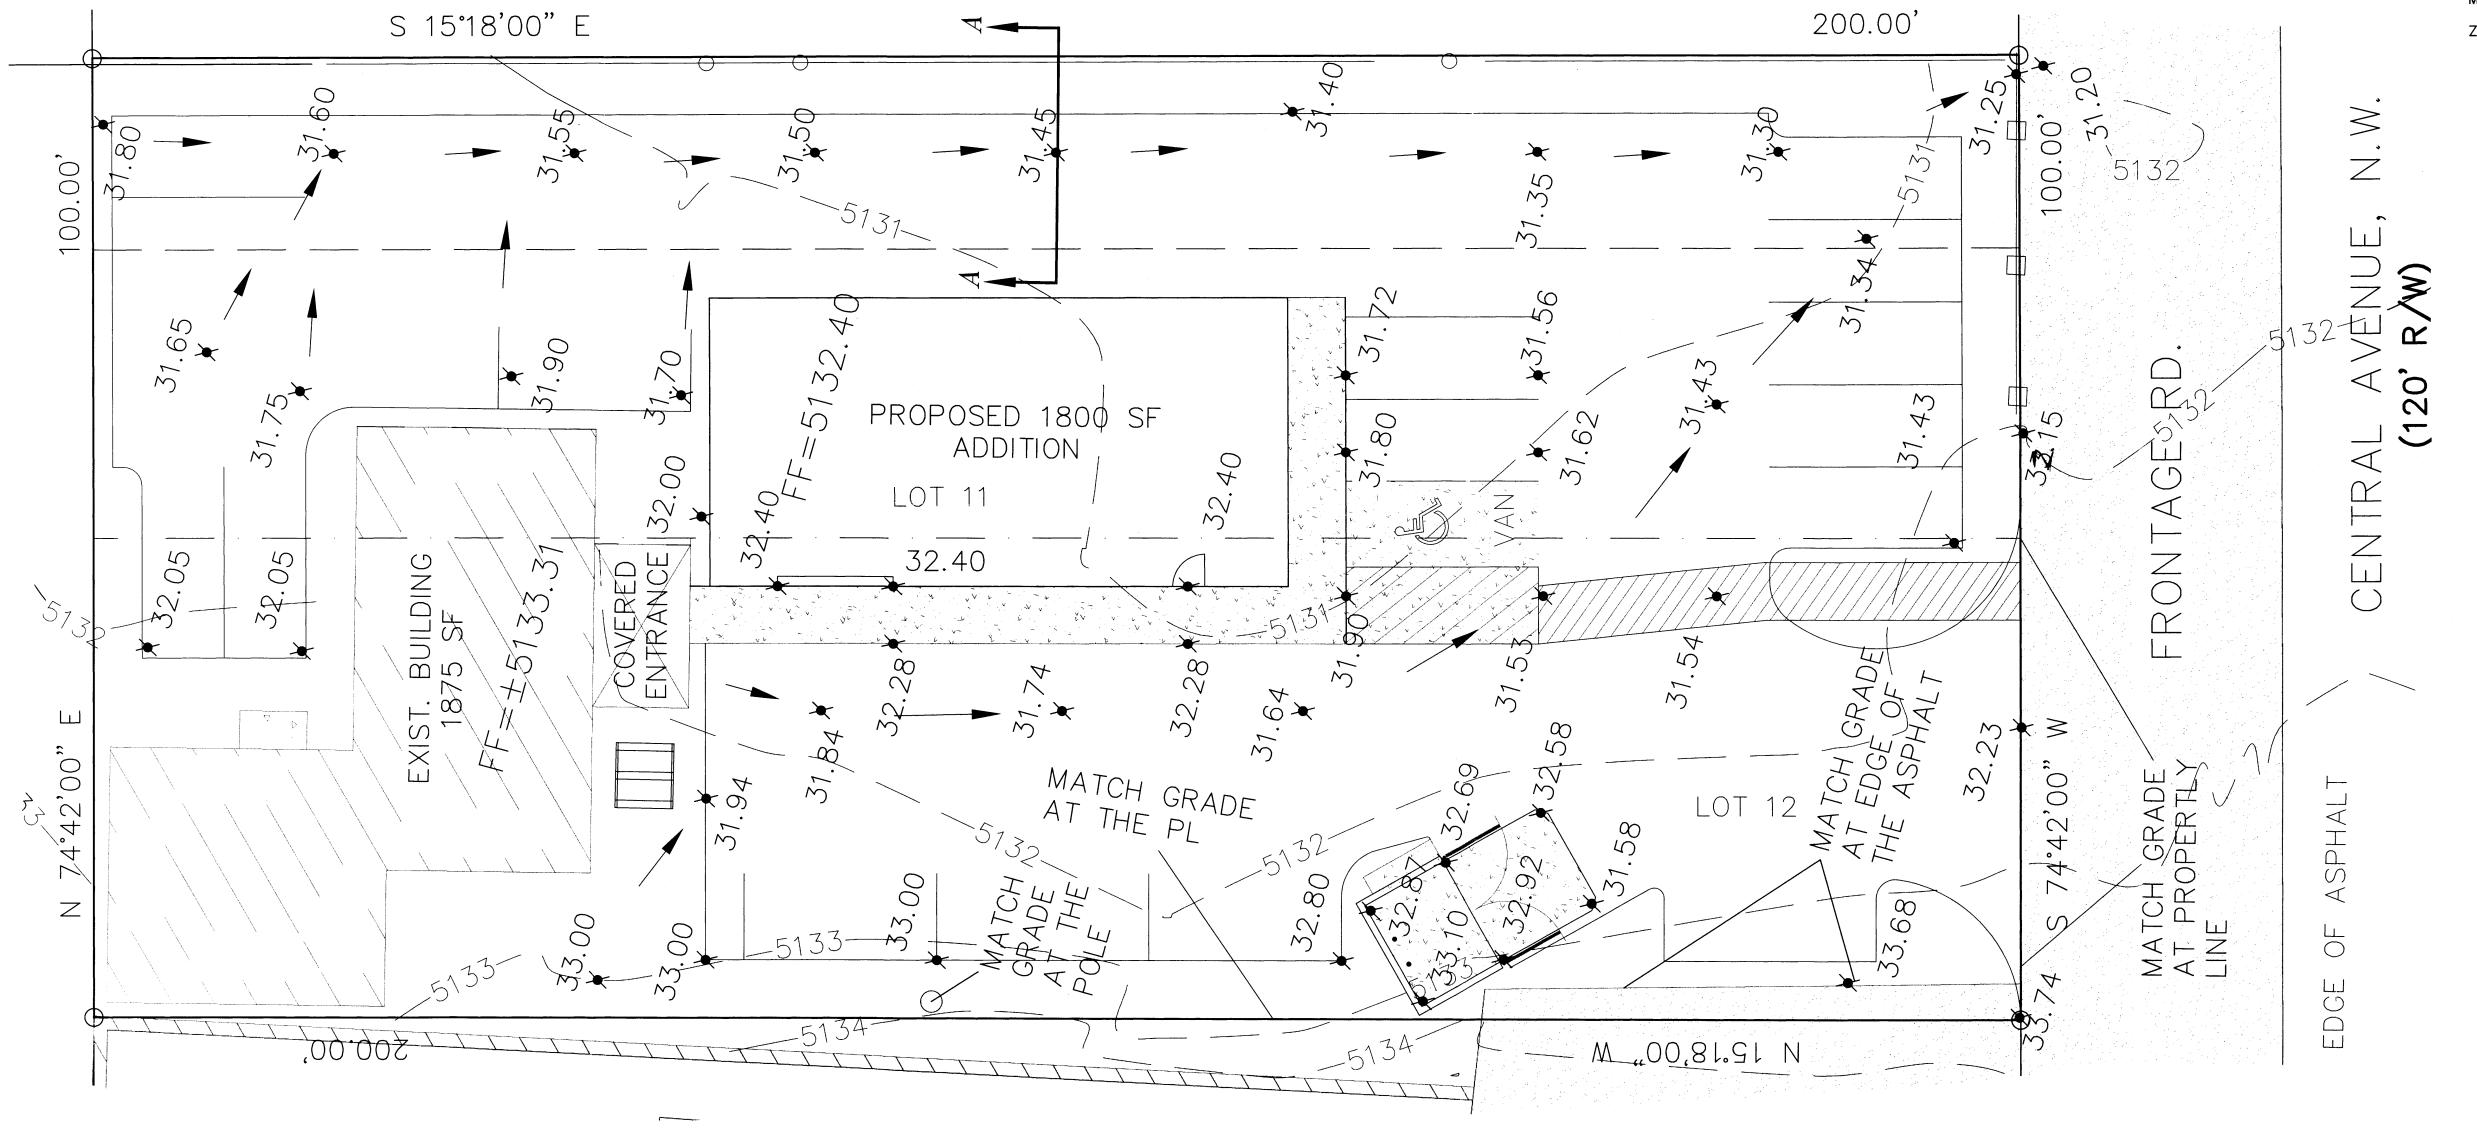

GRAPHIC SCALE

10 5 0 10

SCALE: 1"=10'

RECEIVED

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HYDROLOGY

SECTION



ADVANCED ENGINEERING and CONSULTING, LLC

SHAHAB BIAZAR P.E. #13479 10205 SNOWFLAKE CT., NW ALBUQUERQUE, NEW MEXICO 87114 (505)899-5570

LOTS 11 AND 12, BLOCK 7
GRADING AND DRAINAGE PLAN


DRAWING: DRAWN BY: 2010-MH-GR.dwg SBB

DATE: 06-04-10

C103

29/1036

SHEET#

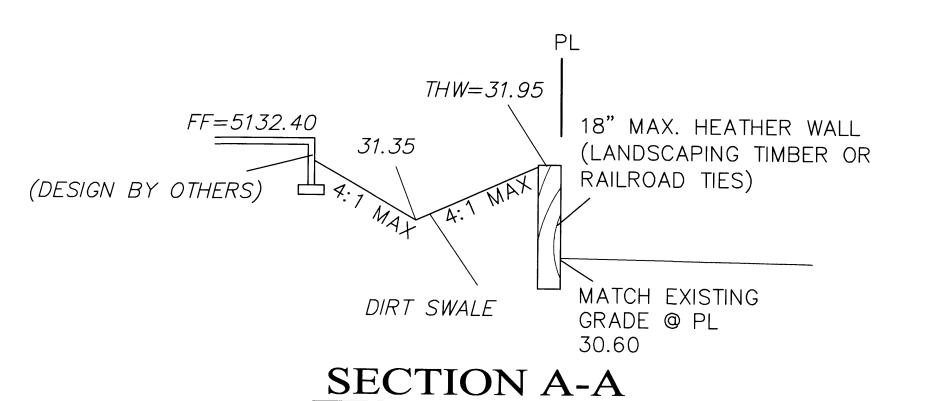

NTS

ROUGH GRADING APPROVAL

DATE

