
CITY OF ALBUQUERQUE

Planning Department Alan Varela, Director

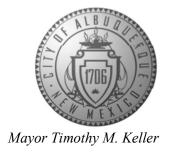

November 18, 2024

Tim Shoemaker, P.E. RTM Engineering 7007 Wyoming Blvd. NE, Ste. F-2 Albuquerque, NM 87109

RE: Panda Express - 98th Street SW

Permanent Certificate of Occupancy - Accepted

Engineer's Certification Date: 11/15/2024

Engineer's Stamp Date: 04/29/2022

Hydrology File: K09D038

Dear Mr. Shoemaker:

PO Box 1293 Based on the Engineer's Grading and Drainage Certification received 11/15/2024 and the site

visit on 11/15/2024, this letter serves as a "green tag" from Hydrology Section for a Permanent

Certificate of Occupancy to be issued by the Building and Safety Division.

Albuquerque If you have any questions, please contact me at 505-924-3314 or amontoya@cabq.gov.

NM 87103 Sincerely,

Anthony Montoya, Jr., P.E.

anth Mars

www.cabq.gov Senior Engineer, Hydrology

Planning Department, Development Review Services



City of Albuquerque Planning Department


Development & Building Services Division

DRAINAGE AND TRANSPORTATION INFORMATION SHEET (DTIS)

roject Title: Hydrology File #							
Legal Description:							
City Address, UPC, OR Parcel:							
Applicant/Agent:		_ Contact:					
Address:		Phone:					
Email:							
Applicant/Owner:		Contact	:				
Address:							
Email:							
TYPE OF DEVELOPMENT:			Single Family Home				
			All other Developments				
	RE-SUBMITTAL:	YES	NO				
DEPARTMENT: TRANS	PORTATION	HYDROLO	OGY/DRAINAGE				
Check all that apply under Both	the Type of Submittal a	nd the Type	of Approval Sought:				
TYPE OF SUBMITTAL:		TYPE OF	APPROVAL SOUGHT:				
Engineering / Architect Certifica	tion	Pad Certification					
Conceptual Grading & Drainage	e Plan	Building Permit					
Grading & Drainage Plan, and/o	or Drainage	Grading Permit					
Report		Paving P	Permit				
Drainage Report (Work Order)		SO-19 P	ermit				
Drainage Master Plan		Foundati	ion Permit				
Conditional Letter of Map Revis	ion (CLOMR)	Certifica	te of Occupancy - Temp	Perm			
Letter of Map Revision (LOMR)	Prelimin	ary / Final Plat				
Floodplain Development Permit			for Building Permit - DFT				
Traffic Circulation Layout (TCI Administrative	L) —		rder (DRC)				
Traffic Circulation Layout (TCI Approval	L) – DFT		of Financial Guarantee (ROFG)				
Traffic Impact Study (TIS)			ual TCL - DFT				
Street Light Layout		•	(SPECIFY)				
		OTTLIC	(51 2011 1)				

REV. 04/03/24

DATE SUBMITTED:

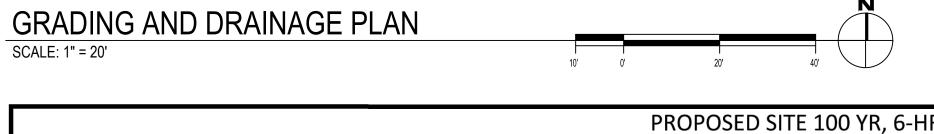

+52,30.18

	PROPOSED SITE 100 YR, 6-HR											
)-YEAR, 6HR	
Basin	Area	Treatr	nent A	Treati	ment B	Treatm	ent C	Treatm	ent D	WEIGHTED E	VOLUME	FLOW
	SF	%	AC	%	AC	%	AC	%	AC	IN	AC-FT	CFS
Basin 1	5399.2	0%	0	0%	0	100%	0.124	0%	0	0.95	0.0098	0.4
Basin 2	33363.2	0%	0	0%	0	0%	0	100%	0.77	2.24	0.1430	3.2
Basin 3	3605.87	0%	0	0%	0	100%	0.083	0%	0	0.95	0.0066	0.2

十5227.35

十5227.32

					EXIS	STING SITE 100	D-YR, 6-HR					
)-YEAR, 6HR	
Basin	Area	Treatr	nent A	Treati	ment B	Treatm	ent C	Treatm	ent D	WEIGHTED E	VOLUME	FLOW
	SF	%	AC	%	AC	%	AC	%	AC	IN	AC-FT	CFS
Basin 1	4573.85	0%	0	0%	0	100%	0.105	0%	0	0.95	0.0083	0.3
Basin 2	35165.58	0%	0	0%	0	0%	0	100%	0.81	2.24	0.1507	3.3
Basin 3	2628.84	0%	0	0%	0	100%	0.060	0%	0	0.95	0.0048	0.2

THE AREAS THAT WERE USED FOR THE STORM WATER CALCULATIONS ARE BASED ON THE SITE LAYOUT SHOWN ON THE PREVIOUS GRADING PLANS APPROVED ON APRIL 7, 2015

LEGAL DESCRIPTION

TRACT NUMBER TWO (2) OF 98TH STREET PLAZA, AS THE SAME ARE SHOWN AND DESIGNATED IN THE CORRECTED PLAT THEREOF FILED IN THE OFFICE OF THE COUNTY CLERK OF BERNALILLO COUNT, NEW MEXICO ON AUGUST 18, 2015 IN PLAT BOOK 2015C,

TRACT OF LAND HERIN DESCRIBED HAVING 0.9726 ACRES (42,368.27 SQUARE FEET)

IDO ZONE DISTRICT: MX-M (MIXED USES-MODERATE INTENSITY ZONE DISTRICT)

BASIS OF BEARING AND BENCHMARK

NAD 83 NEW MEXICO CENTRAL ZONE STATE PLANE COORDINATE VALUES ESTABLISHED

- NMSHC SURVEY CONTROL STATION "I-40-23" DATA: STANDARD BRASS DISC SET FLUSH TO THE GROUND NAD 83 NEW MEXICO CENTRAL ZONE STATE PLANE COORDINATES NORTHING: 1,485,519.844 US FEET EASTING: 1,489,913.599 US FEET ELEV. = 5,341.357 US FEET COMBINED GROUND TO GRID FACTOR = 0.999674412
- DELTA ALPHA = (-) 0°17'20.90" NMSHC SURVEY CONTROL STATION "8-K9-1989" DATA: STANDARD 1-3/4" ALUMINUM DISC RIVETED TO A PIPE NAD 83 NEW MEXICO CENTRAL ZONE STATE PLANE COORDINATES NORTHING: 1,484,994.639 US FEET EASTING: 1,492,463.769 US FEET ELEV. = 5,250.166 US FEET COMBINED GROUND TO GRID FACTOR = 0.999677891 DELTA ALPHA = (-) 0°17'03.21"

THE BASIS OF BEARINGS FOR THE PREMISES SURVEYED ARE NAD 83 NEW MEXICO CENTRAL ZONE GRID BEARINGS BEING BASED ON A LINE BETWEEN THE FOUND PROPERTY CORNERS LISTED ABOVE BEARING = N78°21'46"E.

PROJECT BENCHMARK 13-K9 IS A CITY OF ALBUQUERQUE SURVEY CONTROL STATION "ACS BM 13-K9" ELEVATION = 5,234.53 FEET

BASIS OF ELEVATIONS

NAVD 88

FLOODPLAIN STATEMENT

AREA LIES WITHIN FLOOD ZONE X (OTHER AREAS). AREAS DETERMINED TO BE OUTSIDE THE 0.2% ANNUAL CHANCE OF FLOOD PLAIN ACCORDING TO THE FLOOD INSURANCE RATE MAP PER FIRM MAP PANEL 328 OF 750, MAP NO. 35001C0328J, MAP REVISED DATE 11/04/2016, BERNILILLO COUNTY, NEW MEXICO AND INCORPORATED AREAS.

DRAINAGE CONDITIONS

EXISTING

THE EXISTING SITE IS A PARTIALLY DEVELOPED 0.97 AC LOT. THE CURRENT GRADING WAS DONE PER GRADING PLANS COMPLETED BY WOOTEN ENGINEERING THAT WERE APPROVED ON APRIL 7, 2015 BY THE CITY OF ALBUQUERQUE. THE APPROVED PLANS SHOWED ABOUT 7,500 SQUARE FEET OF RETAIL/ RESTAURANT BUILDING SPACE WHERE THE CURRENT PROPOSED BUILDING WILL BE LOCATED. THE SITE WAS DESIGNED AND GRADED TO DRAIN IN A WESTERLY DIRECTION (AWAY FROM 98TH ST) TOWARDS LANDSCAPE MEDIANS THROUGH SURFACE FLOWS. THESE MEDIANS THEN OUTLET TO THE EXSISITNG 36" 98TH STREET STORM DRAIN THROUGH AN UNDERGROUND STROMDRAIN DRAIN SYSTEM CONTAINING VARYING PIPE SIZES. RUNOFF THAT DOES NOT MAKE IT TO THE LANDSCAPE MEDIANS WILL SHEET FLOW AND BE COLLECTED IN ONE OF THREE CATCH BASINS LOCATED ON 98TH STREET. THESE CATCH BASINS WERE SIZED AND BUILT BY CPN 676284.

PROPOSED THE PROPOSED SITE DESIGN MATCHES THE PREVIOUSLY APPROVED DRAINAGE MANAGEMENT PLAN AND THEREFORE MEETS ALL PRIOR REQUIREMENTS REGARDING DOWNSTREAM RUNOFF. THE DEVIATIONS FROM SAID DRAINAGE MANAGEMENT PLAN IS AN INCREASE OF PERVIOUS AREAS FROM 21% TO 27% AS WELL AS A NEW SITE LAYOUT

CONCLUSION

PIPE CALCULATIONS

CAPACITY = 4.64 CFS

CAPACITY = 13.69 CFS

CAPACITY = 4.67 CFS

Q = 2.24 CFS PIPE SLOPE = 1.0%

Q = 6.23 CFS PIPE SLOPE = 1.0%

Q = 3.2 CFSPIPE SLOPE = 1.0%


PROPOSED

1. PIPE DIAMETER = 12"; PIPE MATERIAL = HDPE; n = 0.010

2. PIPE DIAMETER = 18"; PIPE MATERIAL = HDPE; n = 0.010

1. PIPE DIAMETER = 12"; PIPE MATERIAL = HDPE; n = 0.010


DUE TO THE COMPLIANCE WITH THE PREVIOUSLY APPROVED DRAINAGE MANAGEMENT PLAN, WE ARE REQUESTING THAT THIS DRAINAGE AND GRADING PLAN BE APPROVED

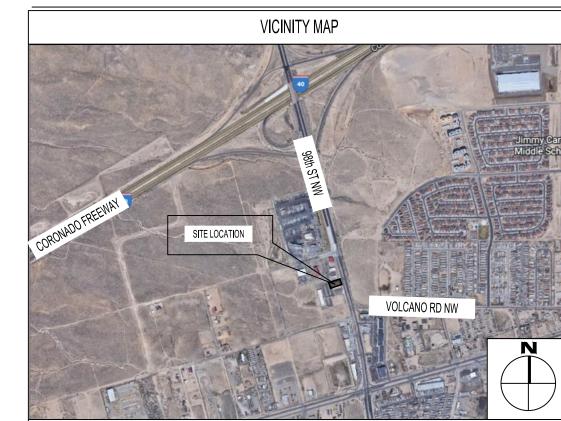

261 98TH STREET, ALBUQUERQUE, NM 87123 N.T.S.

DRAINAGE CERTIFICATION I, <u>TIM SHOEMAKER, NMPE 26935</u>, OF THE FIRM <u>RTM ENGINEERING</u>, HEREBY CERTIFY THAT THIS PROJECT HAS BEEN GRADED AND WILL DRAIN IN SUBSTANTIAL COMPLIANCE WITH AND IN ACCORDANCE WITH THE DESIGN INTENT OF THE APPROVED PLAN DATED 5/2/22. THE RECORD INFORMATION EDITED ONTO THE ORIGINAL DESIGN DOCUMENT HAS BEEN OBTAINED BY CHRISTOPHER MEDINA, NMPS 15702, OF THE FIRM TERRA LAND SURVEYS. I FURTHER CERTIFY THAT I HAVE PERSONALLY VISITED THE PROJECT SITE ON 11/15/24 AND HAVE DETERMINED BY VISUAL INSPECTION THAT THE SURVEY DATA PROVIDED IS REPRESENTATIVE OF ACTUAL SITE CONDITIONS AND IS TRUE AND CORRECT TO THE BEST OF MY KNOWLEDGE AND BELIEF. THIS CERTIFICATION IS SUBMITTED IN SUPPORT OF A REQUEST FOR FINAL CERTIFICATE OF OCCUPANCY.

THE RECORD INFORMATION PRESENTED HEREON IS NOT NECESSARILY COMPLETE AND INTENDED ONLY TO VERIFY SUBSTANTIAL COMPLIANCE OF THE GRADING AND DRAINAGE ASPECTS OF THIS PROJECT. THOSE RELYING ON THIS RECORD DOCUMENT ARE ADVISED TO OBTAIN INDEPENDENT VERIFICATION OF ITS ACCURACY BEFORE USING IT FOR ANY OTHER

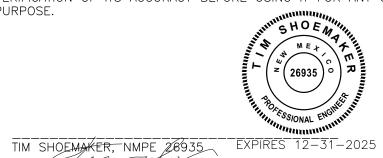

111 (SEAL) DATE 11/15/24

PURPOSE.


RECORD DRAWING

Planning Department Development Review Services HYDROLOGY SECTION APPROVED 05/02/22 BY:
HydroTrans # K09D038

GRADING LEGEND EXISTING PROPOSED BY OTHERS DESCRIPTION TC:XX.XX FL:XX.XX SPOT ELEVATION P:XX.XX ✓ CONTOUR LINE FLOW ARROW





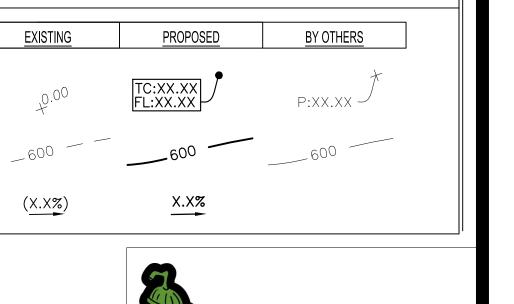

PANDA EXPRESS, INC. 1683 Walnut Grove Ave. Rosemead, California

Telephone: 626.799.9898 Facsimile: 626.372.8288

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REVISIONS:

ISSUE DATE:

DRAWN BY:

PANDA PROJECT #: S8-23-D220241 D220241

PANDA STORE #: ARCH PROJECT #: 21229



www.rtmec.com OH Certificate of Authority: 05046

Heights Venture ARCHITECTURE • DESIGN

1111 North Loop West, Suite 800 5717 Legacy Drive, Suite 240 Houston, Texas 77008 972 490 7292 V 713 869 1103 V

PANDA EXPRESS


261 98TH STREET ALBUQUERQUE, NM 87123

GRADING AND DRAINAGE PLAN PERMI

ANNING

C01.0

261 98TH STREET

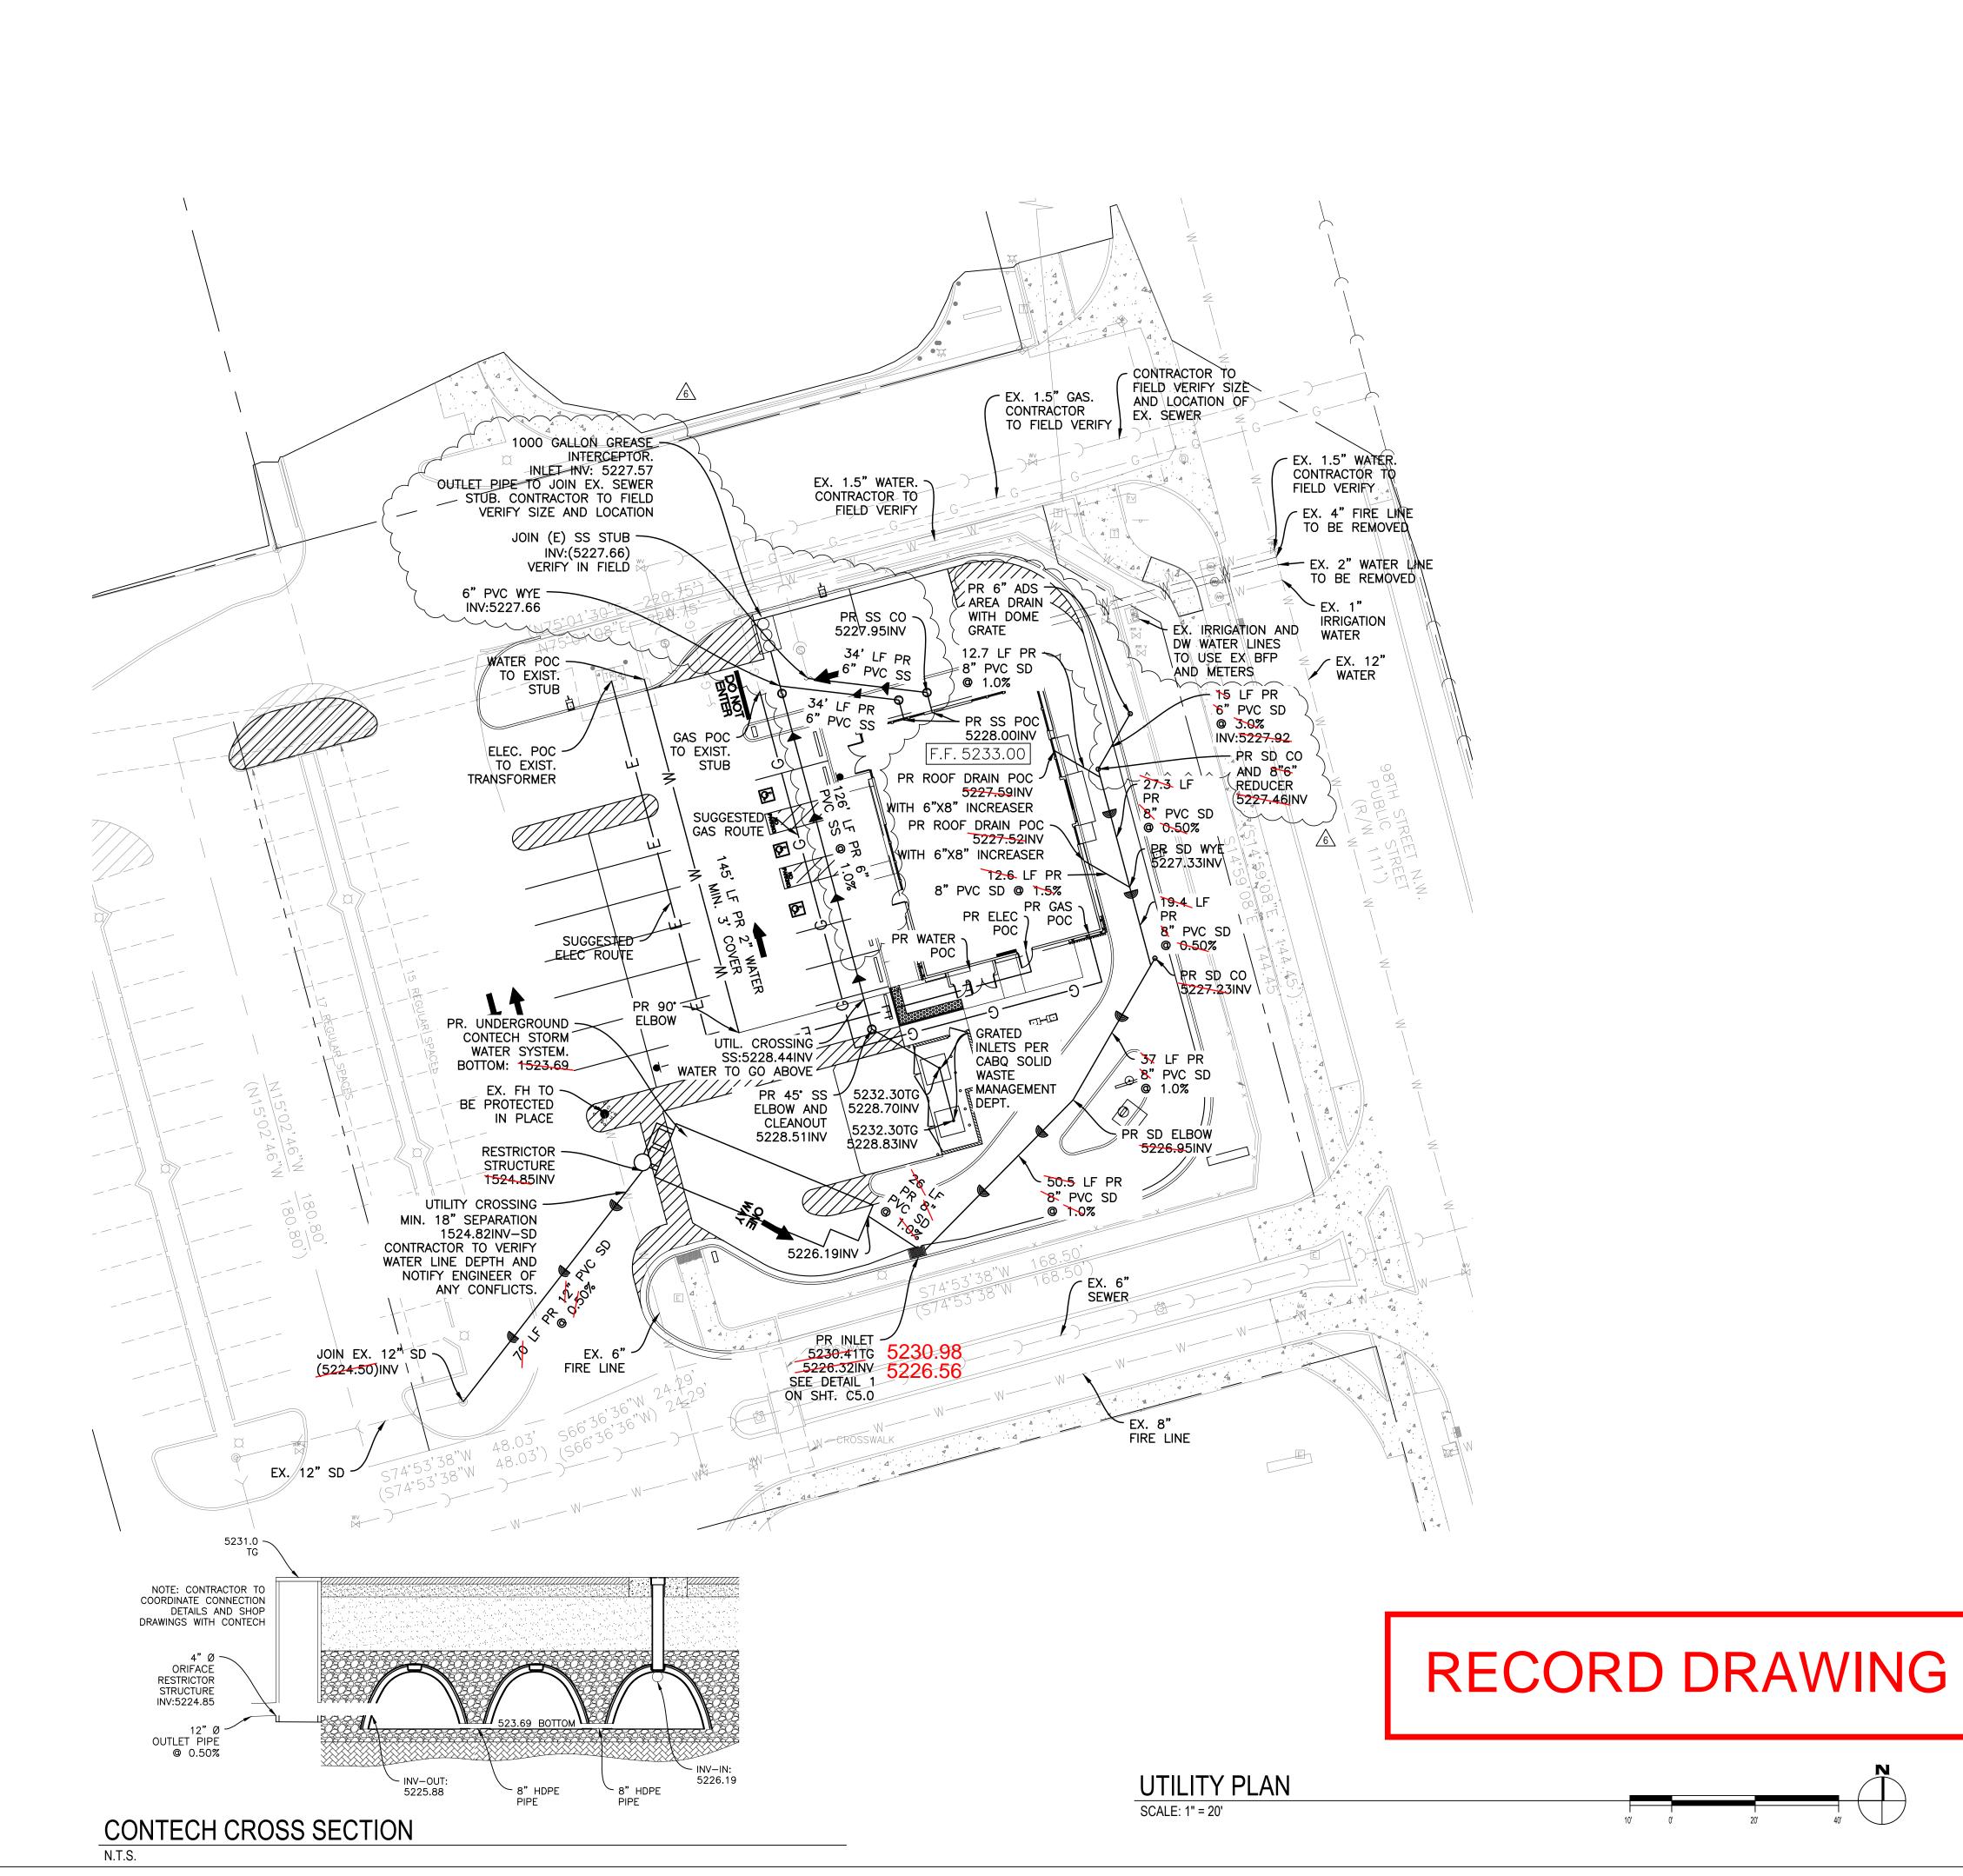

NOTES:

- 1. EX. ITEMS SHALL BE FIELD VERIFIED. RELOCATION OR ADJUSTMENT MAY BE NEEDED. CONTRACTOR TO VERIFY.
- 2. CONTRACTOR SHALL VERIFY ALL WORK, INCLUDING BUT LIMITED TO, SIZES, MATERIALS AND LOCATION, WITH UTILITY COMPANIES PRIOR TO INSTALLATION.
- 3. VERIFY SERVICE LOCATIONS WITH BUILDING PLANS PRIOR TO CONSTRUCTION AND NOTIFY ENGINEER OF ANY DISCREPANCIES.
- 4. RIM GRADES ALONG CURBS ARE FLOW LINE ELEVATIONS.
- 5. SEE SPECIFICATIONS SHEETS FOR ALL STORM, SANITARY, AND WATER PIPE AND STRUCTURE SPECIFICATIONS.
- 6. ALL UTILITY TIE DIMENSIONS ARE FROM CENTER OF UTILITY AND TO BACK OF CURB WHEN TIED TO CURB LINES, UNLESS OTHERWISE NOTED.
- 7. CONTRACTOR TO INSPECT EXISTING SEWER AT POINT OF CONNECTION. CONTRACTOR TO VERIFY THAT EXISTING PIPE IS IN GOOD WORKING CONDITION. CONTRACTOR TO REPAIR AS REQUIRED.
- 8. CONTRACTOR TO NOTIFY OWNER/ENGINEER IF CONFLICTS OCCUR.
- 9. NEW OPENING/CONNECTIONS TO EXISTING MANHOLE/STRUCTURES SHALL BE CORE-DRILLED.
- 10. TEST PITS MUST BE EXCAVATED IN ADVANCE OF CONSTRUCTION II ORDER TO CONFIRM DEPTH AND LOCATION OF EXISTING UTILITIES. NO ADDITIONAL PAYMENT WILL BE MADE FOR TEST PIT EXCAVATION.
- 11. ALL NEW STORM STRUCTURES SHALL HAVE ADA COMPATIBLE OPEN LIDS, PER JURISDICTION STANDARDS.
- 12. ALL UTILITY CONSTRUCTION SHALL BE IN ACCORDANCE WITH PERKINS TOWNSHIP/ERIE COUNTY PUBLIC UTILITIES AND CROSS CONNECTION CONTROL REGULATIONS AND STANDARDS.
- 13. THE CONTRACTOR SHALL OBTAIN AND PAY FOR ALL INSPECTIONS, CERTIFICATIONS, EQUIPMENT ETC., THAT MAY BE REQUIRED.
- 14. CONTRACTOR SHALL COORDINATE GAS, ELECTRIC AND TELEPHONE CONDUIT, PIPING, AND CONDUCTOR REQUIREMENTS WITH MEP PLANS AND UTILITY PROVIDER PRIOR TO INSTALLATION.
- 15. STREET ASPHALT PAVEMENT SHALL BE RESTORED IN ACCORDANCE WITH CITY OF ALBUQUERQUE REQUIREMENTS AND STANDARDS.

DESCRIPTION	EXISTING	PROPOSEI
WATERMAIN PIPE -		
STORM SEWER PIPE -		
SANITARY SEWER PIPE -		
ELECTRICAL DUCT BANK -	— E — —	<u>—Е</u> —
NATURAL GAS LINE -	G	— G—
COMMUNICATIONS LINE -	— COM—— —	—сом—
OVERHEAD LINE -	— OHW — —	——онw—
TELEVISION CABLE -	TV	— TV —
UNDERGROUND WIRE -	— UGW —— ——	— UGW—
TELEPHONE CABLE —	— т — —	—T—
FIBER OPTIC CABLE -	FO	—F0 —
AERIAL WIRES —	— A — —	—A—
EASEMENT LINE -		
VENT LINE -		_
VALVE VAULT	\otimes	$oldsymbol{\Theta}$
WATER B-BOX	\otimes	•
WATER VALVE BOX		
FIRE HYDRANT	Ş	₩
WELL HEAD		W
FIRE DEPARTMENT CONNECTION		~
STORM INLET		•
STORM MANHOLE	\odot	
CATCH BASIN		
STORM CLEANOUT	©	•
DOWNSPOUT	O DS	DS
FLARED END SECTION		
SANITARY MANHOLE		
SANITARY CLEANOUT	S	0
LIGHT POLE	\$	*
TELEPHONE MANHOLE		(1)
POWER POLE	\mathcal{O}	
GAS VALVE	\square	
GAS METER		-
HAND HOLE	HH	HH
MAIL BOX	M	_
ELECTRICAL MANHOLE	((D)
CABLE TV PEDESTAL	TV	
TELEPHONE PEDESTAL		

Know what's **below**.

Call before you dig.

EXPIRES 12-31-2023



PANDA EXPRESS, INC. 1683 Walnut Grove Ave. Rosemead, California 91770

Telephone: 626.799.9898 Facsimile: 626.372.8288

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REVISIONS:

	CITY COMMENTS	02-14-23
	PANDA COMMENTS	02-14-23
	CITY COMMENTS 2	04-28-23
	CITY COMMENTS 3	06-28-23
	CONSTRUCTION SET REV.	08-01-23
6	CONSTRUCTION SET REV.	09-08-23

ISSUE DATE: DDD CLIDMITTAL

1	DRB SUBMITTAL	06-17-2022
2	PERMIT SET	09-09-2022
3	BID SET	10-03-2022
4	CONSTRUCTION SET	02-14-2023
5	CONSTRUCTION SET	08-01-2023
6	DELTA 6 REV.	09-11-2023

DRAWN BY:

PANDA PROJECT #: S8-23-D220241 PANDA STORE #:

ARCH PROJECT #: 21229



9225 Indian Creek Pkwy Suite 1075 Overland Park, KS 66210 Telephone: (913) 322 - 1400 www.rtmec.com KS Certificate of Authority: E-2641

Heights Venture

ARCHITECTURE . DESIGN

1111 North Loop West, Suite 800 5717 Legacy Drive, Suite 240 Houston, Texas 77008 972 490 7292 V 713 869 1103 V


PANDA EXPRESS

PANDA HOME - CUSTOM 261 98TH STREET ALBUQUERQUE, NM 87123

UTILITY PLAN

C04.0

PANDA HOME - SQUARE CUSTOM

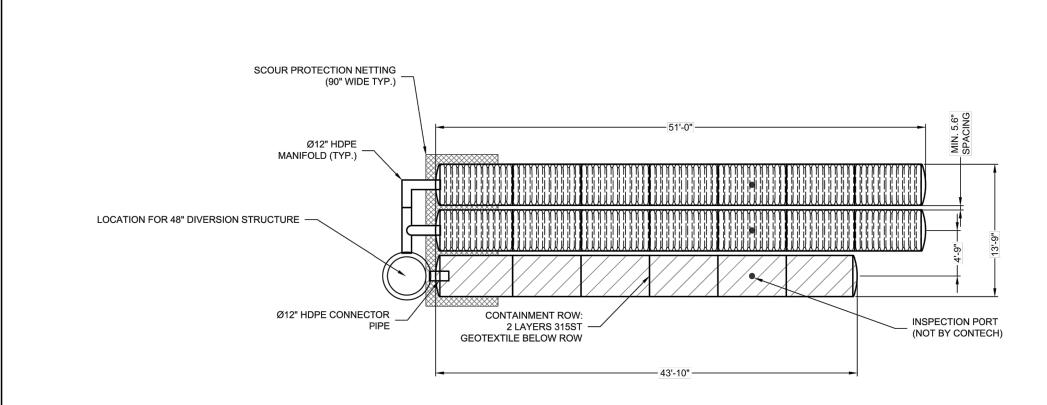

ASSEMBLY

SCALE: 1'=10'
CHAMBER VOLUME: 993 CF
STONE VOLUME: 750 CF
TOTAL VOLUME: 1,743 CF
LOADING: H20/H25

ITEM NUMBER	ITEM DESCRIPTION	CES PART NUMBER	QTY	UNITS
1	CHAMBERMAXX START CHAMBER	APCM 003.3051.004	3	EA
2	CHAMBERMAXX MIDDLE CHAMBER	APCM 003.3051.005	14	EA
3	CHAMBERMAXX END CHAMBER	APCM 003.3051.006	6	EA
4	CONTECH C-40 NON-WOVEN GEOTEXTILE 15 FT X 360 FT	APCM 001.0015.002	1	ROLL
5	CMX SCOUR NET HP300, 8' WIDE (281' MAX. LENGTH)	APCM 007.0075.002	1 @ 16	QTY @ LF
6	Ø12" HDPE TEE	APCM 001.0012.009	1	EA

APCM 001.0012.010

ITEM NUMBER	ITEM DESCRIPTION	CES PART NUMBER	QTY	UNITS
8	Ø12" HDPE CONNECTOR PIPE	N/A	1 @ 2	QTY @ LF
9	Ø12" HDPE SPLIT COUPLER	PEF12SPCP	1	EA
10	315ST CONTAINMENT ROW LINER, 360 FT x 12.5 FT	APCM 007.0015.015	1	ROLL
11	INSTALLATION GUIDE	N/A	1	EA

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CTWCF	Contech expressly disclaims any liability or responsibility for such use. If discrepancies between the supplied information upon which					ENGINEERED SOLUTIONS LLC www.ContechES.com
ĕ	the drawing is based and actual field conditions are encountered as site work progresses, these discrepancies must be reported to Contech immediately for re-evaluation of the design. Contech					7037 Ridge Road, Hanover, MD 21076
တ္ထ	to Contech immediately for re-evaluation of the design. Contech accepts no liability for designs based on missing, incomplete or inaccurate information NOT BY CONTECH.	MARK	DATE	REVISION DESCRIPTION	BY	866-740-3318 410-796-5505 866-376-8511

Ø12" 90 DEGREE HDPE ELBOW

CHAMBERMAXX®


CONTECH

PROPOSAL

DRAWING

CHAMBERMAXX RETENTION SYSTEM - 723819-10
98th Street - Panda Express
Albuquerque
SITE DESIGNATION: N/A

I I TOOLO I ITO	OLG.	10	DATE	
723819	1	10		09/2022
DESIGNED:		DRAW	/N:	
RLH			RL	_H
CHECKED:		APPR	OVED	
SHEET NO.:				
	1	O	F	4

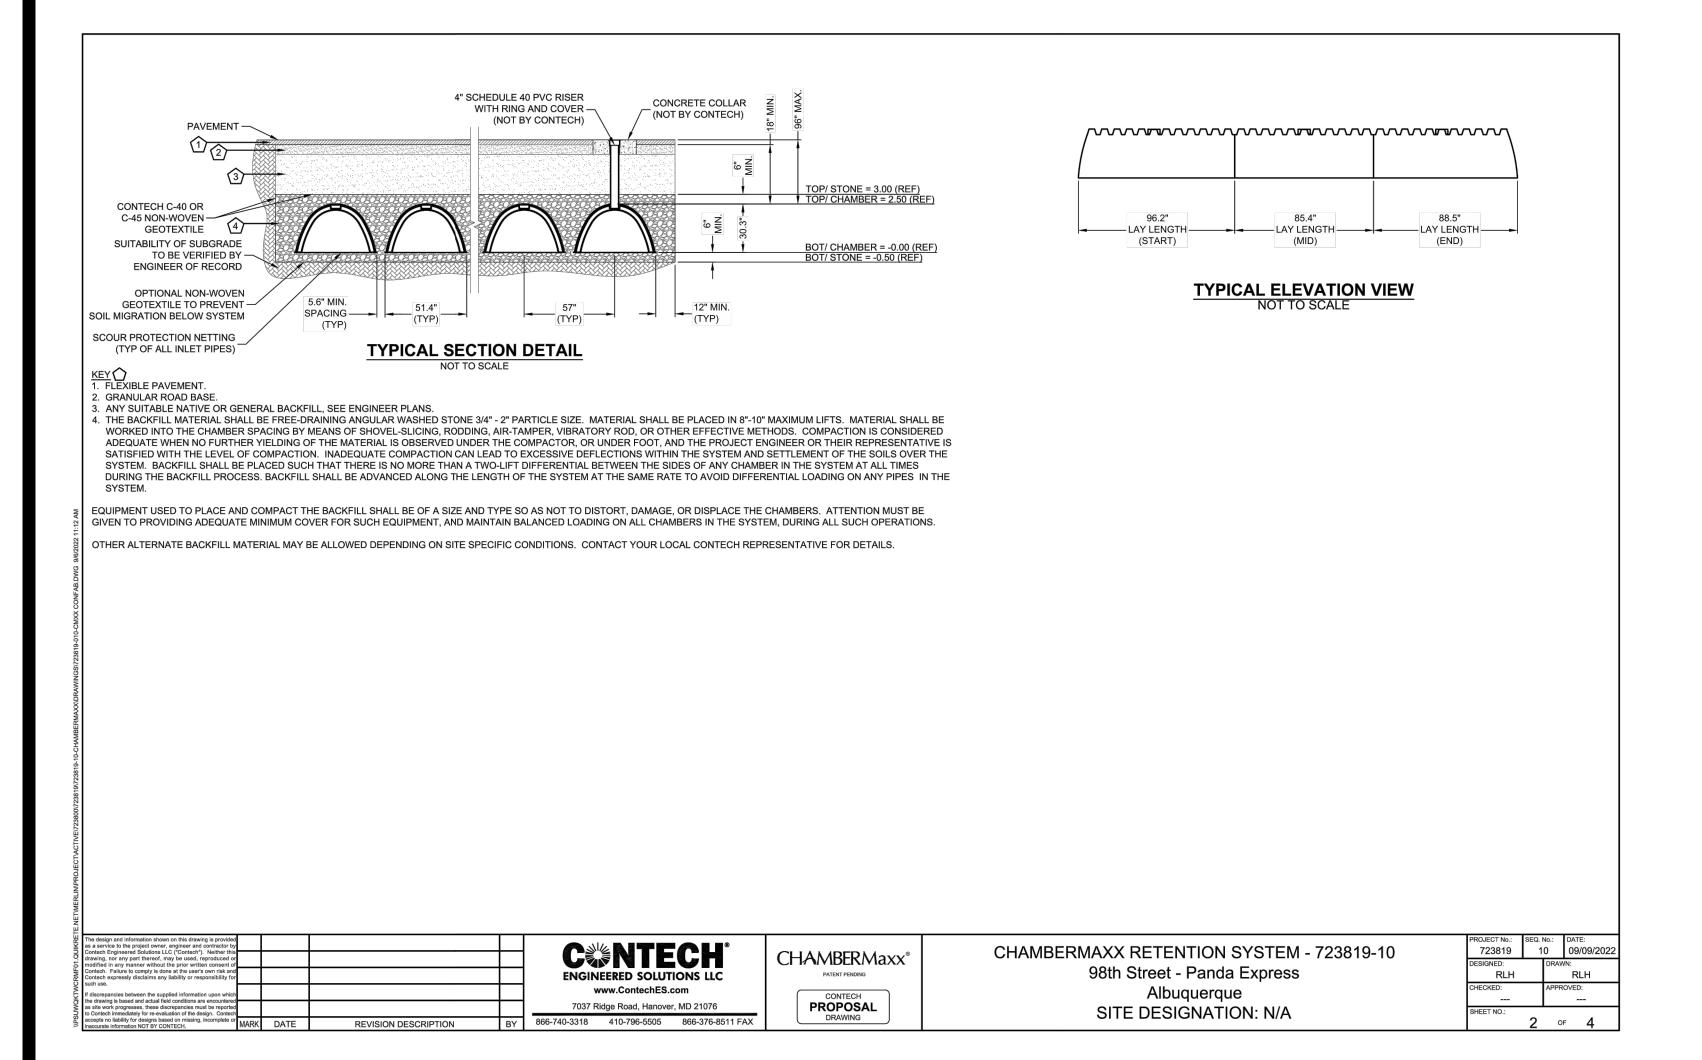

NOTES:

 CONTRACTOR TO COORDINATE CONNECTION DETAILS AND SHOP DRAWINGS WITH CONTECH







PANDA EXPRESS, INC. 1683 Walnut Grove Ave. Rosemead, California

Telephone: 626.799.9898 Facsimile: 626.372.8288

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PANDA COMMENTS	02-14-23
CITY COMMENTS 2	04-28-23
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CONSTRUCTION SET REV.	08-01-23

ISSUE DATE:

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2	PERMIT SET	09-09-2022
3	BID SET	10-03-202
4	CONSTRUCTION SET	02-14-202
5	CONSTRUCTION SET	08-01-202
6	DELTA 6 REV.	09-11-2023

DRAWN BY:

PANDA PROJECT #: S8-23-D220241
PANDA STORE #: D220241

ARCH PROJECT #: 21229



9225 Indian Creek Pkwy
Suite 1075
Overland Park, KS 66210
Telephone: (913) 322 - 1400
www.rtmec.com
KS Certificate of Authority: E-2641

Heights Venture ARCHITECTURE & DESIGN

HOUSTON DALLAS
1111 North Loop West, Suite 800 5717 Legacy Drive, Suite 240

972 490 7292 V

PANDA EXPRESS

Houston, Texas 77008


713 869 1103 V

PANDA HOME - CUSTOM 261 98TH STREET ALBUQUERQUE, NM 87123

UTILITY DETAILS III

C04

IOME COLLABE CHOTOM

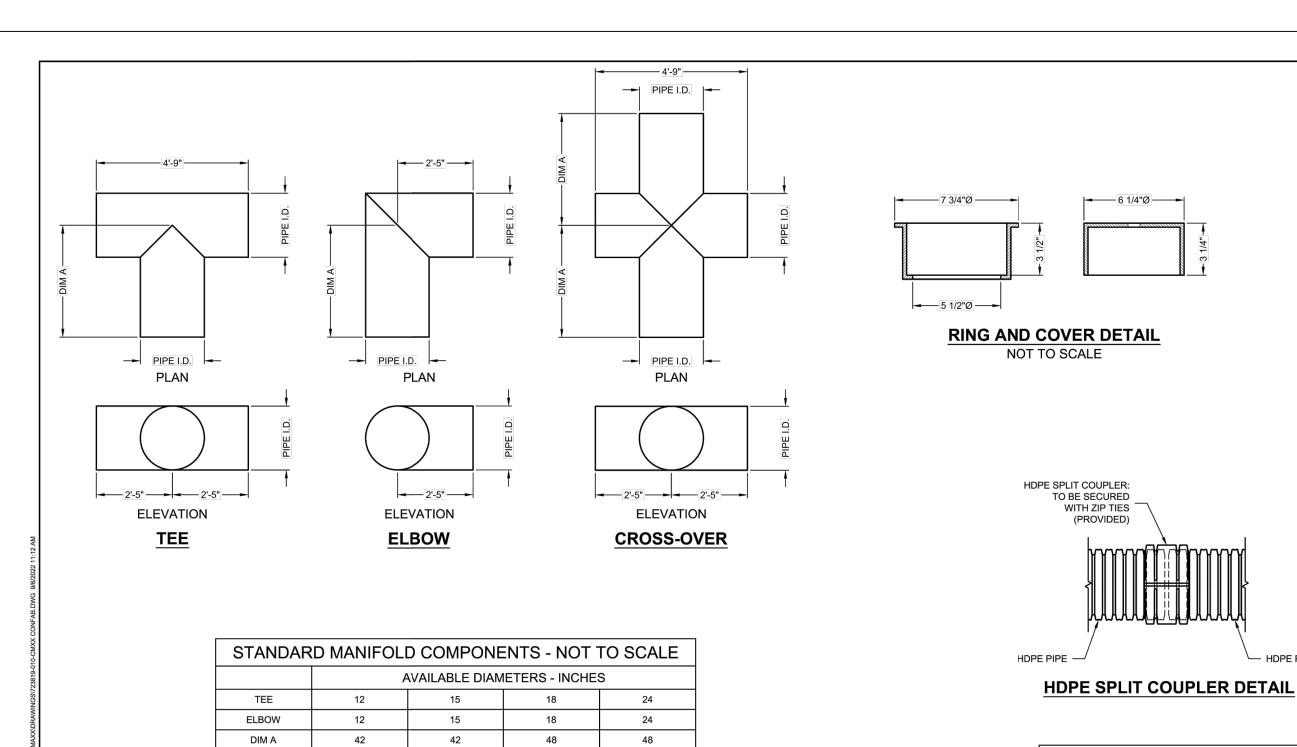

GENERAL NOTES: 1. FITTING MATERIAL TO BE MANUFACTURED FROM CORRUGATED

HIGH DENSITY POLYETHYLENE, AASHTO M294 PIPE. 2. FITTINGS TO BE FABRICATED IN ACCORDANCE WITH THE

REQUIREMENT OF AASHTO M294. 3. FITTINGS DESIGNED TO PROTRUDE 6" INTO THE END OF THE INLET CHAMBERS.

4. MANIFOLD TEE AND ELBOW JOINT TO BE CONNECTED UTILIZING HDPE SPLIT COUPLERS.

TYPICAL MANIFOLD DETAILS

esign and information shown on this drawing is provided service to the project owner, engineer and contractor by the Engineerad Solutions LLC ("Contech"). Neither this ng, nor any part thereof, may be used, reproduced or ted in any manner without the prior written consent of ch. Failure to comply is done at the user's own risk and ch expressly disclaims any liability or responsibility for use. Trepancies between the supplied information upon which awing is based and actual field conditions are encountered work progresses, these discrepancies must be reported tech immediately for re-evaluation of the design. Contech ta no liability for designs based on missing, incomplete or trate information NOT BY CONTECH.					CENTECH® ENGINEERED SOLUTIONS LLC		
					www.ContechES.com	ĺ	
					7037 Ridge Road, Hanover, MD 21076		
	MARK	DATE	REVISION DESCRIPTION	BY	866-740-3318 410-796-5505 866-376-8511 FAX		

CHAMBERMaxx® PROPOSAL

CHAMBERMAXX RETENTION SYSTEM - 723819-10 98th Street - Panda Express Albuquerque SITE DESIGNATION: N/A

6 1/4"Ø ────

(PROVIDED)

HDPE SPLIT COUPLERS

COUPLER SIZE

12"Ø SPLIT COUPLER

15"Ø SPLIT COUPLER

18"Ø SPLIT COUPLER

24"Ø SPLIT COUPLER

723819 10 09/09/202 RLH RLH

CAST IRON RING AND COVER. SEE DETAIL

4"Ø SCHEDULE 40 PVC RISER (NOT BY CONTECH)

INSPECTION PORT DETAIL

HDPE PIPE

NUMBER

PEF12SPCP

PEF15SPCP

PEF18SPCP

PEF24SPCP

NOT TO SCALE

CHAMBERMAXX DESIGN DETAILS				
FEATURE	START CHAMBER	MIDDLE CHAMBER	END CHAMBER	
OVERALL CHAMBER HEIGHT - IN	30.3	30.3	30.3	
OVERALL CHAMBER WIDTH - IN	51.4	51.4	51.4	
ACTUAL LENGTH - IN	98.4	91.0	92.0	
INSTALLED LAY LENGTHS - IN	96.2	85.4	88.5	
CHAMBER STORAGE VOLUME - CF	50.2	47.2	46.2	
CHAMBER STORAGE PER LINEAR FOOT - CF/LF	6.3	6.6	6.3	
*MIN. INSTALLED CHAMBER VOLUME - CF	78.1	75.1	74.1	
*MIN. INSTALLED CHAMBER VOLUME PER LINEAR FOOT - CF/LF	9.7	10.6	10.0	
CHAMBER WEIGHT - LB	83	73	76	

*6" OF STONE ABOVE AND BELOW CHAMBER, 5.6" CHAMBER SPACING AND 40% POROSITY

GENERAL NOTES

- 1. ALL ELEVATIONS, DIMENSIONS AND LOCATIONS OF RISERS AND INLETS SHALL BE VERIFIED BY THE ENGINEER OF
- 2. PRIOR TO INSTALLATION OF THE CHAMBERMAXX SYSTEM A PRE-CONSTRUCTION MEETING SHALL BE CONDUCTED. THOSE REQUIRED TO ATTEND ARE THE SUPPLIER OF THE SYSTEM, THE GENERAL CONTRACTOR,
- SUB-CONTRACTORS AND THE ENGINEER. 3. CHAMBERMAXX CHAMBERS ARE MANUFACTURED FROM POLYPROPYLENE PLASTIC.
- 4. CHAMBERMAXX SYSTEM TO MEET AASHTO HS20/HS25 LIVE LOADING, PER AASHTO LRFD SECTION 12. 5. ACCESS COVERS TO MEET AASHTO HS20/HS25 LIVE LOADING. 6. MINIMUM COVER IS 18-INCHES TO BOTTOM OF FLEXIBLE PAVEMENT OR TO TOP OF RIGID PAVEMENT. FOR COVER
- HEIGHTS GREATER THAN 96-INCHES CONTACT YOUR LOCAL REPRESENTATIVE. 7. ALL PARTS PROVIDED BY CONTECH UNLESS OTHERWISE NOTED. 8. FOR INFORMATION ON PRE-TREATMENT SYSTEMS, REFERENCE CONTECH PRE-TREATMENT SYSTEM STANDARD
- DETAILS OR CONTACT YOUR LOCAL REPRESENTATIVE. 9. CHAMBERMAXX BY CONTECH ENGINEERED SOLUTIONS (800) 925-5240

INSTALLATION NOTES

- 1. CHAMBERMAXX INSTALLATION GUIDE TO BE REVIEWED BY CONTRACTOR PRIOR TO INSTALLATION. 2. PRIOR TO PLACING BEDDING, THE FOUNDATION MUST BE CONSTRUCTED TO A UNIFORM AND STABLE GRADE. IN THE EVENT THAT UNSUITABLE FOUNDATION MATERIALS ARE ENCOUNTERED DURING EXCAVATION, UNSUITABLE MATERIAL SHALL BE REMOVED AND BROUGHT BACK TO GRADE WITH FILL MATERIAL AS APPROVED BY THE ENGINEER OF RECORD. ONCE THE FOUNDATION PREPARATION IS COMPLETE, THE BEDDING MATERIAL CAN BE PLACED. 3. THE SCOUR PROTECTION NETTING TO EXTEND 1'-0" BEYOND OUTSIDE EDGE OF INLET CHAMBERS.
- 4. COVER ANY OPEN VOID SPACES GREATER THAN 3/4" ON CHAMBERS WITH A NON-WOVEN GEOTEXTILE TO PREVENT INFILTRATION OF BACKFILL MATERIAL. 5. STONE EMBEDMENT MATERIAL SHALL BE INSTALLED TO 95% STANDARD PROCTOR DENSITY AND PLACED IN 6-INCH TO 8-INCH LIFTS SUCH THAT THERE IS NO MORE THAN A TWO LIFT DIFFERENTIAL BETWEEN ANY OF THE CHAMBERS AT ANY TIME. GRANULAR BACKFILL MATERIAL SHALL BE COMPACTED TO 90% SPD. BACKFILLING SHALL BE ADVANCED

ALONG THE LENGTH OF THE CHAMBER ROWS AT THE SAME RATE TO AVOID DIFFERENTIAL LOADING AND

- DISPLACEMENT OF THE CHAMBERS. THE MINIMUM CHAMBER SPACING MUST BE MAINTAINED. 6. REFER TO CHAMBERMAXX INSTALLATION GUIDE FOR TEMPORARY CONSTRUCTION LOADING GUIDELINES.
- 7. IT IS ALWAYS THE CONTRACTOR'S RESPONSIBILITY TO FOLLOW OSHA GUIDELINES FOR SAFE PRACTICES.
- 8. GENERAL INSTALLATION METHODS AND MATERIALS TO BE IN ACCORDANCE WITH ASTM D2321.
 9. ANTI-FLOTATION PROVISIONS DUE TO HIGH GROUNDWATER OR OTHER FLOTATION CONCERNS ARE SITE-SPECIFIC. DESIGN CONSIDERATIONS AND SHALL BE SPECIFIED BY ENGINEER ON RECORD.

TE.NETVMERLINPRO					
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NOTES:

CONTRACTOR TO COORDINATE CONNECTION DETAILS AND SHOP DRAWINGS WITH CONTECH







PANDA EXPRESS, INC. 1683 Walnut Grove Ave. Rosemead, California 91770

Telephone: 626.799.9898 Facsimile: 626.372.8288

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REVISIONS:

CITY COMMENTS	02-14-23
PANDA COMMENTS	02-14-23
CITY COMMENTS 2	04-28-23
CITY COMMENTS 3	06-28-23
CONSTRUCTION SET REV.	08-01-23
·	

ISSUE DATE:

1	DRB SUBMITTAL	06-17-2022
2	PERMIT SET	09-09-2022
3	BID SET	10-03-2022
4	CONSTRUCTION SET	02-14-2023
5	CONSTRUCTION SET	08-01-2023
6	DELTA 6 REV.	09-11-2023

DRAWN BY:

PANDA PROJECT #: S8-23-D220241 PANDA STORE #:

ARCH PROJECT #: 21229



9225 Indian Creek Pkwy Suite 1075 Overland Park, KS 66210

Telephone: (913) 322 - 1400 www.rtmec.com KS Certificate of Authority: E-2641

ARCHITECTURE • DESIGN HOUSTON 1111 North Loop West, Suite 800 5717 Legacy Drive, Suite 240

Houston, Texas 77008 Plano, Texas. 75024 713 869 1103 V 972 490 7292 V

PANDA EXPRESS

PANDA HOME - CUSTOM 261 98TH STREET ALBUQUERQUE, NM 87123

UTILITY DETAILS IV

+5227.51 TW:(5232.0)

1' CURB CUT TC:5232.19 FS:5231.69

F.F. 5233.00

TC:5233.00 FS:5232.50

(9) +5224.81'

+5227.35'

+5227.22

GRADING PLAN

SCALE: 1" = 20'

GRADING DETAIL 1

+5227.32

JOIN EXIST. REPLACE AS NEEDED

FS:(5225.85)

40' PRIVATE

RECIPROCAL

EASEMENT

+5229.61° FS:(5229.41)

+5231.19'

<u>(1.5%</u>)

+5230.18

JOIN (E) (TC:5229.5) (FL:5229.0)

+5229.28

+5227.79' (S)

+5228.26

15' BUILDING

+5231.88

UNDERGROUND

ELECTRIC-

EASEMENT

十5225.87"

TC:(5225.37) FL:(5224.87) JOIN EXIST.

FS:(5225.01)

TC:(5225.22) FL:(5224.72)

JOIN EXIST. REPLACE AS NEEDED

FS:(5225.78)

FS:(5224.86)

+5221.95

+5221,51'

EXISTING RETAINING


WALL. CONTRACTOR TO

EXERCISE CAUTION
AROUND POTENTIAL TIE
BACK MATERIALS

+5220.48

+5219.80"

I, CHRISTOPHER A. MEDINA, N.M.P.L.S. NO. 15702, DO HEREBY CERTIFY THAT THE AS-BUILT INFORMATION SHOWN ON SHEETS 9 AND SHEET 12, AND THE ACTUAL SURVEY WHICH IT WAS DERIVED FROM WAS PERFORMED BY ME OR UNDER MY DIRECT SUPERVISION; THAT THIS AS-BUILT SURVEY WAS PERFORMED IN THE MONTH OF OCTOBER 2023; AND THAT THE INFORMATION SHOWN IS TRUE AND CORRECT TO THE BEST OF MY KNOWLEDGE AND BELIEF AND THAT IT MEETS ALL REQUIREMENTS LISTED UNDER THE STANDARD

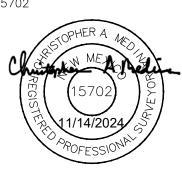

GRADING	LEGEND		
DESCRIPTION	EXISTING	PROPOSED	BY OTHERS
SPOT ELEVATION	40.00	TC:XX.XX FL:XX.XX	P:XX.XX
CONTOUR LINE	600	600	600
FLOW ARROW	(<u>X.X%</u>)	X.X%	

NOTES:


1. PERVIOUS/ IMPERVIOUS AREA:

EXISTING PERVIOUS-0.19 AC (19.5%) IMPERVIOUS-0.78 AC (80.5%)

<u>PROPOSED</u> PERVIOUS-0.20 AC (21%) IMPERVIOUS-0.77 AC (79%)

SEE SHEETS EH.01 AND EH.02 FOR

FULL EXHIBIT

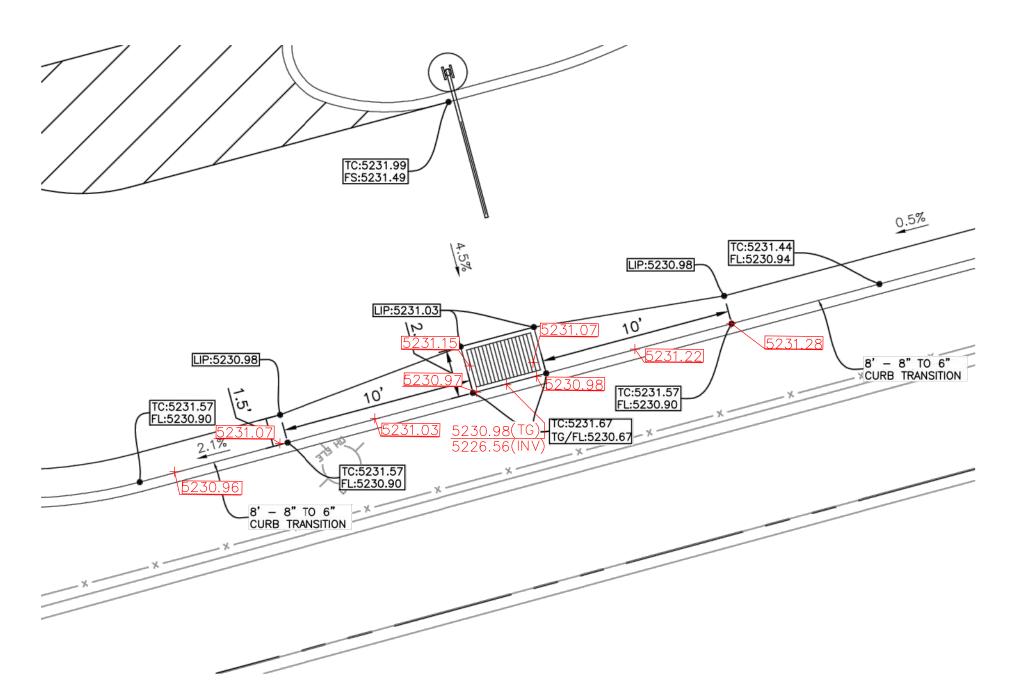

INLET GRADING DETAIL 1 SCALE: 1" = 5'

GRADING NARRATIVE:

THE PROPOSED LOT IS TO MATCH THE PREVIOUSLY APPROVED GRADING PLANS FOR THIS SITE. THE SITE DRAINS FROM EAST TO WEST AND IS COLLECTED VIA A GRATED INLET AND MEDIAN. THE SITE IS BOUNDED BY 98TH STREET TO THE EAST AND AN EXISTING PARKING LOT TO THE WEST.







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DRAWN BY:

PANDA PROJECT #: S8-23-D220241

D220241 PANDA STORE #: ARCH PROJECT #: 21229



Suite 1075 Overland Park, KS 66210 Telephone: (913) 322 - 1400 www.rtmec.com KS Certificate of Authority: E-2641

Heights Venture ARCHITECTURE : DESIGN

1111 North Loop West, Suite 800 5717 Legacy Drive, Suite 240 Houston, Texas 77008 Plano, Texas. 75024

PANDA EXPRESS

PANDA HOME - CUSTOM 261 98TH STREET ALBUQUERQUE, NM 87123

GRADING PLAN

C05.0

PANDA HOME - SQUARE CUSTOM

CONSTRUCTION