CITY OF ALBUQUERQUE

Planning Department Alan Varela, Interim Director



October 28, 2021

Shawn Biazar SBS Construction and Engineering, LLC 10209 Snowflake Ct. NW Albuquerque, NM 87114

RE: 8719 Central Ave NW Grading & Drainage Plan

Engineer's Stamp Date: 09/26/21

Hydrology File: K09D049

Dear Mr. Biazar:

Based upon the information provided in your submittal received 09/28/2021, the Grading and Drainage Plan is approved for Building Permit and Grading Permit. Since this site has an existing house and since the building is for a garage, a pad certification is not needed for this

project.

Please attach a copy of this approved plan in the construction sets for Building Permit processing along with a copy of this letter. Prior to approval in support of Permanent Release of Occupancy

by Hydrology, Engineer Certification per the DPM checklist will be required.

If you have any questions, please contact me at 924-3995 or rbrissette@cabq.gov.

if you have any questions, preuse contact the at 22 1 3750 of restricted designation.

www.cabq.gov

PO Box 1293

Albuquerque

NM 87103

Sincerely,

Renée C. Brissette, P.E. CFM Senior Engineer, Hydrology Planning Department

Renée C. Brissette

Find Hydrology forms and information at: cabq.gov/planning/development-review-services/hydrology-section



City of Albuquerque

Planning Department

Development & Building Services Division

DRAINAGE AND TRANSPORTATION INFORMATION SHEET (REV 6/2018)

Project Title: 8917 CENTRAL AVE. NW GARAGE ADD	Hydrology File #:			
DRB#:	EPC#:	Work Order#:		
Legal Description: LOT 15-A, BLOCK 7, OR				
City Address: 8917 CENTRAL AVENUE, NW				
Applicant: SBS CONSTRUCTION AND E	Contact: SHAWN BIAZAR			
Address: 7632 WILLIAM MOYERS AVE., NE				
Phone#: (505) 804-5013	Fax#: (505) 897-4996	E-mail: _AECLLC@AOL.COM		
Other Contact:				
Address:Phone#:				
TYPE OF DEVELOPMENT: PLA	AT (# of lots) X RESIDENCE	DRB SITE ADMIN SITE		
IS THIS A RESUBMITTAL? Yes	s X _{No}			
DEPARTMENT TRANSPORTATION	N X HYDROLOGY/DRAINA	AGE		
Check all that Apply: TYPE OF SUBMITTAL: ENGINEER/ARCHITECT CERTIFICAT: PAD CERTIFICATION CONCEPTUAL G & D PLAN X GRADING PLAN DRAINAGE REPORT DRAINAGE MASTER PLAN FLOODPLAIN DEVELOPMENT PERMI ELEVATION CERTIFICATE CLOMR/LOMR TRAFFIC CIRCULATION LAYOUT (TO TRAFFIC IMPACT STUDY (TIS) STREET LIGHT LAYOUT OTHER (SPECIFY) PRE-DESIGN MEETING?	X BUILDING CERTIFIC PRELIMING SITE PLA SITE PLA FINAL PI TAPPLIC SIA/ REL FOUNDA GRADING GRADING SO-19 AP PAVING GRADING GRADING CLOMR/I FLOODPI	PERMIT APPROVAL G/ PAD CERTIFICATION RDER APPROVAL		
DATE SUBMITTED: 09-28-2021	By: SHAWN BIAZAR			
COA STAFF:	ELECTRONIC SUBMITTAL RECEIVE	D:		

FEE PAID:_____

Location

lot 15-A, Block 7, Original Townsite of Westland, is located at 8719 Central Avenue, NW containing 0.933 acre. See attached portion of Vicinity Map K-9-Z for exact location.

Purpose

The purpose of this drainage report is to present a grading and drainage solution for 1140 SF of new garage and a future 1200 SF pool on this lot.

Existing Drainage Conditions

This lot is very flat and drains south to Central Ave., NW. No offiste runoff enters this site.

Proposed Conditions and On-Site Drainage Management Plan

The draiage patterns will remain the same. The additional runoff volume generated by the construction of the garage will be retained on site. The total volume requirement under proposed conditions is 658.40 CF. The retetion pond provided has a volume of 824.03 CF.

VOLUME CALCULATIONS FOR 10 DAY STORM

	BASIN	AREA	(SF)	AREA	(AC)	AREA	(MI ²)
Γ	ON-SITE	40,641.72		0.933		0.001458	

E = EA(AA) + EB(AB) + EC(AC) + ED(AD)AA + AB + AC + AD

V-360 = E(AA + AB + AC + AD)

EA = 0.55

EB = 0.73

EC = 0.95

ED = 2.24

P-60 = 1.69

P-360 = 2.17

P-1440 = 2.49

P-10 Day = 3.90

EXISTING CONDITIONS PROPOSED CONDITIONS

AA = 0.00%	AA = 0.00%
AB = 30.00%	AB = 24.00
AC = 50.00%	AC = 50.00
AD = 20.00%	$AD = 26.00^{\circ}$

1.1420 IN 1.2326 IN V-360 =0.0888 AC-FT V-360 =0.0958 AC-FT 0.1866 AC 0.2426 AC AD =V-10 DAY = 0.1157 AC-FTV-10 DAY = 0.1308 AC-FTV-10 DAY= 5,697.79 CF V-10 DAY= 5,039.57 CF

V (REQUIRED) = 5,697.97 - 5,039.57 = 658.40 CF


POND VOLUME REQUIRED FOR FIRST FLUSH


0.62 INCHES x IMPERVIOUS AREA = $(0.62/12 \times 2,340.00) = 120.09$ CF THIS VOLUME IS PART OF THE PONDING PROVIDED.

PONDING VOLUME CALCULATION

BOTTOM AREA (@ 5064)= 54.33 SF

TOP AREA (@5066) = 769.70 SFDEPTH = 2.00POND VOLUME=(769.70+54.33)/2*2 POND VOLUME=824.03 CF > 658.40 CF

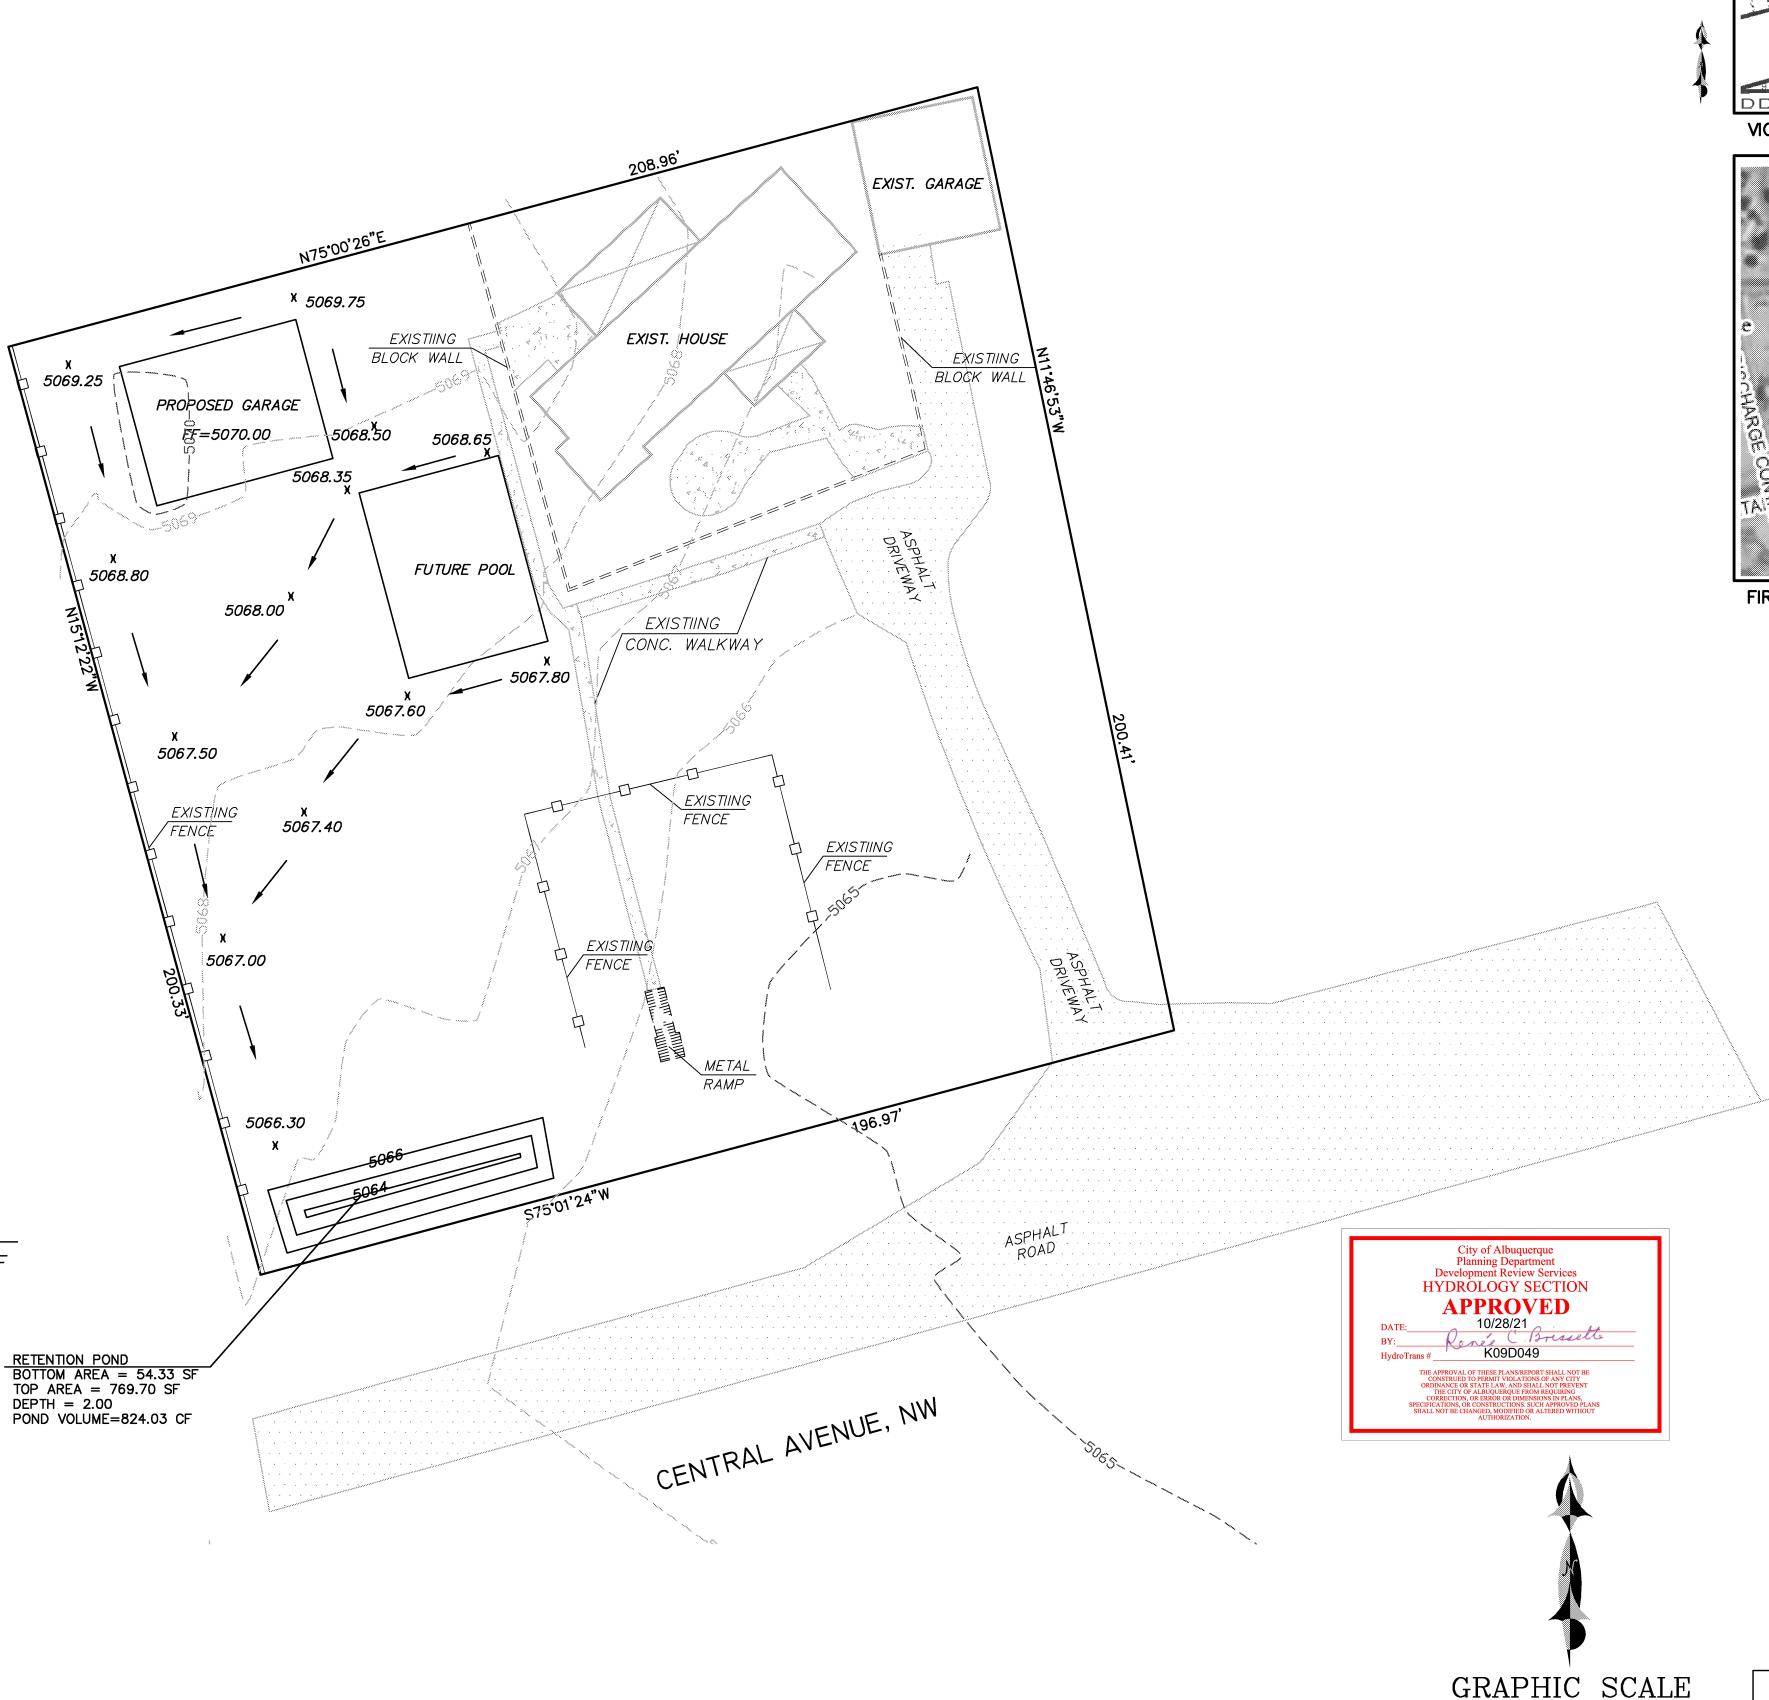

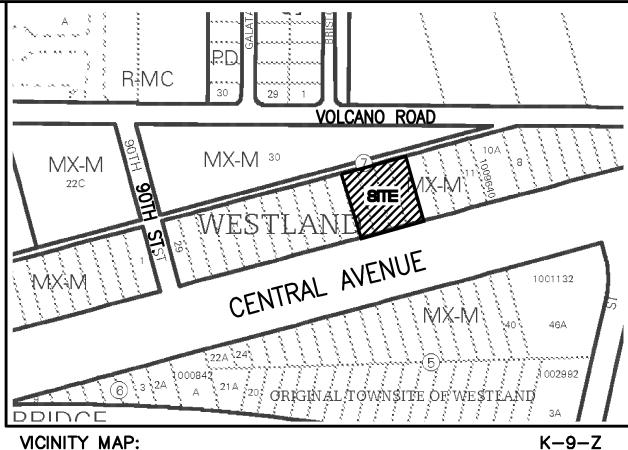

VICINITY MAP:



FIRM MAP:

35001C0328J

LEGAL DESCRIPTION:

LOT 15-A, BLOCK 7, ORIGINAL TOWNSITE OF WESTLAND

ADDRESS: 8719 CENTRAL AVE., NW

LEGEND

EXISTING CONTOUR (MAJOR) EXISTING CONTOUR (MINOR) BOUNDARY LINE PROPOSED SPOT ELEVATION X 42.70 EXISTING GRADE **★** 5029.16 × 5075.65 EXISTING FLOWLINE ELEVATION PROPOSED RETAINING WALL

BC = 41.30BOTTOM OF CHANEL

TF=42.00 TOP OF FOOTING TRW=45.12 TOP OF RETAINING WALL

HIGH POINT AS-BUILT GRADES

69.77 AS-BUILT SPOT ELEVATIONS

REZA AFAGHPOUR

SCALE: 1"=20'

SBS CONSTRUCTION AND ENGINEERING, LLC

7632 WILLIAM MOYERS AVE., NE ALBUQUERQUE, NEW MEXICO 87122 (505) 804-5013 EMAIL: AECLLC@AOL.COM

8719 CENTRAL AVE., NW NEW GARAGE **GRADING PLAN**

DRAWING: DRAWN BY: DATE: SHEET# 202115-GD.DWG SH-B 9-29-2021