

Precipitation Zone 1 - Albuquerque Renal Construction, LLC

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Basin	Area	Area	Area		tment A	THE RESERVE OF THE PARTY OF THE	ment B	Trea	ment C	Treat	ment D	Weighted E		100	Weighted E	1.000	200	Weighted E	Control of the Control	Flow
	(sf)		(sq miles)	%	(acres)	%	(acres)	~ % ~	(acres)	-	(acres)	(ac-ft)	(ac-ft)	cis	≪ (ac-ft)≪	(ac-ft)		(ac-ft)	(ac-ft)	cfs cfs
Impervious	32,873.3	0.755	0.00118	0%	0	0%	0.000	0%	.0	100%		1.970		3.30	1.240	\$		0.720 0.120	0.045	0.03
Pervious	2,388.8	0.055	0.00009	0%	0	0%	0.000	100%	0.054839	0%	0.000	0.990		0.16	0.440	0.002	0.08 2.26	0.120	0.046	1.30
Total	35,262.1	0.810	0.00126										0.128	3.46		0.000	2,20		0.040	1.50
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DISTURBANCE PERMIT PRIOR TO BEGINNING WORK.

THAT GETS INTO EXISTING RIGHT-OF-WAY.

ON SITE DURING CONSTRUCTION.

OF ANY PROJECT.

2. CONTRACTOR IS RESPONSIBLE FOR MAINTAINING RUN-OFF

3. CONTRACTOR IS RESPONSIBLE FOR CLEANING ALL SEDIMENT

4. REPAIR OF DAMAGED FACILITIES AND CLEANUP OF SEDIMENT ACCUMULATIONS ON ADJACENT PROPERTIES AND IN PUBLIC FACILITIES IS THE RESPONSIBILITY OF THE CONTRACTOR.

5. ALL EXPOSED EARTH SURFACES MUST BE PROTECTED FROM

WIND AND WATER EROSION PRIOR TO FINAL (CITY) ACCEPTANCE

Weighted $E = E_a^*A_a + E_b^*A_b + E_c^*A_c + E_d^*A_d / (Total Area)$ Volume = Weighted D * Total Area Flow = $Q_a * A_a + Q_b * A_b + Q_c * A_c + Q_d * A_d$

LEGEND CURB & GUTTER BOUNDARY LINE CENTERLINE RIGHT-OF-WAY BUILDING SIDEWALK SCREEN WALL RETAINING WALL - CONTOUR MAJOR CONTOUR MINOR SPOT ELEVATION FLOW ARROW EXISTING CURB & GUTTER **EXISTING BOUNDARY LINE** ---- EXISTING CONTOUR MINOR **EXISTING SPOT ELEVATION**

EXISTING BUILDING ×5107.04 GUARD RAIL PER DETAIL SHEET C3


GRADING AND DRAINAGE MANAGEMENT PLAN


reconfiguration.


PURPOSE The purpose of this Grading and Drainage Plan is to update the drainage

EXISTING CONDITIONS The site is a fully developed 0.809 acre lot located in Albuquerque NM on the hard northeast corner of Unser Boulevard and Sarracino Place, NW; identified as Tracts B-2 and B-3 of Hubbell Heights. The site contains a single story 20,635 square foot building, parking lot, and landscaped areas. The existing site conveys runoff to several drop inlets in the parking field, which connect to an existing storm drain system in Unser Blvd. The remaining flows are conveyed to Sarracino Place, and continue to Unser Blvd. via sheet and shallow concentrated flow, which also enter the Unser Blvd. storm drain system. An approved Drainage Plan was not available from City Hydrology, so peak discharge for the 100 yr, 10 yr, and 2 yr (6 hours) storm events have been calculated according to Chapter 22 of the DPM and can be seen in the table on this sheet. The site lies outside the flood hazard zone as indicated in the above FIMA Flood Map, and no offsite flows enter the property.

PROPOSED CONDITIONS The existing commercial building will be remodeled internally to accommodate a healthcare office for dialysis treatment. The parking field on the west side of the building will be reconfigured, with the below-grade delivery dock being filled in, to increase parking and better accommodate ADA accessibility throughout the site. The south edge of the site will be reconfigured to accommodate more parking spaces as well. An increase in pervious area in the form of landscape will result due to the parking lot reconfiguration; therefore the overall site discharge will decrease. The west parking area will continue to convey runoff to the existing two drop inlets and continue to the Unser storm drain. Further, the south parking area will convey runoff via sheet flow to Sarracino Place and flow to Unser Blvd. Therefore historic drainage patterns will not be diverted and peak discharge will decrease due to this proposed site remodel and parking lot

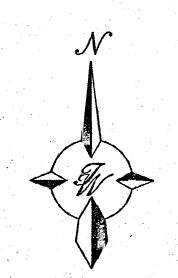

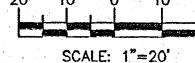

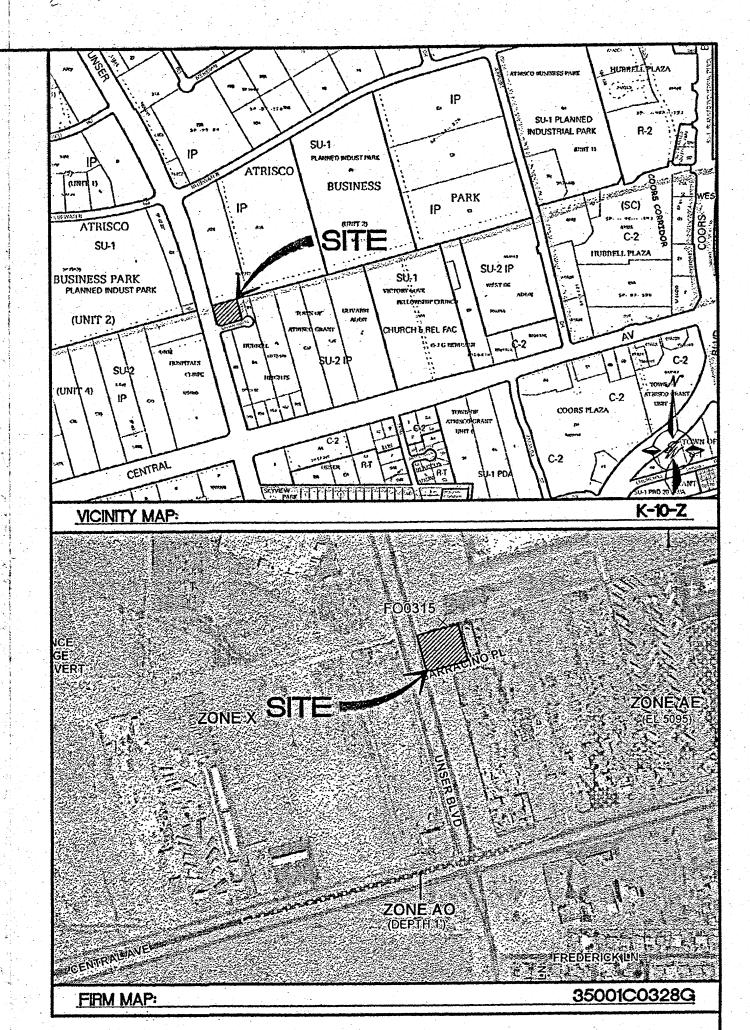

LEGAL DESCRIPTION

TRACTS B-2 AND B-3 HUBBELL HEIGHTS

1. GRADES ON CURB LINE ARE TO FLOWLINE UNLESS

NOTICE TO CONTRACTORS

- 1. AN EXCAVATION/CONSTRUCTION PERMIT WILL BE REQUIRED BEFORE BEGINNING ANY WORK WITHIN CITY RIGHT-OF-WAY.
- 2. ALL WORK DETAILED ON THESE PLANS TO BE PERFORMED, EXCEPT AS OTHERWISE STATED OR PROVIDED HERON, SHALL BE CONSTRUCTED IN ACCORDANCE WITH CITY OF ALBUQUERQUE INTERIM STANDARD SPECIFICATIONS FOR PUBLIC WORKS CONSTRUCTION, 1985.
- 3. TWO WORKING DAYS PRIOR TO ANY EXCAVATION, CONTRACTOR MUST CONTACT LINE LOCATING SERVICE, 765-1234, FOR LOCATION OF EXISTING UTILITIES.
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- 5. BACKFILL COMPACTION SHALL BE ACCORDING TO TRAFFIC/STREET USE.
- 6. MAINTENANCE OF THESE FACILITIES SHALL BE THE RESPONSIBILITY OF THE OWNER OF THE PROPERTY SERVED.
- 7. WORK ON ARTERIAL STREETS SHALL BE PERFORMED ON A 24-HOUR BASIS.

APPROVAL	NAME	DATE
INSPECTOR		

ROUGH GRADING APPROVAL


ENGINEER'S

RONALD R. BOHANNAN P.E. #7868

DRAWN BY ALBUQUERQUE RENAL DY CONSTRUCTION, LLC DATE 7/11/12 GRADING AND DRAINAGE PLAN 2012011-GRE SHEET # TIERRA WEST, LLC 5571 MIDWAY PARK PLACE NE

ALBUQUERQUE, NM 87109 (505) 858-3100 JOB # www.tierrawestilc.com 2012011 JAN 1 4 2015 AND DEVELOPMENT SECTION

DATE

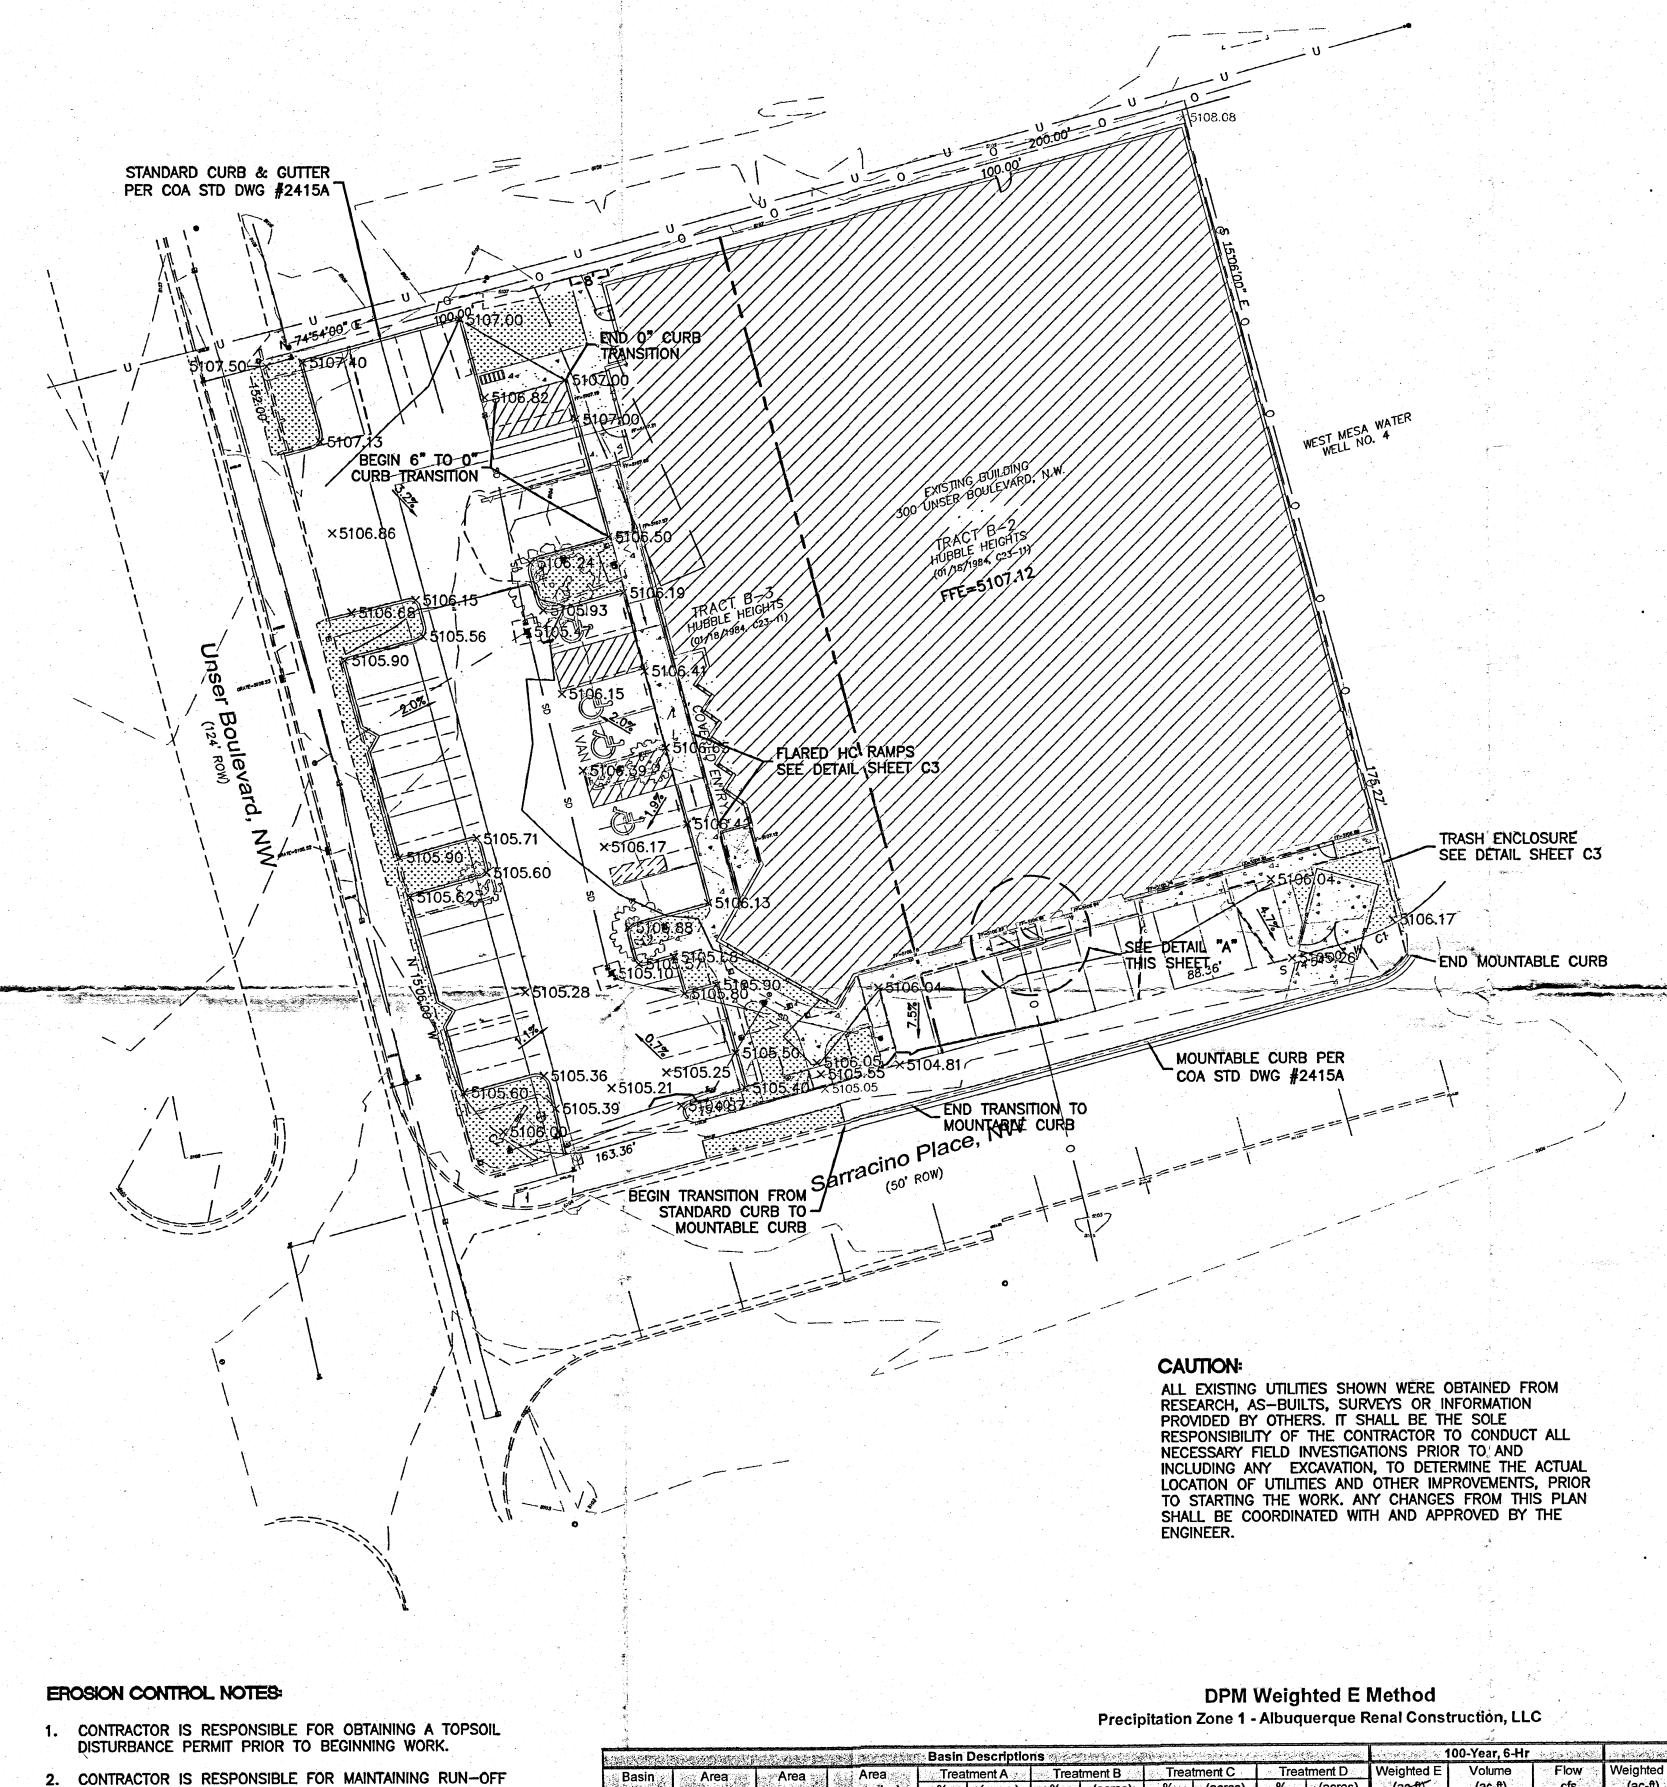

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Basin	Area	Area	Area		nent A		tment B	Trea	tment C	Treat	ment D	Weighted E	Volume	Flow	Weighted E	Volume	Flow	Weighted E	Volume	Flow
	(sf)	(acres)	(sq miles)	%	(acres)	, % ₋	(acres)	.%	(acres)	%	ु(acres)	(ae-ft)	(ac-ft)	cfs	(ac-ft)	(ac-ft)	cfs	(ac-ft)	(ac-ft)	cfs
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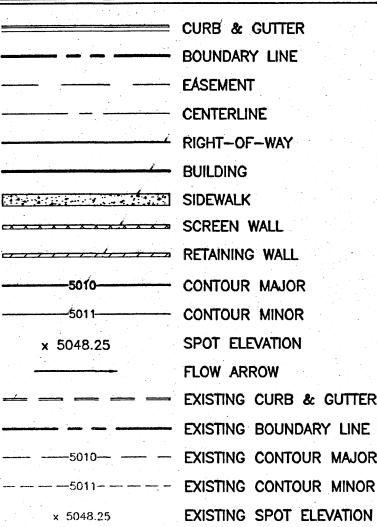
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Weighted $E = E_a A_a + E_b A_b + E_c A_c + E_d A_d / (Total Area)$ Volume = Weighted D * Total Area Flow = $Q_a * A_a + Q_b * A_b + Q_c * A_c + Q_d * A_d$

LEGEND




EXISTING BUILDING GUARD RAIL PER DETAIL SHEET C3 **DETAIL *A*** SC: 1"=5'

GRADING AND DRAINAGE MANAGEMENT PLAN

PURPOSE The purpose of this Grading and Drainage Plan is to update the drainage management plan for the above reference site for a Tenant Improvement for building

EXISTING CONDITIONS The site is a fully developed 0.809 acre lot located in Albuquerque NM on the hard northeast corner of Unser Boulevard and Sarracino Place, NW; identified as Tracts B-2 and B-3 of Hubbell Heights. The site contains a single story 20,635 square foot building, parking lot, and landscaped areas. The existing site conveys runoff to several drop inlets in the parking field, which connect to an existing storm drain system in Unser Blvd. The remaining flows are conveyed to Sarracino Place, and continue to Unser Blvd. via sheet and shallow concentrated flow, which also enter the Unser Blvd. storm drain system. An approved Drainage Plan was not available from City Hydrology, so peak discharge for the 100 yr, 10 yr, and 2 yr (6 hours) storm events have been calculated according to Chapter 22 of the DPM and can be seen in the table on this sheet. The site lies outside the flood hazard zone as indicated in the above FIMA Flood Map, and no offsite flows enter the property.

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JRACTS B-2 AND B-3 HUBBELL HEIGHTS

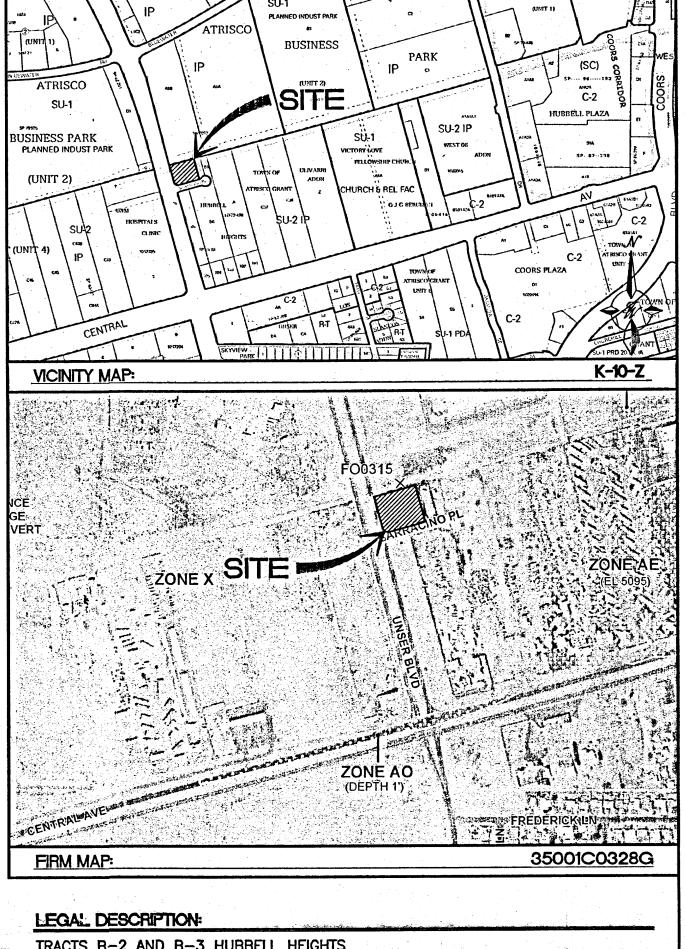
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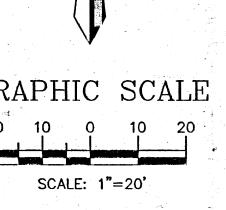
NOTICE TO CONTRACTORS


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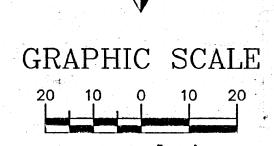
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APPROVAL	NAME	DATE	
INSPECTOR			


DATE ROUGH GRADING APPROVAL





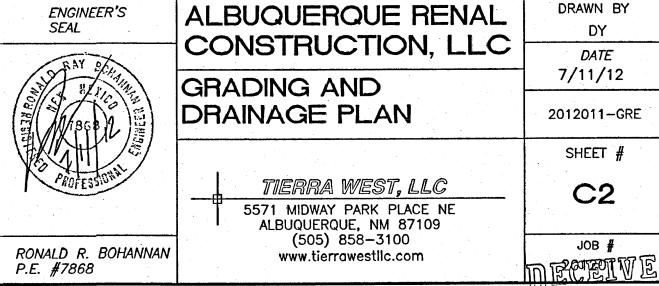

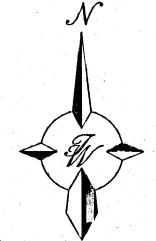

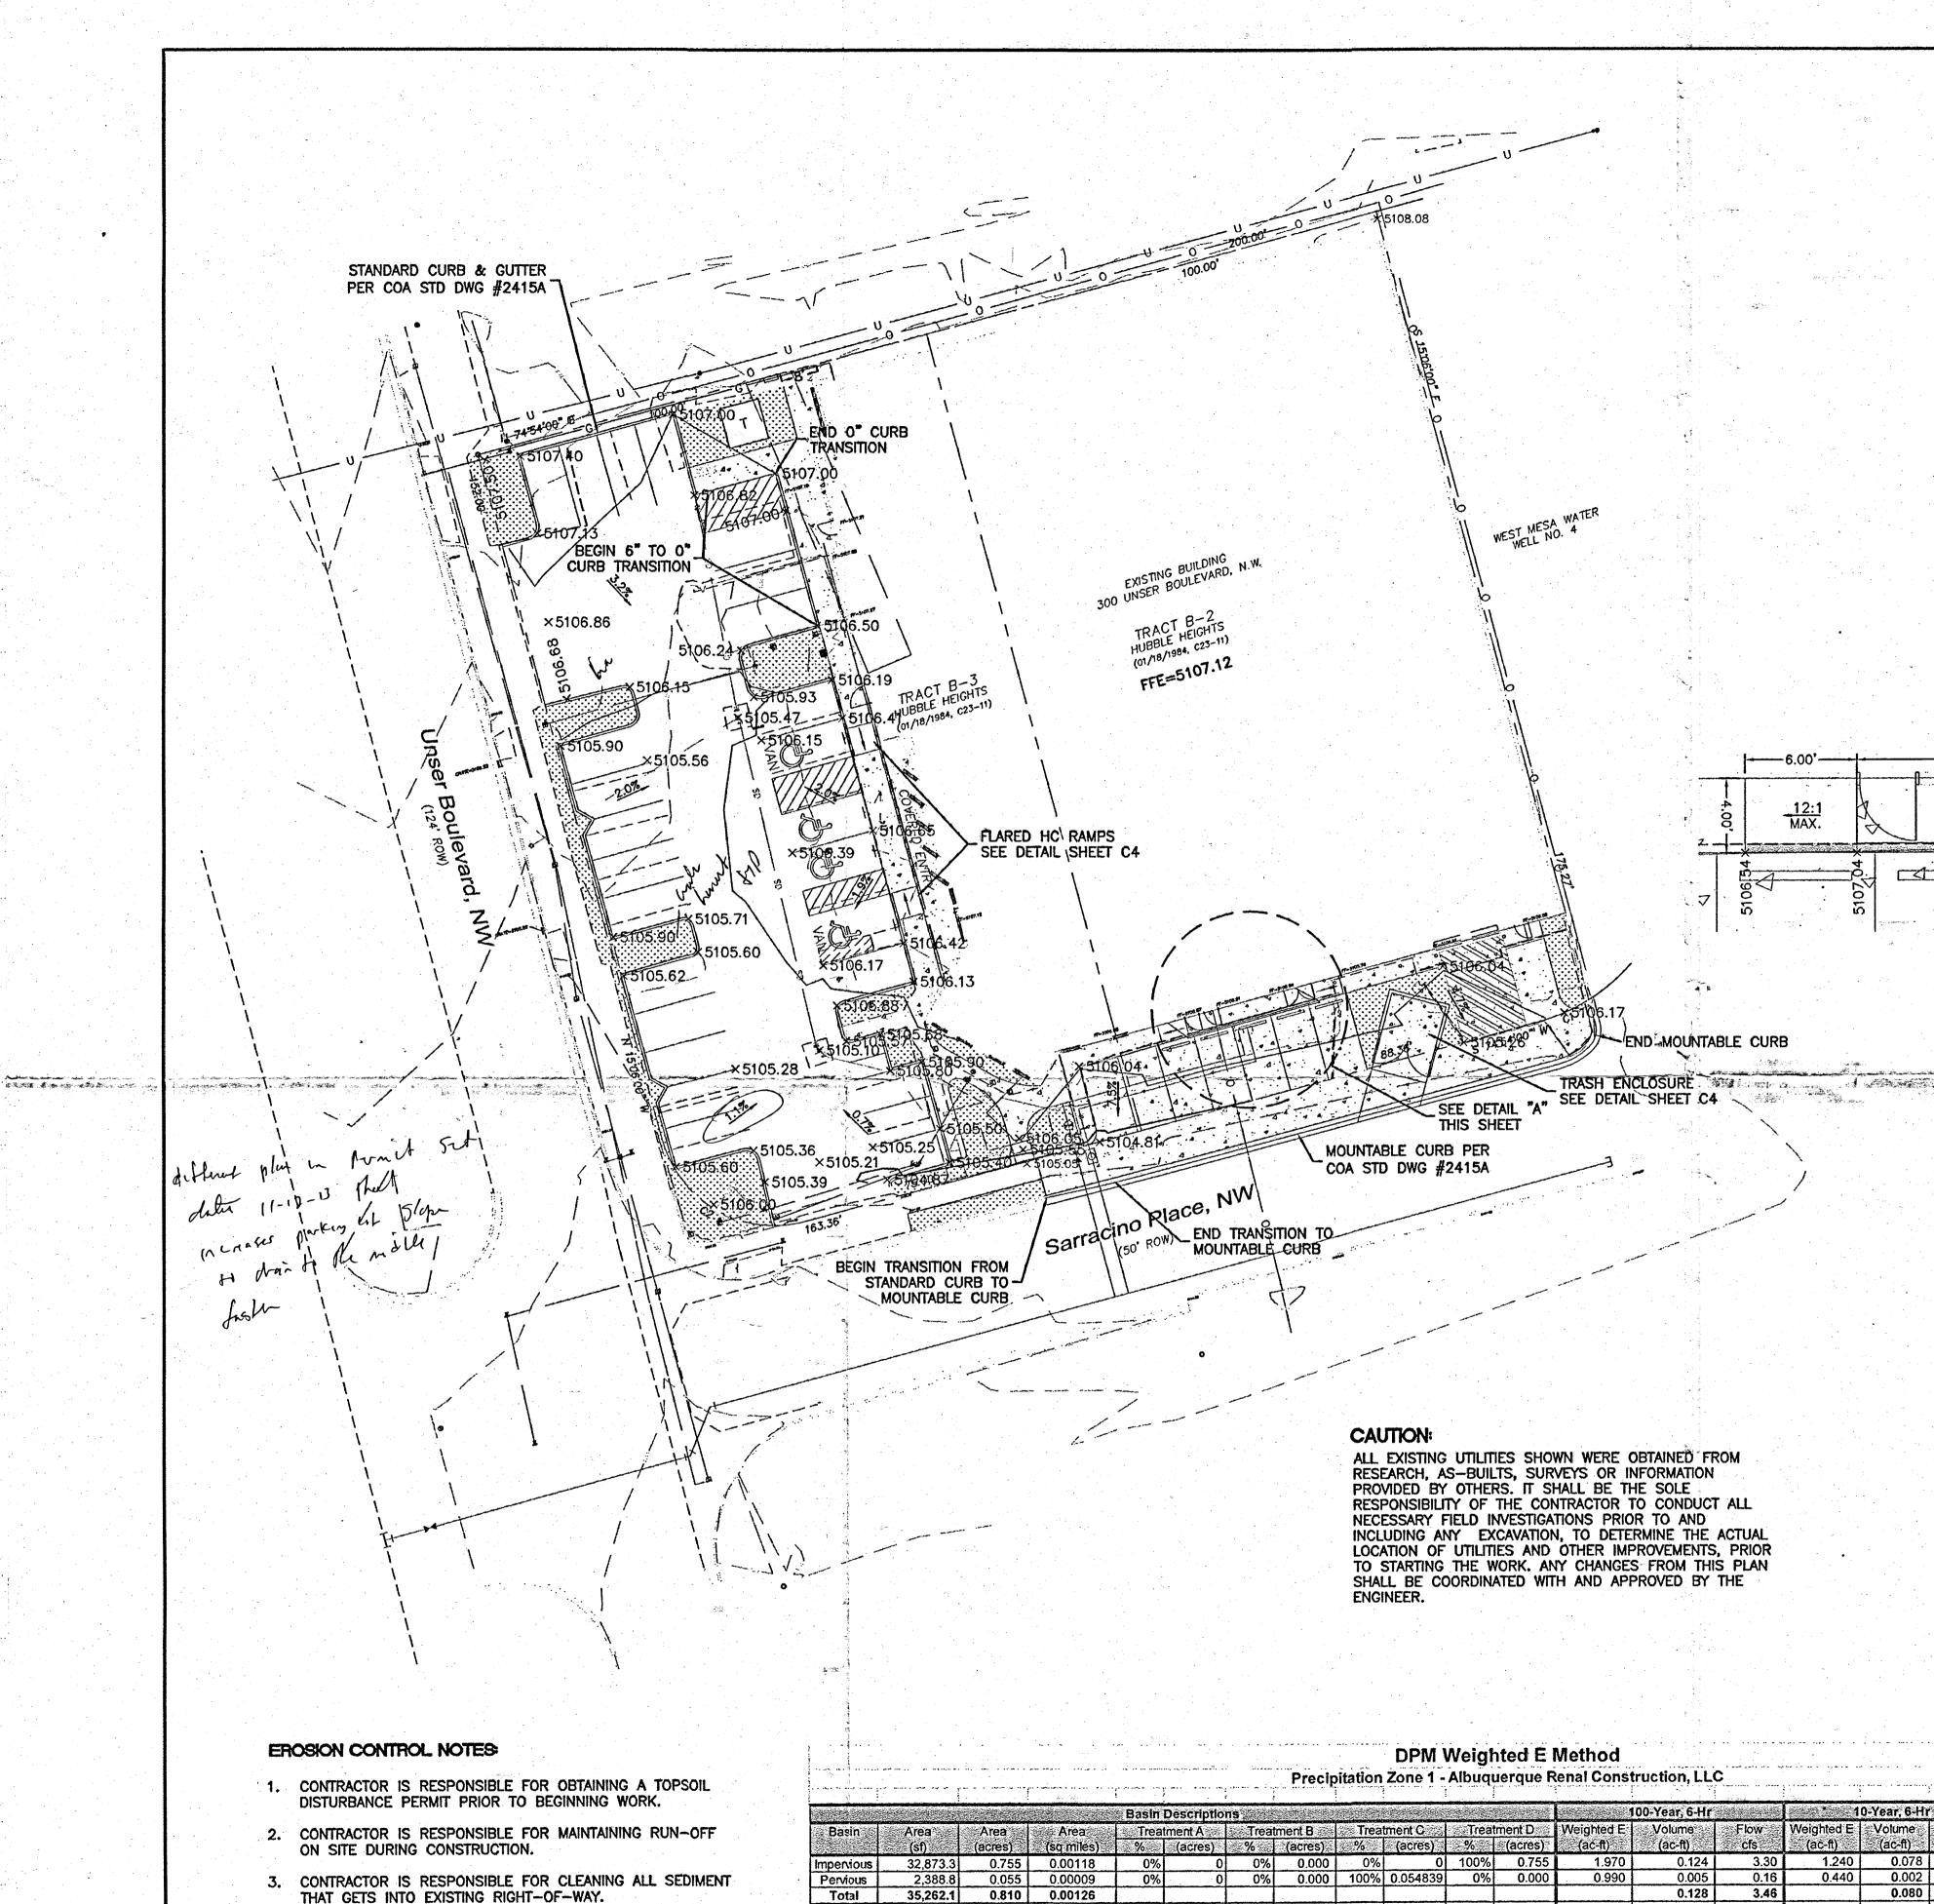

Weighted $E = E_a A_a + E_b A_b + E_c A_c + E_d A_d / (Total Area)$

Volume = Weighted D * Total Area

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WIND AND WATER EROSION PRIOR TO FINAL (CITY) ACCEPTANCE

GRADING AND DRAINAGE MANAGEMENT PLAN

GUARD RAIL PER DETAIL SHEET C3

EXISTING BUILDING

LEGEND

SIDEWALK

SCREEN WALL

RETAINING WALL

CONTOUR MINOR

SPOT ELEVATION

EXISTING CURB & GUTTER

EXISTING CONTOUR MAJOR

FLOW ARROW

----- EXISTING CONTOUR MINOR

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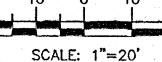
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GRAPHIC SCALE



ENGINEER'S

P.E. #7868

ALBUQUERQUE RENAL CONSTRUCTION, LLC

> TIERRA WEST, LLC 5571 MIDWAY PARK PLACE NE ALBUQUERQUE, NM 87109 (505) 858-3100 www.tierrawestllc.com

2012011

K-10-Z

LEGAL DESCRIPTION:

BUSINESS PARK

VICINITY MAP:

1. GRADES ON CURB LINE ARE TO FLOWLINE UNLESS OTHERWISE SPECIFIED.

NOTICE TO CONTRACTORS

BUSINESS


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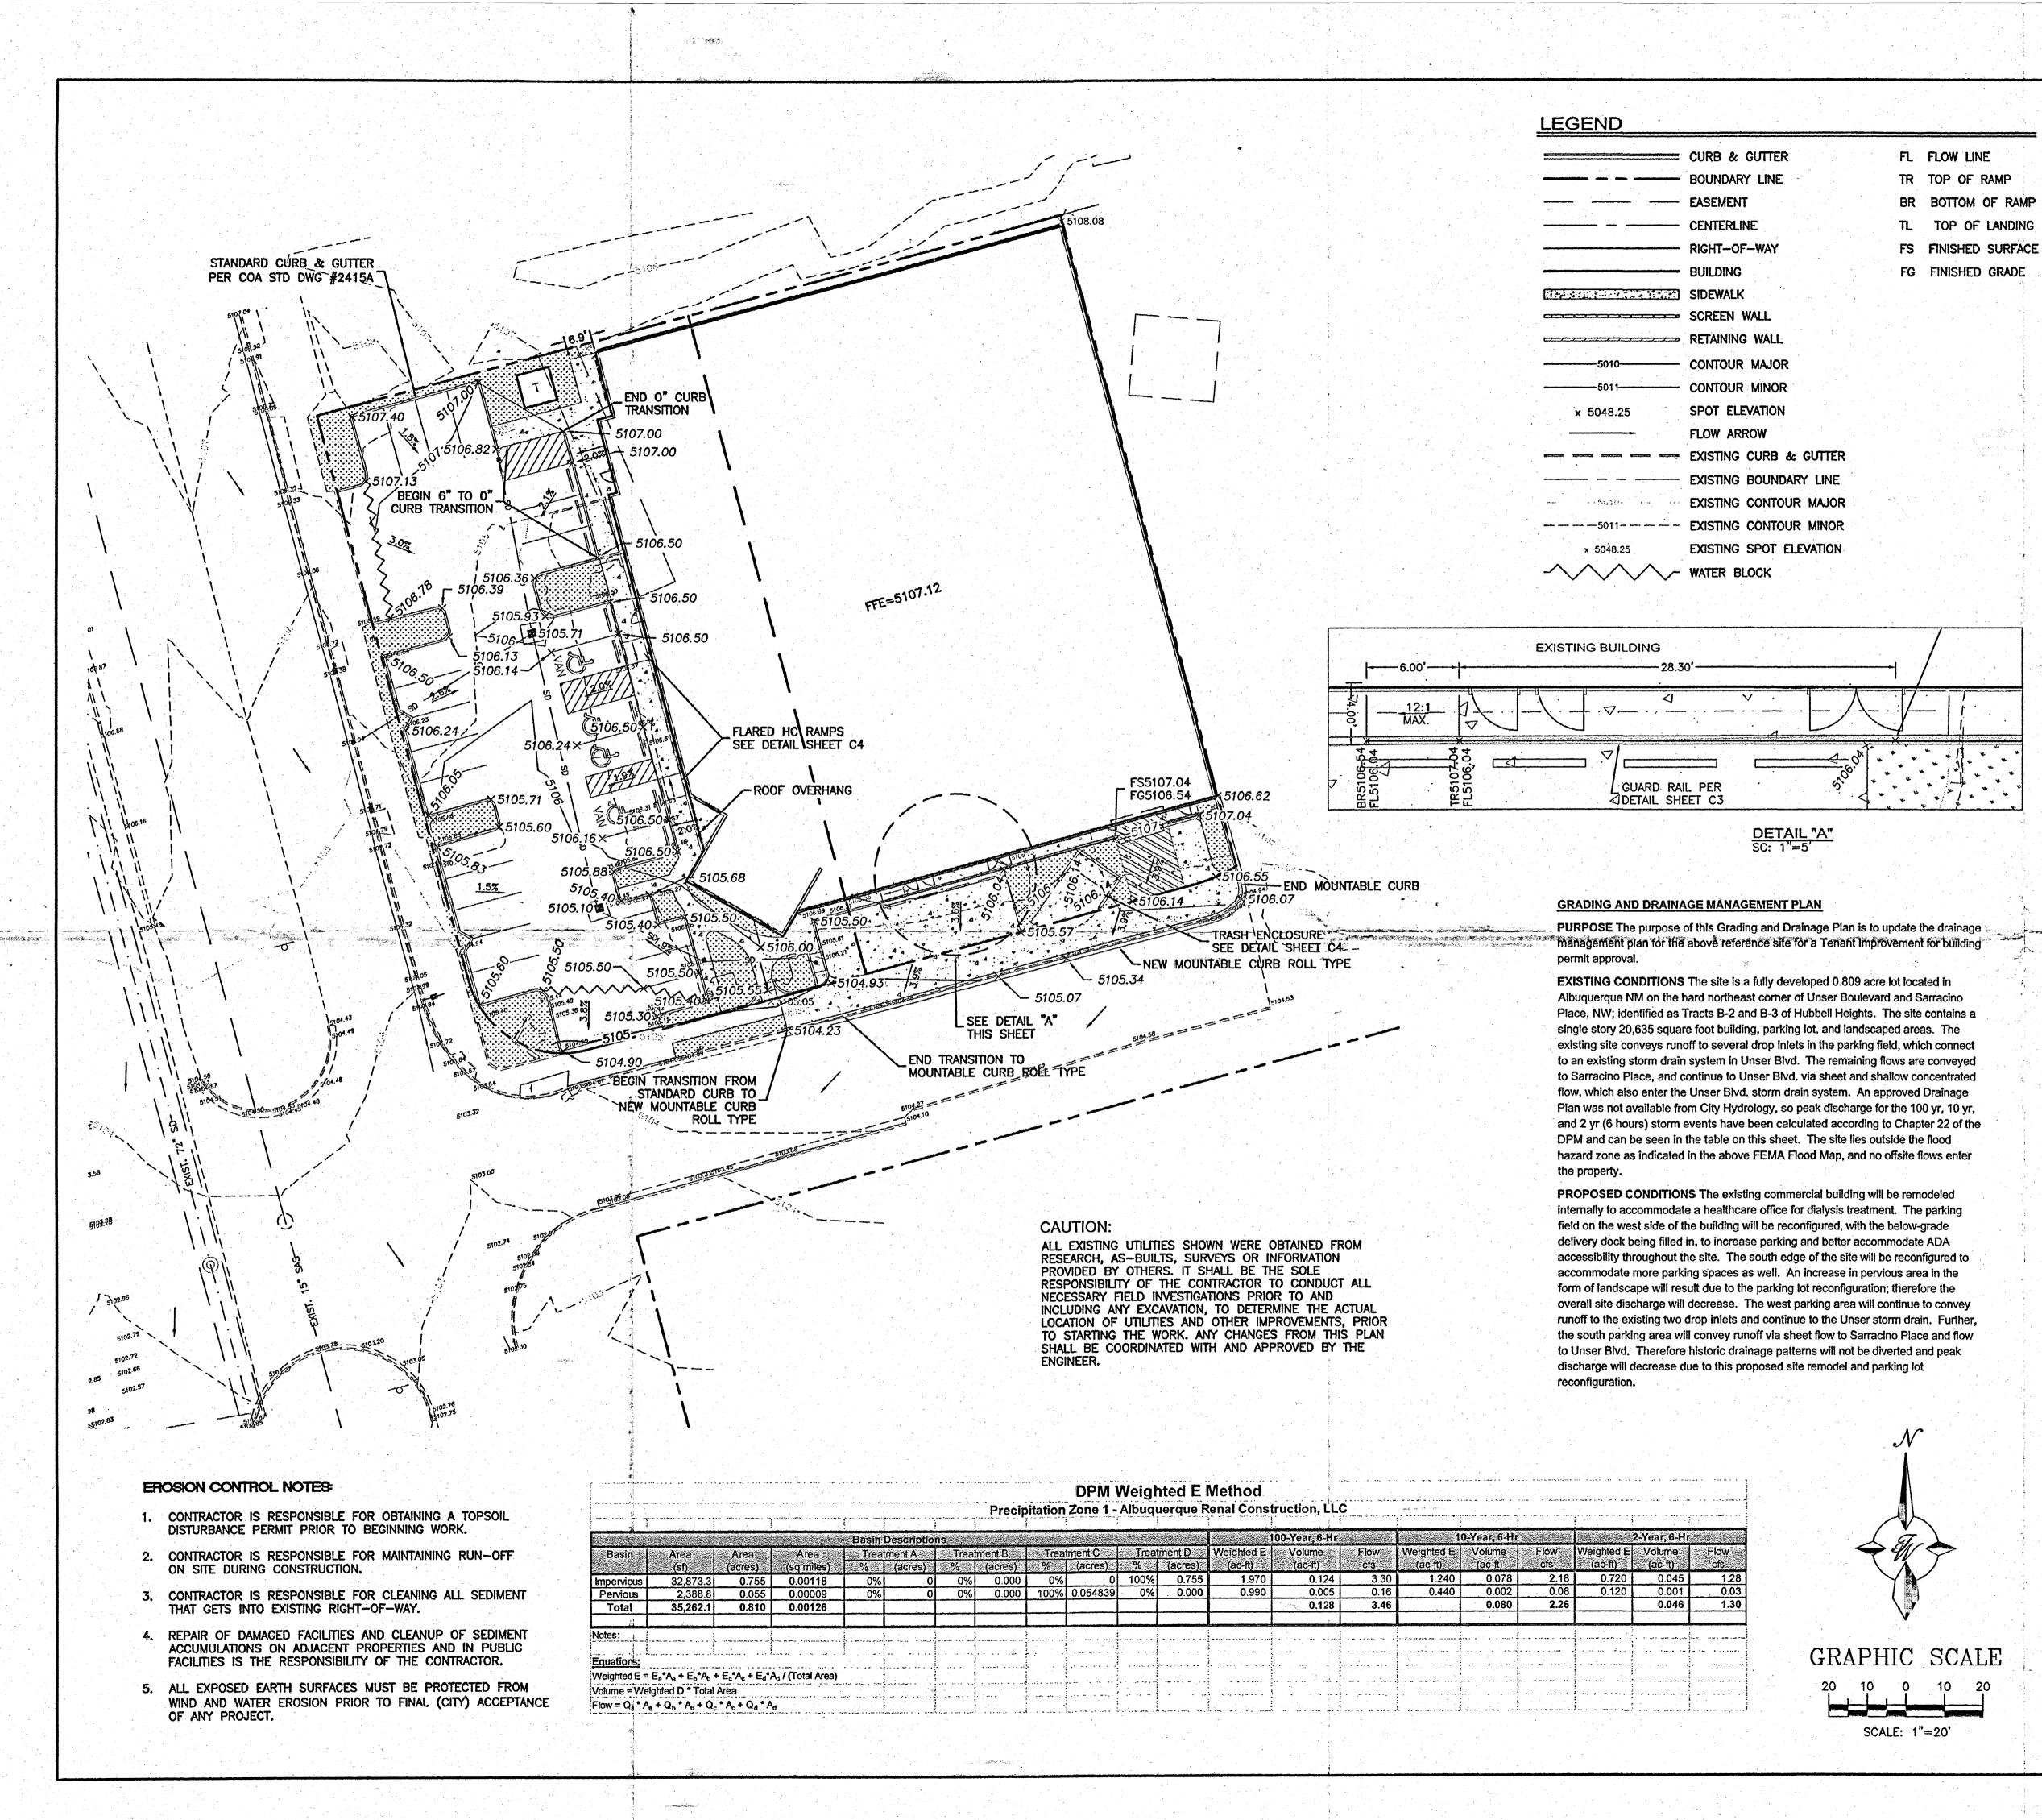
APPROVAL	NAME	DATE
INSPECTOR		


ROUGH GRADING APPROVAL

DRAWN BY DY DATE 9/24/13 GRADING AND DRAINAGE PLAN 2012011-GRE SHEET # JOB # RONALD R. BOHANNAN

DATE



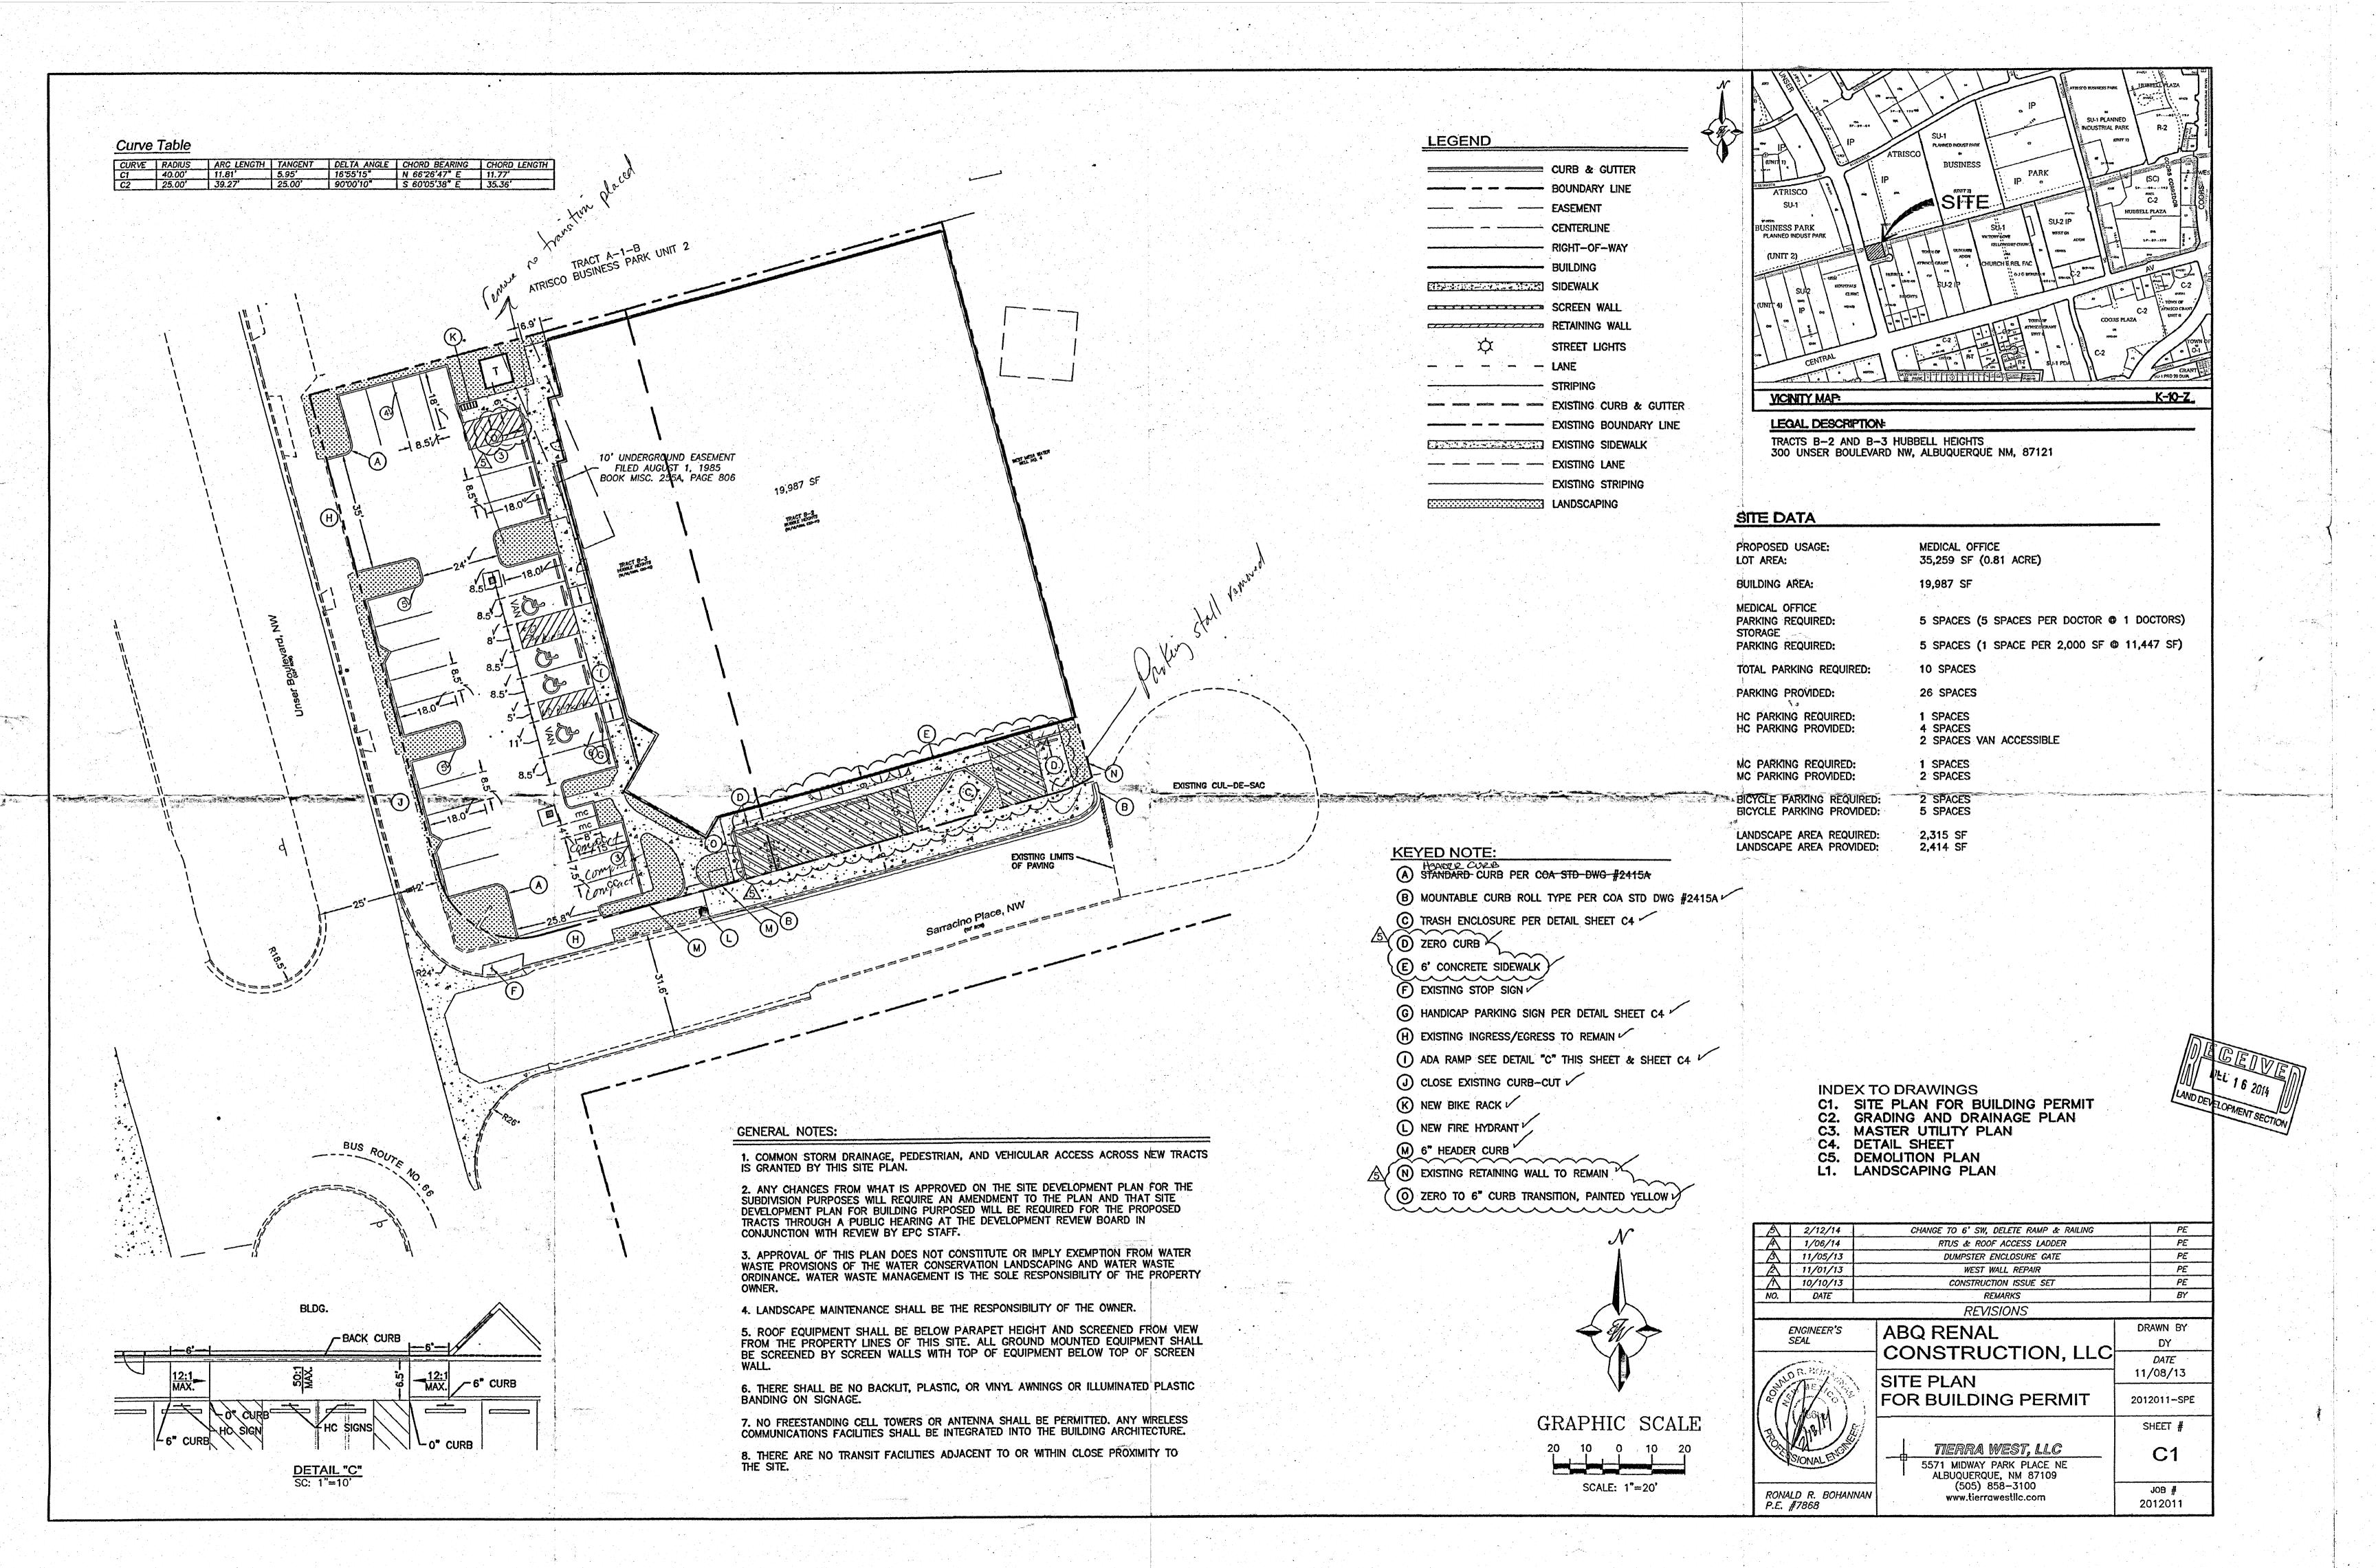

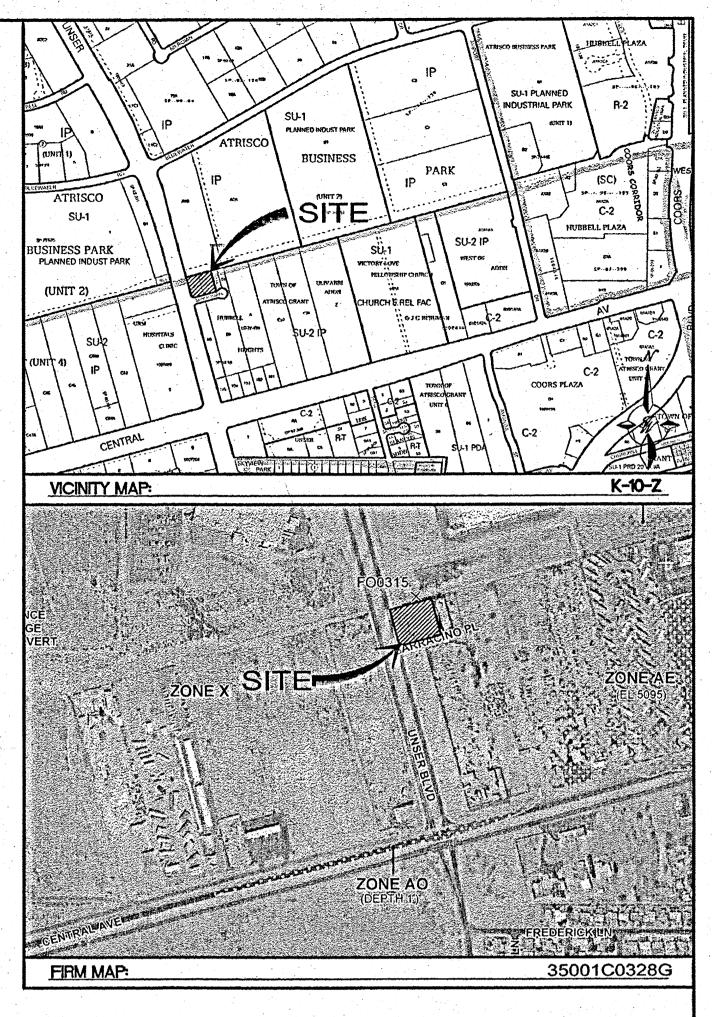

LEGAL DESCRIPTION:

TRACTS B-2 AND B-3 HUBBELL HEIGHTS

NOTES:

P.E. #7868

1. GRADES ON CURB LINE ARE TO FLOWLINE UNLESS OTHERWISE SPECIFIED.

2. ADJUST DROP INLET GRATE ELEVATIONS PER PLAN.

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APPROVAL	_	NAM	IE		DATE
INSPECTOR					

ROUGH GRADING APPROVAL

DRAWN BY **ABQ RENAL** ENGINEER'S SEAL DY CONSTRUCTION, LLC 11/08/13 **GRADING AND** DRAINAGE PLAN 2012011-GRE SHEET # TIERRA WEST. LLC 5571 MIDWAY PARK PLACE NE ALBUQUERQUE, NM 87109 (505) 858-3100 JOB # RONALD R. BOHANNAN www.tierrawestllc.com

DEC 0 9 2013

LAND DEVELOPMENT SECTION

DATE