GENERAL CONSTRUCTION NOTES

GENERAL

CONTRACTOR IS RESPONSIBLE FOR OBTAINING ALL REQUIRED CONSTRUCTION PERMITS, INCLUDING A TOP SOIL DISTURBANCE PERMIT, PRIOR TO START OF CONSTRUCTION.

ALL WORK ON THIS PROJECT SHALL BE PERFORMED IN ACCORDANCE WITH APPLICABLE FEDERAL, STATE, AND LOCAL LAWS. ORDINANCES. AND REGULATIONS CONCERNING CONSTRUCTION SAFETY AND HEALTH.

REFERENCES MADE TO STANDARD SPECIFICATIONS AND STANDARD DRAWINGS REFER TO THE CITY OF ALBUQUERQUE STANDARD SPECIFICATIONS FOR PUBLIC WORKS CONSTRUCTION, 1986 EDITION WITH ALL UPDATES.

THE CONTRACTOR SHALL NOT INSTALL ITEMS AS SHOWN ON THESE PLANS WHEN IT IS OBVIOUS THAT FIELD CONDITIONS ARE DIFFERENT THAN SHOWN IN THE PLANS. SUCH CONDITIONS SHALL BE BROUGHT TO THE ATTENTION OF THE ENGINEER IN A TIMELY MANNER. IN THE EVENT THE CONTRACTOR DOES NOT NOTIFY THE ENGINEER IN A TIMELY MANNER, THE CONTRACTOR ASSUMES FULL RESPONSIBILITY AND EXPENSE FOR ANY REVISIONS NECESSARY, INCLUDING ENGINEERING DESIGN FEES.

EXISTING SITE IMPROVEMENTS WHICH ARE DAMAGED OR DISPLACED BY THE CONTRACTOR SHALL BE REMOVED AND REPLACED BY THE CONTRACTOR AT THE CONTRACTOR'S EXPENSE. REPAIRS SHALL BE APPROVED BY THE OWNER PRIOR TO CONSTRUCTION OF THE REPAIRS. REPAIRS SHALL BE ACCEPTED BY THE OWNER PRIOR TO FINAL PAYMENT.

EXISTING FENCING THAT IS NOT DESIGNATED FOR REMOVAL SHALL NOT BE DISTURBED. ANY FENCING THAT IS DISTURBED OR ALTERED BY THE CONTRACTOR SHALL BE RESTORED TO ITS ORIGINAL CONDITION AT THE CONTRACTORS EXPENSE. IF THE CONTRACTOR DESIRES TO REMOVE FENCING TO ACCOMMODATE CONSTRUCTION ACTIVITIES, THE CONTRACTOR SHALL OBTAIN THE OWNER'S WRITTEN PERMISSION BEFORE THE FENCE IS REMOVED. CONTRACTOR SHALL RESTORE THE FENCE TO ITS ORIGINAL CONDITION AT THE EARLIEST OPPORTUNITY. WHILE ANY FENCING IS REMOVED, THE CONTRACTOR SHALL BE SOLELY RESPONSIBLE FOR SECURITY OF THE SITE UNTIL THE FENCE IS RESTORED.

WORK WITHIN ADJACENT RIGHT-OF-WAY

PRIOR TO BEGINNING ANY CONSTRUCTION ACTIVITIES WITHIN ADJACENT RIGHT-OF-WAYS OR WITHIN PROPERTY NOT OWNED BY THE OWNER OF THE PROJECT SITE, THE CONTRACTOR SHALL ASSURE THAT ALL PERMITS AND PERMISSIONS REQUIRED HAVE BEEN OBTAINED IN WRITING.

SURVEY MONUMENTS, PROPERTY CORNERS, BENCHMARKS

THE CONTRACTOR SHALL NOTIFY THE OWNER AT LEAST SEVEN DAYS BEFORE BEGINNING ANY CONSTRUCTION ACTIVITY THAT COULD DAMAGE OR DISPLACE SURVEY MONUMENTS, PROPERTY CORNERS, OR PROJECT BENCHMARKS SO THESE ITEMS MAY BE RELOCATED.

ANY SURVEY MONUMENTS, PROPERTY CORNERS, OR BENCHMARKS THAT ARE NOT IDENTIFIED FOR RELOCATION ARE THE RESPONSIBILITY OF THE CONTRACTOR TO PRESERVE AND PROTECT, RELOCATION OR REPLACEMENT OF THESE ITEMS SHALL BE DONE BY THE OWNER'S SURVEYOR AT THE EXPENSE OF THE CONTRACTOR.

DIMENSIONS

- ALL DIMENSIONS TO CURBS ARE TO THE FLOWLINE UNLESS OTHERWISE NOTED.
- ALL STATIONING IS TO THE CENTERLINE OF THE RIGHT-OF-WAY UNLESS OTHERWISE NOTED.
- ALL SLOPES AND GRADES ARE IN PERCENT UNLESS OTHERWISE NOTED.

CURB ELEVATIONS ARE SHOWN AT THE FLOW LINE UNLESS OTHERWISE NOTED. SEE THE DETAIL SHEET TO DETERMINE THE CURB HEIGHT ABOVE FLOW LINE.

SOILS

UNLESS OTHERWISE SPECIFIED, SUBGRADE, ENGINEERED FILL, AND STRUCTURAL FILL SHALL BE COMPACTED TO THE FOLLOWING SPECIFICATIONS OF THE ASTM D-1557 MAXIMUM DRY DENSITY.

MATERIAL/LOCATION	PERCENT COMPACTION
STRUCTURAL FILL IN THE BUILDING AREA	95%
SUBBASE FOR SLAB SUPPORT	95%
MISCELLANEOUS BACKFILL BELOW STRUCTURAL	_
FILL OR ROADWAY PAVEMENT	95%
MISCELLANEOUS BACKFILL BELOW UNPAVED,	
NON-BUILDING AREAS	90%
ROADWAY PAVEMENT SUBGRADE	95%
SIDEWALK SUBGRADE	90%
CURB AND GUTTER SUBGRADE	95%

PAVEMENT

WHEN ABUTTING NEW PAVEMENT TO EXISTING PAVEMENT, CUT EXISTING PAVEMENT EDGE TO A NEAT, STRAIGHT LINE AS NECESSARY TO REMOVE ANY BROKEN OR CRACKED PAVEMENT AND MATCH NEW PAVEMENT ELEVATION TO

ALL UTILITIES AND UTILITY SERVICE LINES SHALL BE INSTALLED AND APPROVED PRIOR TO PAVING.

ALL WATER VALVE BOXES AND ELECTRICAL, TELEPHONE, TELEVISION, AND SEWER MANHOLES IN THE CONSTRUCTION AREA SHALL BE ADJUSTED TO FINISHED GRADE BEFORE PAVING.

WHEN SIDEWALK OR CURB AND GUTTER IS REMOVED, IT SHALL BE REMOVED TO EXISTING CONSTRUCTION JOINTS. CUTTING OR BREAKING SHALL NOT BE ALLOWED.

LEGEND

	EX BLOCK WALL	\$	LIGHT POLE		EX SD INLET
x G 89.5	EX SPOT ELEV.	A	EX FIRE HYDRANT	is	CONCRETE
♦ FL 09.3	PROP SPOT ELEV.	•	EX WATER VALVE		EX WATER METER
5160	EX BLOCK WALL	0	EX SD MANHOLE	63	EXIST. TREE
\boxtimes	TRANSFORMER	S	EX SAS MANHOLE		

UTILITI

IF ANY UTILITY LINES, PIPELINES, OR UNDERGROUND UTILITY LINES ARE SHOWN ON THESE DRAWINGS, THEY ARE SHOWN IN AN APPROXIMATE LOCATION ONLY BASED ON THE INFORMATION PROVIDED TO THE ENGINEER BY OTHERS. THIS INFORMATION MAY BE INACCURATE OR INCOMPLETE. ADDITIONALLY, UNDERGROUND LINES MAY EXIST THAT ARE NOT SHOWN. THE CONTRACTOR SHALL VERIFY THE LOCATION OF ANY UTILITY LINE, PIPELINE, OR UNDERGROUND UTILITY LINE IN OR NEAR THE AREA OF THE WORK IN ACCORDANCE WITH CHAPTER 62, ARTICLE 14-1, THROUGH 14-8, NMSA 1978.

THE CONTRACTOR SHALL CONTACT THE STATEWIDE UTILITY LOCATOR SERVICE AT 1-800-321-2537 AT LEAST TWO WORKING DAYS BEFORE BEGINNING CONSTRUCTION. AFTER THE UTILITIES ARE SPOTTED, THE CONTRACTOR SHALL EXPOSE ALL PERTINENT UTILITIES TO VERIFY THEIR VERTICAL AND HORIZONTAL LOCATION. IF A CONFLICT EXISTS BETWEEN EXISTING UTILITIES AND PROPOSED CONSTRUCTION, THE CONTRACTOR SHALL NOTIFY THE ENGINEER SO THAT THE CONFLICT CAN BE RESOLVED WITH MINIMAL DELAY.

THE CONTRACTOR SHALL EXERCISE DUE CARE TO AVOID DISTURBING ANY EXISTING UTILITIES, ABOVE OR BELOW GROUND. UTILITIES THAT ARE DAMAGED BY CARELESS CONSTRUCTION SHALL BE REPAIRED OR REPLACED AT THE CONTRACTOR'S EXPENSE.

EXISTING VALVES SHALL ONLY BE OPERATED BY THE UTILITY COMPANY. CONTRACTOR SHALL NOTIFY THE UTILITY A MINIMUM OF TWO WORKING DAYS BEFORE ANY VALVE, NEW OR EXISTING, NEEDS TO BE OPERATED.

THE CONTRACTOR SHALL COORDINATE ANY REQUIRED UTILITY INTERRUPTIONS WITH THE OWNER AND AFFECTED UTILITY COMPANY A MINIMUM OF THREE WORKING DAYS BEFORE THE INTERRUPTION.

THE CONTRACTOR SHALL MAINTAIN A RECORD DRAWING SET OF PLANS AND PROMPTLY LOCATE ALL UTILITIES, EXITING OR NEW, IN THEIR CORRECT LOCATION, HORIZONTAL AND VERTICAL. THIS RECORD SET OF DRAWINGS SHALL BE MAINTAINED ON THE PROJECT SITE AND SHALL BE AVAILABLE TO THE OWNER AND ENGINEER AT ANY TIME DURING CONSTRUCTION.

EROSION CONTROL, ENVIRONMENTAL PROTECTION, AND STORM WATER POLLUTION PREVENTION PLAN

THE CONTRACTOR SHALL CONFORM TO ALL CITY, COUNTY, STATE, AND FEDERAL DUST AND EROSION CONTROL REGULATIONS. THE CONTRACTOR SHALL OBTAIN AND PREPARE ANY DUST CONTROL OR EROSION CONTROL PERMITS REQUIRED FROM THE REGULATORY AGENCIES.

THE CONTRACTOR SHALL PROMPTLY REMOVE ANY MATERIAL EXCAVATED WITH THE PUBLIC RIGHT-OF-WAY OR ADJACENT PROPERTY TO KEEP IT FROM WASHING OFF THE PROJECT SITE.

THE CONTRACTOR SHALL ENSURE THAT NO SOIL ERODES FROM THE SITE ONTO ADJACENT PROPERTY BY CONSTRUCTION OF TEMPORARY EROSION CONTROL BERMS OR INSTALLING SILT FENCES AT THE PROPERTY LINES AND WETTING THE SOIL TO PREVENT IT FROM BLOWING.

WATERING, AS REQUIRED FOR CONSTRUCTION DUST CONTROL, SHALL BE CONSIDERED INCIDENTAL TO CONSTRUCTION AND NO MEASUREMENT OR PAYMENT SHALL BE MADE. CONSTRUCTION AREAS SHALL BE WATERED FOR DUST CONTROL IN COMPLIANCE WITH GOVERNMENT ORDINANCES. THE CONTRACTOR SHALL BE RESPONSIBLE FOR LOCATING AND SUPPLYING WATER AS REQUIRED.

ANY AREAS DISTURBED BY CONSTRUCTION AND NOT COVERED BY LANDSCAPING OR IMPERVIOUS SURFACES SHALL BE REVEGETATED WITH RECLAMATION SEEDING.

THE CONTRACTOR SHALL PROPERLY HANDLE AND DISPOSE OF ALL ASPHALT REMOVED ON THE PROJECT BY HAULING IT TO AN APPROVED DISPOSAL SITE IN ACCORDANCE WITH THE REQUIREMENTS OF THE NEW MEXICO SOLID WASTE ACT.

ALL WASTE PRODUCTS FROM THE CONSTRUCTION SITE, INCLUDING ITEMS DESIGNED FOR REMOVAL, CONSTRUCTION WASTE, CONSTRUCTION EQUIPMENT WASTE PRODUCTS (OIL, GAS, TIRES, ETC.), GARBAGE, GRUBBING, EXCESS CUT MATERIAL, VEGETATIVE DEBRIS, ETC.. SHALL BE APPROPRIATELY DISPOSED OF OFFSET AT NO ADDITIONAL COST TO THE OWNER. IT SHALL BE THE CONTRACTOR'S RESPONSIBILITY TO OBTAIN ANY PERMITS REQUIRED FOR HAUL OR DISPOSAL OF WASTE PRODUCTS, IT SHALL BE THE CONTRACTOR'S RESPONSIBILITY TO ENSURE THAT THE WASTE DISPOSAL SITE COMPLIES WITH GOVERNMENT REGULATIONS REGARDING THE ENVIRONMENT, ENDANGERED SPECIES, AND ARCHAEOLOGICAL RESOURCES.

THE CONTRACTOR SHALL BE RESPONSIBLE FOR THE CLEANUP AND REPORTING OF SPILLS OF HAZARDOUS MATERIALS ASSOCIATED WITH THE CONSTRUCTION SITE. HAZARDOUS MATERIALS INCLUDE GASOLINE, DIESEL FUEL, MOTOR OIL, SOLVENTS, CHEMICALS, PAINT, ETC. WHICH MAY BE A THREAT TO THE ENVIRONMENT. THE CONTRACTOR SHALL REPORT THE DISCOVERY OF PAST OR PRESENT SPILLS TO THE NEW MEXICO EMERGENCY RESPONSE AT 1-800-219-6157.

THE CONTRACTOR SHALL COMPLY WITH ALL APPLICABLE REGULATIONS CONCERNING SURFACE AND UNDERGROUND WATER. CONTACT WITH SURFACE WATER BY CONSTRUCTION EQUIPMENT AND PERSONNEL SHALL BE MINIMIZED. EQUIPMENT MAINTENANCE AND REFUELING OPERATIONS SHALL BE PERFORMED IN AN ENVIRONMENTALLY SAFE MANNER IN COMPLIANCE WITH GOVERNMENT REGULATIONS.

THE CONTRACTOR SHALL COMPLY WITH ALL APPLICABLE REGULATIONS CONCERNING CONSTRUCTION NOISE AND HOURS OF OPERATION.

ACCESSIBLE FACILITIES

ALL SURFACES ALONG ACCESSIBLE ROUTES AND FOR HANDICAP RAMPS SHALL BE STABLE FIRM, SLIDE RESISTANT AND SHALL COMPLY WITH UNIFORM FEDERAL ACCESSIBILITY STANDARDS. PARAGRAPH 4.5.

LONGITUDINAL SLOPES ALONG ACCESSIBLE ROUTE SIDEWALKS, EXCEPT AT HANDICAP RAMPS, SHALL NOT BE STEEPER THAN 1: 20. CROSS SLOPES ALONG ACCESSIBLE ROUTE SIDEWALKS EXCEPT AT HANDICAP RAMPS, SHALL NOT BE STEEPER THAN 1: 48. SLOPES IN ACCESSIBLE PARKING SPACES, ACCESS AISLES, AND PASSENGER LOADING ZONES SHALL NOT BE STEEPER THAN 1: 48 IN ALL DIRECTIONS.

THE SITE SHALL COMPLY WITH ANSI A117.1-1992, "ACCESSIBLE AND USABLE BUILDINGS AND FACILITIES".

TRAFFIC CONTROL


THE CONTRACTOR SHALL PROVIDE ALL REQUIRED TRAFFIC CONTROL PLANS. ALL SIGNS, BARRICADES, CHANNELIZATION DEVICES, SIGN FRAMES AND ERECTION OF SUCH DEVICES SHALL CONFORM TO THE REQUIREMENTS OF "MANUAL OF UNIFORM TRAFFIC CONTROL DEVICES FOR STREETS AND HIGHWAYS" LATEST EDITION. PRIOR TO CONSTRUCTION, TRAFFIC CONTROL PLANS SHALL BE APPROVED BY THE GOVERNING AUTHORITY.

ABBREVIATIONS

- BM = BENCHMARK
- CATV = CABLE TELEVISION LINE
- CO = CLEANOUT
- COA = CITY OF ALBUQUERQUE
- CONC = CONCRETE
- CL = CENTERLINE
- DIA = DIAMETER
- DTL = DETAIL
- DWG = DRAWING
- E = ELECTRIC LINE
- ELEV = ELEVATION
- EX = EXISTING
- ______
- FF = FINISHED FLOOR ELEVATION
- FG = FINISHED GRADE
- FH = FIRE HYDRANT
- FL = FLOW LINE
- G = GAS PIPE
- 0/10 / 11/2
- GM = GAS METER
- GV = GATE VALVE
- INV = INVERT ELEVATION
- LF = LINEAL FEET
- LP = LIGHT POLE
- L/S = LANDSCAPING
- MH = MANHOLE
- OE = OVERHEAD ELECTRIC LINE


NG = NATURAL GROUND

- OT = OVERHEAD TELEPHONE LINE
- PCC = PORTLAND CEMENT CONCRETE
- PP = POWER POLE
- PROP = PROPOSED
- PVC = POLYVINYL CHLORIDE PIPE
- RCP = REINFORCED CONCRETE PIPE
- R/W = RIGHT-OF-WAY
- S = SLOPE
- SAS = SANITARY SEWER
- SD = STORM DRAIN
- STA = STATION
- STD = STANDARD
- SW = SIDEWALK
- = TELEPHONE
- TA = TOP OF ASPHALT PAVEMENT
- TC = TOP OF CONCRETE SLAB (PAVEMENT)
- TCC = TOP OF CONCRETE CURB
- TG = TOP OF GRATE
- TS = TOP OF SIDEWALK
- TW = TOP OF WALL TYP = TYPICAL
- UE = UNDERGROUND ELECTRIC
- T = UNDERGROUND TELEPHONE
- W = WATER
- WM = WATER METER
- WV = WATER VALVE

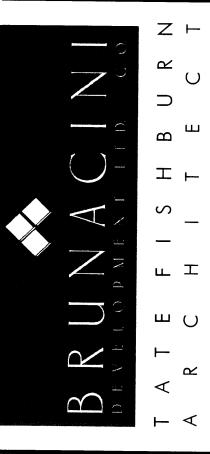

ARCHITECT SEAL

ENGINEER SEAL

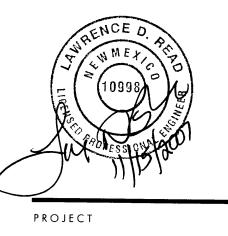

PLAN FOR BUILDING PERMIT BRUNACINI DEVELOPMENT 7550 MERIDIAN PLACE NW BUQUERQUE, NEW MEXICO

REVISIONS

DATE OCTOBER 22, 2007





DRAWING NAME

GENERAL CIVIL NOTES

SHEET NUMBER

C-1

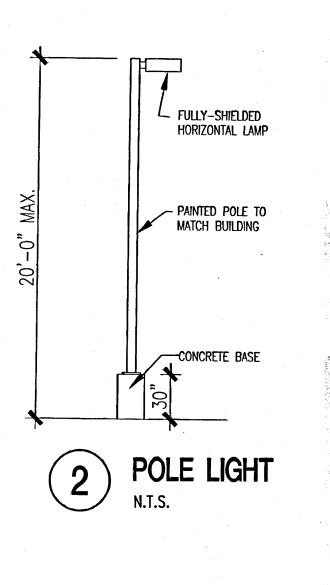

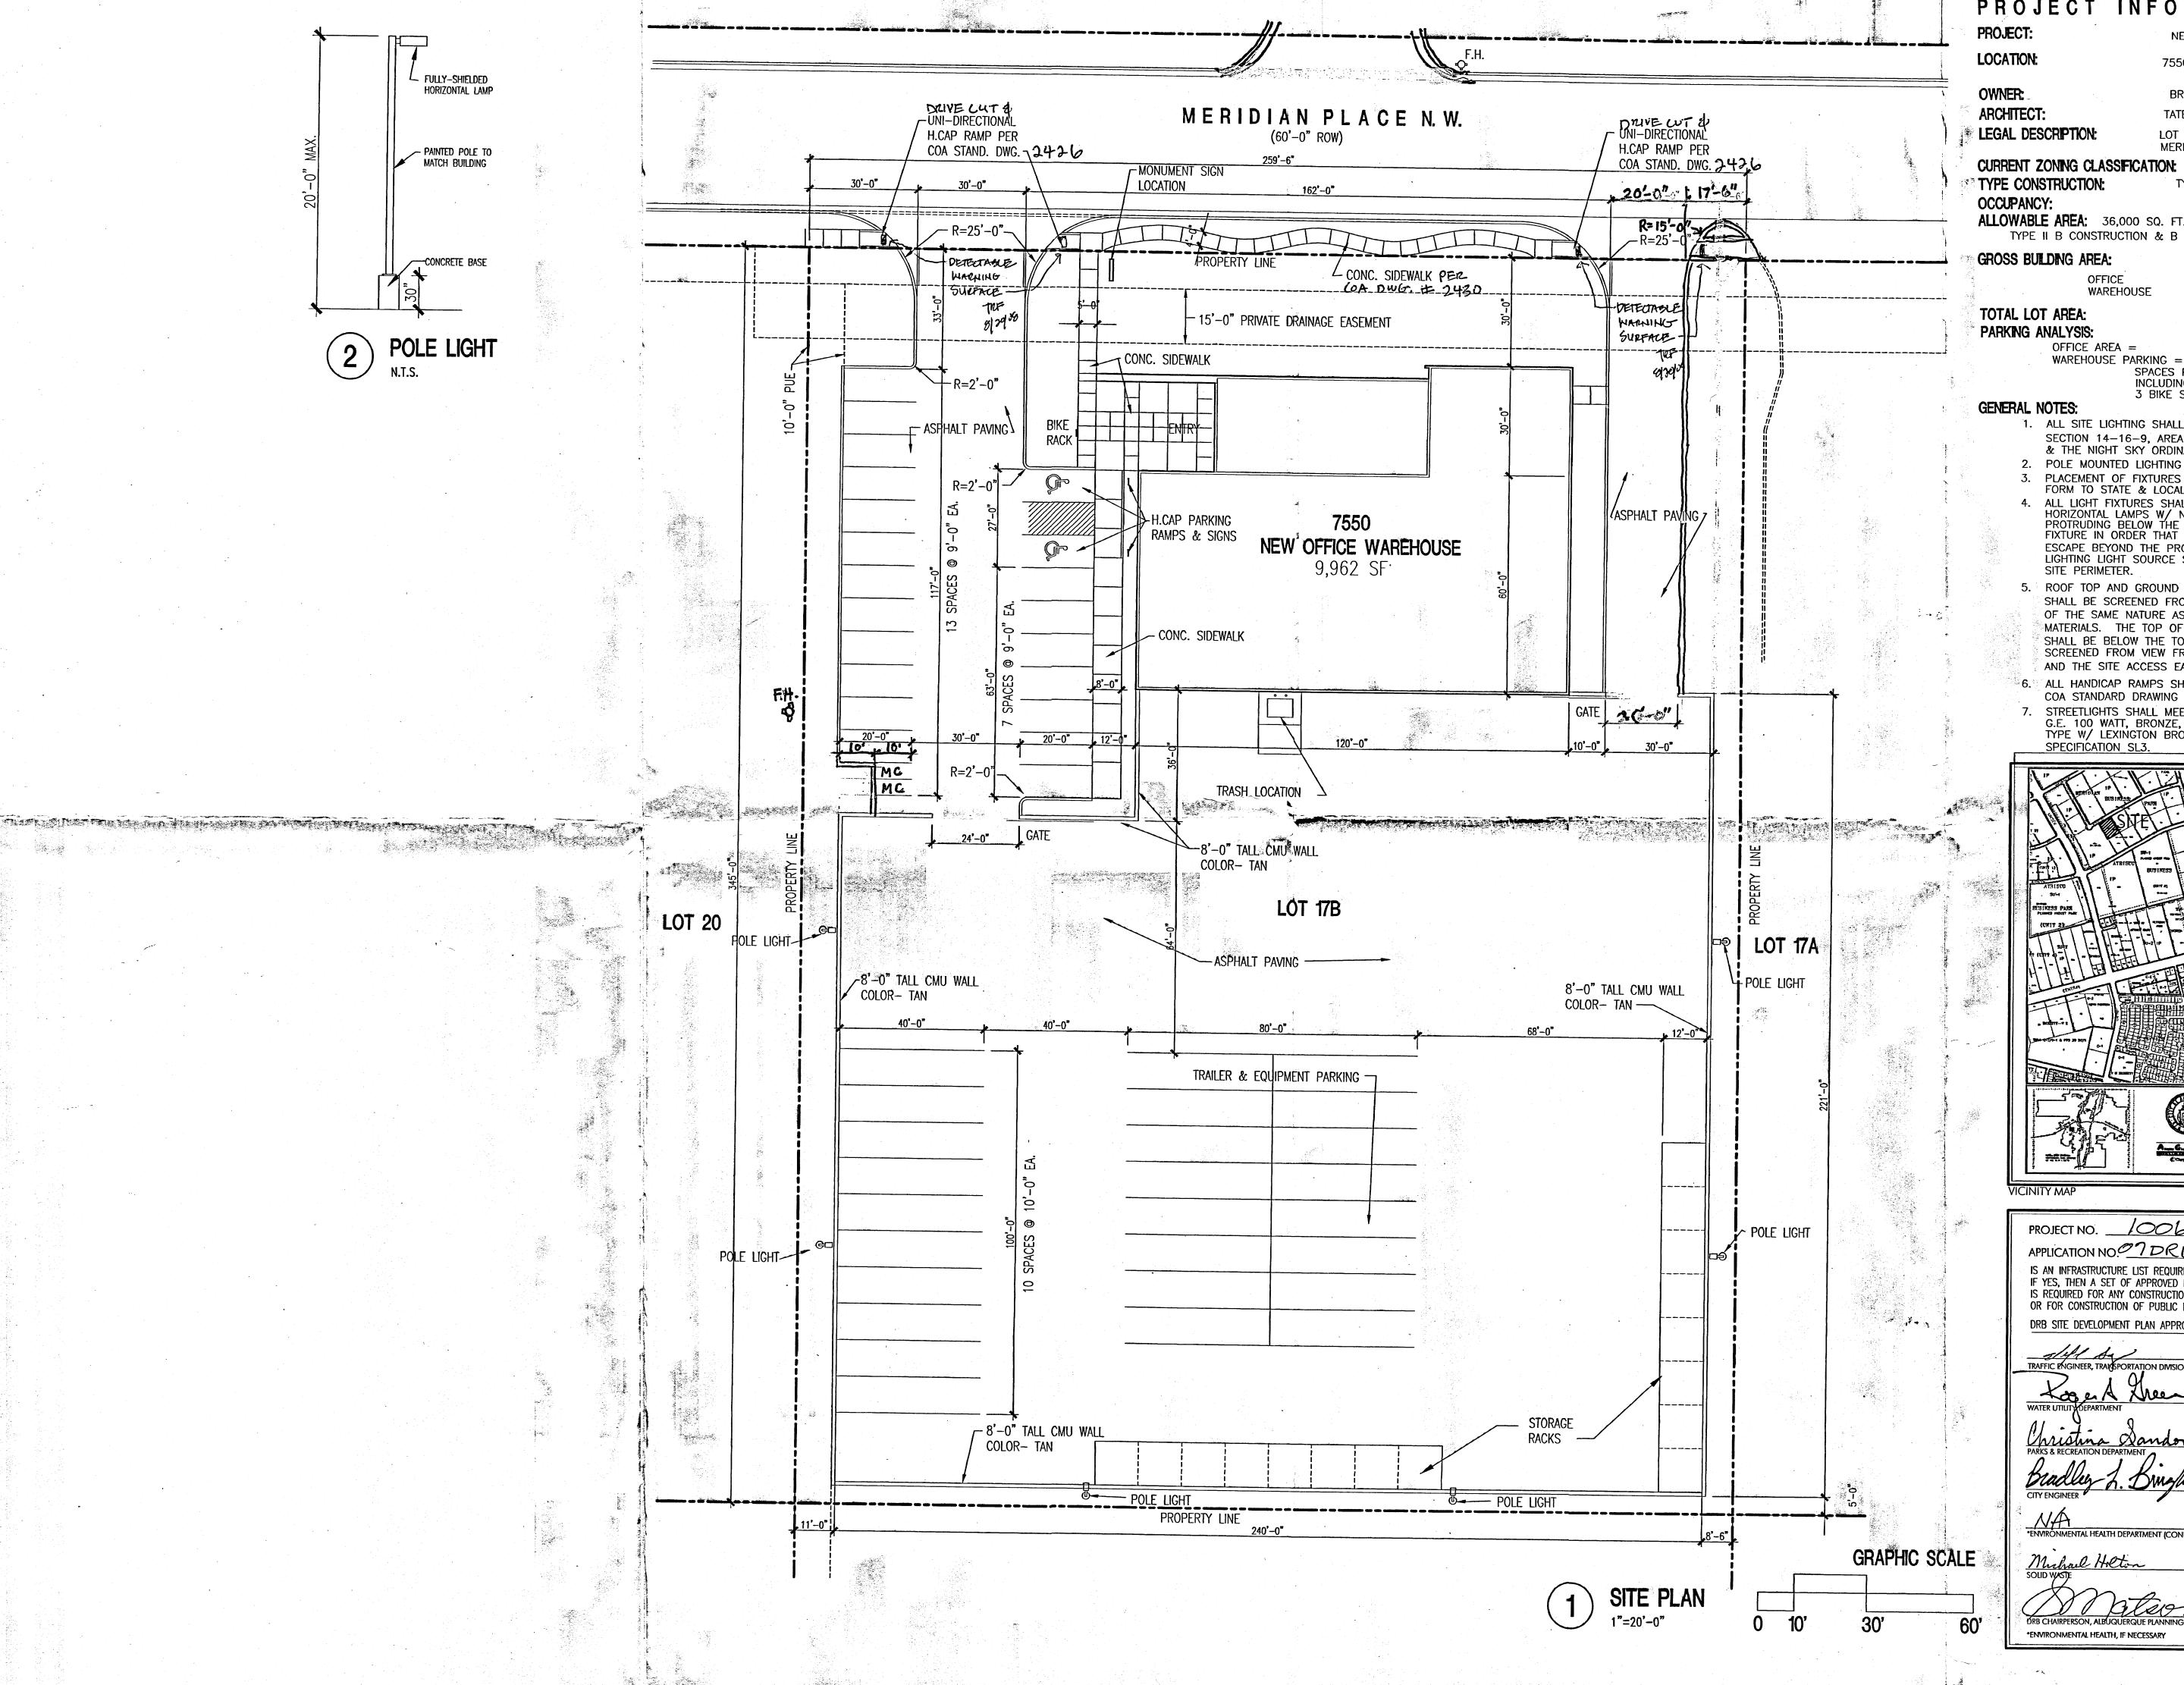

PROJECT INFORMATION

NEW OFFICE/WAREHOUSE

7550 MERIDIAN PLACE NW ALBUQUERQUE, NM BRUNACINI DEVELOPMENT

TATE FISHBURN ARCHITECT LEGAL DESCRIPTION: LOT 17B

MERIDIAN BUSINESS PARK SU-1 FOR IP TYPE II B SPRINKLERED

B/S-2 ALLOWABLE AREA: 36,000 SQ. FT.


TYPE II B CONSTRUCTION & B OCCUPANCY = 9,000 GROSS BUILDING AREA: 9,962 S.F.


> OFFICE 2,274 S.F. WAREHOUSE 7,688 S.F. 2.05 ACRE +/-


OFFICE AREA = 2,274/200= 12

WAREHOUSE PARKING = 7,688/500= 16 SPACES PROVIDED= 33 SPACES INCLUDING 2 HANDICAP 3 BIKE SPACES & 2 MOTORCYCLE

- 1. ALL SITE LIGHTING SHALL BE CONSISTENT WITH SECTION 14-16-9, AREA LIGHTING REGULATIONS & THE NIGHT SKY ORDINANCE. 2. POLE MOUNTED LIGHTING SHALL BE 20'-0" MAX.
- PLACEMENT OF FIXTURES & STANDARDS SHALL CON-FORM TO STATE & LOCAL SAFETY & ILLUM. REQ'MNTS 4. ALL LIGHT FIXTURES SHALL BE FULLY SHIELDED HORIZONTAL LAMPS W/ NO LIGHT, LENS OR BULB PROTRUDING BELOW THE BOTTOM OF THE CUT-OFF FIXTURE IN ORDER THAT NO FUGITIVE LIGHT SHALL ESCAPE BEYOND THE PROPERTY LINE AND NO SITE LIGHTING LIGHT SOURCE SHALL BE VISIBLE FROM THE SITE PERIMETER.
- 5. ROOF TOP AND GROUND MOUNTED EQUIPMENT SHALL SHALL BE SCREENED FROM PUBLIC VIEW BY MATERIALS OF THE SAME NATURE AS THE BUILDING'S BASIC MATERIALS. THE TOP OF ALL ROOFTOP EQUIPMENT SHALL BE BELOW THE TOP OF THE PARAPET OR SCREENED FROM VIEW FROM PUBLIC RIGHTS-OF-WAY AND THE SITE ACCESS EASEMENT.
- 6. ALL HANDICAP RAMPS SHALL BE BUILT BY COA STANDARD DRAWING #2441.
- 7. STREETLIGHTS SHALL MEET THE FOLLOWING SPEC.—
 G.E. 100 WATT, BRONZE, LUMEN SHOEBOX
 TYPE W/ LEXINGTON BRONZE POLE PER PNM SPECIFICATION SL3.

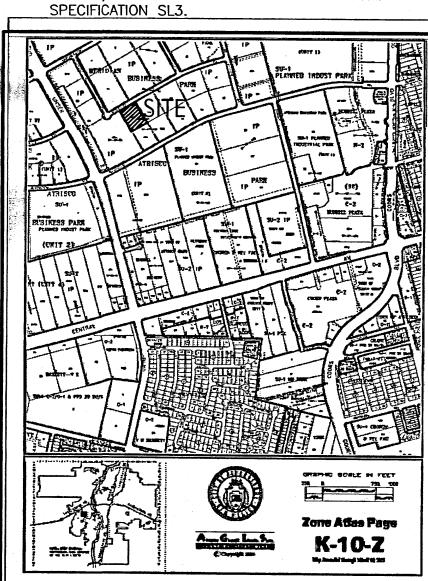

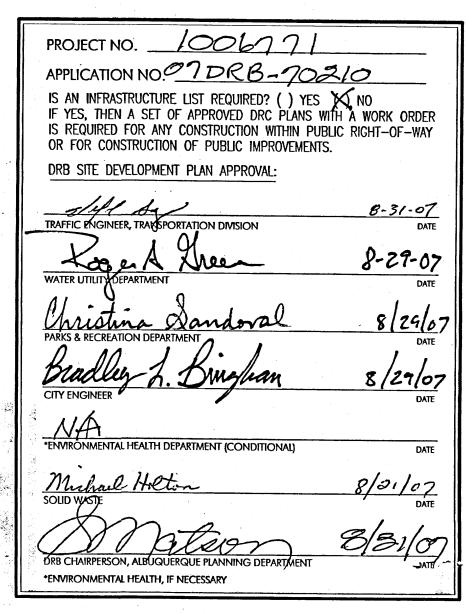


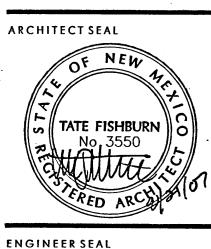

PROJECT

SUILDING F EVELOPME FE PLAN BRUN/ 7550 / LBUQL

REVISIONS AUG 2 0 2008

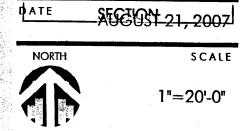


1"=20'-0"DRAWING NAME

HYDPOLOGY

SITE PLAN FOR BUILDING PERMIT


SHEET NUMBER SDP-1

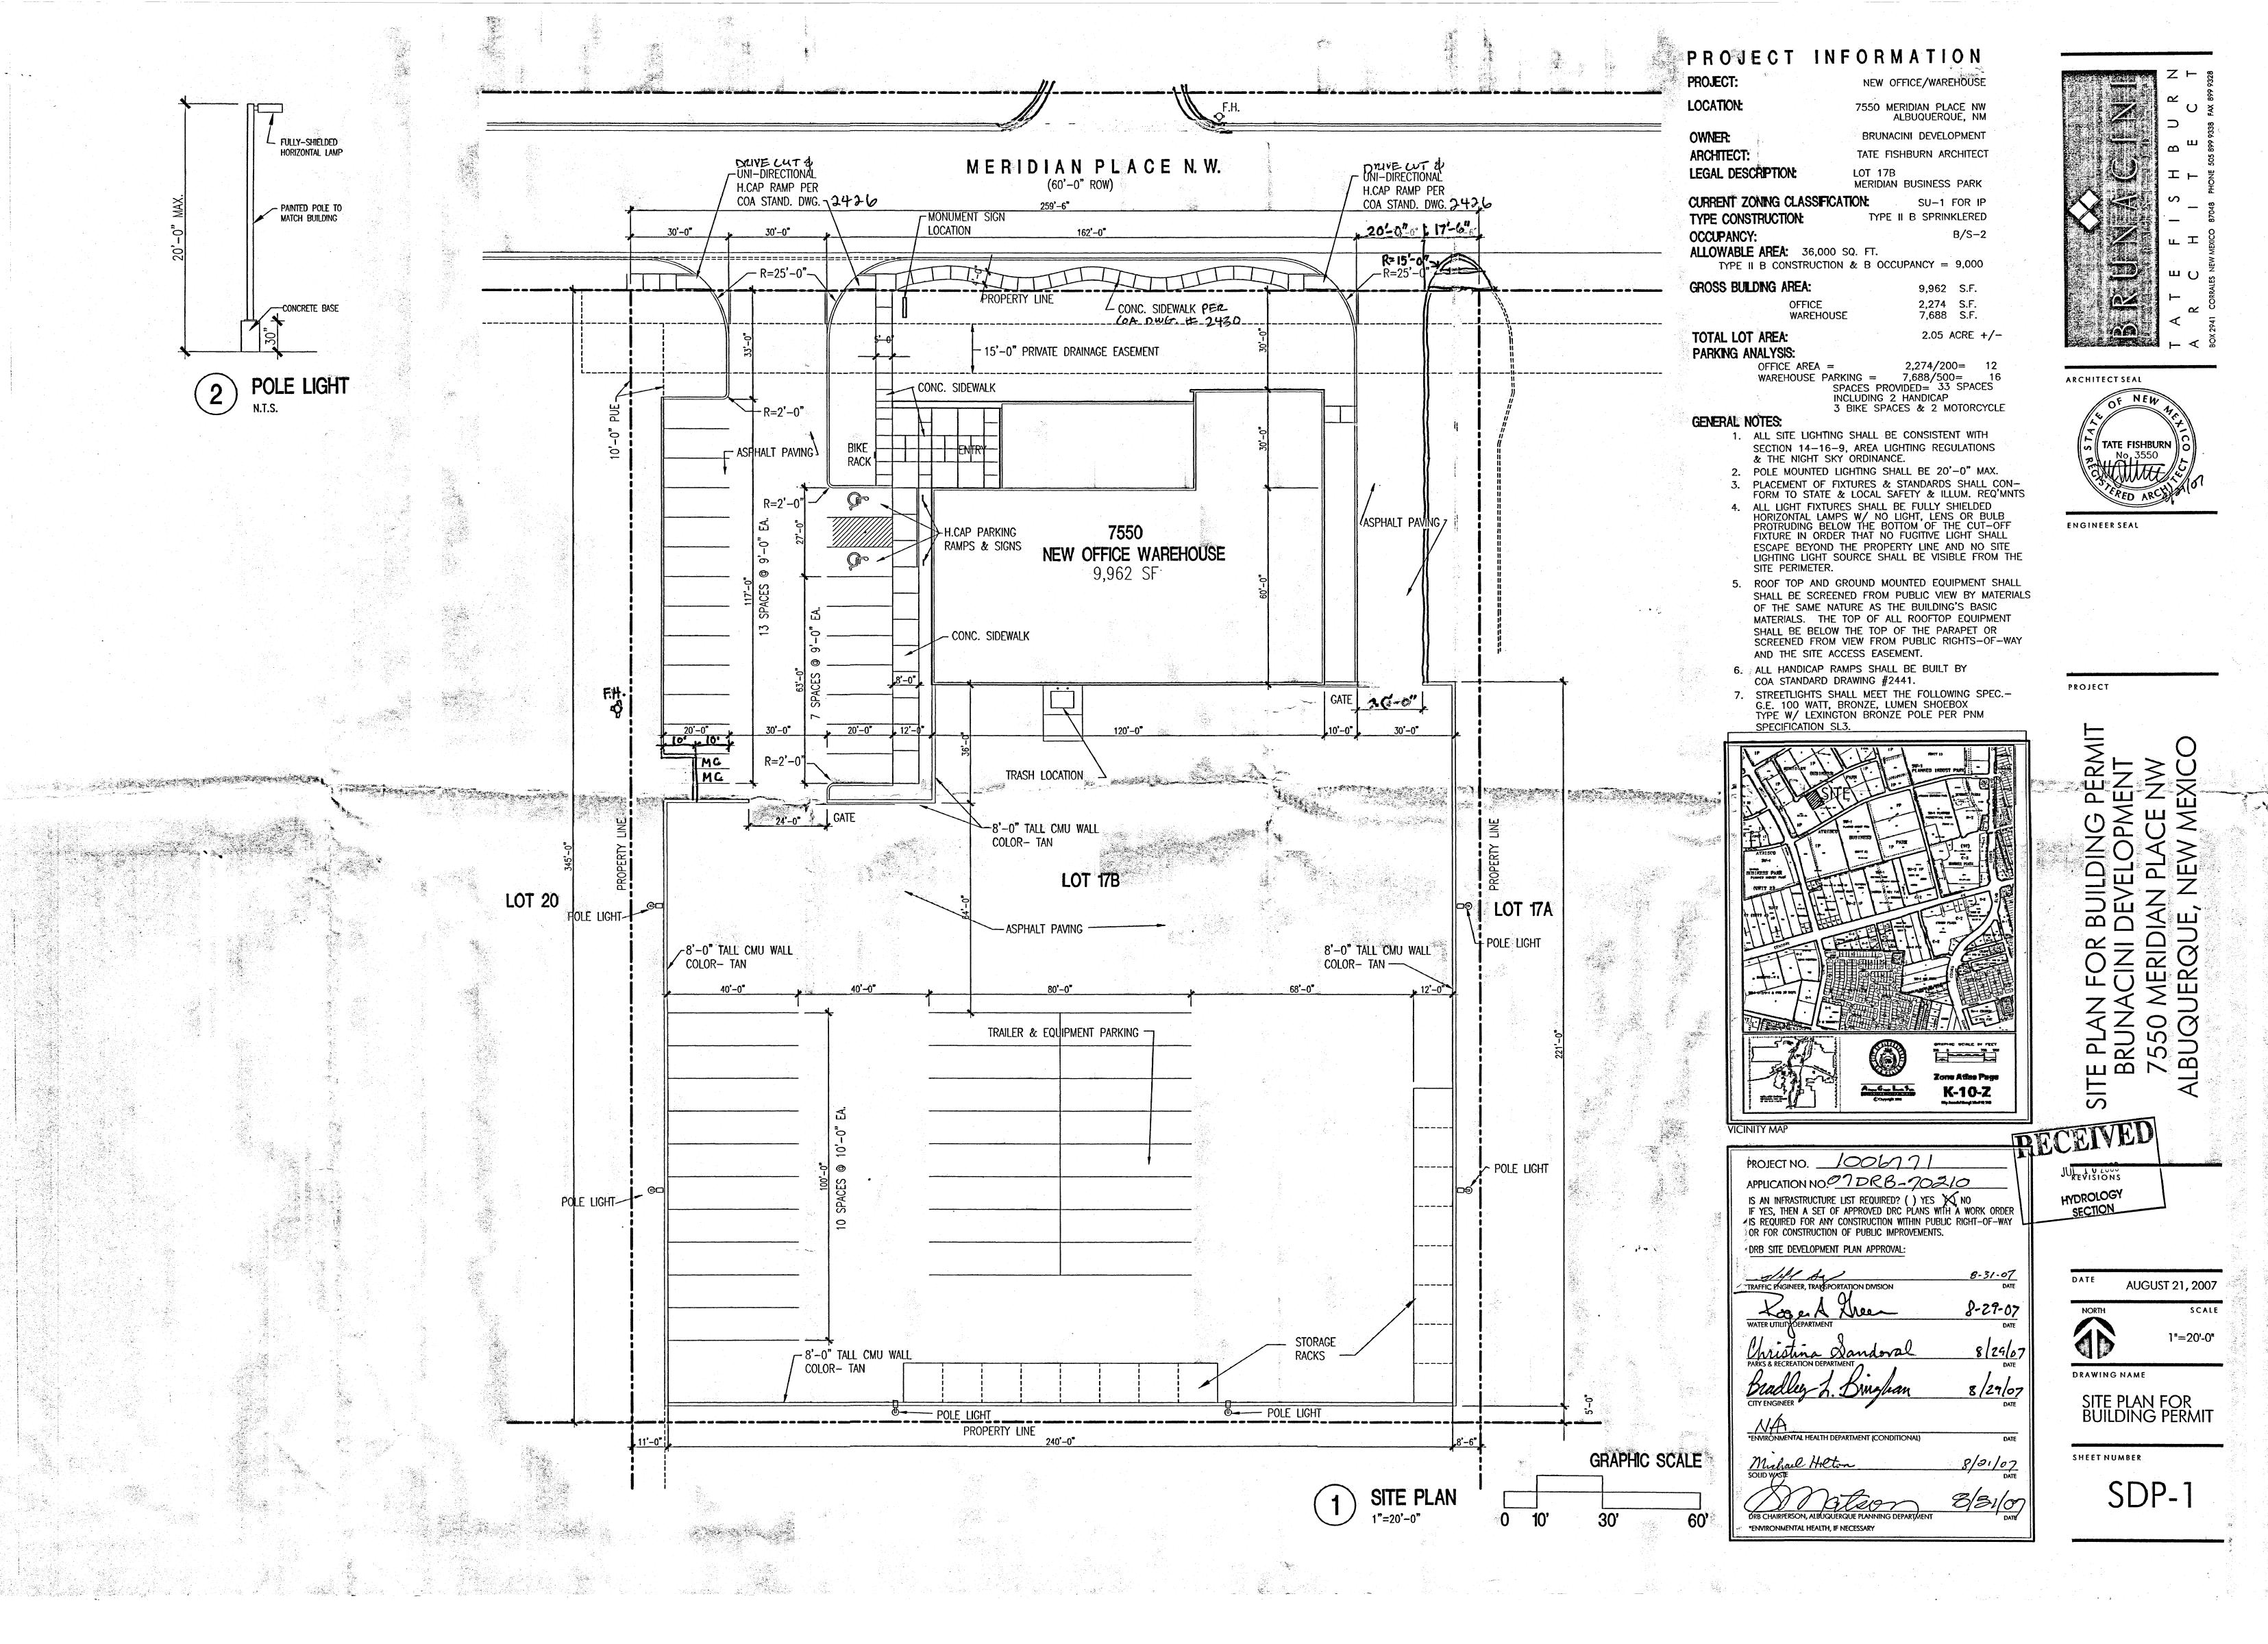

POND INFORMATION 100-YR OUTLET INV. VOLUME PROVIDED ELEV WSEL V(100-YR) 12.4 2,779 CF 1,735 CF 8.66 (GRATE) 10.5 20,500 CF 22,908 CF 371 cf 313 CF ** POND FOR BOTH BASIN D AND OFFSITE BASIN E NEW 30' PRIVATE DRIVE _ EXTEND 6" PVC SD TO-BOTTOM POND, INSTALL CAP WITH 3/4" DRILLED HOLE. WITH 3' WIDE RIPRAP RUNDOWN TO POND BOTTOM INV OF PIPE 12.4 RIPRAP D50 = 3* QMAX 0.02 CFS < 0.10 CES/ACRE THICKNESS = 6" FL 14.53 +/ NEW 30' PRIVATE DRIVE PER COA STD DWG 2426 GRADE BREAK-POND BOTTOM, INSTALL CAP INV ELEV 9.50. DRILL 7/8° QMAX = 0.01 CFS < 0.10 CFS/ACREEXIST 6" BASIN D EXISTING SO MANHOLE RIM ELEV 5111.11 INV 5104.65/ -INSTALL 6" DIA PVC / PRIVATE STORM DRAIN - 5113.17 INSTALL 2' SQ AREA MLET. -IO 8.664 NV 7.16 -5 = 1.95%INSTALL 3.75" INCH DIA ORIFICE PLATE QMAX 0.18 CFS < 0.10 CFS/ACRE (BASIN D 1:71 AC + BASIN E.:07 AC) NEW 8' TALL PERIMETER CMU WALL BASIN B DRAINAGE CERTIFICATION I, Larry D. Read, NMPE 10998, of the firm Firm Larry Read & Assoc., Inc. hereby certify that this project has been graded and will drain in substantial compliance with and in accordance with the design intent of the approved plan dated Nov. 15, 2007. The record information edited onto the original design document has been obtained by Will Plottner, Jr., NMPS 14271, of the firm Cartesian Surveys. I further certify that I have personally visited the project site on July 9, 2008 and have determined by visual inspection that the survey data provided is representative of actual site conditions and is true and correct to the best of my knowledge and belief. This certification is submitted in support of a request for Certificate _TA 5117.45 / of Occupancy. Exceptions: Two concrete rundowns have been added from roof drain outlets to the pond bottom in Basin C.

NOTE TO REVIEWER Since all but two as—built elevation spots were noted as matching the design spots, called the surveyor to inquire. I was told that all spots matched within 0.05 feet unless noted. I have included the surveyor's field sheet for verification. Overall an excellent construction project. The record information presented hereon is not necessarily complete and intended only to verify substantial compliance of the Grading and Drainage aspects of this project. Those relying on this record document are advised to obtain Independent verification of its accuracy before using it for any other purpose. TCC 73.50 73.21 VERIFED SPOT ELEVATION EARTH SPOT ELEVATION

MATCHES DESIGN

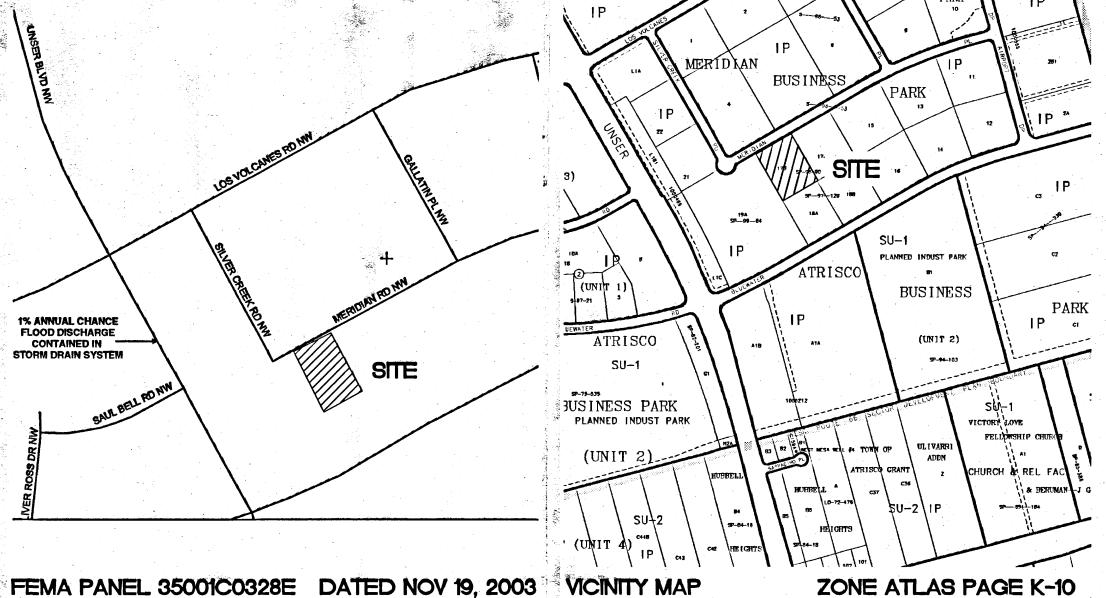

100-YEAR HYDROLOGIC CALCULATIONS

BASIN	AREA	A	В	EATMEN C	D	WEIGHTED E	V (6-hr)	V (6-hr)	V/40 down	3//40 4-3	^
#		(%)				1 1			1 ' ''	V(10 day)	Q
T	(acre)	(/0)	(%)	(%) EXISTING	(%)	(in)	(acre-ft)	(cu-ft)	(acre-ft)	(cu-ft)	(cfs
BASIN A	0.0004	400.00	0.00					-			
	0.0294	100.00	0.00	0.00	0.00	0.44	0.00	47	0.00	47	0.04
BASIN B	0.0094	100.00	0.00	0.00	0.00	0.44	0.00	15	0.00	15	0.01
BASIN C	0.2179	100.00	0.00	0.00	0.00	0.44	0.01	348	0.01	348	0.28
BASIN D	1.7109	100.00	0.00	0.00	0.00	0.44	0.06	2,733	0.06	2,733	2.21
OFFSITE BASIN E	0.0699	100.00	0.00	0.00	0.00	0.44	0.00	112	0.00	112	0.09
BASIN F	0.0871	100.00	0.00	0.00	0.00	0.44	0.00	139	0.00	139	0.11
TOTAL	2.04						0.07	3,254	0.07	3,254	2.63
			F	PROPOSE	D CON	DITIONS		÷ .			
BASIN A	0.0294	0.00	25.20	25.20	49.60	1.40	0.00	. 149	0.01	227	0.10
BASIN B	0.0094	0.00	0.00	7.33	92.67	1.90	0.00	65	0.00	111	0.04
BASIN C	0.2179	0.00	0.00	50.90	49.10	1.47	0.03	1,164	0.04	1,735	0.79
BASIN D	1.7109	0.00	0.00	7.33	92.67	1.90	0.27	11,789	0.46	20,249	7.29
OFFSITE BASIN E	0.0699	0.00	0.00	100.00	0.00	0.99	0.01	251	0.01	251	0.20
BASIN F	0.0871	0.00	0.00	100.00	0.00	0.99	0.01	313	0.01	313	0.25
TOTAL	2.04				à .		0.31	13,417	0.52	22,573	8.42
									4 -	<u> </u>	
EXCESS PRECIP.		0.44	0.67	0.99	1.97	E _i (in)					•
PEAK DISCHARGE		1.29	2.03	2.87	4.37	Qn (cfs)		V.	A 400 - 1,002 (as a part -), and the	and the second of the second	
	ii turanii le i tota	area e							ZONE =	1	
IGHTED E (in) = (EA)(%A) + (Б₃)(%В) +	(Ec)(%C) ·	+ (E _D)(%l	D) 35%	A				P6-HR (in.) =	2.20	
R (acre-ft) = (WEIGHTED E)(P24-HR (in.) =		 ค.เมล์ในเวอร์ -
DAY (acre-ft) = V6-HR + (Ad)(P10D	•								P10DAY (in.) =	(引き) (2.20 P. 10	

LOCATION, DESCRIPTION, AND LEGAL DESCRIPTION.

THE PROPOSED DEVELOPMENT ON LOT 17B, MERIDIAN BUSINESS PARK IS A PROPOSED OFFICE/WAREHOUSE BUILDING WITH ASSOCIATED PAVED PARKING AND PAVED STORAGE AREA BEHIND THE BUILDING. THE SITE IS LOCATED ON THE SOUTH SIDE OF MERIDIAN PLACE SW JUST EAST OF SILVER CREEKROAD SW. THE SURROUNDING AREA IS LIKE DEVELOPMENT OF OFFICE/WAREHOUSE PROPERTIES. THIS SITE IS SURROUNDED BY EXISTING DEVELOPMENT.

THIS SITE IS INCLUDED IN THE DRAINAGE MASTER PLAN FOR ATRISCO BUSINESS PARK DATED OCTOBER 1993 PREPARED BY EASTERLING AND ASSOCIATES, INC. AS SUCH THIS SITE IS LIMITED TO 0.10 CFS/ACRE DISCHARGE FROM THE SITE. THE ONLY EXCEPTION IS THE EQUIVALENT AREA OF A STRIP 10—FEET WIDE FOR THE WIDTH OF THE FRONTAGE THAT IS ALLOWED TO FREE DISCHARGE INTO THE STREET.

HYDROLOGY

THE HYDROLOGY FOR THIS PROJECT WAS ANALYZED USING THE QUICK CALCULATIONS OF THE JUNE 1997 RELEASE OF THE CITY OF ALBUQUERQUE DEVELOPMENT PROCESS MANUAL, SECTION 22.2.

PRECIPITATION


THE 100-YR, 6-HR DURATION STORM EVENT WAS USED AS THE DESIGN STORM FOR THIS ANALYSIS. THE SITE LIES WITHIN THE ZONE 1 PRECIPITATION AREA FOR THE CITY OF ALBUQUERQUE, AS IDENTIFIED IN THE CITY OF ALBUQUERQUE DEVELOPMENT PROCESS MANUAL, SECTION 22.2. THEREFORE, TABLES WITHIN THIS SECTION WERE USED TO ESTABLISH THE EXCESS PRECIPITATION AND PEAK DISCHARGE.

EXISTING DRAINAGE

THE SITE SLOPES FROM THE NORTHWEST TO THE SOUTHEAST AT APPROXIMATELY 2%. DRAINAGE IS BY SHALLOW SHEET FLOW. THE SITE IS PROTECTED FROM RUNOFF FROM THE NORTH BY THE IMPROVED SECTION OF MERIDIAN PLACE. THE PROPERTIES TO THE EAST AND SOUTH ARE BELOW THIS SITE SO THERE IS NO IMPACT TO THIS SITE. THE ONLY IMPACT IS FROM THE SITE TO THE WEST WHERE AN AREA (OFFSITE BASIN E) BETWEEN THE CURB AND PROPERTY LINE IS GRADED AS AN EMBANKMENT SLOPE THAT DISCHARGES INTO THIS LOT.

DEVELOPED CONDITION

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ARCHITECT SEAL

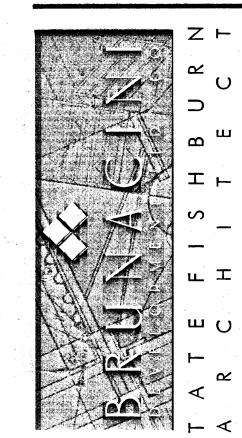ENGINEER SEAL




PROJECT

SITE PLAN FOR BUILDING PERMI BRUNACINI DEVELOPMENT 7550 MERIDIAN PLACE NW ALBUQUERQUE, NEW MEXICO

REVISIONS

DATE AUGUST 21, 2007

1"=30'-0"

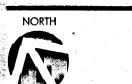

DRAWING NAME


GRADING PLAN


SHEET NUMBER

C-2

JUL 1 0 2008

HYDROLOGY

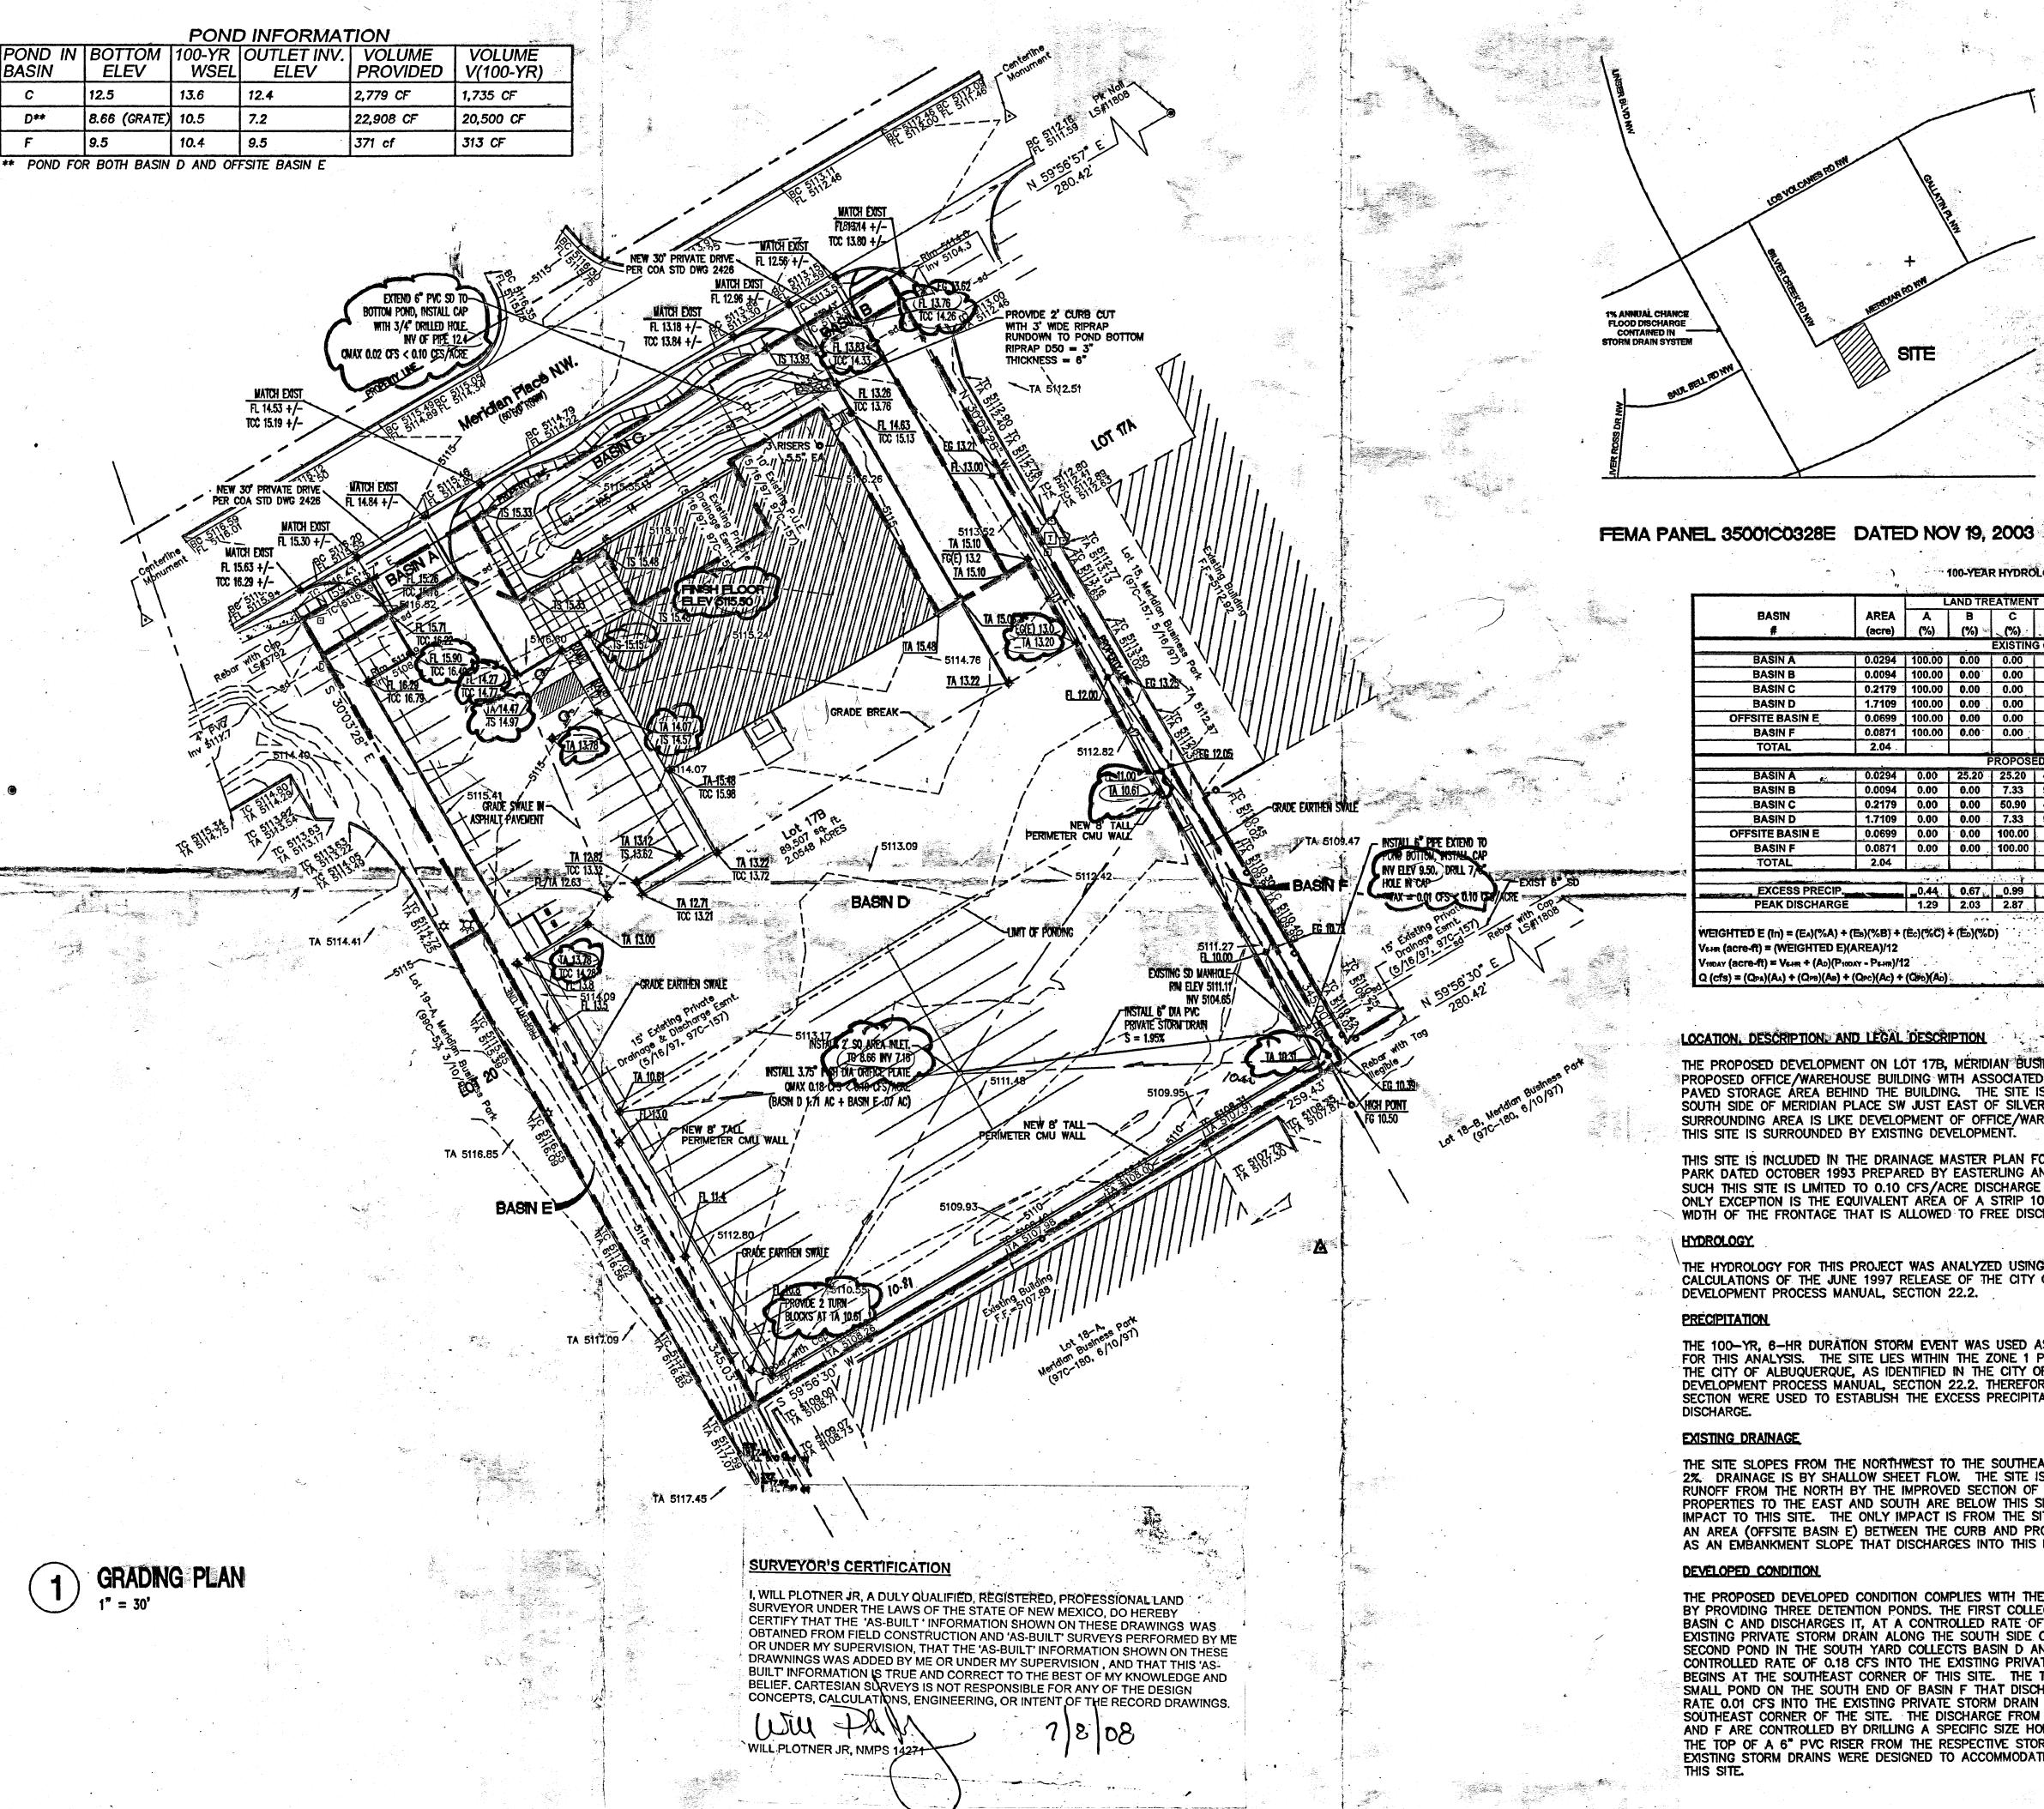

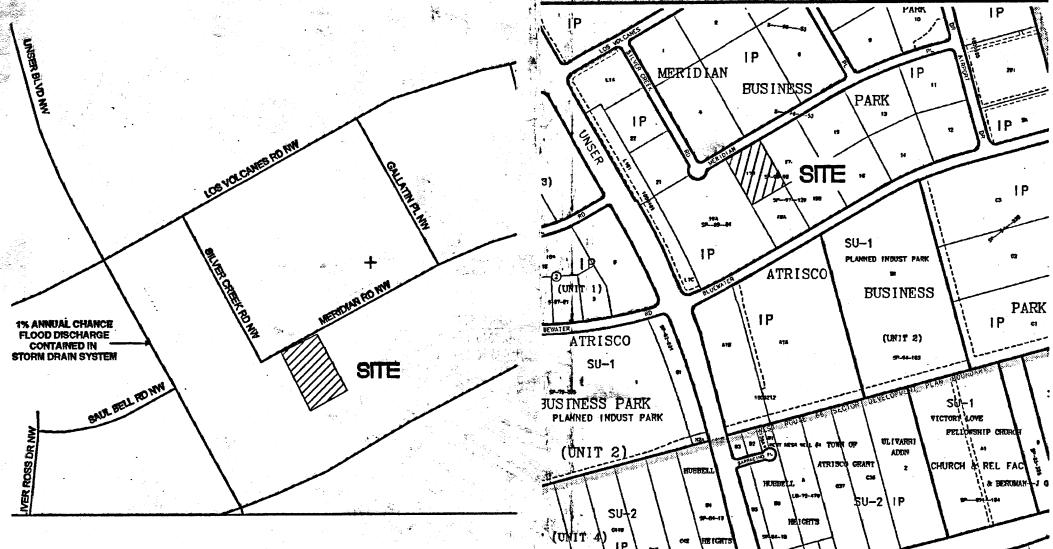

ZONE ATLAS PAGE K-10

		L	AND TR	EATMEN	T	WEIGHTED			•		
BASIN	AREA	A	В	С	D **	E	V (6-hr)	··V (6-hr)	V(10 day)	V(10 day)	Q
# 2	(acre)	(%)	(%) 🔄	_(%)	. (%)	(In)	(acre-ft)	(cu-ft)	(acre-ft)	(cu-ft)	(cfs
				EXISTIN	G CONDI	TIONS .					
BASIN A	0.0294	100.00	0.00	0.00	0.00 _ï	0.44	0.00	47	0.00	-47	0.04
BASIN B	0.0094	100.00	0.00	0.00	0.00	0.44	0.00	. 15	0.00	15	0.01
BASIN C	0.2179	100.00	0.00	0.00	0.00	0.44	0.01	348	0.01	348	0.28
BASIN D	1.7109	100.00	0.00	0.00	0.00	0.44	0.06	2,733	0.06	2,733	2.2
OFFSITE BASIN E	0.0699	100.00	0.00	0.00	0.00	0.44	. 0.00	112	0.00	112	0.09
BASIN F	0.0871	100.00	0.00	0.00	0.00	0.44	0.00	139	0.00	139	0.1
TOTAL	2.04	•					0.07	3,254	0.07	3,254	2.63
	•			PROPOSI	ED COND	ITIONS .			;		
BASIN A	0.0294	0.00	25.20	25.20	49.60	1.40	0.00	149	0.01	227	0.10
Basin B	0.0094	0.00	0.00	7.33	92.67	1.90	0.00	65	0.00	111	0.04
BASIN C	0.2179	0.00	0.00	50.90	49.10	1.47	0.03	1,164	0.04	1,735	0.79
BASIN D	1.7109	0.00	0.00	7.33	92.67	1.90	0.27	11,789	0.46	20,249	7.2
OFFSITE BASIN E	0.0699	0.00	0.00	100.00	0.00	0.99	0.01	251	0.01	251	0.2
BASIN F	0.0871	0.00	0.00	100.00	0.00	ų 0.9 9	0.01	313	0.01	313	0.2
TOTAL	2.04	. غيوستان		* 1	- 3	le .	0.31	13,417	0.52	22,573	8.4
13 20		و المالية المالية		· · · · · · ·	معصيد حب				• • •		
EXCESS PRECIP.		_0,44	0.67	0.99_	1.97	* Ei (în)		•			
PEAK DISCHARGE		1.29	2.03	2.87	4.37	Qri (cfs)			1886 A		ā.,
							3 7 7 7		ZONE =	. 1	
EIGHTED E (In) = $(E_A)(\%A) +$		(Ec)(%C)	÷ (Eb)(%I	D) :::					Pour (in.)	1.77	
HR (acre-ft) = (WEIGHTED E)	ADEANA?					4	· ·		P24-HR (171.) =		3.4

LOCATION, DESCRIPTION, AND LEGAL DESCRIPTION

Q(cfs) = (Qpa)(Aa) + (Qpb)(Ab) + (Qpc)(Ac) + (Qpb)(Ab)

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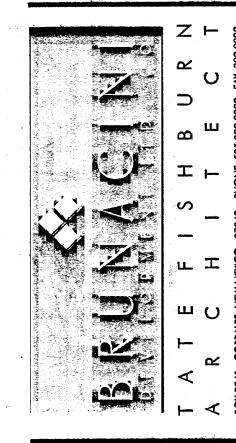
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ARCHITECTSEAL

ENGINEER SEAL

PLAN RUN 550 3UQ(

REVISIONS


AUGUST 21, 2007


DRAWING NAME GRADING PLAN

SHEET NUMBER

JUL 1 0 2008

HYDROLOGY

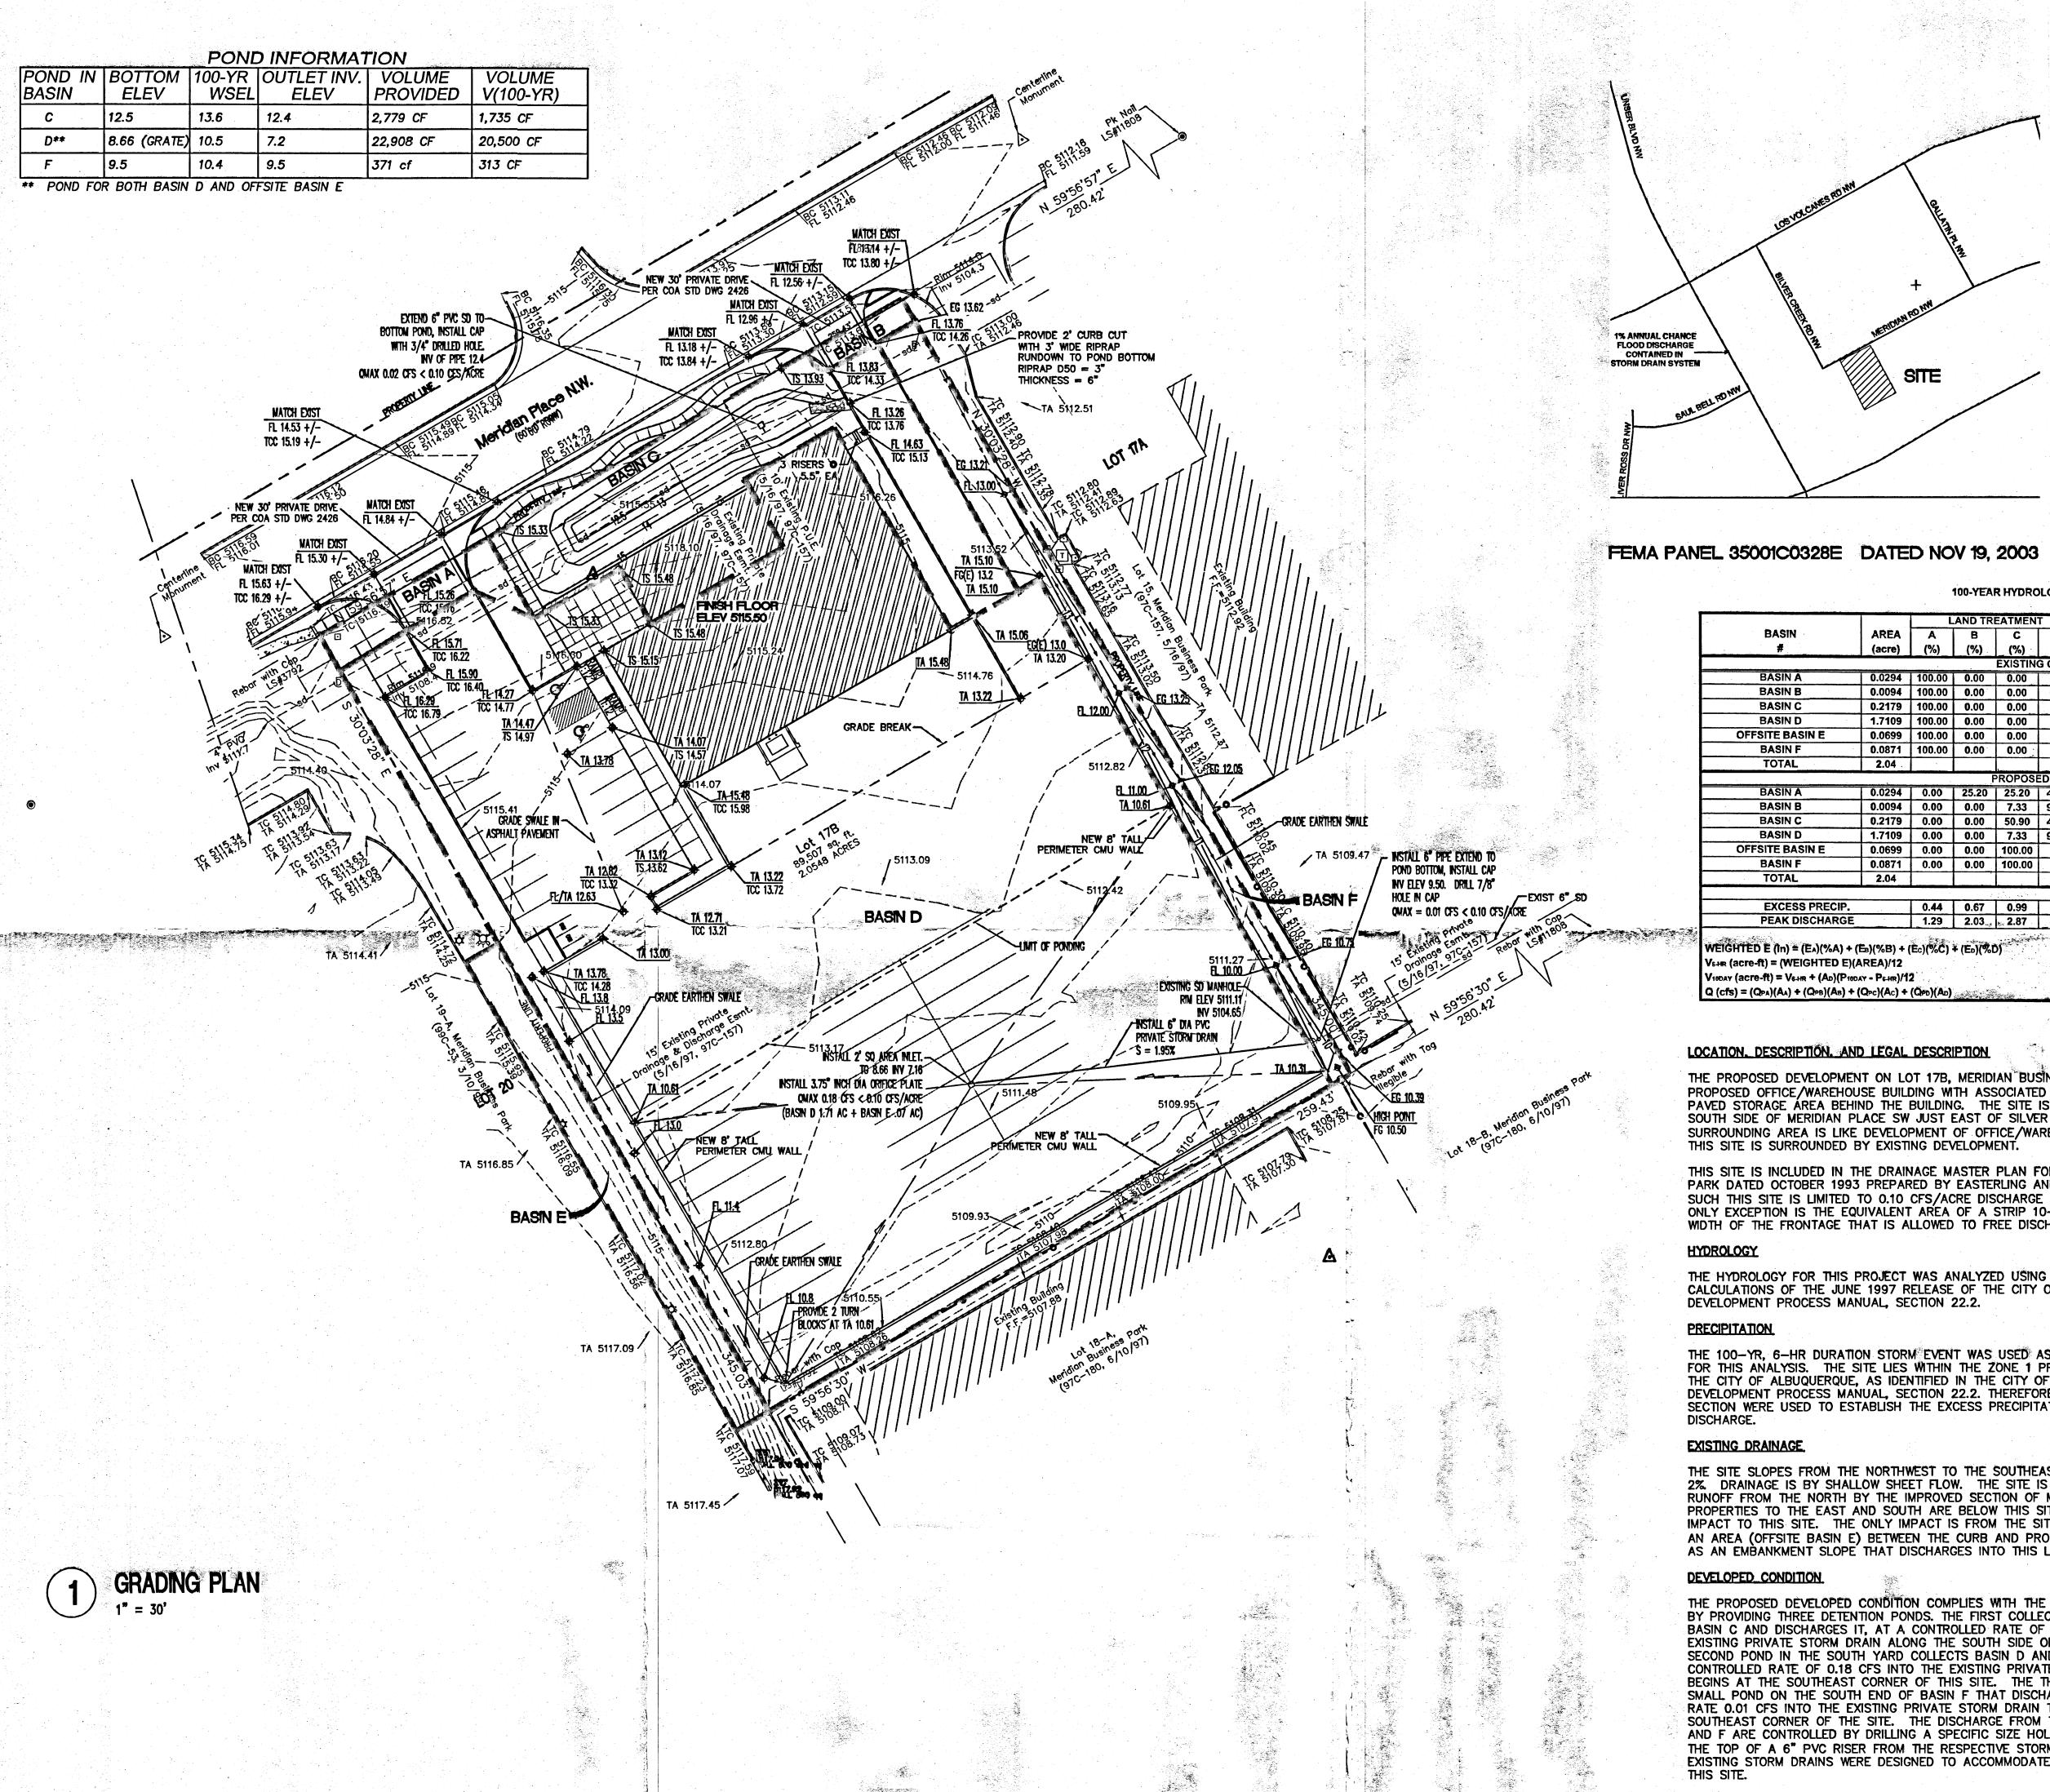

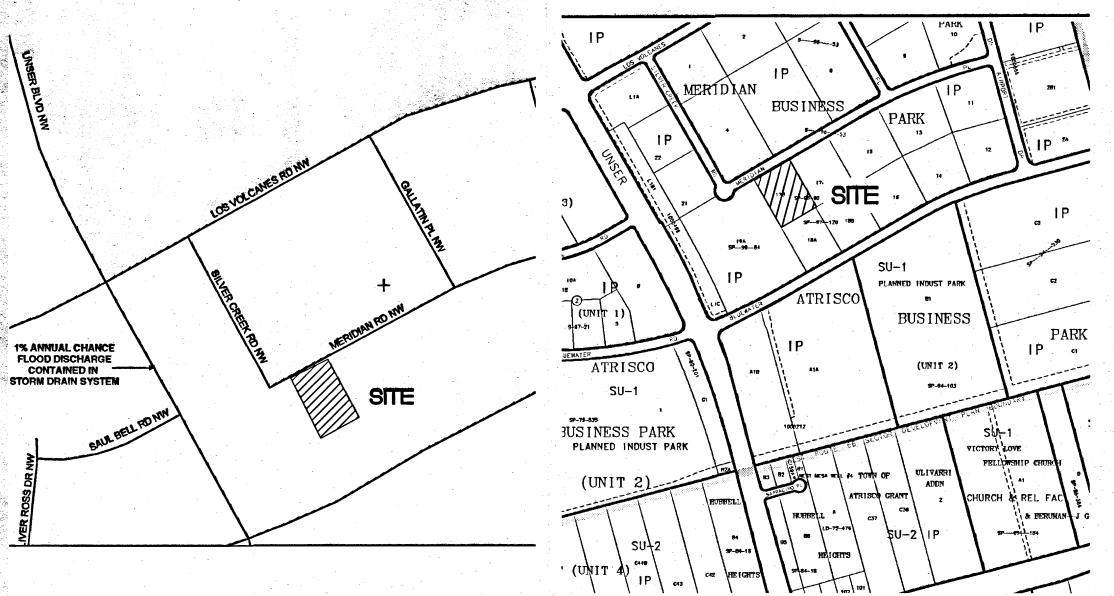

100-YEAR HYDROLOGIC CALCULATIONS

0.4000				EATMEN		WEIGHTED					
BASIN	AREA	A	В	C	D	E	V (6-hr)	V (6-hr)	V(10 day)	V(10 day)	Q
#	(acre)	(%)	(%)	(%)	(%)	(in)	(acre-ft)	(cu-ft)	(acre-ft)	· (cu-ft)	_(cfs
				EXISTING	G COND	ITIONS					
BASIN A	0.0294	100.00	0 .00	0.00	0.00	0.44	0.00	47	0.00	47	0.04
BASIN B	0.0094	100.00	0.00	0.00	0.00	0.44	0.00	15	0.00	15	0.01
BASIN C	0.2179	100.00	0.00	0.00	0.00	0.44	0.01	348	0.01	348	0.28
BASIN D	1.7109	100.00	0.00	0.00	0.00	0.44	0.06	2,733	0.06	2,733	2.21
OFFSITE BASIN E	0.0699	100.00	0.00	0.00	0.00	0.44	0.00	112	0.00	112	0.09
BASIN F	0.0871	100.00	0.00	0.00	0.00	0.44	0.00	139	0.00	139	0.11
TOTAL	2.04						0.07	3,254	0.07	3,254	2.63
				PROPOSE	D CON	DITIONS					
BASIN A	0.0294	0.00	25.20	25.20	49.60	1.40	0.00	149	0.01	227	0.10
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BASIN D	1.7109	0.00	0.00	7.33	92.67	1.90	0.27	11,789	0.46	20,249	7.29
OFFSITE BASIN E	0.0699	0.00	0.00	100.00	0.00	0.99	0.01	251	0.01	251	0.20
BASIN F	0.0871	0.00	0.00	100.00	0.00	0.99	0.01	313	0.01	313	0.25
TOTAL	2.04						0.31	13,417	0.52	22,573	8.42
									: .		-
EXCESS PRECIP.		0.44	0.67	0.99	1.97	E: (in)					
PEAK DISCHARGE		1.29	2.03	» 2.87	4.37	Qn (cfs)					

VICINITY MAP

LOCATION, DESCRIPTION, AND LEGAL DESCRIPTION

 $Q(cfs) = (Q_{PA})(A_A) + (Q_{PB})(A_B) + (Q_{PC})(A_C) + (Q_{PD})(A_D)$

V10DAY (acre-ft) = V6-HR + (AD)(P10DAY - P6-HR)/12

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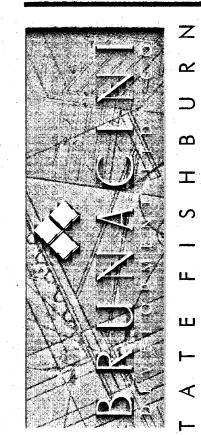
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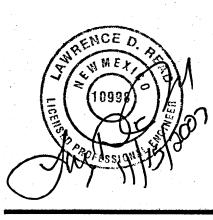
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ARCHITECTSEAL

ENGINEERSEAL

ZONE ATLAS PAGE K-10



PROJECT

ERID TE PLAN BRUN, 7550 LBUQI SIT

REVISIONS


AUGUST 21, 2007


1"=30'-0"


DRAWING NAME

GRADING PLAN

SHEET NUMBER

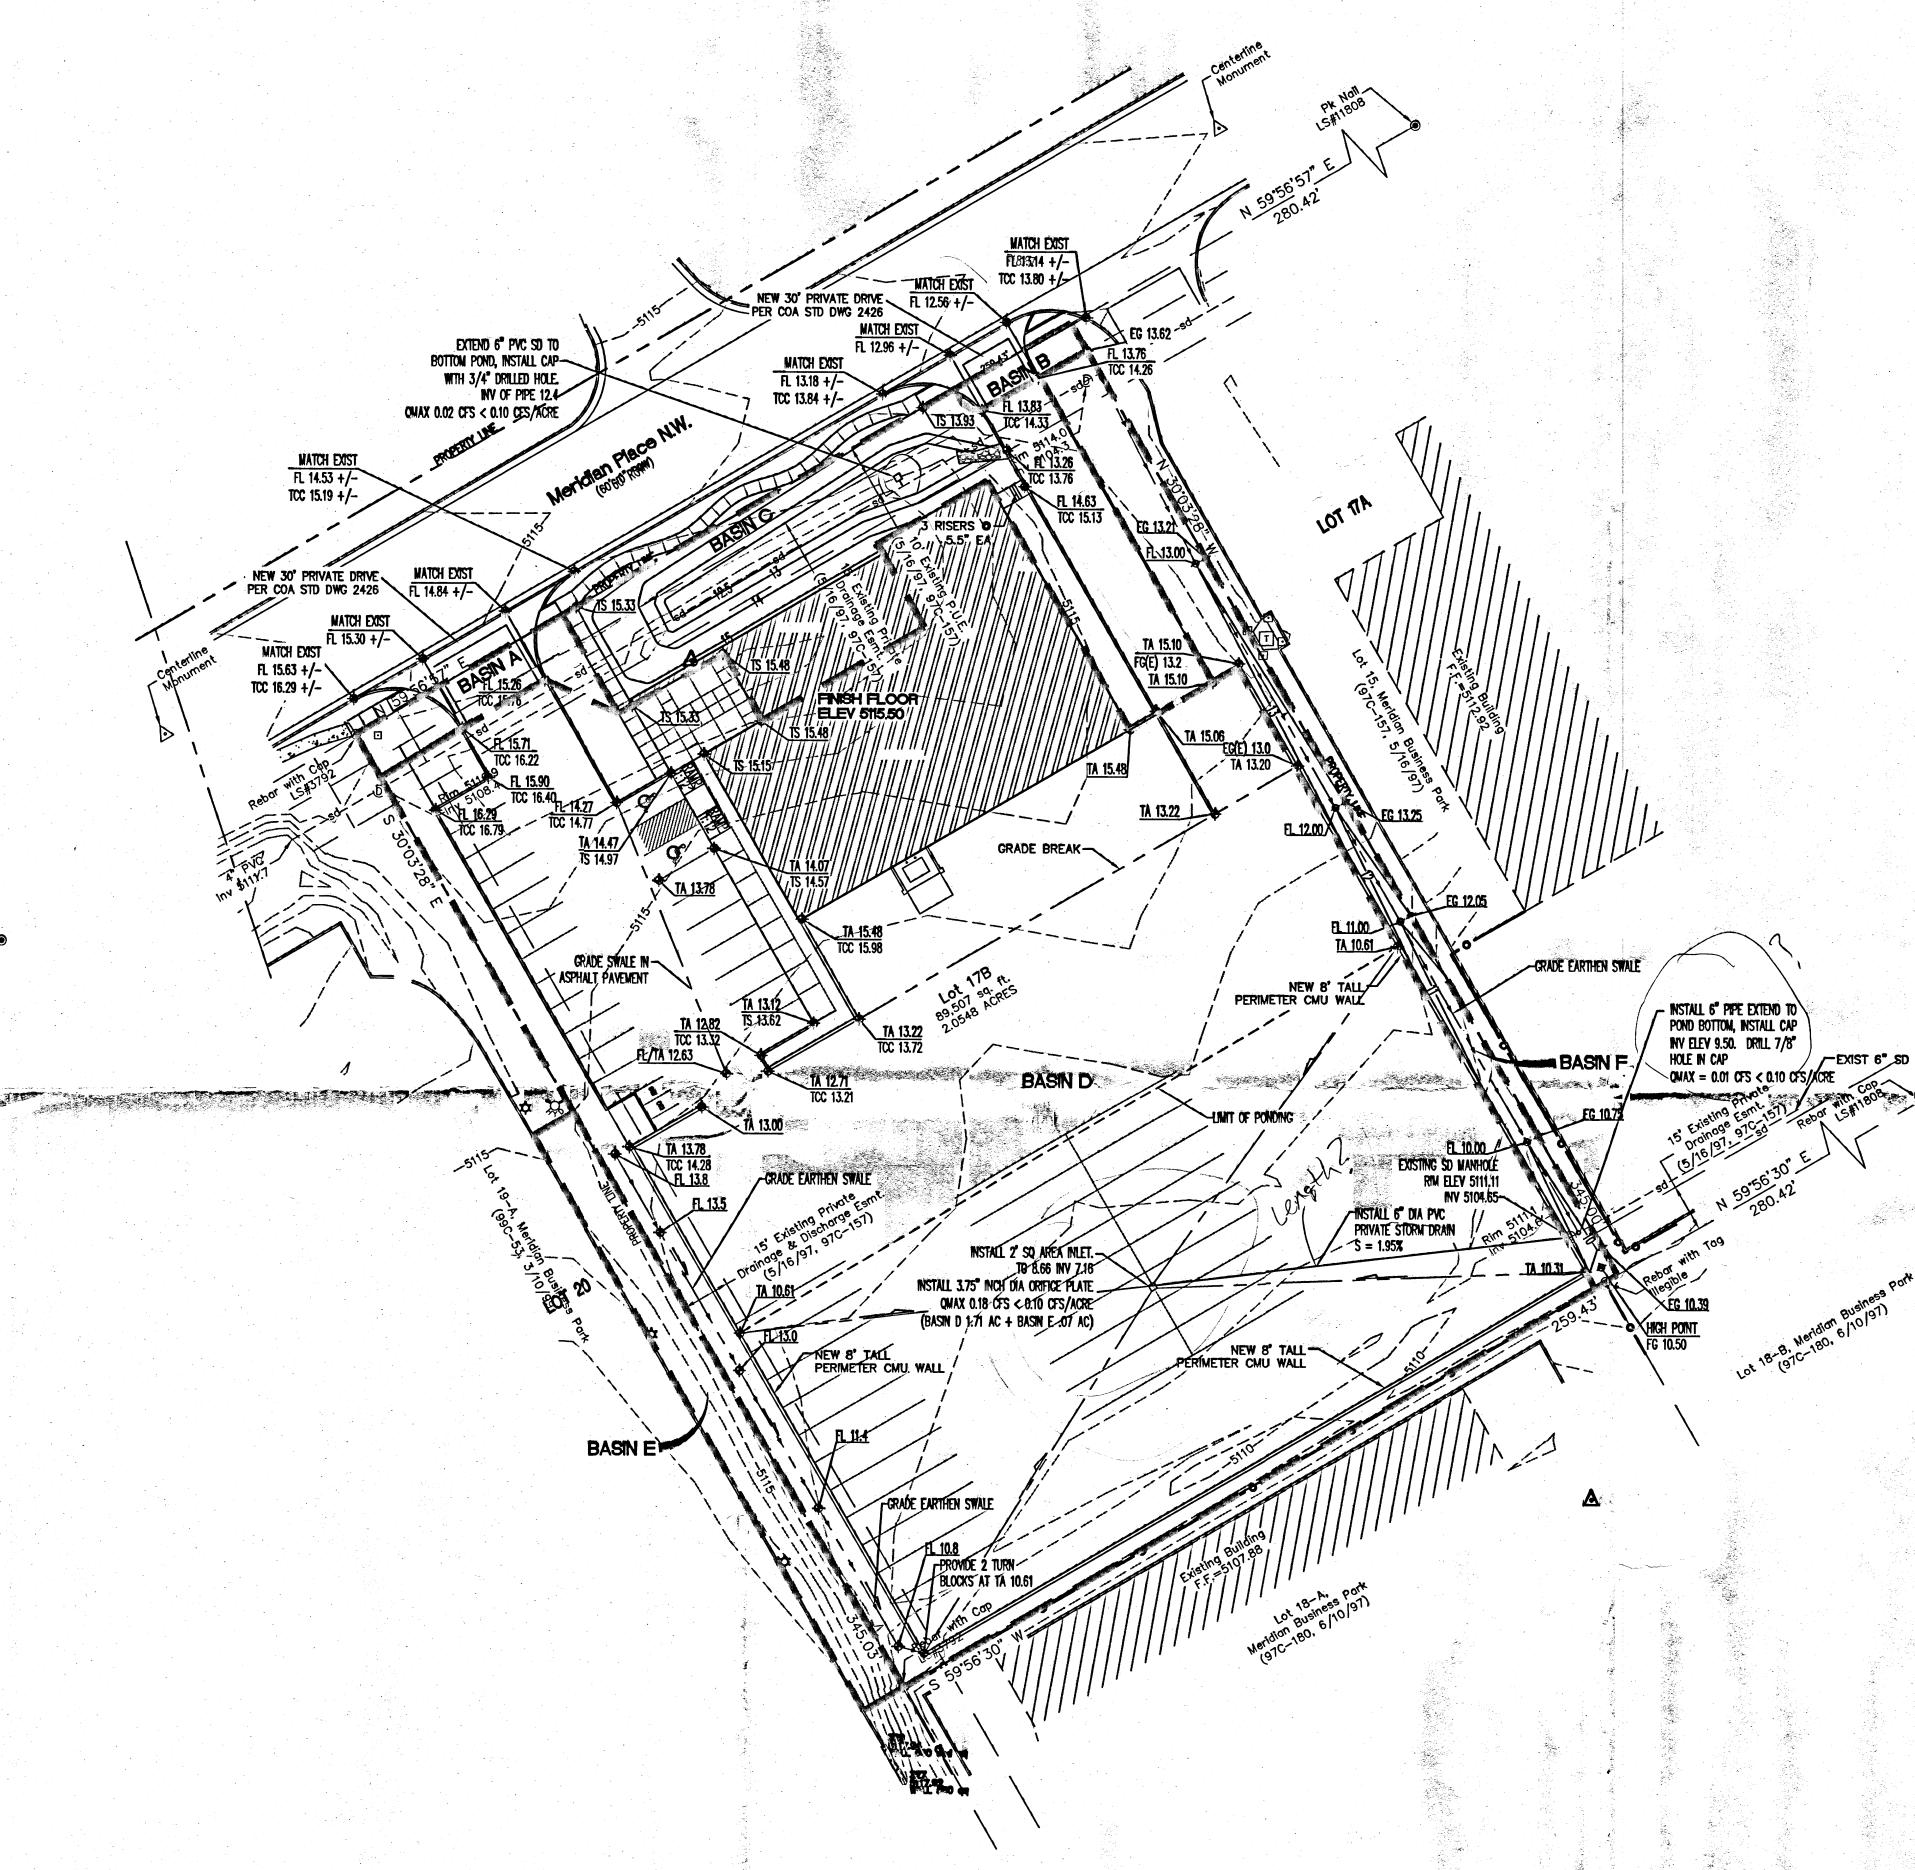

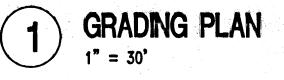

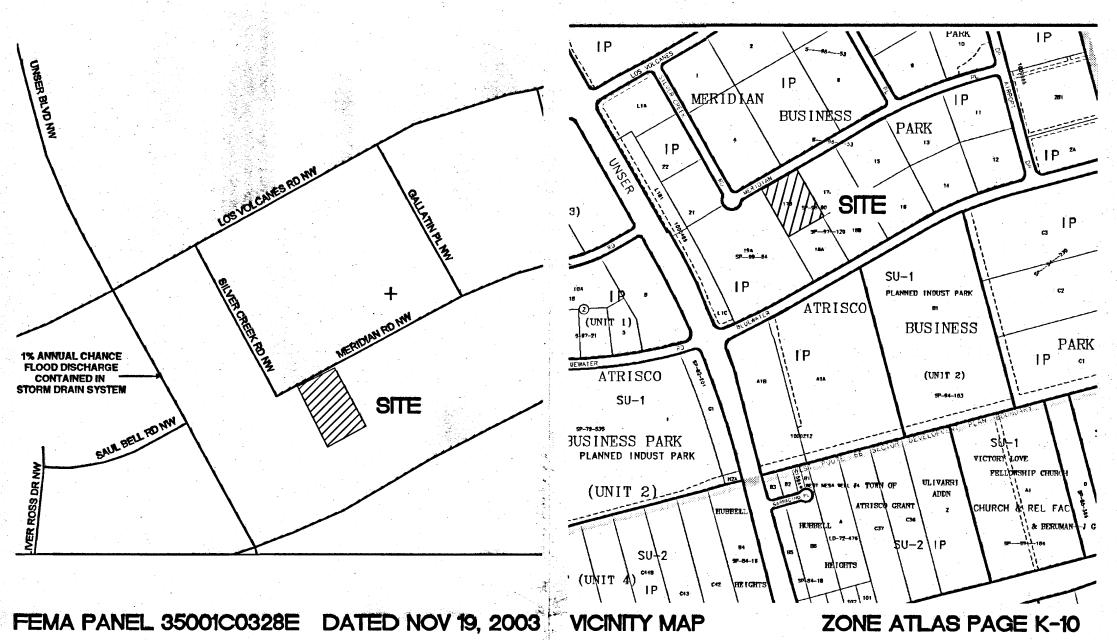

100-YEAR HYDROLOGIC CALCULATIONS

BASIN	ADEA			ATMENT		WEIGHTED			L	L	
_	AREA	A	В	С	D	E	V (6-hr)	V (6-hr)	1 '	V(24 hour)	Q
*	(acre)	(%)	(%)	(%)	(%)	(in)	(acre-ft)	(cu-ft)	(acre-ft)	(cu-ft)	_(cf
	<u> </u>			EXIST	TING CO	NDITIONS					
SITE	5.2737	100.00	0.00	0.00	0.00	0.66	0.29	12,635	0.29	12,635	9.8
OFFSITE BASIN B	1.7800	100.00	0.00	0.00	0.00	0.66	0.10	4,265	0.10	4,265	3.3
MODESTO ROW	1.8200	78.40	0.00	0.00	21.60	1.03	0.16	6,786	0.17	7,500	4.6
			l								
				PROP	OSED CO	ONDITIONS		leria e e e e e e e e e e e e e e e e e e e		<u> </u>	
SITE	5.2737	0.00	0.00	11.60	88.40	2.24	0.98	42,803	1.18	51,264	25.
OFFSITE BASIN B	1.7800	0.00	0.00	0.00	100.00	2.36	0.35	15,249	0.42	18,480	8.9
MODESTO ROW	1.8200	78.40	0.00	0.00	21.60	1.03	0.16	6,786	0.17	7,500	4.6
			<u> </u>					'			
EVOCA PRES					- 12	1					
EXCESS PREC		0.66	0.92	1.29	2.36	Eı (in)		1			
PEAK DISCHAR	RGE	1.87	2.6	3.45	5.02	Q _{PI} (cfs)					
				িক্ত		er en	ر. خضت کخت بدانست مورد راست	erik samani karan sa	ZONE =	3	
EIGHTED E (in) = (EA)			(%C) + (I	E₀)(%D) (对表演员的 表。		11000	P _{6-HR} (in.) =	≨= 2.60° ≥	
нк (acre-ft) = (WÈIGH					ンゲー				P247R (in.) =	3.10	
DDAY (acre-ft) = Vo-HR +	(AnliDimer.	D\145		Section Contracts	5-2 10		•		Propay (in.) =	4.90	

LOCATION. DESCRIPTION: AND LEGAL DESCRIPTION

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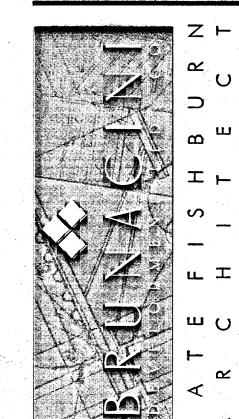
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ARCHITECTSEAL

ENGINEER SEAL




PROJECT

FE PLAN BRUN, 7550 LBUQ(

REVISIONS


AUGUST 21, 2007

SCALE

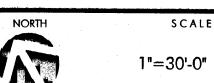

DRAWING NAME

GRADING PLAN

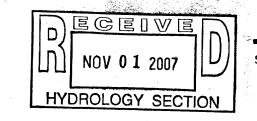

SHEET NUMBER

GENERAL CONSTRUCTION NOTES

GENERAL

CONTRACTOR IS RESPONSIBLE FOR OBTAINING ALL REQUIRED CONSTRUCTION PERMITS, INCLUDING A TOP SOIL DISTURBANCE PERMIT, PRIOR TO START OF CONSTRUCTION.

ALL WORK ON THIS PROJECT SHALL BE PERFORMED IN ACCORDANCE WITH APPLICABLE FEDERAL, STATE, AND LOCAL LAWS, ORDINANCES, AND REGULATIONS CONCERNING CONSTRUCTION SAFETY AND HEALTH.

REFERENCES MADE TO STANDARD SPECIFICATIONS AND STANDARD DRAWINGS REFER TO THE CITY OF ALBUQUERQUE STANDARD SPECIFICATIONS FOR PUBLIC WORKS CONSTRUCTION, 1986 EDITION WITH ALL UPDATES.

THE CONTRACTOR SHALL NOT INSTALL ITEMS AS SHOWN ON THESE PLANS WHEN IT IS OBVIOUS THAT FIELD CONDITIONS ARE DIFFERENT THAN SHOWN IN THE PLANS. SUCH CONDITIONS SHALL BE BROUGHT TO THE ATTENTION OF THE ENGINEER IN A TIMELY MANNER. IN THE EVENT THE CONTRACTOR DOES NOT NOTIFY THE ENGINEER IN A TIMELY MANNER, THE CONTRACTOR ASSUMES FULL RESPONSIBILITY AND EXPENSE FOR ANY REVISIONS NECESSARY, INCLUDING ENGINEERING DESIGN FEES.

EXISTING SITE IMPROVEMENTS WHICH ARE DAMAGED OR DISPLACED BY THE CONTRACTOR SHALL BE REMOVED AND REPLACED BY THE CONTRACTOR AT THE CONTRACTOR'S EXPENSE. REPAIRS SHALL BE APPROVED BY THE OWNER PRIOR TO CONSTRUCTION OF THE REPAIRS. REPAIRS SHALL BE ACCEPTED BY THE OWNER PRIOR TO FINAL PAYMENT.

EXISTING FENCING THAT IS NOT DESIGNATED FOR REMOVAL SHALL NOT BE DISTURBED. ANY FENCING THAT IS DISTURBED OR ALTERED BY THE CONTRACTOR SHALL BE RESTORED TO ITS ORIGINAL CONDITION AT THE CONTRACTORS EXPENSE. IF THE CONTRACTOR DESIRES TO REMOVE FENCING TO ACCOMMODATE CONSTRUCTION ACTIVITIES, THE CONTRACTOR SHALL OBTAIN THE OWNER'S WRITTEN PERMISSION BEFORE THE FENCE IS REMOVED. CONTRACTOR SHALL RESTORE THE FENCE TO ITS ORIGINAL CONDITION AT THE EARLIEST OPPORTUNITY. WHILE ANY FENCING IS REMOVED, THE CONTRACTOR SHALL BE SOLELY RESPONSIBLE FOR SECURITY OF THE SITE UNTIL THE FENCE IS RESTORED.

WORK WITHIN ADJACENT RIGHT-OF-WAY

PRIOR TO BEGINNING ANY CONSTRUCTION ACTIVITIES WITHIN ADJACENT RIGHT-OF-WAYS OR WITHIN PROPERTY NOT OWNED BY THE OWNER OF THE PROJECT SITE, THE CONTRACTOR SHALL ASSURE THAT ALL PERMITS AND PERMISSIONS REQUIRED HAVE BEEN OBTAINED IN WRITING.

SURVEY MONUMENTS, PROPERTY CORNERS, BENCHMARKS

THE CONTRACTOR SHALL NOTIFY THE OWNER AT LEAST SEVEN DAYS BEFORE BEGINNING ANY CONSTRUCTION ACTIVITY THAT COULD DAMAGE OR DISPLACE SURVEY MONUMENTS, PROPERTY CORNERS, OR PROJECT BENCHMARKS SO THESE ITEMS MAY BE RELOCATED.

ANY SURVEY MONUMENTS, PROPERTY CORNERS, OR BENCHMARKS THAT ARE NOT IDENTIFIED FOR RELOCATION ARE THE RESPONSIBILITY OF THE CONTRACTOR TO PRESERVE AND PROTECT, RELOCATION OR REPLACEMENT OF THESE ITEMS SHALL BE DONE BY THE OWNER'S SURVEYOR AT THE EXPENSE OF THE CONTRACTOR.

DIMENSIONS

ALL DIMENSIONS TO CURBS ARE TO THE FLOWLINE UNLESS OTHERWISE NOTED.

ALL STATIONING IS TO THE CENTERLINE OF THE RIGHT-OF-WAY UNLESS OTHERWISE NOTED.

ALL SLOPES AND GRADES ARE IN PERCENT UNLESS OTHERWISE NOTED.

CURB ELEVATIONS ARE SHOWN AT THE FLOW LINE UNLESS OTHERWISE NOTED. SEE THE DETAIL SHEET TO DETERMINE THE CURB HEIGHT ABOVE FLOW LINE.

SOILS

UNLESS OTHERWISE SPECIFIED, SUBGRADE, ENGINEERED FILL, AND STRUCTURAL FILL SHALL BE COMPACTED TO THE FOLLOWING SPECIFICATIONS OF THE ASTM D-1557 MAXIMUM DRY DENSITY.

MATERIAL/LOCATION	PERCENT COMPACTION
STRUCTURAL FILL IN THE BUILDING AREA	95%
SUBBASE FOR SLAB SUPPORT	95%
MISCELLANEOUS BACKFILL BELOW STRUCTURAL	
FILL OR ROADWAY PAVEMENT	95%
MISCELLANEOUS BACKFILL BELOW UNPAVED,	
NON-BUILDING AREAS	90%
ROADWAY PAVEMENT SUBGRADE	95 %
SIDEWALK SUBGRADE	90%
CURB AND GUTTER SUBGRADE	95%

PAVEMENT

WHEN ABUTTING NEW PAVEMENT TO EXISTING PAVEMENT, CUT EXISTING PAVEMENT EDGE TO A NEAT, STRAIGHT LINE AS NECESSARY TO REMOVE ANY BROKEN OR CRACKED PAVEMENT AND MATCH NEW PAVEMENT ELEVATION TO EXISTING.

ALL UTILITIES AND UTILITY SERVICE LINES SHALL BE INSTALLED AND APPROVED PRIOR TO PAVING.

ALL WATER VALVE BOXES AND ELECTRICAL, TELEPHONE, TELEVISION, AND SEWER MANHOLES IN THE CONSTRUCTION AREA SHALL BE ADJUSTED TO FINISHED GRADE BEFORE PAVING.

WHEN SIDEWALK OR CURB AND GUTTER IS REMOVED, IT SHALL BE REMOVED TO EXISTING CONSTRUCTION JOINTS. CUTTING OR BREAKING SHALL NOT BE ALLOWED.

	EX BLOCK WALL	\$	LIGHT POLE		EX SD INLET
x G 89.5	EX SPOT ELEV.	A	EX FIRE HYDRANT	i÷.	CONCRETE
♦ FL 09.3	PROP SPOT ELEV.	•	EX WATER VALVE		EX WATER METE
5160	EX BLOCK WALL	o	EX SD MANHOLE		EXIST. TREE
\boxtimes	TRANSFORMER	S	EX SAS MANHOLE		

UTILITIE

IF ANY UTILITY LINES, PIPELINES, OR UNDERGROUND UTILITY LINES ARE SHOWN ON THESE DRAWINGS, THEY ARE SHOWN IN AN APPROXIMATE LOCATION ONLY BASED ON THE INFORMATION PROVIDED TO THE ENGINEER BY OTHERS. THIS INFORMATION MAY BE INACCURATE OR INCOMPLETE. ADDITIONALLY, UNDERGROUND LINES MAY EXIST THAT ARE NOT SHOWN. THE CONTRACTOR SHALL VERIFY THE LOCATION OF ANY UTILITY LINE, PIPELINE, OR UNDERGROUND UTILITY LINE IN OR NEAR THE AREA OF THE WORK IN ACCORDANCE WITH CHAPTER 62, ARTICLE 14-1, THROUGH 14-8, NMSA 1978.

THE CONTRACTOR SHALL CONTACT THE STATEWIDE UTILITY LOCATOR SERVICE AT 1-800-321-2537 AT LEAST TWO WORKING DAYS BEFORE BEGINNING CONSTRUCTION. AFTER THE UTILITIES ARE SPOTTED, THE CONTRACTOR SHALL EXPOSE ALL PERTINENT UTILITIES TO VERIFY THEIR VERTICAL AND HORIZONTAL LOCATION. IF A CONFLICT EXISTS BETWEEN EXISTING UTILITIES AND PROPOSED CONSTRUCTION, THE CONTRACTOR SHALL NOTIFY THE ENGINEER SO THAT THE CONFLICT CAN BE RESOLVED WITH MINIMAL DELAY.

THE CONTRACTOR SHALL EXERCISE DUE CARE TO AVOID DISTURBING ANY EXISTING UTILITIES, ABOVE OR BELOW GROUND. UTILITIES THAT ARE DAMAGED BY CARELESS CONSTRUCTION SHALL BE REPAIRED OR REPLACED AT THE CONTRACTOR'S EXPENSE.

EXISTING VALVES SHALL ONLY BE OPERATED BY THE UTILITY COMPANY. CONTRACTOR SHALL NOTIFY THE UTILITY A MINIMUM OF TWO WORKING DAYS BEFORE ANY VALVE, NEW OR EXISTING, NEEDS TO BE OPERATED.

THE CONTRACTOR SHALL COORDINATE ANY REQUIRED UTILITY INTERRUPTIONS WITH THE OWNER AND AFFECTED UTILITY COMPANY A MINIMUM OF THREE WORKING DAYS BEFORE THE INTERRUPTION.

THE CONTRACTOR SHALL MAINTAIN A RECORD DRAWING SET OF PLANS AND PROMPTLY LOCATE ALL UTILITIES, EXITING OR NEW, IN THEIR CORRECT LOCATION, HORIZONTAL AND VERTICAL. THIS RECORD SET OF DRAWINGS SHALL BE MAINTAINED ON THE PROJECT SITE AND SHALL BE AVAILABLE TO THE OWNER AND ENGINEER AT ANY TIME DURING CONSTRUCTION.

EROSION CONTROL, ENVIRONMENTAL PROTECTION, AND STORM WATER POLLUTION PREVENTION PLAN

THE CONTRACTOR SHALL CONFORM TO ALL CITY, COUNTY, STATE, AND FEDERAL DUST AND EROSION CONTROL REGULATIONS. THE CONTRACTOR SHALL OBTAIN AND PREPARE ANY DUST CONTROL OR EROSION CONTROL PERMITS REQUIRED FROM THE REGULATORY AGENCIES.

THE CONTRACTOR SHALL PROMPTLY REMOVE ANY MATERIAL EXCAVATED WITH THE PUBLIC RIGHT-OF-WAY OR ADJACENT PROPERTY TO KEEP IT FROM WASHING OFF THE PROJECT SITE.

THE CONTRACTOR SHALL ENSURE THAT NO SOIL ERODES FROM THE SITE ONTO ADJACENT PROPERTY BY CONSTRUCTION OF TEMPORARY EROSION CONTROL BERMS OR INSTALLING SILT FENCES AT THE PROPERTY LINES AND WETTING THE SOIL TO PREVENT IT FROM BLOWING.

WATERING, AS REQUIRED FOR CONSTRUCTION DUST CONTROL, SHALL BE CONSIDERED INCIDENTAL TO CONSTRUCTION AND NO MEASUREMENT OR PAYMENT SHALL BE MADE. CONSTRUCTION AREAS SHALL BE WATERED FOR DUST CONTROL IN COMPLIANCE WITH GOVERNMENT ORDINANCES. THE CONTRACTOR SHALL BE RESPONSIBLE FOR LOCATING AND SUPPLYING WATER AS REQUIRED.

ANY AREAS DISTURBED BY CONSTRUCTION AND NOT COVERED BY LANDSCAPING OR IMPERVIOUS SURFACES SHALL BE REVEGETATED WITH RECLAMATION SEEDING.

THE CONTRACTOR SHALL PROPERLY HANDLE AND DISPOSE OF ALL ASPHALT REMOVED ON THE PROJECT BY HAULING IT TO AN APPROVED DISPOSAL SITE IN ACCORDANCE WITH THE REQUIREMENTS OF THE NEW MEXICO SOLID WASTE ACT.

ALL WASTE PRODUCTS FROM THE CONSTRUCTION SITE, INCLUDING ITEMS DESIGNED FOR REMOVAL, CONSTRUCTION WASTE, CONSTRUCTION EQUIPMENT WASTE PRODUCTS (OIL, GAS, TIRES, ETC.), GARBAGE, GRUBBING, EXCESS CUT MATERIAL, VEGETATIVE DEBRIS, ETC.. SHALL BE APPROPRIATELY DISPOSED OF OFFSET AT NO ADDITIONAL COST TO THE OWNER. IT SHALL BE THE CONTRACTOR'S RESPONSIBILITY TO OBTAIN ANY PERMITS REQUIRED FOR HAUL OR DISPOSAL OF WASTE PRODUCTS, IT SHALL BE THE CONTRACTOR'S RESPONSIBILITY TO ENSURE THAT THE WASTE DISPOSAL SITE COMPLIES WITH GOVERNMENT REGULATIONS REGARDING THE ENVIRONMENT, ENDANGERED SPECIES, AND ARCHAEOLOGICAL RESOURCES.

THE CONTRACTOR SHALL BE RESPONSIBLE FOR THE CLEANUP AND REPORTING OF SPILLS OF HAZARDOUS MATERIALS ASSOCIATED WITH THE CONSTRUCTION SITE. HAZARDOUS MATERIALS INCLUDE GASOLINE, DIESEL FUEL, MOTOR OIL, SOLVENTS, CHEMICALS, PAINT, ETC. WHICH MAY BE A THREAT TO THE ENVIRONMENT. THE CONTRACTOR SHALL REPORT THE DISCOVERY OF PAST OR PRESENT SPILLS TO THE NEW MEXICO EMERGENCY RESPONSE AT 1-800-219-6157.

THE CONTRACTOR SHALL COMPLY WITH ALL APPLICABLE REGULATIONS CONCERNING SURFACE AND UNDERGROUND WATER. CONTACT WITH SURFACE WATER BY CONSTRUCTION EQUIPMENT AND PERSONNEL SHALL BE MINIMIZED. EQUIPMENT MAINTENANCE AND REFUELING OPERATIONS SHALL BE PERFORMED IN AN ENVIRONMENTALLY SAFE MANNER IN COMPLIANCE WITH GOVERNMENT REGULATIONS.

THE CONTRACTOR SHALL COMPLY WITH ALL APPLICABLE REGULATIONS CONCERNING CONSTRUCTION NOISE AND HOURS OF OPERATION.

ACCESSIBLE FACILITIES

ALL SURFACES ALONG ACCESSIBLE ROUTES AND FOR HANDICAP RAMPS SHALL BE STABLE FIRM, SLIDE RESISTANT AND SHALL COMPLY WITH UNIFORM FEDERAL ACCESSIBILITY STANDARDS. PARAGRAPH 4.5.

LONGITUDINAL SLOPES ALONG ACCESSIBLE ROUTE SIDEWALKS, EXCEPT AT HANDICAP RAMPS, SHALL NOT BE STEEPER THAN 1: 20. CROSS SLOPES ALONG ACCESSIBLE ROUTE SIDEWALKS EXCEPT AT HANDICAP RAMPS, SHALL NOT BE STEEPER THAN 1: 48. SLOPES IN ACCESSIBLE PARKING SPACES, ACCESS AISLES, AND PASSENGER LOADING ZONES SHALL NOT BE STEEPER THAN 1: 48 IN ALL DIRECTIONS.

THE SITE SHALL COMPLY WITH ANSI A117.1-1992, "ACCESSIBLE AND USABLE BUILDINGS AND FACILITIES".

TRAFFIC CONTROL

THE CONTRACTOR SHALL PROVIDE ALL REQUIRED TRAFFIC CONTROL PLANS. ALL SIGNS, BARRICADES, CHANNELIZATION DEVICES, SIGN FRAMES AND ERECTION OF SUCH DEVICES SHALL CONFORM TO THE REQUIREMENTS OF "MANUAL OF UNIFORM TRAFFIC CONTROL DEVICES FOR STREETS AND HIGHWAYS" LATEST EDITION. PRIOR TO CONSTRUCTION, TRAFFIC CONTROL PLANS SHALL BE APPROVED BY THE GOVERNING AUTHORITY.

ABBREVIATIONS

BM = BENCHMARK

CATV = CABLE TELEVISION LINE

CO = CLEANOUT

COA = CITY OF ALBUQUERQUE

CONC = CONCRETE

CL = CENTERLINE

DIA = DIAMETER

DTL = DETAIL

DWG = DRAWING

E = ELECTRIC LINE

ELEC. = ELECTRIC

ELEV = ELEVATION

EX = EXISTING

FF = FINISHED FLOOR ELEVATION

FG = FINISHED GRADE

FH = FIRE HYDRANT

FL = FLOW LINE

G = GAS PIPE

GM = GAS METER

GV = GATE VALVE

INV = INVERT ELEVATION

LF = LINEAL FEET

LP = LIGHT POLE

L/S = LANDSCAPING

MH = MANHOLE

NG = NATURAL GROUND

OE = OVERHEAD ELECTRIC LINE

OT = OVERHEAD TELEPHONE LINE

PCC = PORTLAND CEMENT CONCRETE

PP = POWER POLE

PROP = PROPOSED

PVC = POLYVINYL CHLORIDE PIPE

RCP = REINFORCED CONCRETE PIPE

R/W = RIGHT-OF-WAY

S = SLOPE

SAS = SANITARY SEWER

SD = STORM DRAIN

STA = STATION

STD = STANDARD

T = TELEPHONE

W = SIDEWALK

SW = SIDEWALK

TA = TOP OF ASPHALT PAVEMENT

TC = TOP OF CONCRETE SLAB (PAVEMENT)

TG = TOP OF GRATE

G = TOP OF GRATE

TS = TOP OF SIDEWALK

TCC = TOP OF CONCRETE CURB

TW = TOP OF WALL

TYP = TYPICAL

UE = UNDERGROUND ELECTRIC

UT = UNDERGROUND TELEPHONE


W = WATE

WM = WATER METER
WV = WATER VALVE

BRUND OF WENT LTD CONTACT AT EFT SHBURN

ARCHITECT SEAL

ENGINEER SEAL

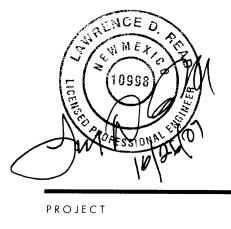

PLAN FOR BUILDING PERMIT BRUNACINI DEVELOPMENT 7550 MERIDIAN PLACE NW IBUQUERQUE, NEW MEXICO

REVISIONS

OCTOBER 22, 2007

SCALE


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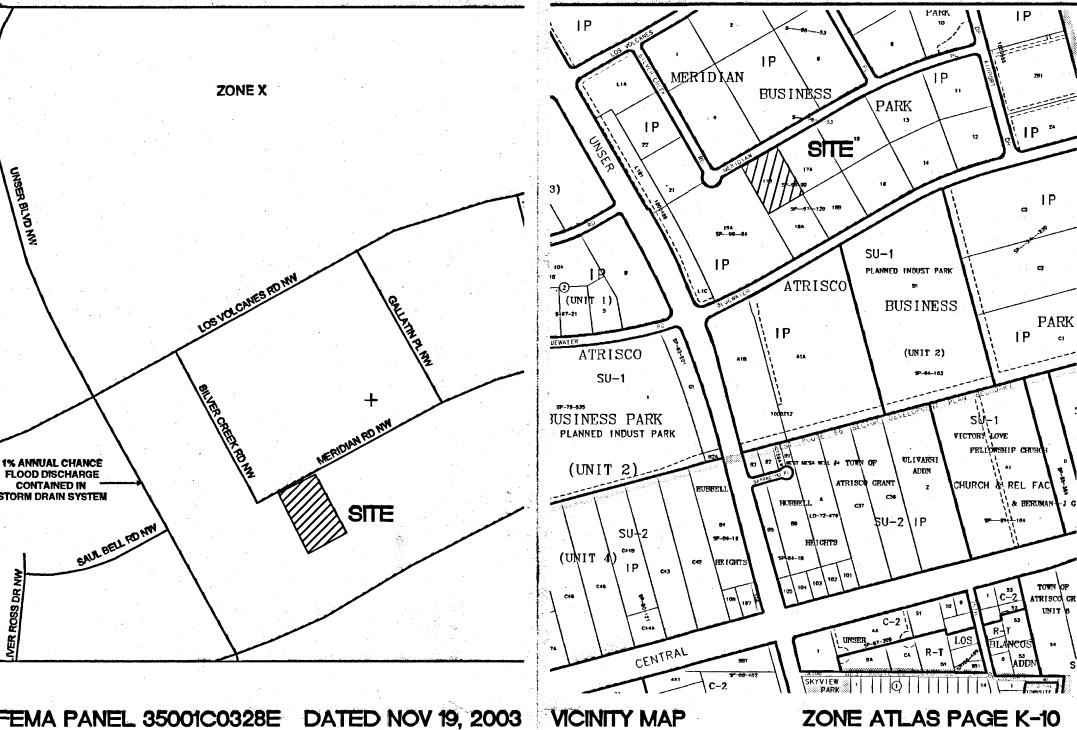


GENERAL CIVIL NOTES

SHEET NUMBER





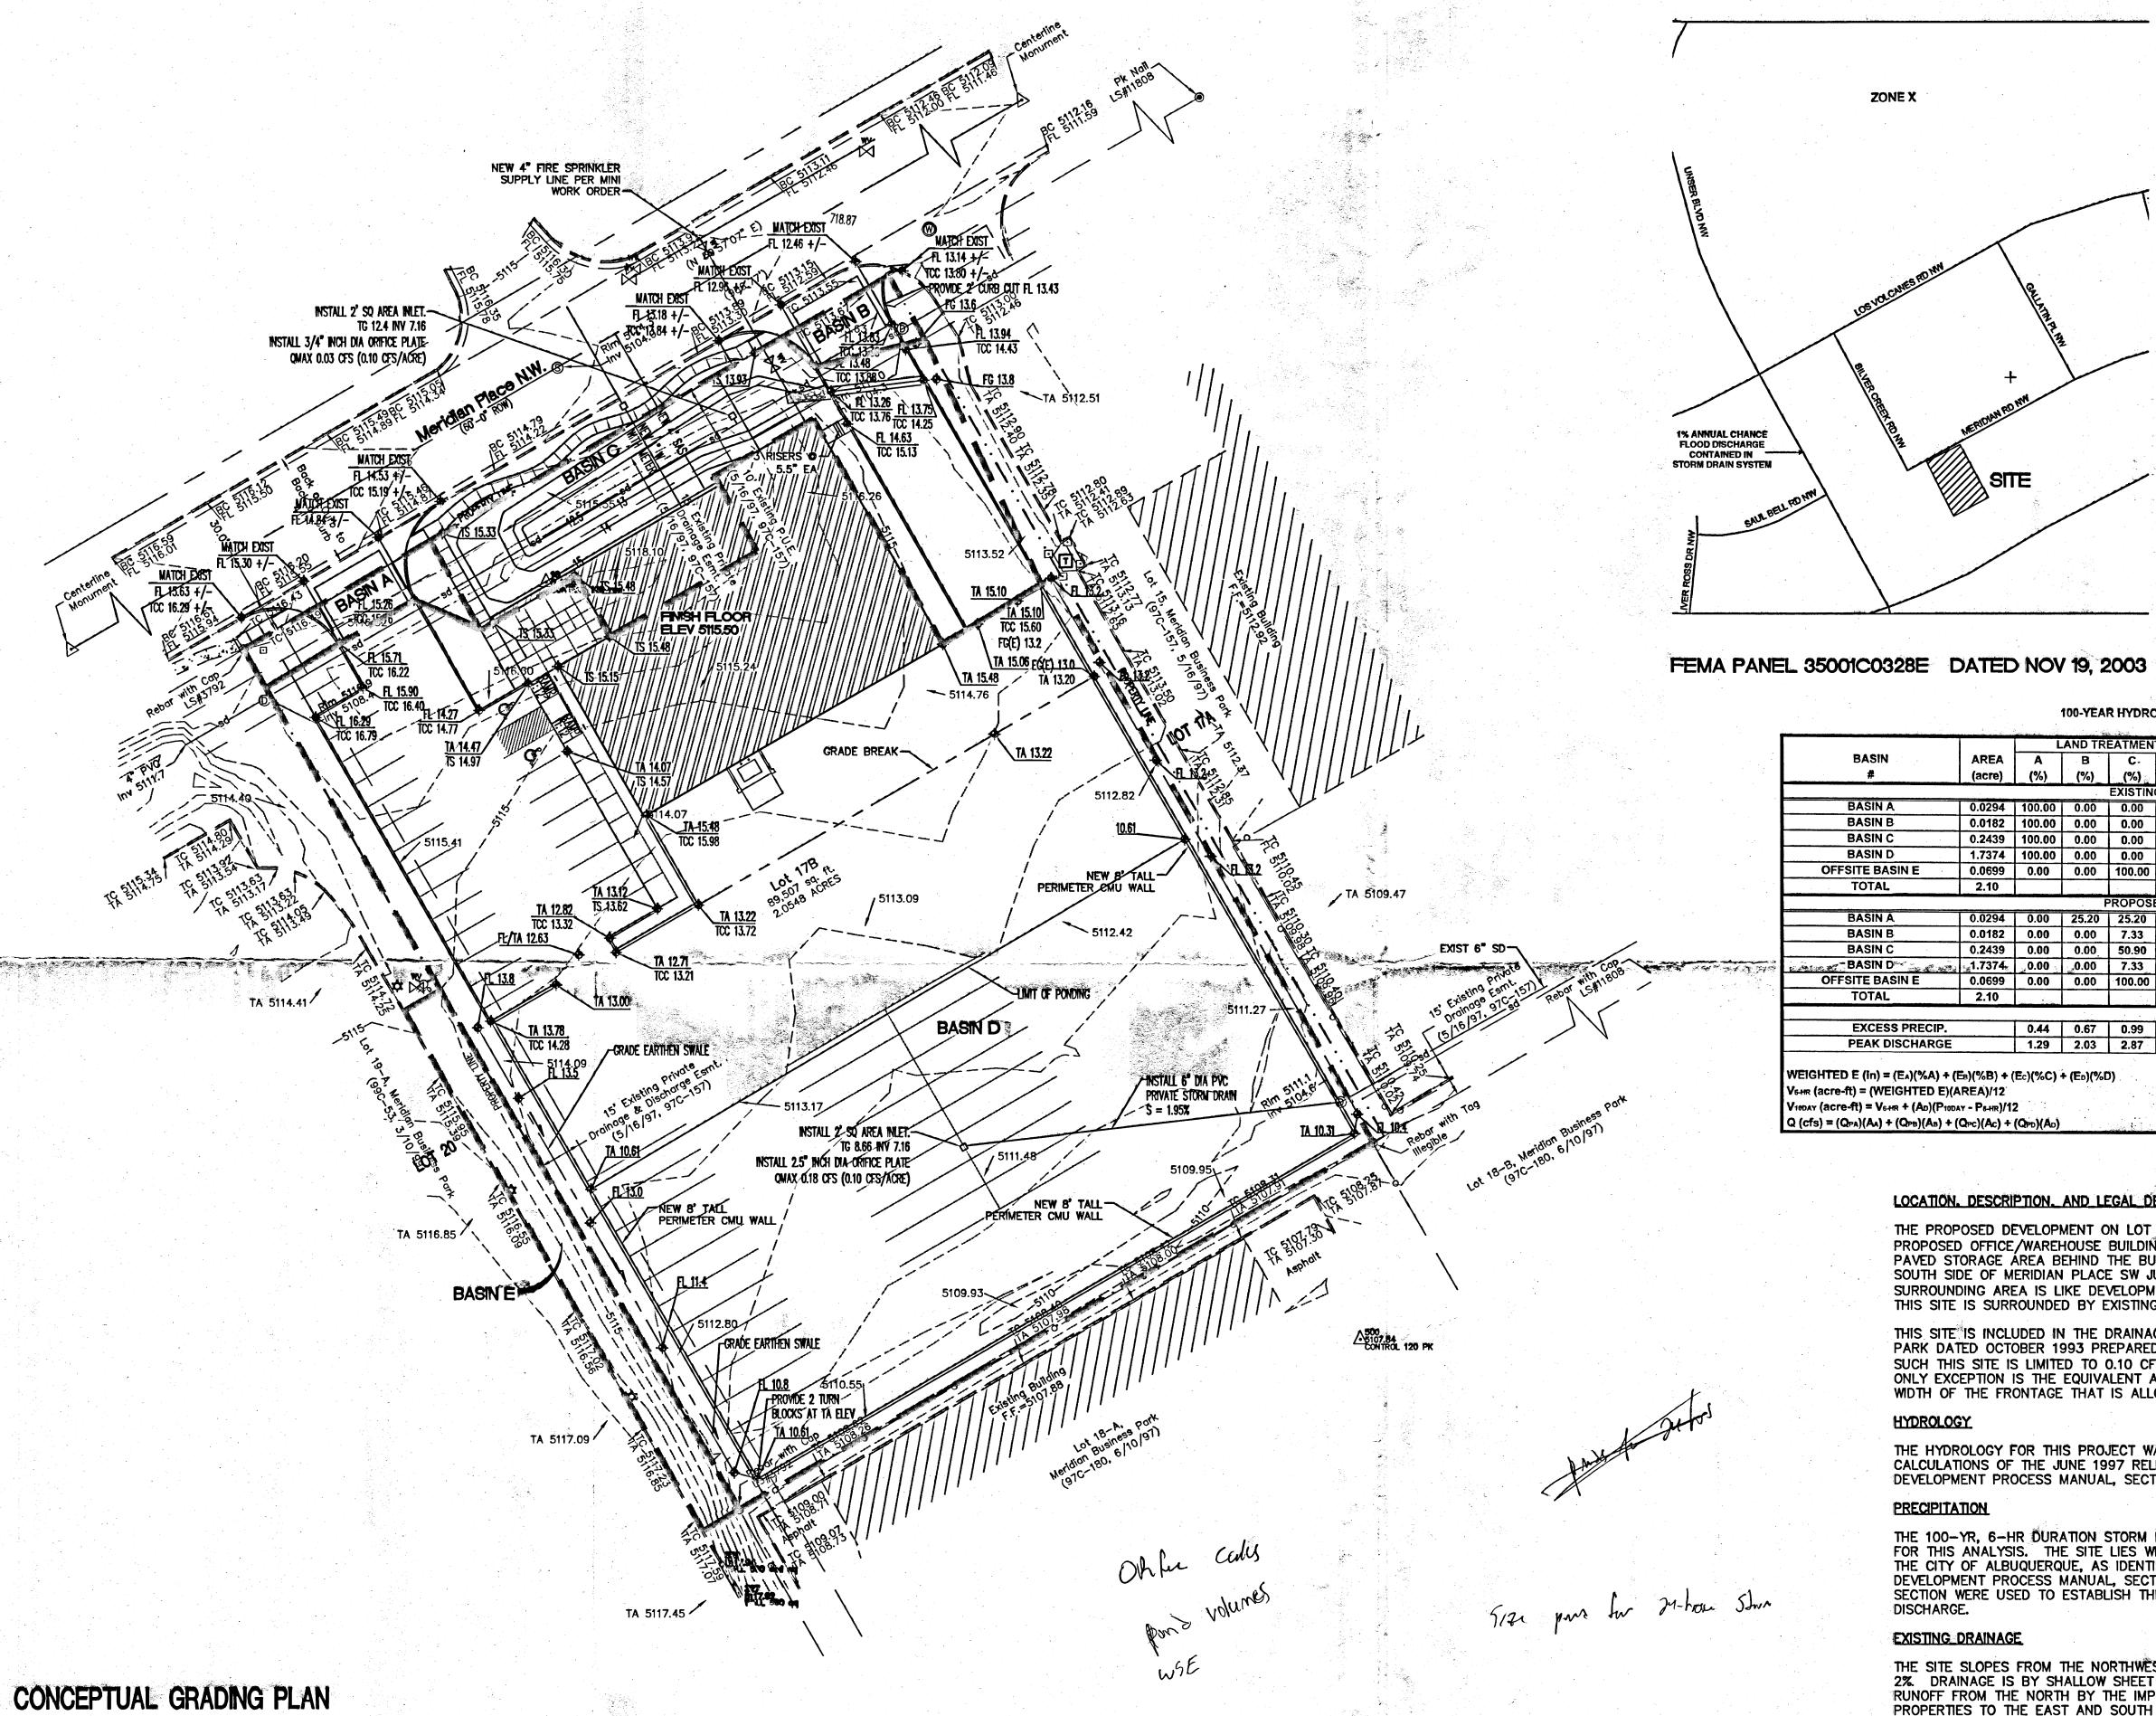

100-YEAR HYDROLOGIC CALCULATIONS

		L	AND TR	EATMEN	T	WEIGHTED		-			
BASIN	AREA	Α	В	C.	D	E	V (6-hr)	V (6-hr)	V(10 day)	V(10 day)	Q
#	(acre)	(%)	(%)_	(%)	(%)	(in)	(acre-ft)	(cu-ft)	(acre-ft)	(cu-ft)	(cfs
				EXISTIN	G COND	TIONS					
BASIN A	0.0294	100.00	0.00	0.00	0.00	0.44	0.00	47	0.00	47	0.0
BASIN B	0.0182	100.00	0.00	0.00	0.00	0.44	0.00	29	0.00	29	0.0
BASIN C	0.2439	100.00	0.00	0.00	0.00	0.44	0.01	390	0.01	390	0.3
BASIN D	1.7374	100.00	0.00	0.00	0.00	0.44	0.06	2,775	0.06	2,775	2.2
OFFSITE BASIN E	0.0699	0.00	0.00	100.00	0.00	0.99	0.01	251	0.01	251	0.2
TOTAL	2.10						0.08	3,492	0.08	3,492	2.8
			I	PROPOS	D CONE	OITIONS					
BASIN A	0.0294	0.00	25.20	25.20	49.60	1.40	0.00	149	0.01	227	0.1
BASIN B	0.0182	0.00	0.00	7.33	92.67	1.90	0.00	125	0.00	215	0.0
BASIN C	0.2439	0.00	0.00	50.90	49.10	1.47	0.03	1,303	0.04	1,942	0.8
-BASIN D	_≦ 1.7374 ₈	0.00	_0.00	7.33	92.67	1.90	0.27	11,971	0.47	20,563	7.4
OFFSITE BASIN E	0.0699	0.00	0.00	100.00	0.00	0.99	0.01	251	0.01	251	0.2
TOTAL	2.10	125					0.32	13,799	0.53	23,198	8.6
						Same of the second	•				
EXCESS PRECIP.		0.44	0.67	0.99	1.97	Eı (in)					
PEAK DISCHARGE		1.29	2.03	2.87	4.37	Q _{PI} (cfs)					
		****					. 351		ZONE =	5 - 1 - 1 - 1 - 1 - 1 - 1 - 1 - 1 - 1 -	

LOCATION. DESCRIPTION. AND LEGAL DESCRIPTION.

THE PROPOSED DEVELOPMENT ON LOT 17B, MERIDIAN BUSINESS PARK IS A PROPOSED OFFICE/WAREHOUSE BUILDING WITH ASSOCIATED PAVED PARKING AND PAVED STORAGE AREA BEHIND THE BUILDING. THE SITE IS LOCATED ON THE SOUTH SIDE OF MERIDIAN PLACE SW JUST EAST OF SILVER CREED ROAD SW. THE SURROUNDING AREA IS LIKE DEVELOPMENT OF OFFICE/WAREHOUSE PROPERTIES. THIS SITE IS SURROUNDED BY EXISTING DEVELOPMENT.

THIS SITE IS INCLUDED IN THE DRAINAGE MASTER PLAN FOR ATRISCO BUSINESS PARK DATED OCTOBER 1993 PREPARED BY EASTERLING AND ASSOCIATES, INC. AS SUCH THIS SITE IS LIMITED TO 0.10 CFS/ACRE DISCHARGE FROM THE SITE. THE ONLY EXCEPTION IS THE EQUIVALENT AREA OF A STRIP 10-FEET WIDE FOR THE WIDTH OF THE FRONTAGE THAT IS ALLOWED TO FREE DISCHARGE INTO THE STREET.

HYDROLOGY

THE HYDROLOGY FOR THIS PROJECT WAS ANALYZED USING THE QUICK CALCULATIONS OF THE JUNE 1997 RELEASE OF THE CITY OF ALBUQUERQUE DEVELOPMENT PROCESS MANUAL, SECTION 22.2.

PRECIPITATION


THE 100-YR, 6-HR DURATION STORM EVENT WAS USED AS THE DESIGN STORM FOR THIS ANALYSIS. THE SITE LIES WITHIN THE ZONE 1 PRECIPITATION AREA FOR THE CITY OF ALBUQUERQUE, AS IDENTIFIED IN THE CITY OF ALBUQUERQUE DEVELOPMENT PROCESS MANUAL, SECTION 22.2. THEREFORE, TABLES WITHIN THIS SECTION WERE USED TO ESTABLISH THE EXCESS PRECIPITATION AND PEAK DISCHARGE.

EXISTING DRAINAGE

THE SITE SLOPES FROM THE NORTHWEST TO THE SOUTHEAST AT APPROXIMATELY 2%. DRAINAGE IS BY SHALLOW SHEET FLOW. THE SITE IS PROTECTED FROM RUNOFF FROM THE NORTH BY THE IMPROVED SECTION OF MERIDIAN PLACE. THE PROPERTIES TO THE EAST AND SOUTH ARE BELOW THIS SITE SO THERE IS NO IMPACT. THE ONLY IMPACT IS FROM THE SITE TO THE WEST WHERE AN AREA (OFFSITE BASIN E) BETWEEN THE CURB AND PROPERTY LINE IS GRADED AS AN EMBANKMENT SLOPE THAT DISCHARGES INTO THIS LOT.

DEVELOPED CONDITION

THE PROPOSED DEVELOPED CONDITION COMPLIES WITH THE MASTER DRAINAGE PLAN BY PROVIDING TWO DETENTION PONDS. THE FIRST COLLECTS THE RUNOFF FROM BASIN C AND DISCHARGES IT, AT A CONTROLLED RATE OF 0.03 CFS INTO THE EXISTING PRIVATE STORM DRAIN ALONG THE SOUTH SIDE OF MERIDIAN PLACE. THE SECOND POND IN THE SOUTH YARD COLLECTS BASIN D AND DISCHARGES, AT A CONTROLLED RATE OF (0.28 CFS INTO THE EXISTING PRIVATE STORM DRAIN THAT BEGINS AT THE SOUTHEAST CORNER OF THIS SITE. BOTH STORM DRAINS WERE DESIGNED TO ACCOMMODATE THIS SITE.

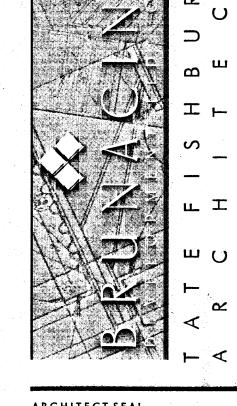

ARCHITECTSEAL

ENGINEER SEAL



PROJECT

PL JRUN 755C 9UC 百图以圆

REVISIONS

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AUGUST 21, 2007

SCALE 1"=30'-0"

DRAWING NAME CONCEPTUAL GRADING PLAN

SHEET NUMBER

AUG 2 7 2007

HYDROLOGY SECTION

P_{24+R} (in.) = 2.66

Proday (in.) = 3.67