Planning Department Alan Varela, Director



Mayor Timothy M. Keller

September 2, 2022

Tate Fishburn, RA
Tate Fishburn Architect
P.O Box 2941
Corrales, NM 87048

Re: New Office/ Ware House

541 Airport Dr. NW

Conceptual Traffic Circulation Layout for DRB Approval

Architect's Stamp 07-12-22 (K10-D023K)

Dear Mr. Fishburn,

The conceptual TCL submittal received 07-29-2022 is approved for DRB submittal. When submitting this project through the building permit process, please provide a copy of the approved DRB Site plan along with a more detailed site plan for construction purposes through a second Traffic Circulation Layout submittal process. The detailed plan will be compared against the approved DRB site plan to ensure that all previously approved site infrastructure is shown with exact paving layout, dimensioning, and parking capacity. Ultimately, a copy of the approved DRB Site Plan and the more detailed stamped and signed plan will both be needed for each of the building permit plans. Please keep these originals to be used for certification of the site for final C.O. for Transportation.

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When the site construction is completed and an inspection for Certificate of Occupancy (C.O.) is requested, use the original City stamped approved TCL for certification. Redline any minor changes and adjustments that were made in the field. A NM registered architect or engineer must stamp, sign, and date the certification TCL along with indicating that the development was built in "substantial compliance" with the TCL. Submit this certification, the TCL, and a completed

NM 87103

<u>Drainage and Transportation Information Sheet</u> to front counter personnel for log in and evaluation by Transportation.

www.cabq.gov

Once verification of certification is completed and approved, notification will be made to Building Safety to issue Final C.O. To confirm that a final C.O. has been issued, call Building Safety at 924-3690.

Sincerely,

Ernest Armijo, P.E.

Principal Engineer, Planning Dept.

Development Review Services

C: CO Clerk, Fil



City of Albuquerque

Planning Department

Development & Building Services Division

DRAINAGE AND TRANSPORTATION INFORMATION SHEET (REV 6/2018)

Project Title: NEW OFFICE/	WAREHOUSE Per	rmit #:	Hydrology File #:	
RB#: EPC#:			Work Order#:	
Legal Description: LOT 7-B A	ND LOT 10 MERIDIA	N BUSINESS F	PARK	
City Address: 541 AIRPOR				
Applicant: TATE FISHBURN			Contact: TATE FISHBURN	
Address: P.O. BOX 2941, C				
Phone#:	Fax#:		E-mail:tatefishburn@msn.com	
Other Contact:			Contact:	
Address:				
			E-mail:	
TYPE OF DEVELOPMENT:	PLAT (# of lots)	RESIDENCE	X DRB SITE ADMIN SITE	
IS THIS A RESUBMITTAL?X	Yes No			
DEPARTMENT X TRANSPOR	TATIONHYD	ROLOGY/DRAINA	AGE	
Check all that Apply: TYPE OF SUBMITTAL: ENGINEER/ARCHITECT CER' PAD CERTIFICATION CONCEPTUAL G & D PLAN GRADING PLAN DRAINAGE REPORT DRAINAGE MASTER PLAN		BUILDIN CERTIFIC PRELIMI SITE PLA X SITE PLA	PROVAL/ACCEPTANCE SOUGHT: G PERMIT APPROVAL CATE OF OCCUPANCY NARY PLAT APPROVAL AN FOR SUB'D APPROVAL AN FOR BLDG. PERMIT APPROVAL LAT APPROVAL	
FLOODPLAIN DEVELOPMENT ELEVATION CERTIFICATE CLOMR/LOMR X TRAFFIC CIRCULATION LAY TRAFFIC IMPACT STUDY (TIME STREET LIGHT LAYOUT OTHER (SPECIFY) PRE-DESIGN MEETING? DATE SUBMITTED: 07-13-20	OUT (TCL)	SIA/ RELEASE OF FINANCIAL GUARANTEE FOUNDATION PERMIT APPROVAL GRADING PERMIT APPROVAL SO-19 APPROVAL PAVING PERMIT APPROVAL GRADING/ PAD CERTIFICATION WORK ORDER APPROVAL CLOMR/LOMR FLOODPLAIN DEVELOPMENT PERMIT OTHER (SPECIFY) PRE-DRB SUBMITTAL		
COA STAFF:	ELECTRONIC	SUBMITTAL RECEIVE	D:	

FEE PAID:_

Planning Department Brennon Williams, Director



Mayor Timothy M. Keller

June 20, 2022

Tate Fishburn, RA P.O. Box 2941 Corrales, NM 87048

Re: NEW OFFICE/WAREHOUSE 541 Airport Drive NW Traffic Circulation Layout Architect's Stamp None (K10-D023)

Dear Mr. Fishburn,

Based upon the information provided in your submittal received 06-16-2022, the above referenced plan cannot be approved for Building Permit until the following comments are addressed:

- Listed are the number of parking spaces required by the IDO as well as the proposed number of parking spaces including bicycle and motorcycle parking.
 Coordinate/discuss with Zoning.
- 2. Clarify the extents of the current phase 1 versus phase 2. Are you proposing phase 2 as part of this submittal? Explain since phase 2 is on a different lot and will required a separate submittal and fees. I will not comment on sheet SDP-2 until the appropriate action is taken for the submittal process.
- 3. The traffic circulation layout must be stamped, signed, and dated by an engineer or architect licensed in the state of New Mexico.
- 4. **Proposed Driveway (Los Volcanes):** Provide entrance design or reference design per COA std dwg 2426.
- 5. Airport Driveway:
 - First proposed drive entrance location: What is the distance from Los Volcanes? Verify you meet the required distance from a Collector on Airport.
 - Second proposed driveway: How will you provide a 6 ft valley gutter across the 30 ft driveway when you are only providing temp. extruded curb and status of ramp on the southside of entrance.
- 6. **Keyed Note 1:** Please reference detail and sheet number.
- 7. Keyed Note 7:
 - Please provide entrance ramp detail since a detail has not been provided.
 - Sidewalk detail will be needed and reference COA std dwg 2430 (public sidewalk) on both Los Volcanes and Airport Drive (when applicable.
- 8. Keved Note 8: Need to provide detail.
- 9. Detail 4 (Accessible Parking):
 - The landing will need to be label 50:1 max in all directions.

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- NO PARKING: Detail for the text will need to be provided.
- 10. Please identify all **proposed buildings, doors, structures, sidewalks**, curbs, drive pads, wall and anything that influences the parking and circulation on the site.
- 11. Identify all existing access easements and rights of way width dimensions.
- 12. Identify the right of way width, medians, curb cuts, and street widths on Los Volcanes and Airport Drive.
- 13. The minimum parking stall dimensions are:

Type of parking	Min. Width	Min. Length	Min. Overhang
Standard	8.5'	18'	2'
Compact	7.5'	15'	1.5'
Motorcycle	4'	8'	N/A
ADA	8.5'	18'	2'

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14. The ADA accessible parking sign must have the required language per 66-7-352.4C NMSA 1978 "Violators Are Subject to a Fine and/or Towing." Please call out detail and location of signs. The sign height is not correct. Please review COA standards for correct signage height.

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15. The ADA access aisles shall have the words "NO PARKING" in capital letters, each of which shall be at least one foot high and at least two inches wide, placed at the rear of the parking space so as to be close to where an adjacent vehicle's rear tire would be placed. (66-1-4.1.B NMSA 1978). Provide details.

NM 87103

16. All ADA curb ramps within public ROW must be updated to current standards and have truncated domes installed. Please verify corner of Los Volcanes/Airport ramp complies with these requirements stated.

- 17. Any private structures that are located within public right-of-way such as fences and walls shall either be removed or else a revocable permit with the City is required in which an annual fee is paid per year, based on square footage of the encroachment. All posts and other items within public ROW will need to be removed.
- 18. Motorcycle parking spaces: Label pavement MC. Provide detail for pavement text.
- 19. All bicycle racks shall be designed according to the following guidelines:
 - a. The rack shall be a minimum 30 inches tall and 18 inches wide.
 - b. The bicycle frame shall be supported horizontally at two or more places. Comb/toaster racks are not allowed.
 - c. The rack shall be designed to support the bicycle in an upright position. See the IDO for additional information.
 - d. The rack allows varying bicycle frame sizes and styles to be attached.
 - e. The user is not required to lift the bicycle onto the bicycle rack.

Planning Department Brennon Williams, Director



Mayor Timothy M. Keller

- f. Each bicycle parking space is accessible without moving another bicycle.
- 20. Bicycle racks shall be sturdy and anchored to a concrete pad.
- 21. A 1-foot clear zone around the bicycle parking stall shall be provided.
- 22. Bicycle parking spaces shall be at least 6 feet long and 2 feet wide.
- 23. Per DPM, a 6 ft. wide ADA accessible pedestrian pathway is required from the ADA parking stall access aisles to the building entrances. Please clearly show this pathway and provide details. Adjacent to bicycle parking there is a bump out and no dimension provided, so this segment of sidewalk will needed 6ft width without the bump and overhang from vehicle parking stall as well as the second & third set of ADA parking stalls. Throughout the parking lot there shall be a clear 6ft pedestrian pathway, this will need to be shown on the site plan with sidewalk widths.
- 24. All proposed pavement markings and striping will need details.
- 25. Parking areas shall have barriers to prevent vehicles from extending over sidewalk, and landscaping.
- 26. Corner of building will need bollards (details need and painted traffic yellow) so delivery truck will be aware and avoid any type of conflict.

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- 27. Provide a copy of refuse approval.
- 28. Fire Department: An approval Fire 1 plan needs to be provided.

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29. It is not apparent what type of pavement surface design is being proposed for heavy vehicle traffic. Please provide pavement design for delivery truck traffic and vehicle traffic on drive aisles.

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30. Please provide a sight distance exhibit

31. **Intersection Sight Distance:** A clear sight line will be needed on Airport and Los Volcanes intersection for turning movements for Airport Drive.

- 32. Show the clear sight triangle and add the following note to the plan: "Landscaping and signage will not interfere with clear sight requirements. Therefore, signs, walls, trees, and shrubbery between 3 and 8 feet tall (as measured from the gutter pan) will not be acceptable in the clear sight triangle.
- 33. Please specify the City Standard Drawing Number when applicable.
- 34. Shared Site access: driveways that straddle property lines, or are entirely on one propertybut are to be used by another property, shall have an access easement. Please include a copy of your shared access agreement with the adjacent property owner.
- 35. Add a note stating "All broken or cracked sidewalk must be replaced with sidewalk and curb & gutter." A build note must be provided referring to the appropriate City Standard drawing (2430 & 2415A).
- 36. Please provide a letter of response for all comments given.
- 37. Traffic Studies: See the Traffic Impact Study (TIS) thresholds. In general, a minimum combination of 100 vehicles entering and exiting in the peak hour warrants a Traffic Impact Study. Visit with Traffic Engineer for determination, and fill out a TIS Form that

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states whether one is warranted. In some cases, a trip generation may be requested for determination (Contact Matt Grush: mgrush@cabq.gov).

Once corrections are complete resubmit

- 1. The Traffic Circulation Layout
- 2. A Drainage Transportation Information Sheet (DTIS)
- 3. Send an electronic copy of your submittal to PLNDRS@cabq.gov.
- 4. The \$75 re-submittal fee.

for log in and evaluation by Transportation.

If you have any questions, please contact me at (505) 924-3630.

Sincerel

PO Box 1293

Nilo Salgado-Fernandez, P.E.

Senior Traffic Engineer, Planning Dept.

Albuquerque

Development Review Services

NM 87103

C: CO Clerk, File

July 12, 2022

Ernest Armijo, P.E. Manager for Transportation City of Albuquerque Traffic Engineering 600 N. 2nd Street Suite 300 Albuquerque NM 97102

Subject-New Office/Warehouse- 541 Airport Drive NW Traffic Circulation Layout Review

Dear Ernest,

This memo is in response to comments received from Nilo Salgado-Fernandez concerning our submittal for TCL approval for DRB. Our responses are numbered to correlate with Nilo's comments on his letter to us dated June 20, 2022.

Project Description- This project will involve three separate lots that are all owned by the same entity, lots 7A, 7B and 10. Cross access and drainage easements exist on lots 7A & 7B while lot 10 will be added to this cross access easement with this project. The project will also be divided into two phases shown separately on sheet SDP-1 and SDP-2. Phase one shown on SDP-1 will involve the new building and all site improvements on Lot 7B. Phase two shown on DSP-2 will involve developing lot 10 for trailer parking for the two buildings on Lot 7A and 7B. Phase two will also involve some minor reconfigurations to the existing truck court on 7A and some docks on 7B. Please refer to the drawings for details of the phasing.

Responses to comments

- 1. Parking is shown per the IDO.
- 2. Refer to the project description above as well as more detailed noting on the plans. Also attached is the draft access easement.
- 3. Revised plans have architect stamp, signed and dated.
- 4. Refer to revised plans for noted standard drawings at driveways.
- 5. Refer to revised plans for distance to drive and clarification on extent of the temp. extruded curb. Both Airport and Los Volcanes are collector streets.
- 6. Refer to revised plans for detail reference.
- 7. Refer to revised plans for std. dwg notes for ramps and sidewalks.
- 8. Refer to revised plans for temp. extruded curb detail.
- 9. Refer to revised details for HC parking.
- 10. Refer to revised drawings for clarifications doors, sidewalks etc.
- 11. Refer to revised drawings for easement and ROW clarifications.
- 12. Refer to revised plans.
- 13. Refer to revised motorcycle parking details for stall dimensions.
- 14. Refer to revised HC parking sign details for added notes.
- 15. Refer to revised ADA access aisle details.
- 16. Refer to revised plans for truncated domes at new curb ramps and the existing curb ramp at intersection.
- 17. No structures in the public ROW.


- 18. Refer to revised plans for motorcycle parking details.
- 19. Refer to revised bicycle rack details.
- 20. Same as above.
- 21. Same as 19 above.
- 22. Same as 19 above.
- 23. Refer to plans for clarification. We have 8' wide sidewalks along the entire length of the building. We have hatched the conc. sidewalks to help clarify.
- 24. Refer to revised plans.
- 25. All parking areas have either conc. curbs or conc. parking bumpers.
- 26. Refer to revised plans for added bollards at corner.
- 27. Solid Waste approved plan is attached.
- 28. Approved Fire One plan is attached.
- 29. Refer to revised plans for paving design note.
- 30. Refer to revised plans for clear site triangles.
- 31. Refer to revised plans for site distances. See the legend for hatching.
- 32. Same as 30 above.
- 33. Refer to revised plans for added City Standard Drawing numbers.
- 34. Shared access easements are attached.
- 35. Refer to revised plans for general note concerning existing sidewalks and c&g.
- 36. This is the response letter.
- 37. TIS form is attached.

Please refer to the revised SDP-1 and SDP-2 along with supporting documents. Let us know if you need any further clarification.

Sincerely,

Tate Fishburn

Registered Architect No. 3550

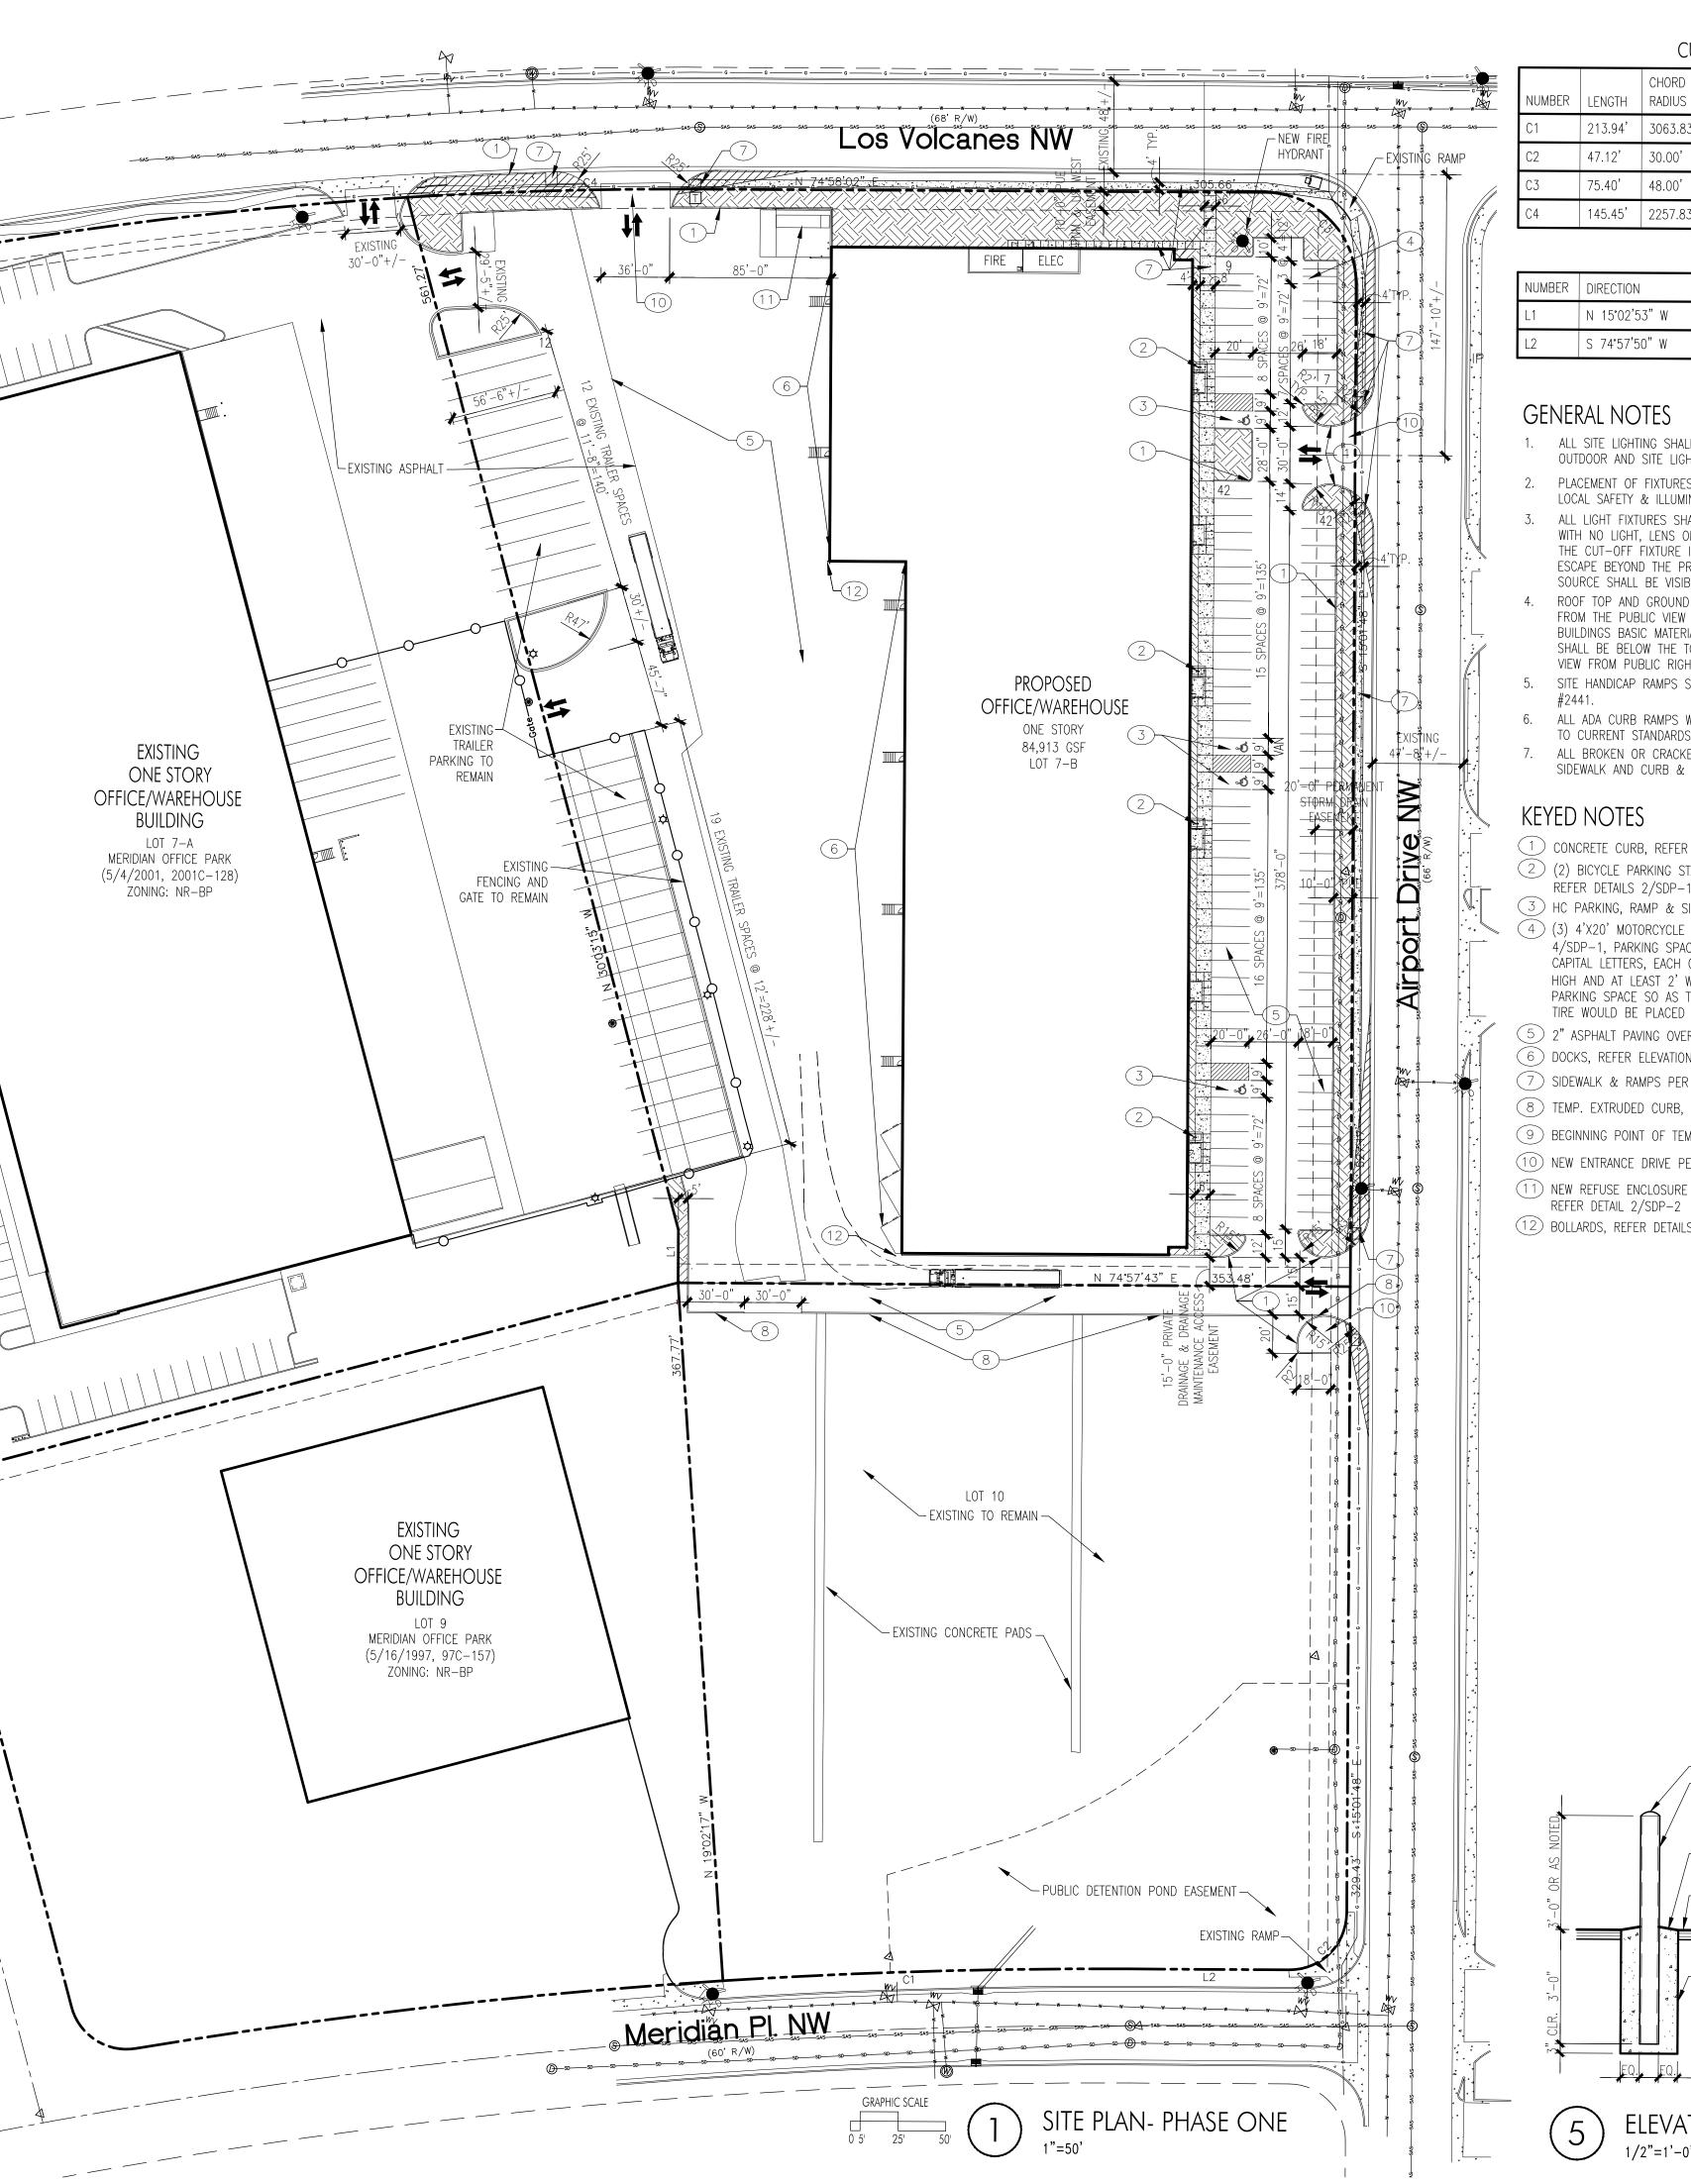

CURVE TABLE

		CHORD		CHORD	CHORD
NUMBER	LENGTH	RADIUS	DELTA	LENGTH	DIRECTION
C1	213.94'	3063.83	4°00'03"	213.90"	S 72°57′53" W
C2	47.12'	30.00'	89°59'37"	213.90"	S 29°58'01" W
C3	75.40'	48.00'	90°00'11"	213.90"	S 60°01'53" E
C4	145.45'	2257.83	3°41'27"	213.90"	N 72°56'11" E

LINE TABLE


JMBER	DIRECTION	LENGTH
	N 15°02'53" W	27.96'
	S 74°57'50" W	84.01'


GENERAL NOTES


- 1. ALL SITE LIGHTING SHALL COMPLY WITH IDO SECTION 14-16-5-8. OUTDOOR AND SITE LIGHTING.
- 2. PLACEMENT OF FIXTURES & STANDARDS SHALL CONFORM TO STATE & LOCAL SAFETY & ILLUMINATION REQUIREMENTS.
- ALL LIGHT FIXTURES SHALL BE FULLY SHIELDED HORIZONTAL LAMPS WITH NO LIGHT, LENS OR BULB PROTRUDING BELOW THE BOTTOM OF THE CUT-OFF FIXTURE IN ORDER THAT NO FUGITIVE LIGHT SHALL ESCAPE BEYOND THE PROPERTY LINE AND NO SITE LIGHTING LIGHT SOURCE SHALL BE VISIBLE FRO THE SITE PERIMETER.
- ROOF TOP AND GROUND MOUNTED EQUIPMENT SHALL BE SCREENED FROM THE PUBLIC VIEW BY MATERIALS OF THE SAME NATURE AS THE BUILDINGS BASIC MATERIALS. THE TOP OF ALL ROOFTOP EQUIPMENT SHALL BE BELOW THE TOP OF THE PARAPET OR SCREENED FROM VIEW FROM PUBLIC RIGHTS-OF-WAY AND THE SITE ACCESS EASEMENT.
- 5. SITE HANDICAP RAMPS SHALL BE BUILT BY COA STANDARD DRAWING
- 6. ALL ADA CURB RAMPS WITHIN THE PUBLIC ROW SHALL BE UPDATED TO CURRENT STANDARDS AND HAVE TRUNCATED DOMES INSTALLED.
- 7. ALL BROKEN OR CRACKED SIDEWALK MUST BE REPLACED WITH SIDEWALK AND CURB & GUTTER.


KEYED NOTES


- 1 CONCRETE CURB, REFER DETAIL 3/SDP-2
- (2) (2) BICYCLE PARKING STALLS W/ 1' CLEAR ZONE AROUND STALL, REFER DETAILS 2/SDP-1
- (3) HC PARKING, RAMP & SIGN, REFER DETAILS 3&4/SDP-1 (4)(3) 4'X20' MOTORCYCLE PARKING SPACE & SIGN, REFER DETAILS 4/SDP-1, PARKING SPACE SHALL HAVE THE LETTERS 'MC' IN CAPITAL LETTERS, EACH OF WHICH SHALL BE AT LEAST ONE FOOT HIGH AND AT LEAST 2' WIDE PLACED AT THE REAR OF THE PARKING SPACE SO AS TO BE CLOSE TO WHERE VEHICLES REAR
- (5) 2" ASPHALT PAVING OVER 4" BASE COURSE
- (6) DOCKS, REFER ELEVATIONS
- (7) SIDEWALK & RAMPS PER COA STD DWG 2430 & 2411
- (8) TEMP. EXTRUDED CURB, REFER DETAIL 5/SDP-2
- (9) BEGINNING POINT OF TEMP. EXTRUDED CURB
- (10) NEW ENTRANCE DRIVE PER COA STD DWG 2426
- (11) NEW REFUSE ENCLOSURE FOR COMPACTOR AND ONE RECYCLE BIN. REFER DETAIL 2/SDP-2
- (12) BOLLARDS, REFER DETAILS 5/SDP-1

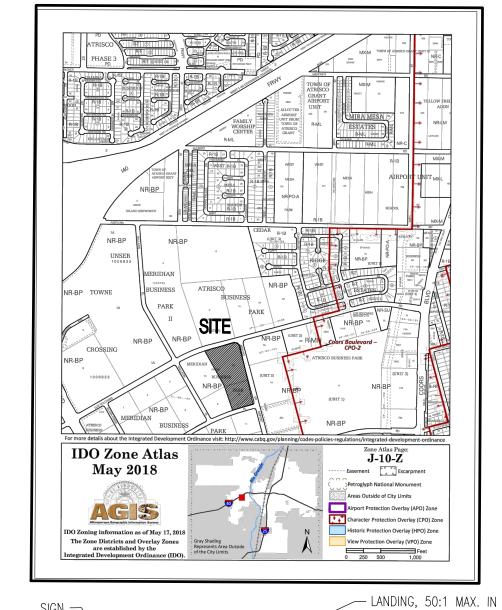


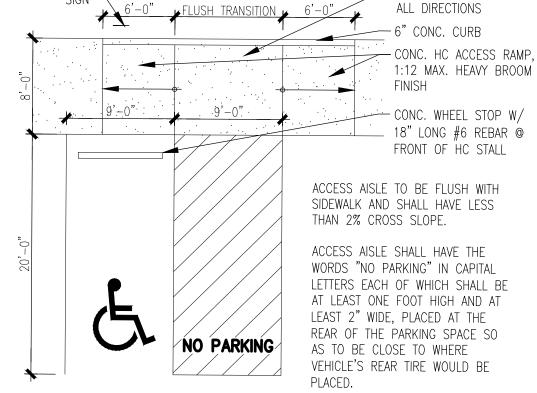

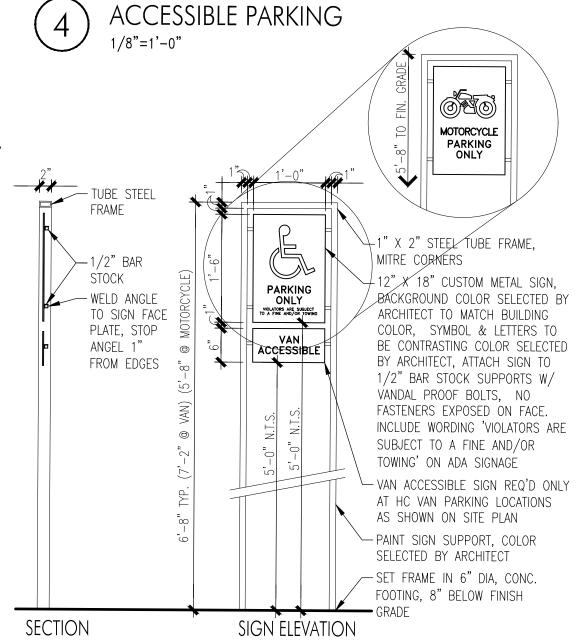

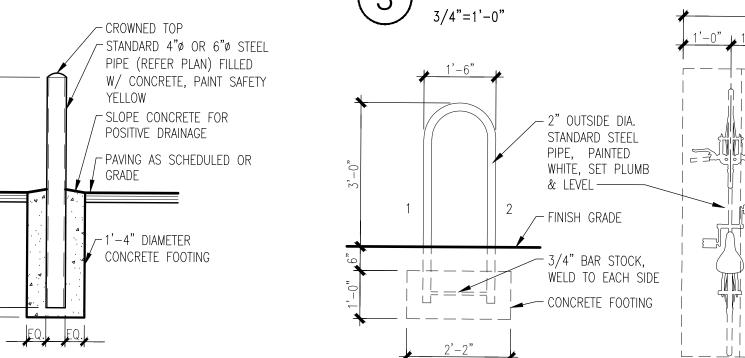

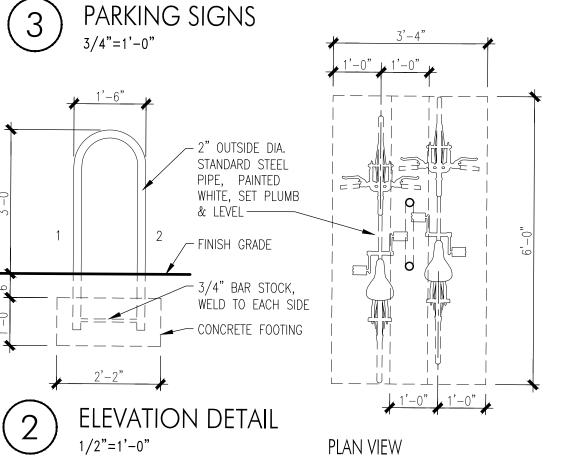

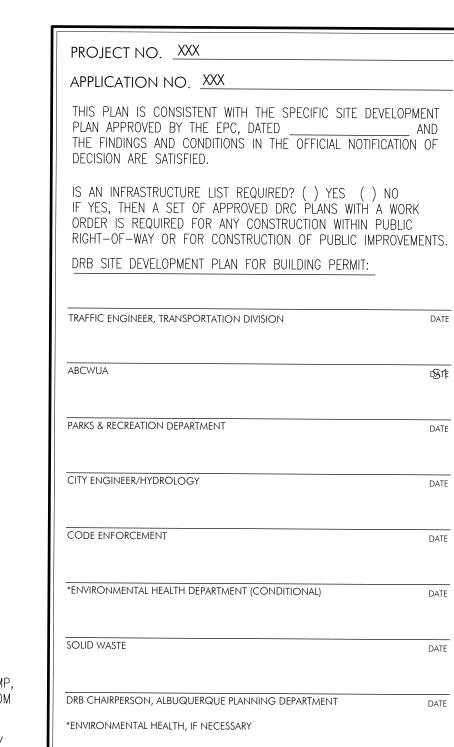

PROJECT INFORMATION PROJECT: NEW OFFICE/WAREHOUSE LOCATION:

541 AIRPORT DRIVE, NW ALBUQUERQUE, NEW MEXICO OWNER: BRUNACINI BUILDERS 1 OPPORTUNITY LAND, LLC ARCHITECT: TATE FISHBURN ARCHITECT

LOT NUMBERED SEVEN-B (7-B) OF THE PLAT OF LOT 7-A AND 7-B, PROJECT MERIDIAN BUSINESS PARK, (BEING A REPLAT OF LOTS 7 AND 8, MERIDIAN BUSINESS PARK) CITY OF ALBUQUERQUE, BERNALILLO COUNTY, NEW MEXICO, AS THE SAME IS SHOWN AND DESIGNATED ON THE PLAT OF SAID SUBDIVISION, FILED IN THE OFFICE OF THE COUNTY CLERK OF BERNALILLO COUNTY, NEW MEXICO ON MAY 4, 2001, IN PLAT BOOK 2001C, FOLIO 128.

LOT NUMBERED TEN (10) OF THE PLAT OF LOTS 1 THRU 23, MERIDIAN BUSINESS PARK, (BEING A REPLAT OF LOTS 1 THRU 9 IN TRACT M, ATRISCO BUSINESS PARK UNIT 2) CITY OF ALBUQUERQUE, NEW MEXICO, AS THE SAME IS SHOWN AND DESIGNATED ON THE PLAT OF SAID SUBDIVISION, FILED IN THE OFFICE OF THE COUNTY CLERK OF BERNALILLO COUNTY, NEW MEXICO ON MAY 16, 1997 IN PLAT BOOK 97C, FOLIO 157.

CURRENT ZONING CLASSIFICATION: NET SITE AREA:

LOT 7-B - 242,754 SF 5.5729 ACRES LOT 10 - 122,863 SF 2.8206 ACRES

OFFICE 21,228 GSF

84,913 GSF

NO REQUIREMENT

WAREHOUSE 63,685 GSF

BUILDING AREA: LOT 7-B

PARKING ANALYSIS:

LEGAL DESCRIPTION:

21,228 GSF 3.5:1000 = 75 SPACES63,685 GSF WAREHOUSE REQUIRED 75 SPACES TOTAL SPACES PROVIDED 100 SPACES

HANDICAP PARKING (51-100 PRVD) = REQUIRED 4 SPACES TOTAL (1 VAN) PROVIDED 4 SPACES TOTAL (1 VAN) $(51-100 \text{ PRVD}) = \text{REQUIRED} \quad 3 \text{ SPACES}$

PROVIDED 3 SPACES BICYCLE PARKING (10% RQD PARKING SPACES) = REQUIRED 8 SPACES

--- PROPERTY LINE ---- EASEMENT LINE



HANDICAP PARKING PAVEMENT MARKING

25' WHITE PARKING LOT POLE W/ (3) 100 WATT LED FIXTURE HEADS

> SITE DISTANCE AND SITE TRIANGLE BASED ON COA DPM 7-5(i)(5)(iii) and 7-5(i)(5)(iv), LANDSCAPING AND SIGNAGE WILL NOT INTERFERE WITH CLEAR SIGHT REQUIREMENTS, THEREFORE SIGNS, WALLS, TREES, AND SHRUBBERY BETWEEN 3 AND 8 FEET TALL (AS MEASURED FROM THE GUTTER PAN) WILL NOT BE ACCEPTABLE IN THE CLEAR SITE




REVISIONS

MAY 2022 1"=50'-0"

OR AS NOTED DRAWING NAME SITE DEVELOPMENT PLAN PHASE ONE

SHEET NUMBER

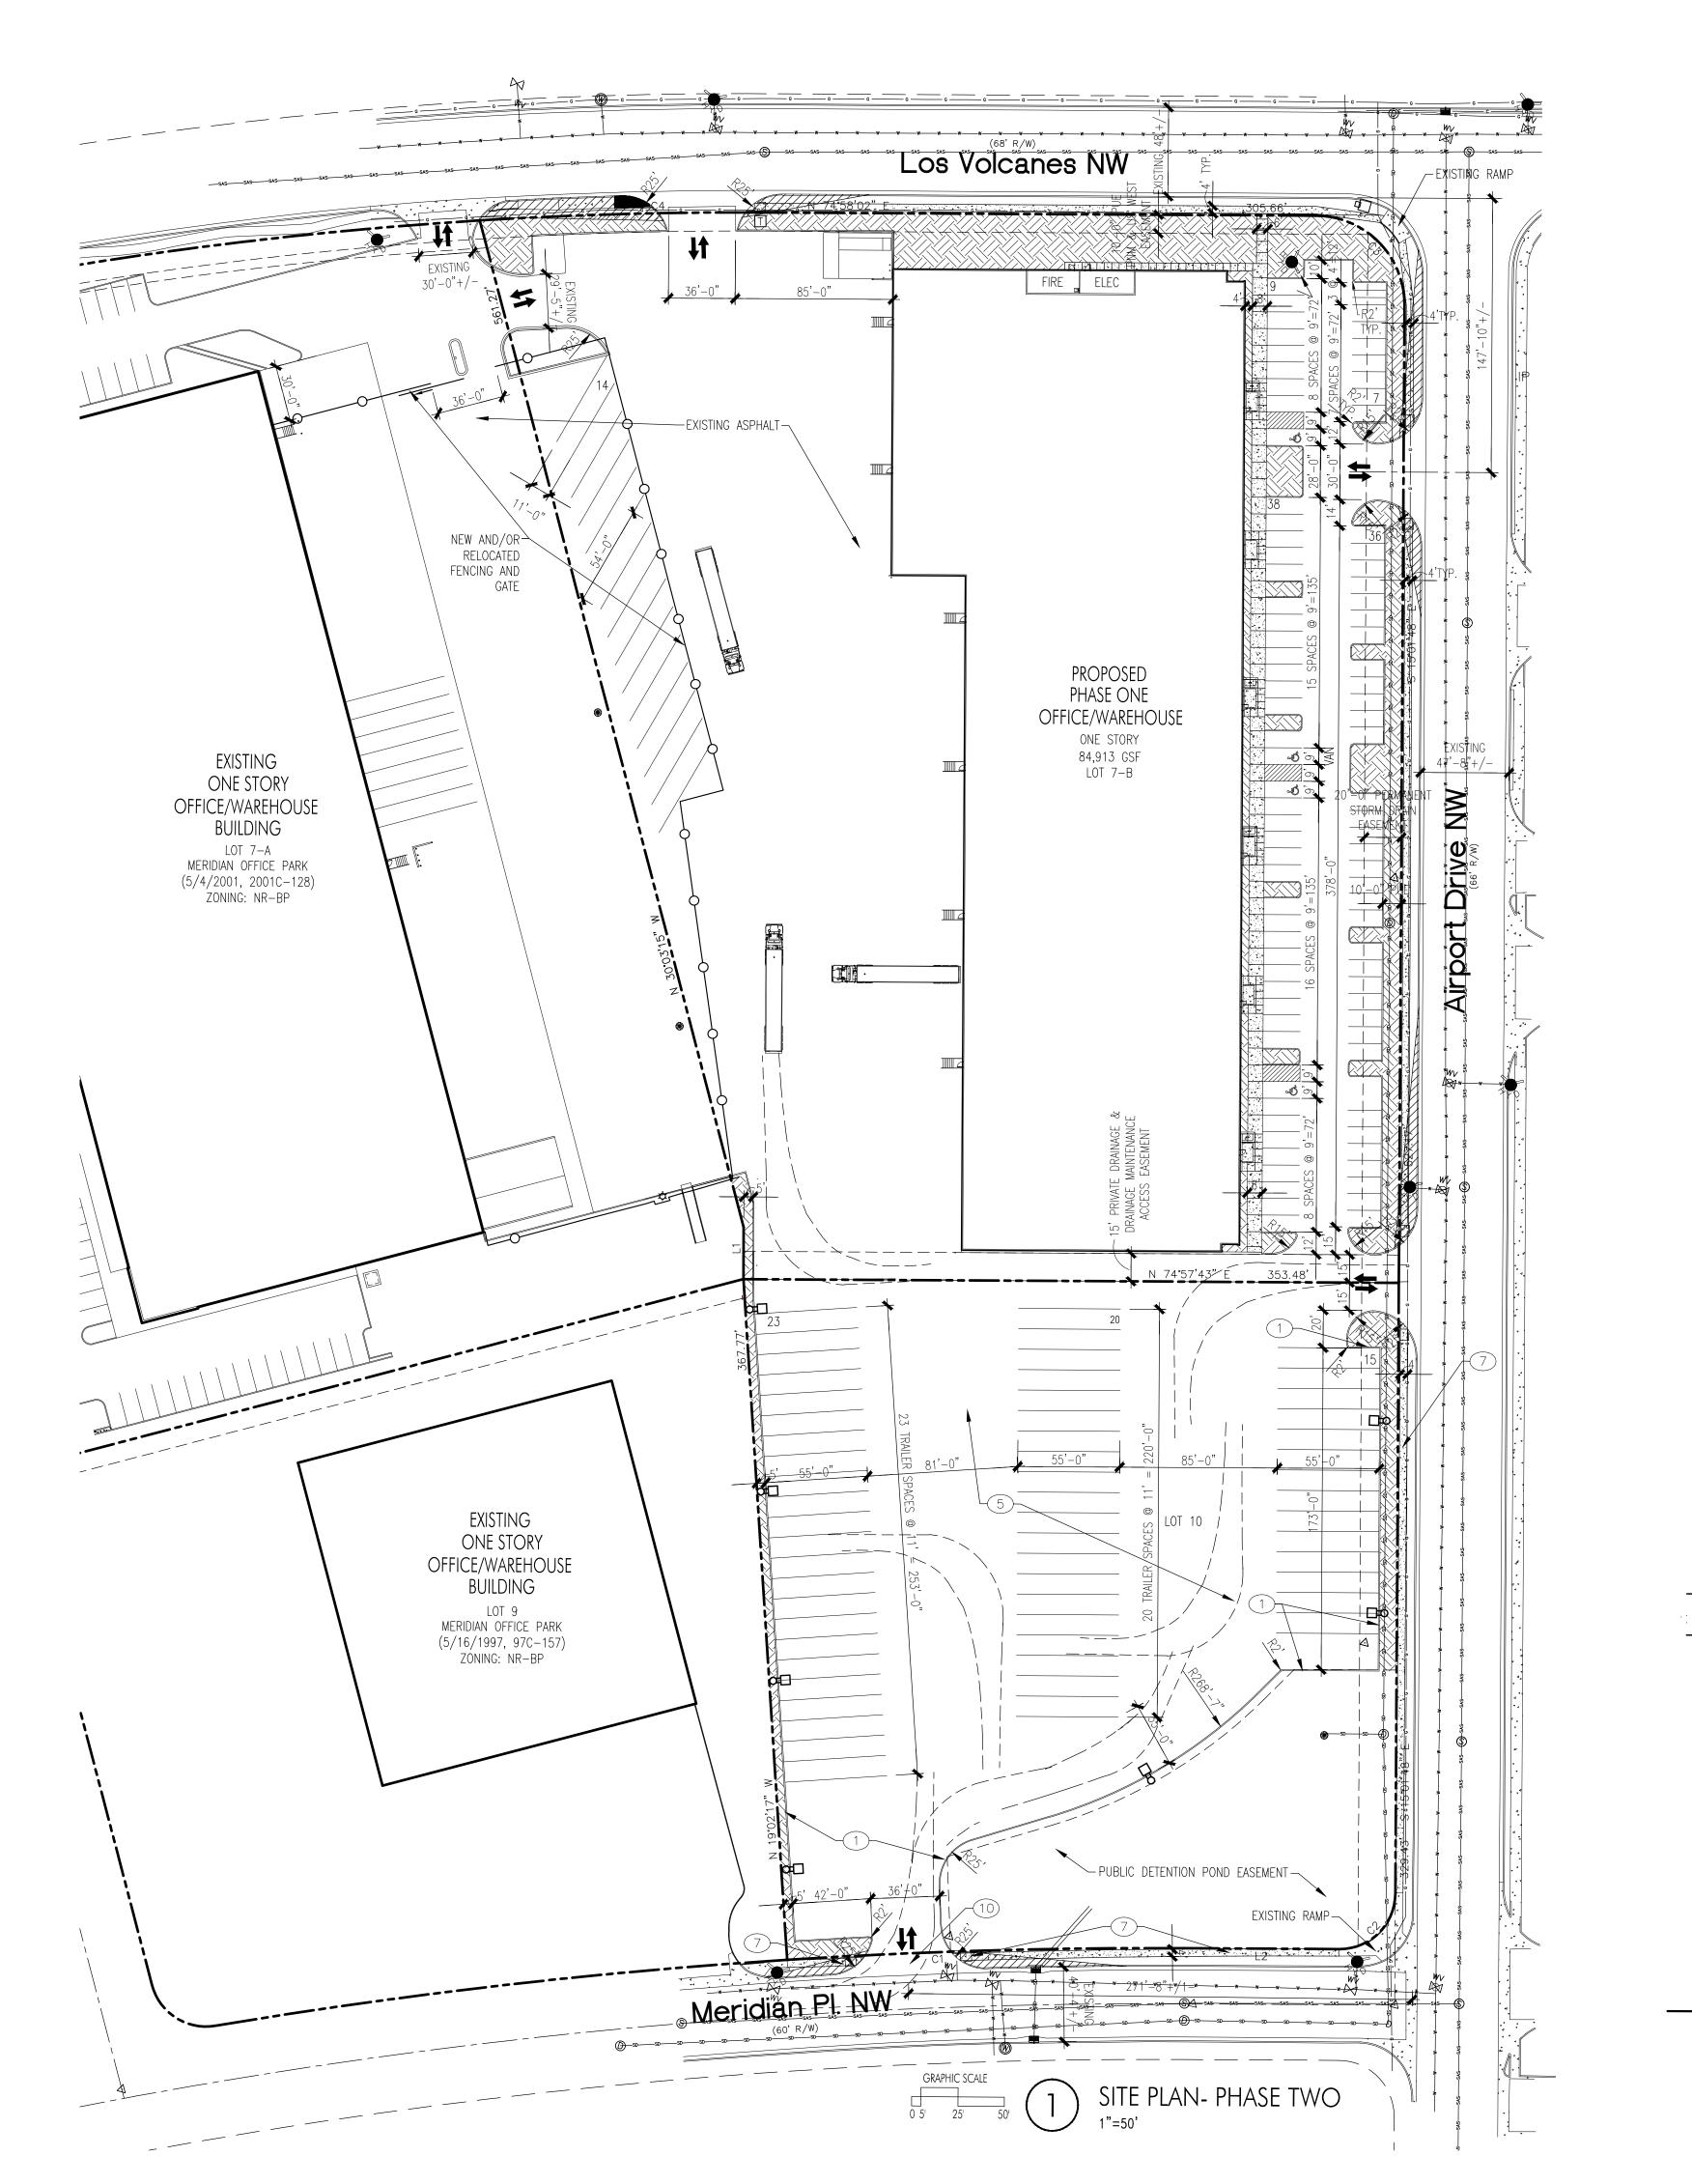

CURVE TABLE

NUMBER	LENGTH	CHORD RADIUS	DELTA	CHORD LENGTH	CHORD DIRECTION
C1	213.94'	3063.83'	4°00'03"	213.90"	S 72°57'53" W
C2	47.12'	30.00'	89°59'37"	213.90"	S 29°58'01" W
C3	75.40'	48.00'	90°00'11"	213.90"	S 60°01'53" E
C4	145.45'	2257.83	3°41'27"	213.90"	N 72°56'11" E

LINE TABLE

NUMBER	DIRECTION	LENGTH
L1	N 15°02'53" W	27.96'
L2	S 74°57'50" W	84.01'

GENERAL NOTES

- 1. ALL SITE LIGHTING SHALL COMPLY WITH IDO SECTION 14-16-5-8. OUTDOOR AND SITE LIGHTING.
- 2. PLACEMENT OF FIXTURES & STANDARDS SHALL CONFORM TO STATE & LOCAL SAFETY & ILLUMINATION REQUIREMENTS.
- 3. ALL LIGHT FIXTURES SHALL BE FULLY SHIELDED HORIZONTAL LAMPS WITH NO LIGHT, LENS OR BULB PROTRUDING BELOW THE BOTTOM OF THE CUT-OFF FIXTURE IN ORDER THAT NO FUGITIVE LIGHT SHALL ESCAPE BEYOND THE PROPERTY LINE AND NO SITE LIGHTING LIGHT SOURCE SHALL BE VISIBLE FRO THE SITE PERIMETER.
- FROM THE PUBLIC VIEW BY MATERIALS OF THE SAME NATURE AS THE BUILDINGS BASIC MATERIALS. THE TOP OF ALL ROOFTOP EQUIPMENT SHALL BE BELOW THE TOP OF THE PARAPET OR SCREENED FROM VIEW FROM PUBLIC RIGHTS-OF-WAY AND THE SITE ACCESS EASEMENT. 5. SITE HANDICAP RAMPS SHALL BE BUILT BY COA STANDARD DRAWING

4. ROOF TOP AND GROUND MOUNTED EQUIPMENT SHALL BE SCREENED

- 6. ALL ADA CURB RAMPS WITHIN THE PUBLIC ROW SHALL BE UPDATED
- TO CURRENT STANDARDS AND HAVE TRUNCATED DOMES INSTALLED. 7. ALL BROKEN OR CRACKED SIDEWALK MUST BE REPLACED WITH SIDEWALK AND CURB & GUTTER.

KEYED NOTES

- (1) CONCRETE CURB, REFER DETAIL 3/SDP-2
- 2 NOT USED
- (3) NOT USED

- LANDSCAPING

EXTRUDED CURB DETAIL

____ MACHINE EXTRUDED CONC.

CURB BONDED TO PAVING W/ TOOLED JT @ 5'-0" O.C.

- 4 NOT USED
- (5) 2" ASPHALT PAVING OVER 4" BASE COURSE (6) NOT USED
- 7) SIDEWALK & RAMPS PER COA STD DWG 2430 & 2411
- (8) NOT USED
- (9) NOT USED
- (10) NEW ENTRANCE DRIVE PER COA STD DWG 2426
- (11) NOT USED
- 12 NOT USED

LEGEND

————— EASEMENT LINE

LANDSCAPED AREA

FIRE HYDRANT

25' WHITE PARKING LOT POLE W/ (3) 100 WATT LED FIXTURE HEADS

HANDICAP PARKING PAVEMENT MARKING

SITE DISTANCE AND SITE TRIANGLE BASED ON COA DPM
7-5(I)(5)(iii) and 7-5(i)(5)(iv), LANDSCAPING AND SIGNAGE
WILL NOT INTERFERE WITH CLEAR SIGHT REQUIREMENTS,
THEREFORE SIGNS, WALLS, TREES, AND SHRUBBERY BETWEEN 3 AND 8 FEET TALL (AS MEASURED FROM THE GUTTER PAN) WILL NOT BE ACCEPTABLE IN THE CLEAR SITE



ARCHITECT SEAL TATE FISHBURN


PROJECT


REVISIONS


MAY 2022 1"=50'-0" OR AS NOTED

DRAWING NAME SITE DEVELOPMENT PLAN PHASE TWO

SHEET NUMBER

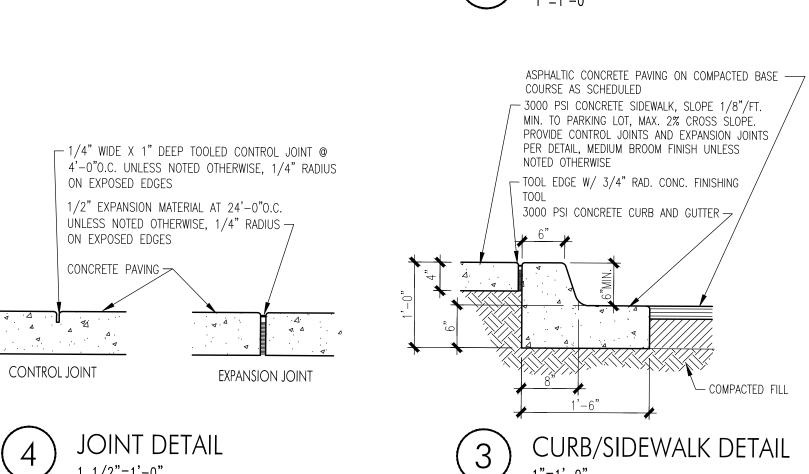

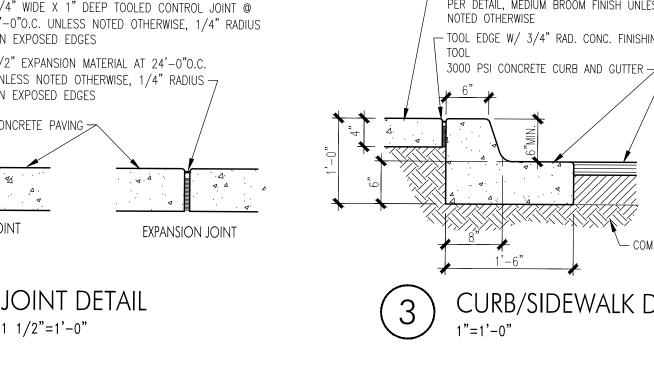

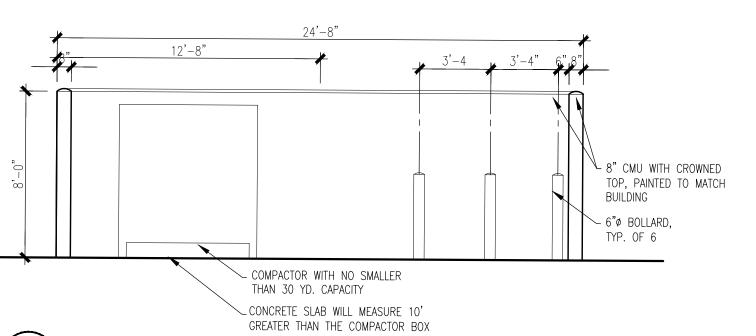

REFUSE SCREEN WALL ELEVATION