
## CITY OF ALBUQUERQUE

Planning Department Alan Varela, Director

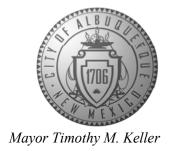

March 1, 2023

Ryan Morrissey, P.E. Burkhardt Engineering 28 North Cherry St. Germantown, OH, 45327

**RE:** Champion Xpress Car Wash

211 Unser Blvd. SW

**Grading and Drainage Plan** 

Engineer's Stamp Date: 2/23/2023

Hydrology File: K10D064

Dear Mr. Morrisey:

Based upon the information provided in your submittal received 2/24/2023, the Grading & Drainage Plan is approved for Building Permit approval. Please attach a copy of this approved plan in the construction sets for Building Permit processing along with a copy of this letter.

## PRIOR TO CERTIFICATE OF OCCUPANCY:

Albuquerque

PO Box 1293

1. Engineer's Certification, per the DPM Part 6-14 (F): *Engineer's Certification Checklist For Non-Subdivision* is required.

NM 87103

2. Please provide the executed paper Drainage Covenant (latest revision) printed on one-side only with Exhibit A and a check for \$25 made out to "Bernalillo County" for the stormwater quality ponds per Article 6-15(C) of the DPM to Hydrology for review. Once the review is done, Hydrology will send back an email stating our approval/comments.

www.cabq.gov

As a reminder, if the project total area of disturbance (including the staging area and any work within the adjacent Right-of-Way) is 1 acre or more, then an Erosion and Sediment Control (ESC) Plan and Owner's certified Notice of Intent (NOI) is required to be submitted to the Stormwater Quality Engineer (Doug Hughes, PE, jhughes@cabq.gov, 505-924-3420) 14 days prior to any earth disturbance.

If you have any questions, please contact me at 505-924-3695 or tchen@cabq.gov.

Sincerely,

Tiequan Chen, P.E.

Principal Engineer, Hydrology

Tieque Cha

Planning Department, Development Review Services




## City of Albuquerque

## Planning Department

Development & Building Services Division

DRAINAGE AND TRANSPORTATION INFORMATION SHEET (REV 6/2018)

Project Title: Champion Xpress Car Wash	_Building Permit #:	Hydrology File #: K10D064
DRB#:	_ EPC#:	Work Order#:
Legal Description: Tract 10 Unser Crossing		
City Address: 211 Unser Blvd SW		
Applicant: VIA Real Estate LLC		Contact: Derrick Merchant
Address: 13105 Dover Avenue, Lubbock, T	X 79424	
Phone#: 806-368-7843	_ Fax#:	E-mail: development@7bdev.com
Other Contact: Burkhardt Engineering		Contact: Ryan Martini
Address: 28 North Cherry Street Germanto	wn, OH 45327	
Phone#: 937-388-0060	_ Fax#:	E-mail: rmartini@burkhardtinc.cor
TYPE OF DEVELOPMENT: PLAT	(# of lots) RESIDENCE	DRB SITE X ADMIN SITE
IS THIS A RESUBMITTAL? X Yes	No	
<b>DEPARTMENT</b> TRANSPORTATION	X HYDROLOGY/DRAIN	NAGE
Check all that Apply:		PPROVAL/ACCEPTANCE SOUGHT:
TYPE OF SUBMITTAL:		NG PERMIT APPROVAL ICATE OF OCCUPANCY
ENGINEER/ARCHITECT CERTIFICATIO	NEERTH	ICATE OF OCCUPANCE
PAD CERTIFICATION	PDEI IN	IINARY PLAT APPROVAL
CONCEPTUAL G & D PLAN		LAN FOR SUB'D APPROVAL
X GRADING PLAN		AN FOR BLDG. PERMIT APPROVAL
DRAINAGE REPORT		PLAT APPROVAL
DRAINAGE MASTER PLAN	FINAL	PLAT APPROVAL
FLOODPLAIN DEVELOPMENT PERMIT	APPLIC SIA/DE	LEASE OF FINANCIAL GUARANTEE
ELEVATION CERTIFICATE	SIA/ KE	ATION PERMIT APPROVAL
CLOMR/LOMR		NG PERMIT APPROVAL
TRAFFIC CIRCULATION LAYOUT (TCL	) SO-19 A	
TRAFFIC IMPACT STUDY (TIS)		G PERMIT APPROVAL
STREET LIGHT LAYOUT		NG/ PAD CERTIFICATION
OTHER (SPECIFY)		ORDER APPROVAL
PRE-DESIGN MEETING?	WORK C	
		PLAIN DEVELOPMENT PERMIT
		(SPECIFY)
	OTHER	(SFECIFI)
DATE SUBMITTED: February 24, 2023	By: <u>Ryan Martini</u>	
COA STAFF:	ELECTRONIC SUBMITTAL RECEIV	/ED:
	FEE PAID:	

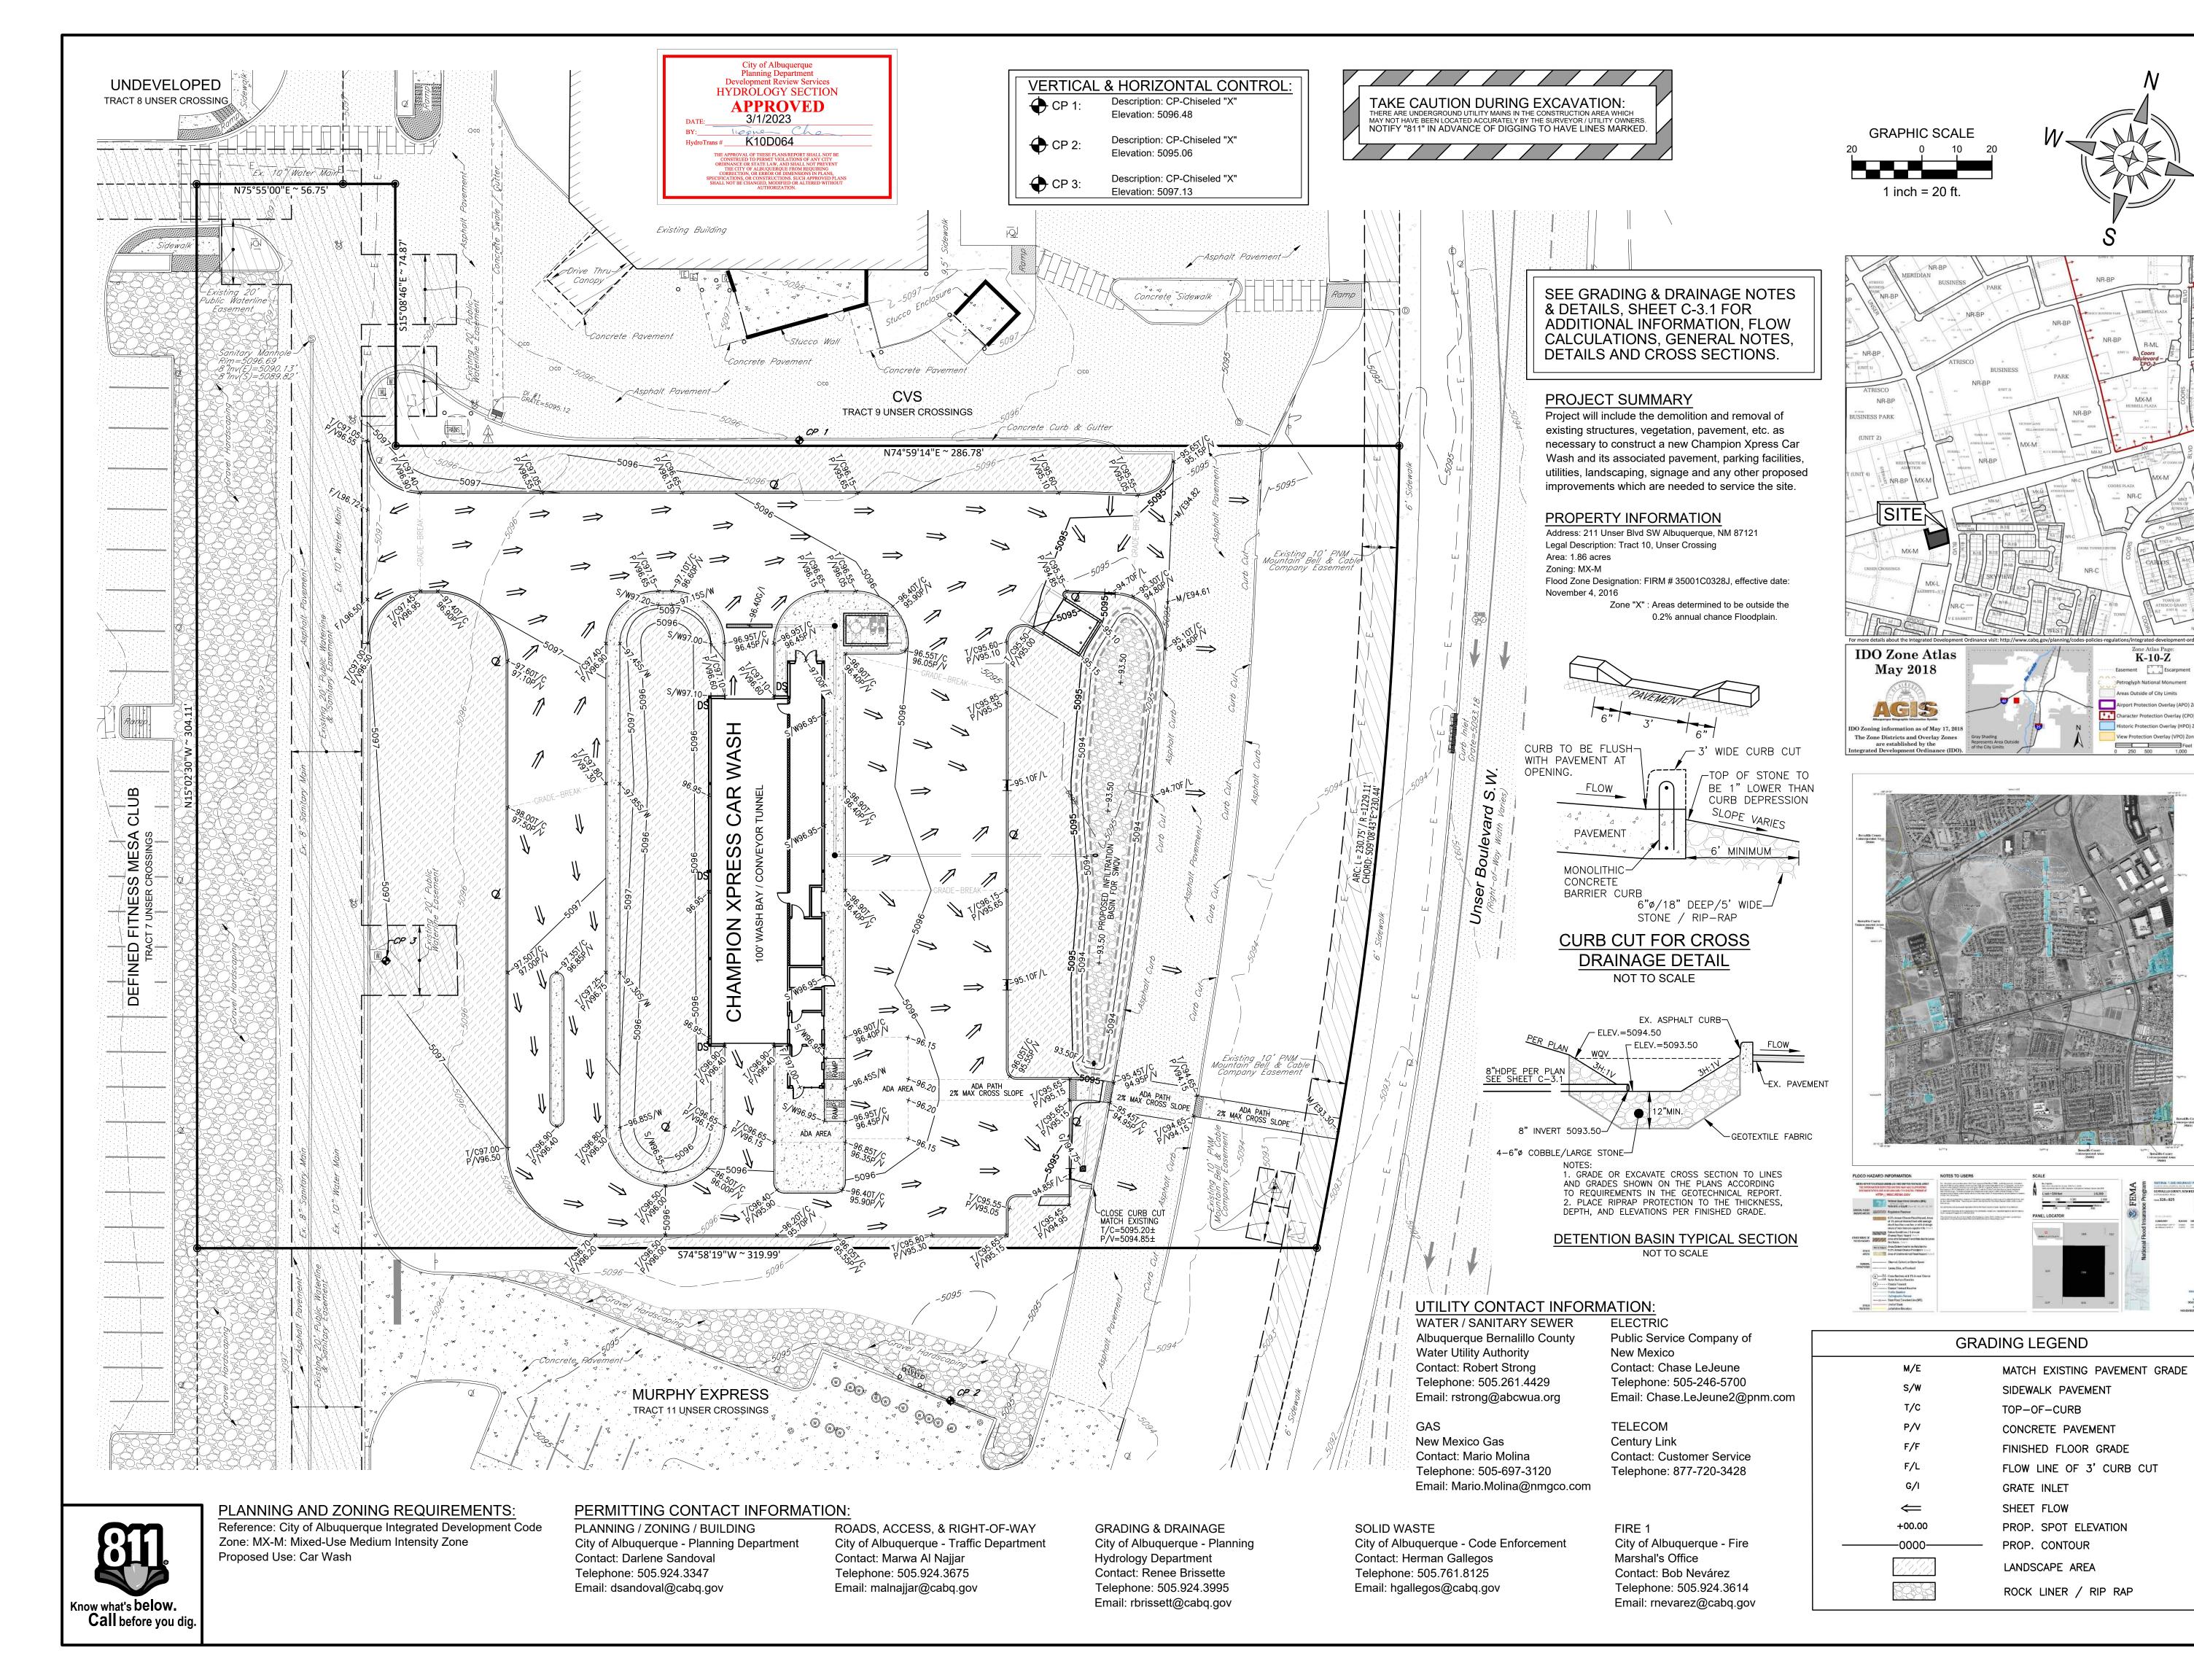



K-10-Z

Areas Outside of City Limits

Feet 1,000

0 500 1,000 2,000 0 125 250 500

COMMUNEY BUSINESS PAND SAFEE

WESTER HIVEEN
2.3.3.2
WAS INVESTED
35001CD 3281
NAV BUSEN
NOVEMBER 4, 2018



Design: RJM Proj: 22.146


Draw: RMM Dwg: 22-146.dwg Check: RJM Tab: C3.0-GP Scale: 1" = 20'

01.16.2023

**GRADING &** DRAINAGE PLAN

Sheet No.:

C - 3.0

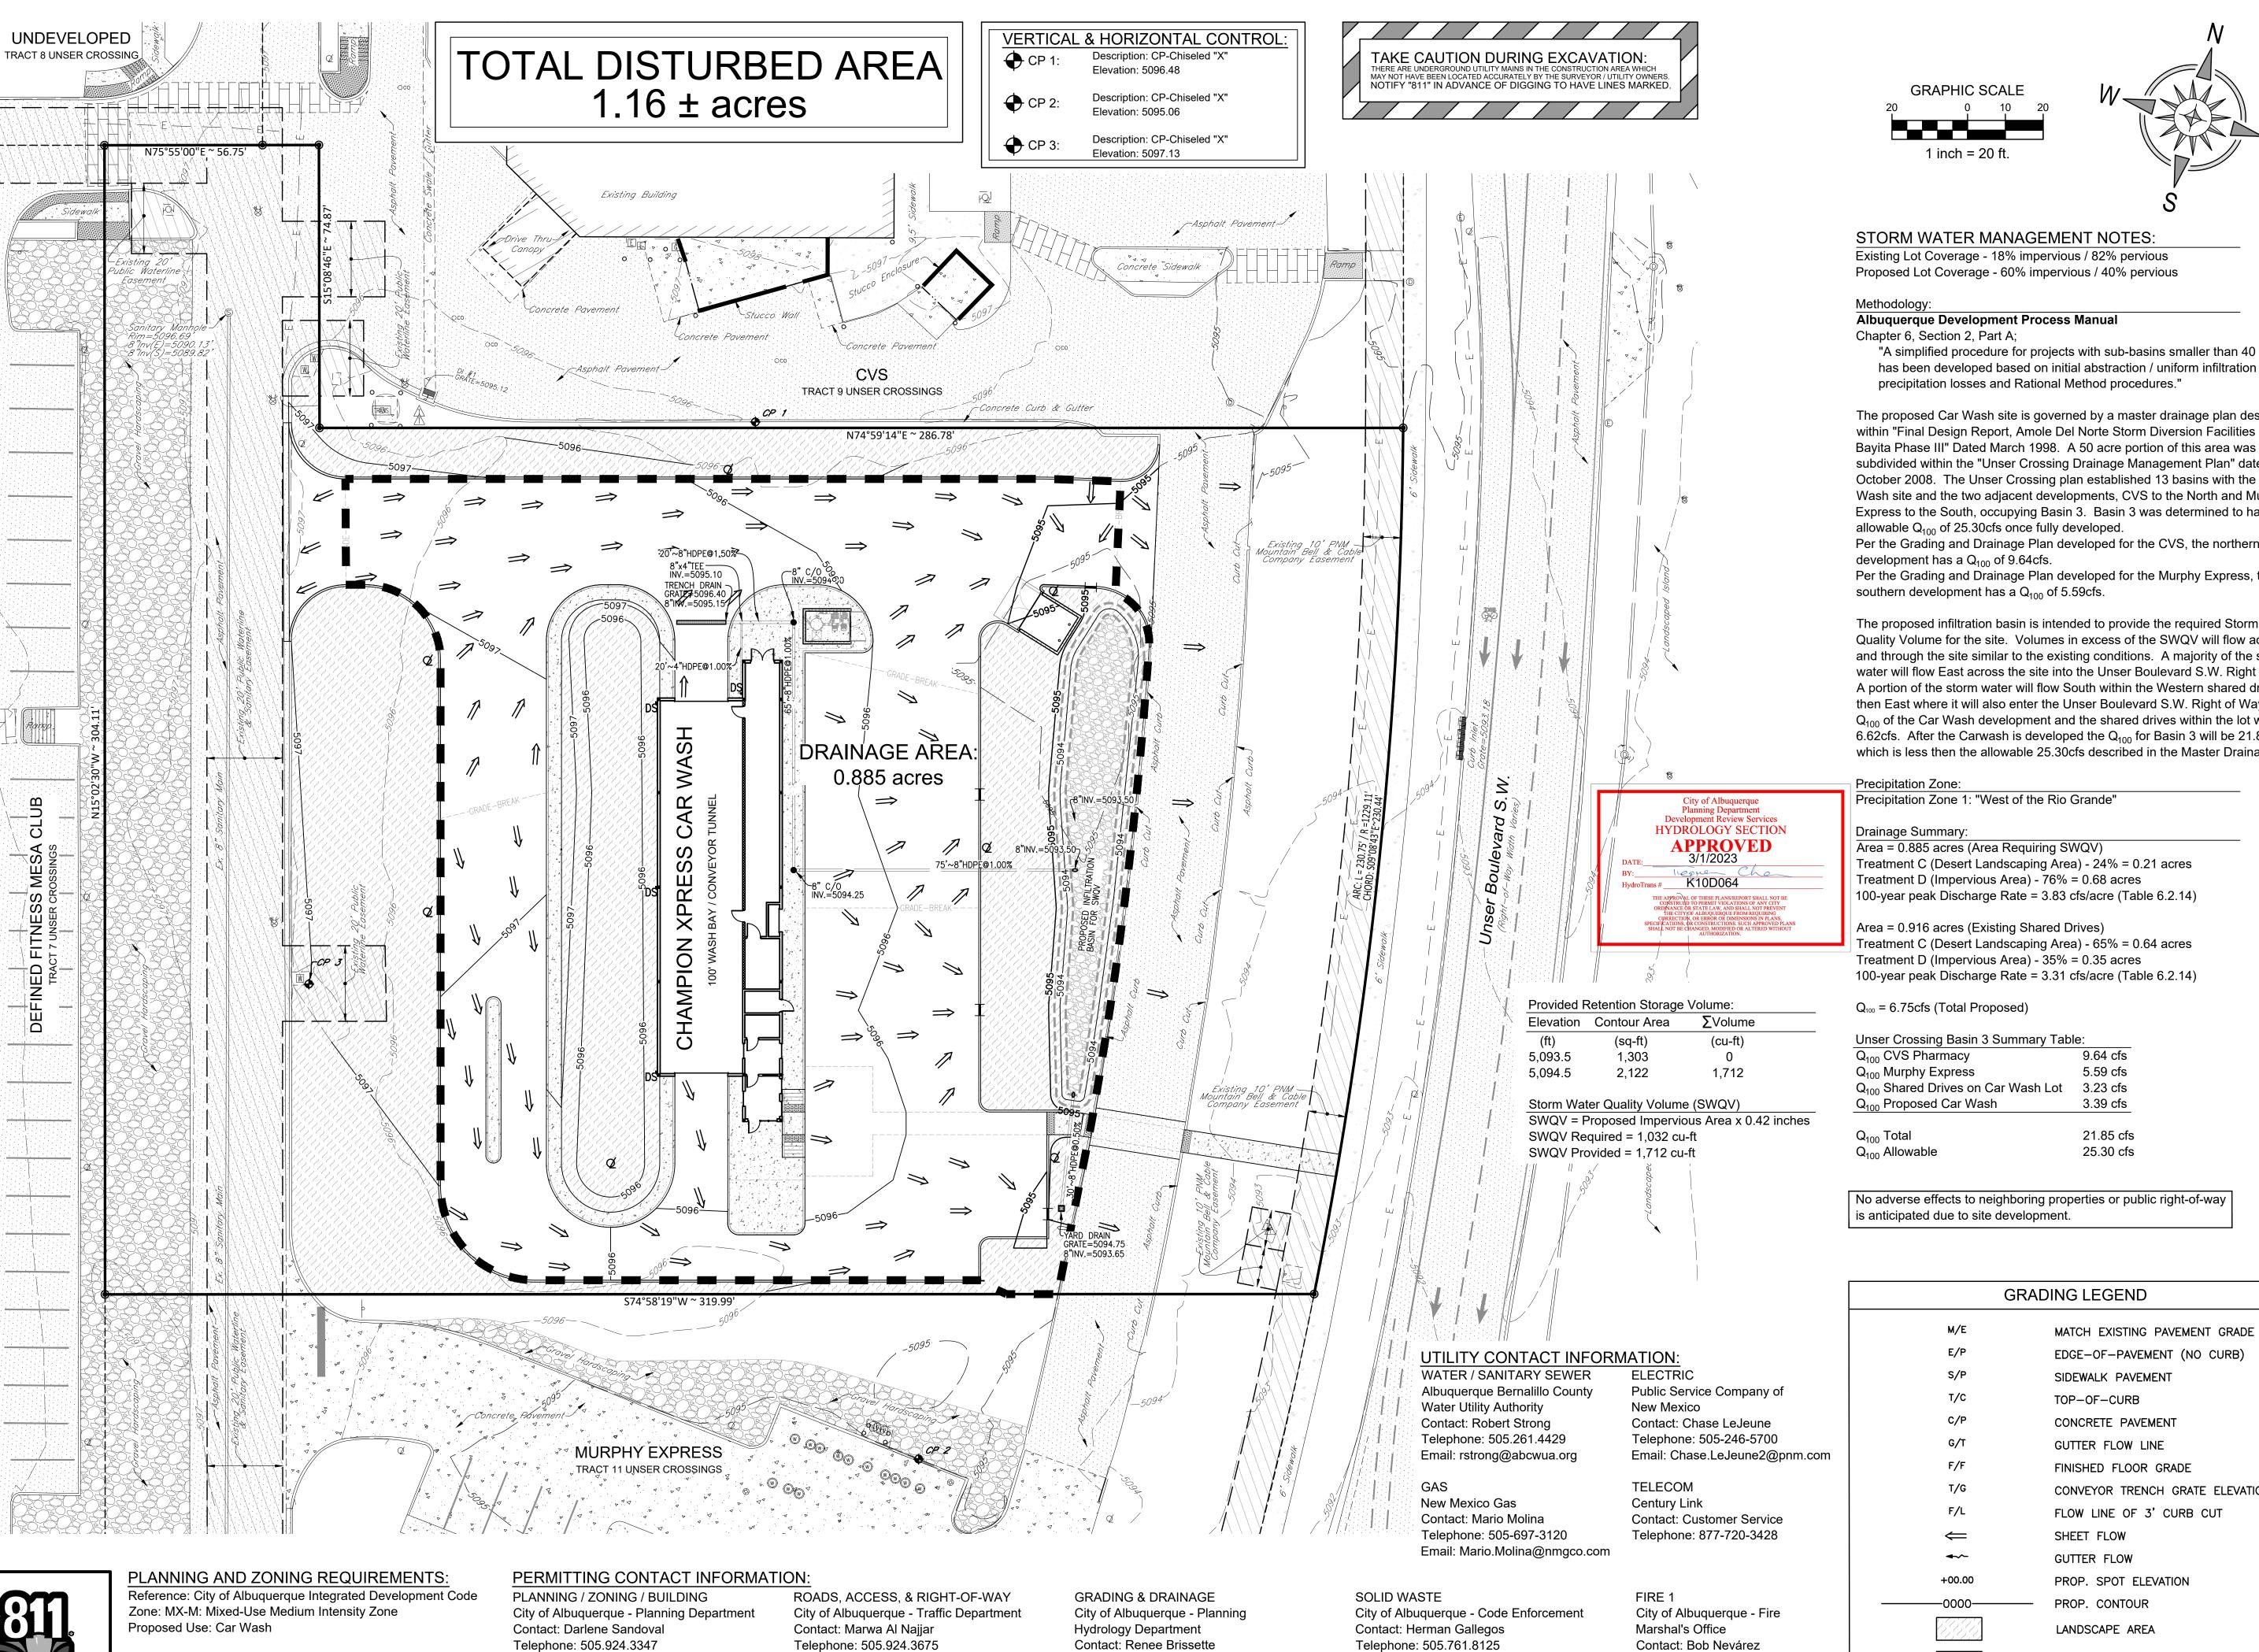

Telephone: 505.924.3995


Email: rbrissett@cabq.gov

Email: dsandoval@cabq.gov

Know what's below.

Call before you dig.

Email: malnajjar@cabq.gov

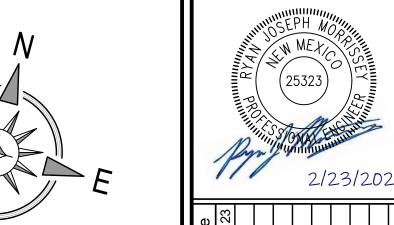

STORM WATER MANAGEMENT NOTES:

Existing Lot Coverage - 18% impervious / 82% pervious Proposed Lot Coverage - 60% impervious / 40% pervious

**Albuquerque Development Process Manual** 

"A simplified procedure for projects with sub-basins smaller than 40 acres has been developed based on initial abstraction / uniform infiltration precipitation losses and Rational Method procedures."

The proposed Car Wash site is governed by a master drainage plan described within "Final Design Report, Amole Del Norte Storm Diversion Facilities Tierra Bayita Phase III" Dated March 1998. A 50 acre portion of this area was further subdivided within the "Unser Crossing Drainage Management Plan" dated October 2008. The Unser Crossing plan established 13 basins with the Car Wash site and the two adjacent developments, CVS to the North and Murphy Express to the South, occupying Basin 3. Basin 3 was determined to have an allowable Q<sub>100</sub> of 25.30cfs once fully developed.

Per the Grading and Drainage Plan developed for the CVS, the northern

Per the Grading and Drainage Plan developed for the Murphy Express, the

The proposed infiltration basin is intended to provide the required Storm Water Quality Volume for the site. Volumes in excess of the SWQV will flow across and through the site similar to the existing conditions. A majority of the storm water will flow East across the site into the Unser Boulevard S.W. Right of Way. A portion of the storm water will flow South within the Western shared drive and then East where it will also enter the Unser Boulevard S.W. Right of Way. The Q<sub>100</sub> of the Car Wash development and the shared drives within the lot will be 6.62cfs. After the Carwash is developed the  $Q_{100}$  for Basin 3 will be 21.85cfs which is less then the allowable 25.30cfs described in the Master Drainage Plan.

Precipitation Zone 1: "West of the Rio Grande"

Treatment C (Desert Landscaping Area) - 24% = 0.21 acres Treatment D (Impervious Area) - 76% = 0.68 acres 100-year peak Discharge Rate = 3.83 cfs/acre (Table 6.2.14)

Treatment C (Desert Landscaping Area) - 65% = 0.64 acres Treatment D (Impervious Area) - 35% = 0.35 acres 100-year peak Discharge Rate = 3.31 cfs/acre (Table 6.2.14)

9.64 cfs 5.59 cfs

3.39 cfs 21.85 cfs

No adverse effects to neighboring properties or public right-of-way

**GRADING LEGEND** 

EDGE-OF-PAVEMENT (NO CURB) SIDEWALK PAVEMENT TOP-OF-CURB CONCRETE PAVEMENT GUTTER FLOW LINE FINISHED FLOOR GRADE CONVEYOR TRENCH GRATE ELEVATION

SHEET FLOW **GUTTER FLOW** 

PROP. SPOT ELEVATION PROP. CONTOUR LANDSCAPE AREA

Telephone: 505.924.3614

Email: rnevarez@cabq.gov

Email: hgallegos@cabq.gov

ROCK LINER / RIP-RAP

C-3.

Design: RJM Proj: 22.146

Draw: RMM Dwg: 22-146.dwg

01.16.2023

**GRADING &** 

DRAINAGE DETAILS

Check: RJM Tab: C3.1-GD

Scale: 1" = 20'

Sheet No.: