

City of Albuquerque

P.O. BOX 1293 ALBUQUERQUE, NEW MEXICO 87103

January 3, 1995

J. Arsenio Martinez Rodriguez Development Consultant 12800 San Juan NE Albuquerque, NM 87123

RE: DRAINAGE PLAN FOR AN ADDITION TO 514 COORS SW MARKET BUILDING & AUTO FUELING FACILITY (K11-D49) ENGINEER'S STAMP DATED 12/22/94.

Dear Mr. Martinez:

Based on the information provided on your December 27, 1994 submittal, the above referenced site is approved for Building Permit.

Please attach a copy of this approved plan to the construction sets prior to sign-off by Hydrology.

If I can be of further assistance, please feel free to contact me at 768-2667.

Sincerely,


Bernie J. Montoya, CE Engineering Associate

BJM/dl

c: Andrew Garcia File

DRAINAGE INFORMATION SHEET

PROJECT TITLE: 514 COORS BLYD. S.W. ZON	NE ATLAS/DRNG. FILE #: <u>K-//-Z/0</u> 49		
DRB #: EPC #:	WORK ORDER #:		
LEGAL DESCRIPTION: 4075 87, 88, 89 \$ 5'2	LY TO OFLOT GO, RIDGRANDE HEIGH		
CITY ADDRESS: 514 COORS BLVD. S.W.			
シデンティー かんパンファイン	CONTACT: MR. MARTINEZ CONTACT: MR. RODRIGUEZ		
ADDRESS: 12800 SAN JUAN N.E. 8712.	3 PHONE: 294-0370		
OWNER: MIHAI SPILCA	CONTACT: MR. SPILCA		
ADDRESS: 5/4 COORS BLVD, SIW.	PHONE:		
ARCHITECT:	CONTACT:		
ADDRESS:	PHONE:		
SURVEYOR: TORRES SURVEYING CO-	CONTACT: MR. JIM TORRES		
ADDRESS: 1570 BRIDGE BLYD. S.W.	PHONE: <u>856-8898</u>		
CONTRACTOR: SUN-DOR CONST. CO.	CONTACT: MANUEL BARRAZA		
ADDRESS: 2	PHONE: 836-4613		
TYPE OF SUBMITTAL: CHEC	K TYPE OF APPROVAL SOUGHT:		
DRAINAGE REPORT	SKETCH PLAT APPROVAL		
DRAINAGE PLAN	PRELIMINARY PLAT APPROVAL		
CONCEPTUAL GRADING & DRAINAGE PLAN	S. DEV. PLAN FOR SUB'D. APPROVAL		
GRADING PLAN	S. DEV. PLAN FOR BLDG. PERMIT APPROVAL		
EROSION CONTROL PLAN	SECTOR PLAN APPROVAL		
ENGINEER'S CERTIFICATION	FINAL PLAT APPROVAL		
OTHER	FOUNDATION PERMIT APPROVAL		
	BUILDING PERMIT APPROVAL		
PRE-DESIGN MEETING:	CERTIFICATE OF OCCUPANCY APPROVAL		
YES	GRADING PERMIT APPROVAL		
	- PAVING PERMIT APPROVAL		
	S.A.D. DRAINAGE REPORT		
	DRAINAGE REQUIREMENTS		
	•		
	OTHER(SPECIFY)		
DATE SUBMITTED: 12-22-94			
CHART T PONDICUES	— DEG 2.7 1994		

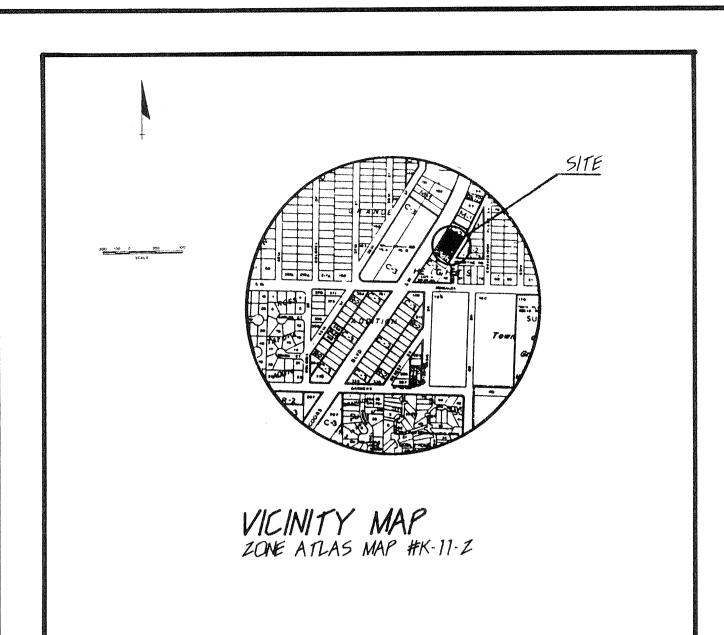

EROSION CONTROL MEASURES:

SCALE: 1"= 20'

- THE CONTRACTOR SHALL BE HELD RESPONSIBLE FOR MANAGEMENT FOR STORM RUN-OFF DURING CONSTRUCTION; HE SHALL INSURE THAT THE FOLLOWING MEASURES ARE TAKEN:
- 1.) ADJACENT PROPERTY SHALL BE PROTECTED AT ALL TIMES BY CONSTRUCTION OF BERMS, DIKES, SWALES, PONDS, AND OTHER TEMPORARY GRADING AS REQUIRED TO PREVENT STORM RUNOFF FROM LEAVING THE SITE AND ENTERING ADJACENT PROPERTIES.
- 2.) ADJACENT PUBLIC RIGHT-OF-WAYS SHALL BE PROTECTED AT ALL TIMES FROM STORM WATER RUNOFF FROM THE SITE. NO SEDIMENT BEARING WATER SHALL BE PERMITTED TO ENTER PUBLIC STREETS.
- 3.) THE CONTRACTOR SHALL IMMEDIATELY AND THROUGHLY REMOVE ANY AND ALL SEDIMENT WITHIN PUBLIC STREETS THAT HAS BEEN ERODED FROM THE SITE AND DEPOSITED THERE.

16W 5 HIGH

CMU WHILL

NEW 4' HIGH CHAIN

16W COK CURB

CONSTRUCTION NOTES:

- 1.) TWO (2) WORKING DAYS PRIOR TO ANY EXCAVATION, CONTRACTOR MUST CONTACT LINE LOCATING SERVICE AT 765-1234 FOR LOCATION OF EXISTING UTILITIES.
- 2.) PRIOR TO CONSTRUCTION, THE CONTRACTOR SHALL EXCAVATE AND VERIFY THE HORIZONTAL AND VERTICAL LOCATION OF ALL POTENTIAL OBSTRUCTIONS; SHOULD A CONFLICT EXIST, THE CONTRACTOR SHALL NOTIFY THE ENGINEER SO THAT THE CONFLICT CAN BE RESOLVED WITH A MINIMUM OF DELAY.
- 3.) ALL WORK ON THIS PROJECT SHALL BE PERFORMED IN ACCORDANCE WITH APPLICABLE FEDERAL, STATE, AND LOCAL LAWS, RULES AND REGULATIONS CONCERNING CONSTRUCTION SAFETY AND HEALTH.
- 4.) ALL CONSTRUCTION WITHIN CITY RIGHT-OF-WAY SHALL BE PERFORMED IN ACCORDANCE WITH APPLICABLE CITY OF ALBUQUERQUE STANDARDS AND PRO-


NEW 6 HIGH

TSEE ENLARGEMENT "X"

A.1 PRECIPITATION ZONES

Bernalillo County's four precipitation zones are indicated in TABLE A-1 and on FIGURE A-1.

TABLE A-1. PRECIPITATION ZONES	
Zone	Location
(1)	West of the Rio Grande
2	Between the Rio Grande and San Mateo
3	Between San Mateo and Eubank, North of Interstate 40; and between San Mateo and the East boundary of Range 4 East, South of Interstate 40
4	East of Eubank, North of Interstate 40; and East of the East boundary of Range 4 East, South of Interstate 40

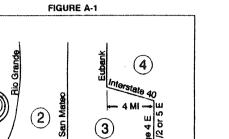

Where a watershed extends across zone boundary, use the zone which contains the largest portion of the watershed.

DPM SECTION 22.2 - HYDROLOGY January, 1993 Page A-4

TABLE A-4. LAND TREATMENTS		
Treatment	Land Condition	
A	Soil uncompacted by human activity with 0 to 10 percent slopes. Native grasses, weeds and shrubs in typical densities with minimal disturbance to grading, groundcover and infiltration capacity. Croplands. Unlined arroyos.	
В	Irrigated lawns, parks and golf courses with 0 to 10 percent slopes. Native grasses, weeds and shrubs, and soil uncompacted by human activity with slopes greater than 10 percent and less than 20 percent	
С	Soil compacted by human activity. Minimal vegetation. Unpaved parking, roads, trails. Most vacant lots. Gravel or rock on plastic (desert landscaping). Irrigated lawns and parks with slopes greater than 10 percent. Native grasses, weeds and shrubs, and soil uncompacted by human activity with slopes at 20 percent or greater. Native grass, weed and shrub areas with clay or clay loam soils and other soils of very low permeability as classified by SCS Hydrologic Soil Group D.	
***************************************	Impervious areas, pavement and roofs.	

treatments, measure respective subareas. In lieu of specific measurement for treatment D, the areal percentages in TABLE A-5 may be employed.

NOTE: CONTRACTOR TO PROVIDE WATERPROOF (PLASTIC) MEMBRANE ALONG NEW ADD-ITION FOUNDATION FOR MOISTURE PROTECTION FROM PONDING AREA.

ORAINAGE CALCULATIONS

REFERENCES:

- A. CITY OF ALBUQUERQUE DEVELOPMENT PROCESS MANUAL (DPM) VOL. 2 DESIGN CRITERIA, CHAPTER 22: DRAINAGE, FLOOD CONTROL, AND EROSION CONTROL.
- B. SOIL SURVEY OF BERNALILLO COUNTY AND PARTS OF SANDOVAL AND VALENICA COUNTIES, NEW MEXICO, UNITED STATES DEPT. OF AGRICULTURAL, SOIL CONSERVATION SERVICE.
- C. FLOODWAY, FLOOD BOUNDARY AND FLOODWAY MAP, CITY OF ALBUQUERQUE, NEW MEXICO, PANEL 27 OF 50.
- D. ZONE ATLAS PAGE K-11-Z.

II. GENERAL INFORMATION:


A. SOIL TYPE (REF. B, SHEET NO. 30) SOIL TYPE IS MADUREZ-WINK ASSOCIATION (MWA), HYDROLOGIC SOIL GROUP "B".

DRAINAGE COMMENTS:

AS SHOWN ON THE VICINITY MAP HEREON, THE SUBJECT SITE IS LOCATED ON THE EAST SIDE OF COORS ROAD S.W. BETWEEN CENTRAL AVENUE AND GONZALES ROAD S.W., IN THE CITY OF ALBUQUERQUE, BERNALILLO COUNTY, NEW MEXICO.

THE PROPOSED PLAN IS FOR A PROPOSED BUILDING ADDITION TO AN EXISTING SER-VICE STATION AND MARKET FACILITY LOCATED AT 514 COORS BLVD. S.W.; THE ADDITIONAL AREA OF 628.0 SQUARE FEET WILL GENERATE AN ADDITIONAL VOLUME OF 103.6 CU. FT. THAT WILL BE DIRECTED TO THE EXISTING POND THAT HAS SUFFICIENT CAPACITY FOR THE DEVELOPED PROJECT SITE AND PROPOSED IMPROVEMENTS, (ANY OVERFLOW FROM SAID EXISTING POND WILL SPILL INTO THE EXISTING PAVED PARKING AREA).

CALCULATION: $\frac{2.20}{12}$ x 628.0 x 0.90 = $\frac{103.6}{12}$ CU. FT. ADDITIONAL VOLUME GENERATED

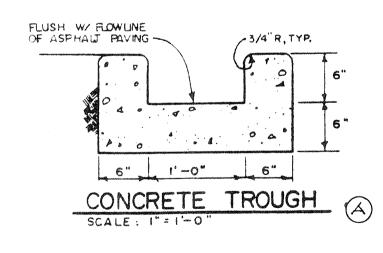

PAVING

- NEW BHIGH CMV WHILL


LEGAL DESCRIPTIONS

FERCE OF HOLICE - PRINTE

LOTS EIGHTY-SEVEN (87), EIGHTY-EIGHT (88), EIGHTY-NINE (89), AND THE SOUTH TWENTY FEET (20°) OF LOT NINETY (90) OF RIO GRANDE HEIGHTS , AN ADDITION TO THE CITY OF ALBU-QUERQUE, NEW MEXICO

CMU W'


TEMPORARY BENCHMARK IS NAIL SET IN SOUTHWEST QUADRANT OF POWER POLE, APPROXIMATELY 3" ABOVE GRADE

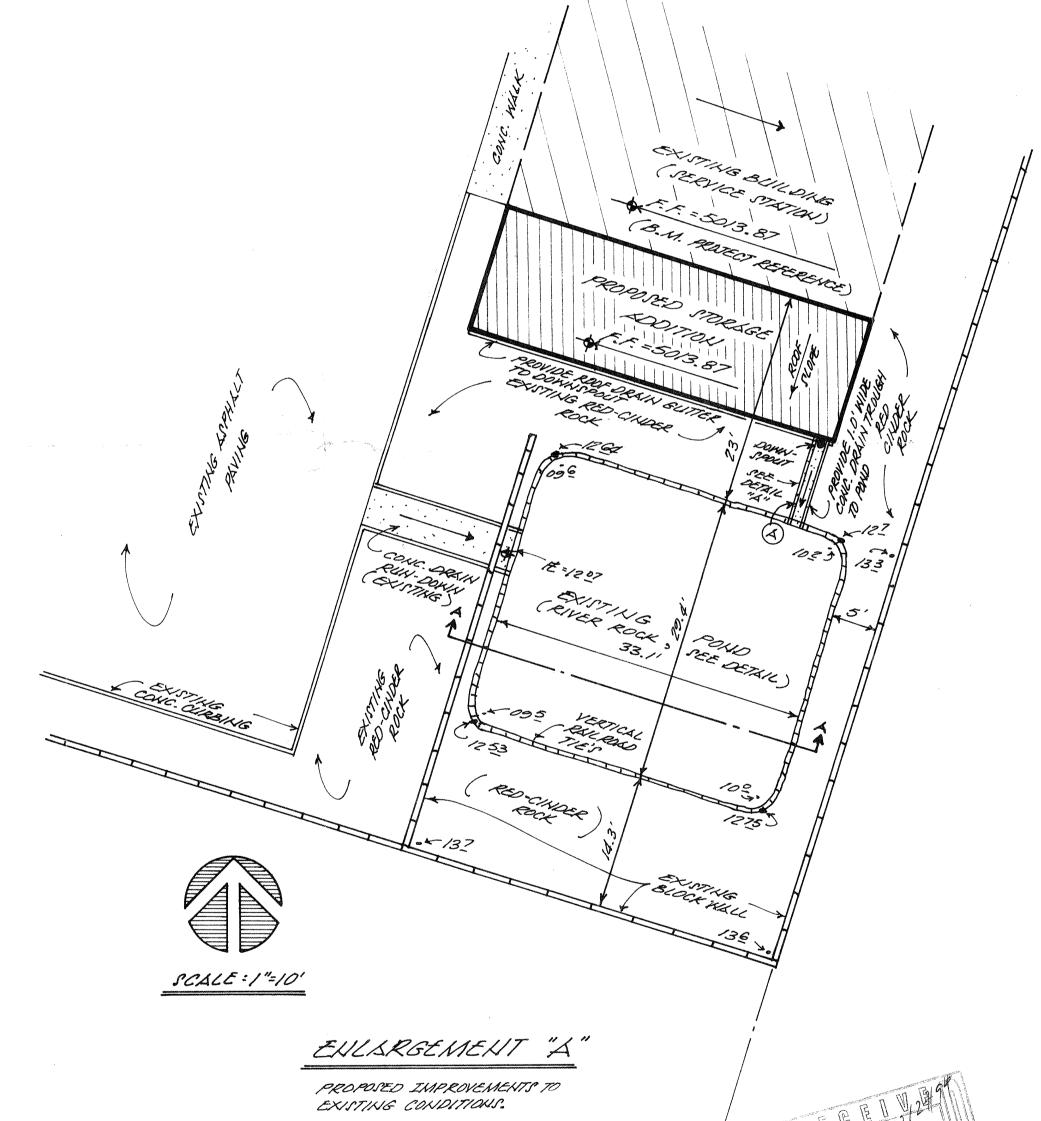

ORAINAGE PLAN

L PROPOSED ADDITION TO L MARKET BUILDING AND AUTO FUELING FACILITY FOR

MIHAI SPILCA 514 COORS BLVD. S.W. ALBUQUERQUE, KEW MEXICO DECEMBER, 1994

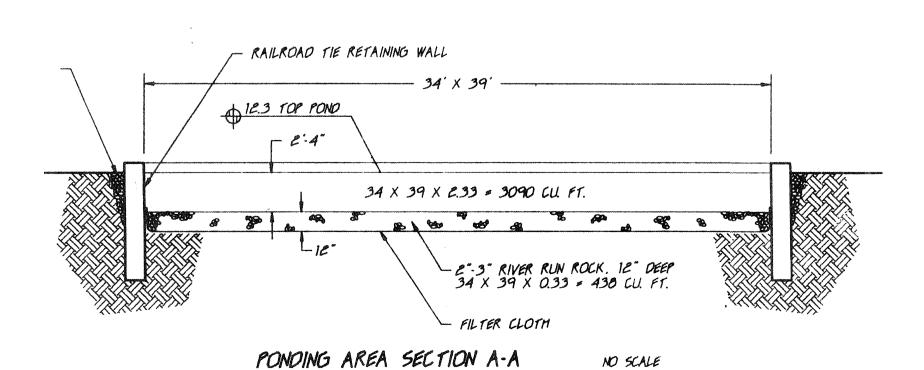

(PER DESIGN)

7875
7875
7875
7875
PROFESSIONAL
12-22-94

ENGINEER'S SEAL