


CAUTION - NOTICE TO CONTRACTOR

THE CONTRACTOR IS SPECIFICALLY CAUTIONED THAT THE LOCATION AND/OR ELEVATION OF EXISTING UTILITIES AS SHOWN ON THESE PLANS IS BASED ON RECORDS OF THE VARIOUS UTILITY COMPANIES AND, WHERE POSSIBLE, MEASUREMENTS TAKEN IN THE FIELD. THE INFORMATION IS NOT TO BE RELIED ON AS BEING EXACT OR COMPLETE. THE CONTRACTOR MUST CALL THE APPROPRIATE UTILITY COMPANY AT LEAST 48 HOURS BEFORE ANY EXCAVATION TO REQUEST EXACT FIELD LOCATION OF UTILITIES. IT SHALL BE THE RESPONSIBILITY OF THE CONTRACTOR TO RELOCATE ALL EXISTING UTILITIES WHICH CONFLICT WITH THE PROPOSED IMPROVEMENTS SHOWN ON THE PLANS.

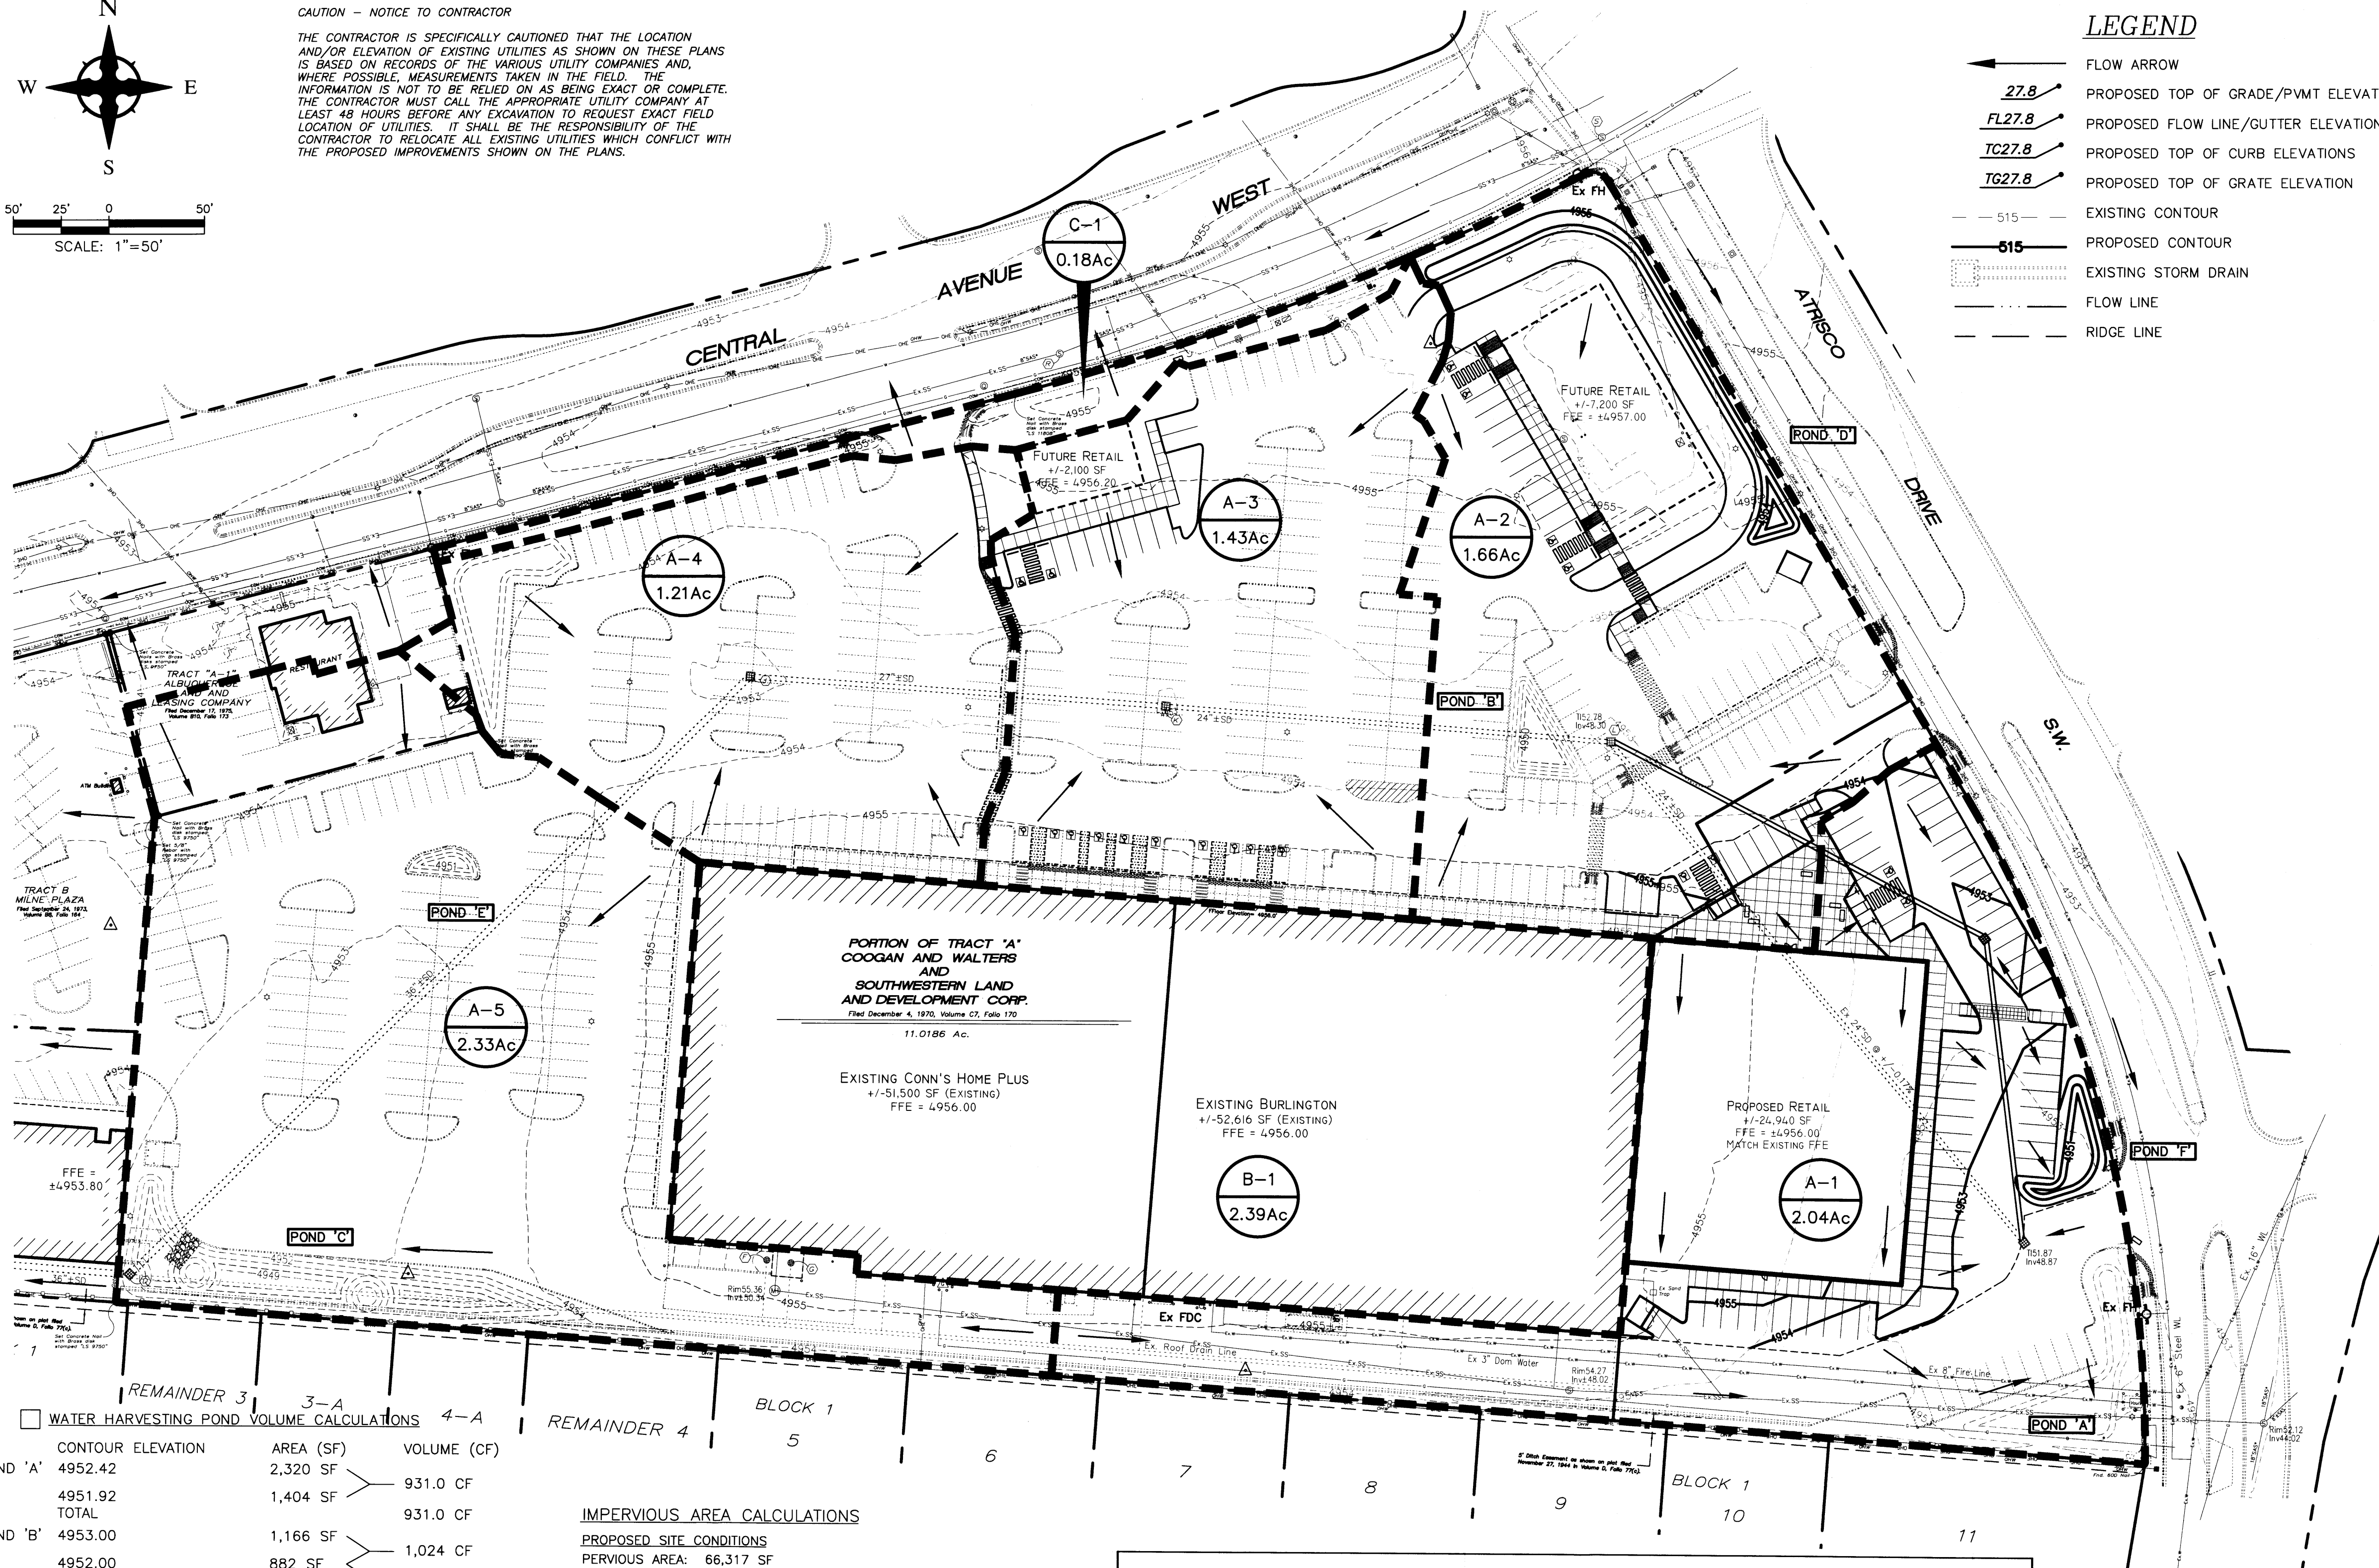

LEGEND

- 27.8' FLOW ARROW
- FL27.8' PROPOSED TOP OF GRADE/PVMT ELEVATIONS
- TC27.8' PROPOSED FLOW LINE/GUTTER ELEVATIONS
- TG27.8' PROPOSED TOP OF CURB ELEVATIONS
- PROPOSED TOP OF GRATE ELEVATION
- 515 EXISTING CONTOUR
- PROPOSED CONTOUR
- EXISTING STORM DRAIN
- FLOW LINE
- RIDGE LINE



VICINITY MAP - Zone Atlas K-12



FIRM MAP 35001C0333H

Per FIRM Map 35001C0333H, dated August 16, 2012, the site is located in the 0.2% chance Annual Floodplain with Average Depth of less than 1 foot.

DRAINAGE MANAGEMENT PLAN

INTRODUCTION

The purpose of this submittal is to provide a conceptual grading plan and drainage management plan for the Redevelopment of West Central Plaza, located at the SW of Central Ave SW and Atrisco Dr SW in Albuquerque, NM. The site contains approximately 11.02 acres. A prior Drainage Management Plan for this site was submitted by Wooten Engineering on 9/30/2015 and approved on 11/10/2015.

EXISTING HYDROLOGIC CONDITIONS

The site is currently developed and drains via an underground storm drain system which outfalls to an existing 36" storm drain in the alley to the west of the site. The parking lot currently surface drains to several Type 'D' inlets as shown on the Grading Plan. The roof of the existing main retail buildings (Conn's Home Plus and Burlington) drain to downspouts which are connected to a storm drain system on the south side of the building. This roof drain connects to the main site storm sewer system located at the southwest corner of the site. There is a small off-site drainage area that flows onto the site from the existing Long John Silver's site as shown within Basins 'A-4' and 'A-5'. Per the Calculations table this sheet, the total existing flow leaving the site in the storm drain system is 47.78 cfs during the 100-Yr Storm Event. This excludes Basin 'C-1', which is a small area that drains directly to Central Ave.

PROPOSED HYDROLOGIC CONDITIONS

The newest building addition to the site (+/-24,940 SF) will further reduce the impervious area by just over 1,000 SF due to the parking lot configuration. There is an existing 24" storm drain that is located under the proposed building and will be relocated with this project per the grading plan on Sheet 1.1. There is also a new Type 'D' inlet located within Basin A-1 at the deflection point of the new 24" pipes. The drainage patterns generally remain the same as the Pre-Developed condition; however, we have added some water harvesting ponds in key areas in order to capture the first flush from the site.

The total runoff from the site (excluding Basin 'C-1') is 46.03 cfs during the 100-Yr, 6-Hr Storm Event which is less than the original Kmart development. Reference the Plan approved on 11/10/2015 for additional information.

FIRST FLUSH CALCULATIONS

Per the First Flush Calculations on this sheet, the total First Flush Volume required to be collected for the site is 8,770 CF. Since the roof of the existing large retail building is flowing directly into a storm drain system and cannot be routed through a landscape area, we have not taken the building roof area into account for the calculation. Per the Water Harvesting Pond Calculations table this sheet, we are collecting 14,554.50 CF of flow from the site which is greater than that required.

CONCLUSION

This Drainage Management Plan provides for grading and drainage elements which are capable of safely passing the 100 year storm, do not burden downstream systems, and meet city requirements. In addition, the proposed water harvesting ponds will help treat stormwater runoff per the DPM. The proposed improvements to the site should not have any negative impacts to facilities downstream. With this submittal, we are requesting Drainage Management and Grading Plan approval for the Site Development Plan for Building Permit.



Wooten Engineering
1005 21st Street SE, Suite B1
Rio Rancho, NM 87124
Ph: 505.980.3560

IMPERVIOUS AREA CALCULATIONS

PROPOSED SITE CONDITIONS

PERVIOUS AREA: 66,317 SF
IMPERVIOUS AREA (EXCL BLDGS): 309,537 SF
MAIN RETAIL BUILDING AREA: 104,115 SF
TOTAL SITE AREA: 479,969 SF
% IMPERVIOUS = 86.18%

NOTE: THE MAIN RETAIL BUILDING IS EXCLUDED FROM THE FIRST FLUSH CALCULATIONS SINCE IT DRAINS TO AN EXISTING BELOW GRADE STORM DRAIN SYSTEM AND CANNOT BE CAPTURED IN THE LANDSCAPE AREAS.

FIRST FLUSH CALCULATION

TOTAL IMPERVIOUS AREA (LESS MAIN RETAIL BLDG) = 309,537 SF
FIRST FLUSH = 309,537 * 0.34" / 12 = **8,770 CF**
TOTAL VOLUME PROVIDED = **14,554.5 CF**

Existing West Central/Atrisco Drainage Calculations

This table is based on the COA DPM Section 22.2, Zone: 1												
BASIN	Area	Area	Land Treatment Percentages				Q(100)	Q(100)	WT E	V(100) ₂₄₀	V(100) ₁₄₄₀	V(100) _{10day}
	(SQ. FT.)	(AC.)	A	B	C	D	(cfs/ac.)	(CFS)	(inches)	(CF)	(CF)	(CF)
A-1	88652	2.04	0.0%	0.0%	13.4%	86.4%	4.16	8.47	1.83	13554	16108	23767
A-2	72473	1.66	0.0%	0.0%	13.4%	86.4%	4.16	6.92	1.83	11081	13168	19430
A-3	62387	1.43	0.0%	0.0%	13.4%	86.4%	4.16	5.96	1.83	9539	11335	16726
A-4	52756	1.21	0.0%	0.0%	13.4%	86.4%	4.16	5.04	1.83	8066	9586	14144
A-5	101524	2.33	0.0%	0.0%	13.4%	86.4%	4.16	9.70	1.83	15523	18446	27218
B-1	104116	2.39	0.0%	0.0%	13.4%	86.4%	4.16	9.94	1.83	15919	18917	27913
C-1	7960	0.18	0.0%	0.0%	13.4%	86.4%	4.16	0.76	1.83	1217	1446	2134
TOTAL	489868	11.25						46.79		74898	89007	131331

Proposed West Central/Atrisco Drainage Calculations

Ultimate Development Conditions Basin Data Table

This table is based on the COA DPM Section 22.2, Zone: 1												
BASIN	Area	Area	Land Treatment Percentages				Q(100)	Q(100)	WT E	V(100) ₂₄₀	V(100) ₁₄₄₀	V(100) _{10day}
	(SQ. FT.)	(AC.)	A	B	C	D	(cfs/ac.)	(CFS)	(inches)	(CF)	(CF)	(CF)
A-1	88652	2.04	0.0%	0.0%	13.4%	86.4%	4.16	8.47	1.83	13554	16108	23767
A-2	72473	1.66	0.0%	0.0%	13.4%	86.4%	4.16	6.92	1.83	11081	13168	19430
A-3	62387	1.43	0.0%	0.0%	13.4%	86.4%	4.16	5.96	1.83	9539	11335	16726
A-4	52756	1.21	0.0%	0.0%	13.4%	86.4%	4.16	5.04	1.83	8066	9586	14144
A-5	101524	2.33	0.0%	0.0%	13.4%	86.4%	4.16	9.70	1.83	15523	18446	27218
B-1	104116	2.39	0.0%	0.0%	13.4%	86.4%	4.16	9.94	1.83	15919	18917	27913
C-1	7960	0.18	0.0%	0.0%	13.4%	86.4%	4.16	0.76	1.83	1217	1446	2134
TOTAL	489868	11.25						46.79		74898	89007	131331

WATER HARVESTING POND VOLUME CALCULATIONS		
CONTOUR ELEVATION	AREA (SF)	VOLUME (CF)
POND 'A' 4952.42	2,320 SF	931.0 CF
4951.92	1,404 SF	931.0 CF
TOTAL		931.0 CF
POND 'B' 4953.00	1,166 SF	1,024 CF
4952.00	882 SF	752 CF
4951.00	622 SF	511 CF
4950.00	400 SF	
TOTAL		2,287 CF
POND 'C' 4952.00	5,704 SF	4,732 CF
4951.00	3,760 SF	2,885 CF
4950.00	2,010 SF	1,440 CF
4949.00	870 SF	
TOTAL		9,057 CF
POND 'D' 4955.00	1,844 SF	699.5 CF
4954.50	955 SF	304.5 CF
4954.00	263 SF	168.5 CF
4953.00	74 SF	
TOTAL		1,172.5 CF
POND 'E' 4953.00	378 SF	299 CF
4952.00	220 SF	157 CF
4951.00	94 SF	
TOTAL		456 CF
POND 'A' 4952.00	884 SF	651.0 CF
4951.00	418 SF	
TOTAL		651.0 CF
SUBTOTAL		14,554.5 CF

REV	DATE	BY	REVISION
1			
2			
3			
4			
5			
6			
7	7/6/2016	JTW	EPC Conditions
8	4/25/2016	JTW	City Comments

MODULUS ARCHITECTS
220 COPPER AVE. N.W. SUITE 350
ALBUQUERQUE, NEW MEXICO 87102
PHONE (505) 338-1499 FAX (505) 338-1498

JEFFREY TODD WOOTEN
NEW MEXICO
16892
PROFESSIONAL ENGINEER
7/27/2016

PROJECT TITLE: WEST CENTRAL PLAZA - PROP. ADDITION
4208 CENTRAL AVE. SW
ALBUQUERQUE NEW MEXICO

PROJECT MANAGER: JEFF WOOTEN
JOB NO.: 2015064
DRAWN BY: JTW

DATE: 3/28/2016
SCALE: AS NOTED

SHEET: 1
C1.1
3



DRAINAGE MANAGEMENT PLAN

NOTICE TO CONTRACTORS

- 1. AN EXCAVATION/CONSTRUCTION PERMIT WILL BE REQUIRED BEFORE BEGINNING ANY WORK WITHIN CITY RIGHT-OF-WAY.
- 2. ALL WORK DETAILED ON THESE PLANS TO BE PERFORMED, EXCEPT AS OTHERWISE STATED OR PROVIDED HEREON, SHALL BE CONSTRUCTED IN ACCORDANCE WITH CITY OF ALBUQUERQUE INTERIM STANDARD SPECIFICATIONS FOR PUBLIC WORKS CONSTRUCTION, 1996 UPDATE NO. 8.
- 3. TWO WORKING DAYS PRIOR TO ANY EXCAVATION, CONTRACTOR MUST CONTACT NM ONE CALL FOR LOCATION OF EXISTING UTILITIES. (NM ONE CALL = 811)
- 4. PRIOR TO CONSTRUCTION, THE CONTRACTOR SHALL EXCAVATE AND VERIFY THE HORIZONTAL AND VERTICAL LOCATIONS OF ALL CONSTRUCTIONS. SHOULD A CONFLICT EXIST, THE CONTRACTOR SHALL NOTIFY THE ENGINEER SO THAT THE CONFLICT CAN BE RESOLVED WITH A MINIMUM AMOUNT OF DELAY.
- 5. BACKFILL COMPACTION SHALL BE ACCORDING TO TRAFFIC/STREET USE.
- 6. MAINTENANCE OF THESE FACILITIES SHALL BE THE RESPONSIBILITY OF THE OWNER OF THE PROPERTY SERVED.
- 7. WORK ON ARTERIAL STREETS SHALL BE PERFORMED ON A 24-HOUR BASIS.


CAUTION - NOTICE TO CONTRACTOR

THE CONTRACTOR IS SPECIFICALLY CAUTIONED THAT THE LOCATION AND/OR ELEVATION OF EXISTING UTILITIES AS SHOWN ON THESE PLANS IS BASED ON RECORDS OF THE VARIOUS UTILITY COMPANIES AND, WHERE POSSIBLE, MEASUREMENTS TAKEN IN THE FIELD. THE INFORMATION IS NOT TO BE RELIED ON AS BEING EXACT OR COMPLETE. THE CONTRACTOR MUST CALL THE APPROPRIATE UTILITY COMPANY AT LEAST 48 HOURS BEFORE ANY EXCAVATION TO REQUEST EXACT FIELD LOCATION OF UTILITIES. IT SHALL BE THE RESPONSIBILITY OF THE CONTRACTOR TO RELOCATE ALL EXISTING UTILITIES WHICH CONFLICT WITH THE PROPOSED IMPROVEMENTS SHOWN ON THE PLANS.

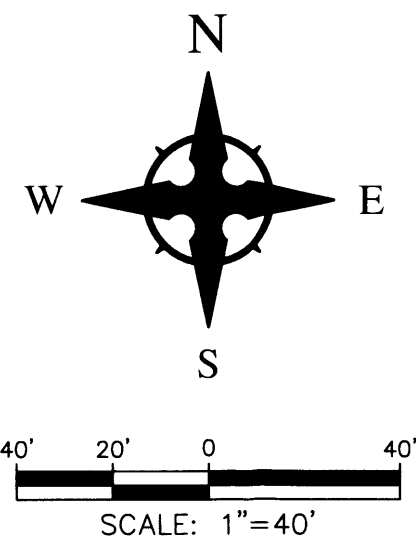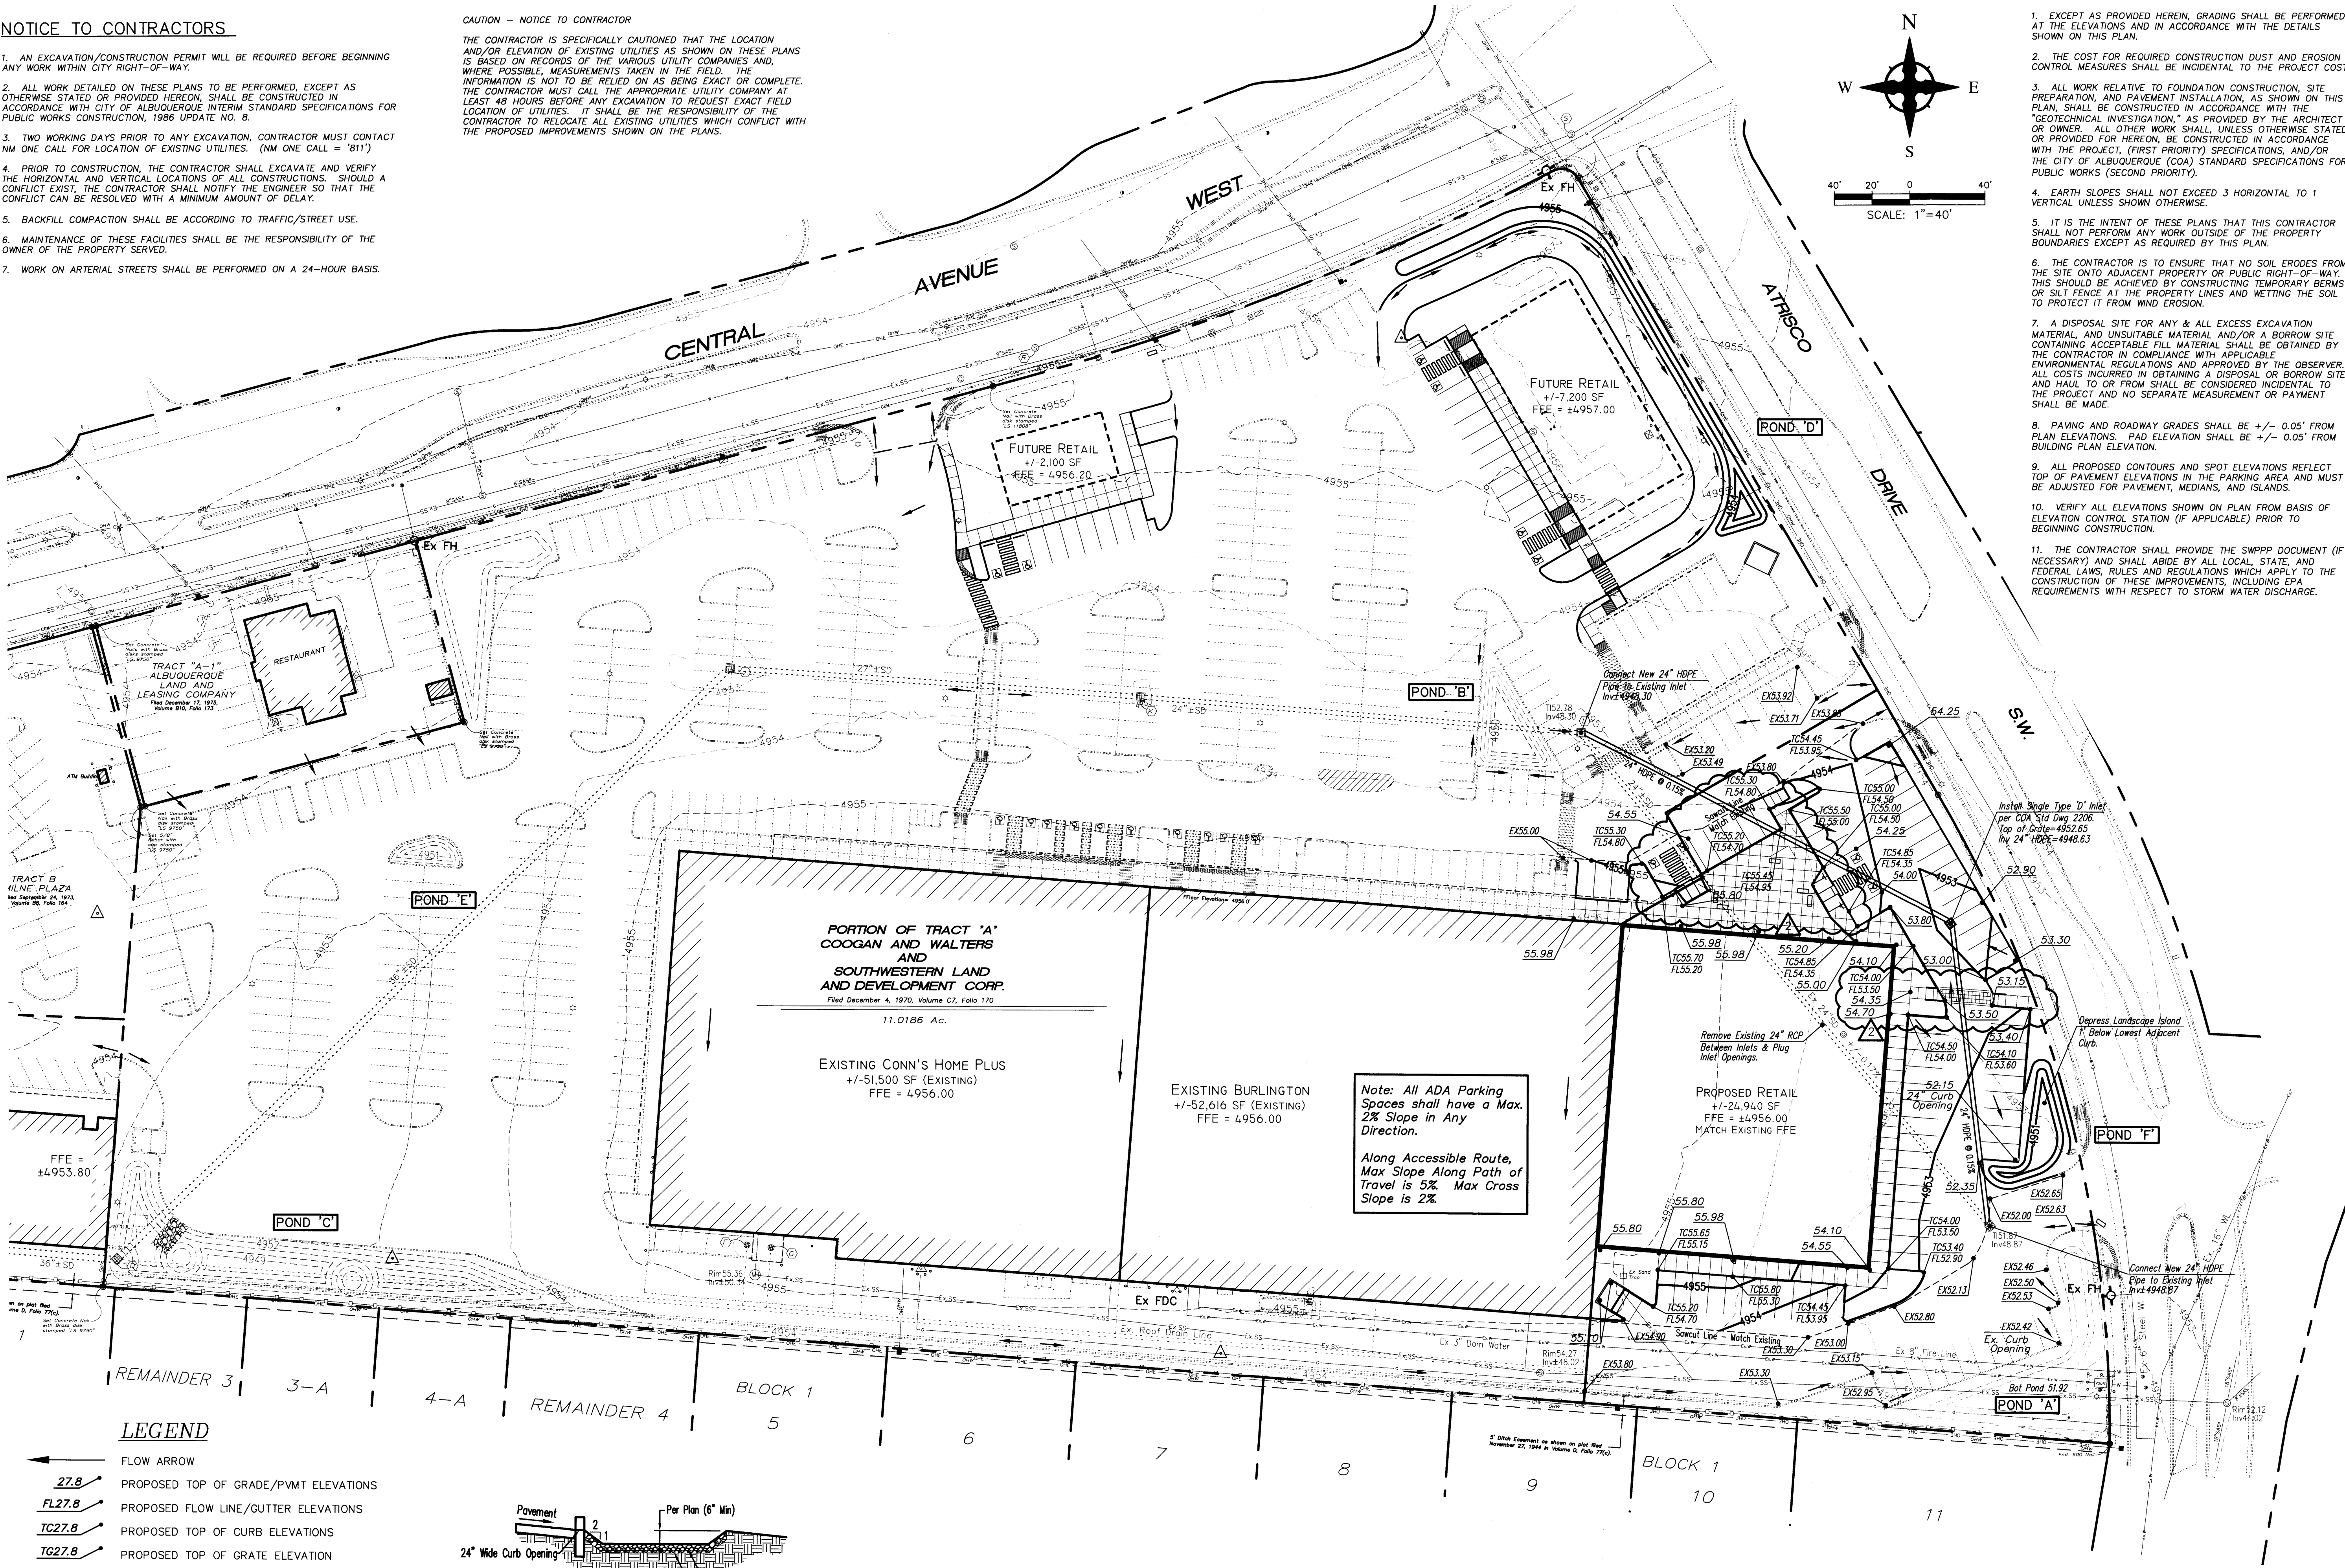

- 1. EXCEPT AS PROVIDED HEREIN, GRADING SHALL BE PERFORMED AT THE ELEVATIONS AND IN ACCORDANCE WITH THE DETAILS SHOWN ON THIS PLAN.
- 2. THE COST FOR REQUIRED CONSTRUCTION DUST AND EROSION CONTROL MEASURES SHALL BE INCIDENTAL TO THE PROJECT COST.
- 3. ALL WORK RELATIVE TO FOUNDATION CONSTRUCTION, SITE PREPARATION, AND PAVEMENT INSTALLATION, AS SHOWN ON THIS PLAN, SHALL BE CONSTRUCTED IN ACCORDANCE WITH THE "GEOLOGICAL INVESTIGATION" AS PROVIDED BY THE ARCHITECT OR OWNER. ALL OTHER WORK SHALL, UNLESS OTHERWISE STATED OR PROVIDED FOR HEREON, BE CONSTRUCTED IN ACCORDANCE WITH THE PROJECT, (FIRST PRIORITY) SPECIFICATIONS, AND/OR THE CITY OF ALBUQUERQUE (COA) STANDARD SPECIFICATIONS FOR PUBLIC WORKS (SECOND PRIORITY).
- 4. EARTH SLOPES SHALL NOT EXCEED 3 HORIZONTAL TO 1 VERTICAL UNLESS SHOWN OTHERWISE.
- 5. IT IS THE INTENT OF THESE PLANS THAT THIS CONTRACTOR SHALL NOT PERFORM ANY WORK OUTSIDE OF THE PROPERTY BOUNDARIES EXCEPT AS REQUIRED BY THIS PLAN.
- 6. THE CONTRACTOR IS TO ENSURE THAT NO SOIL ERODES FROM THE SITE ONTO ADJACENT PROPERTY OR PUBLIC RIGHT-OF-WAY. THIS SHOULD BE ACHIEVED BY CONSTRUCTING TEMPORARY BERMS OR SILT FENCE AT THE PROPERTY LINES AND WETTING THE SOIL TO PROTECT IT FROM WIND EROSION.
- 7. A DISPOSAL SITE FOR ANY & ALL EXCESS EXCAVATION MATERIAL, AND UNSUITABLE MATERIAL AND/OR A BORROW SITE CONTAINING ACCEPTABLE FILL MATERIAL, SHALL BE OBTAINED BY THE CONTRACTOR IN COMPLIANCE WITH APPLICABLE ENVIRONMENTAL REGULATIONS AND APPROVED BY THE OBSERVER. ALL COSTS INCURRED IN OBTAINING A DISPOSAL OR BORROW SITE AND HAUL TO OR FROM SHALL BE CONSIDERED INCIDENTAL TO THE PROJECT AND NO SEPARATE MEASUREMENT OR PAYMENT SHALL BE MADE.
- 8. PAVING AND ROADWAY GRADES SHALL BE +/- 0.05' FROM PLAN ELEVATIONS. PAD ELEVATION SHALL BE +/- 0.05' FROM BUILDING PLAN ELEVATION.
- 9. ALL PROPOSED CONTOURS AND SPOT ELEVATIONS REFLECT TOP OF PAVEMENT ELEVATIONS IN THE PARKING AREA AND MUST BE ADJUSTED FOR PAVEMENT, MEDIANS, AND ISLANDS.
- 10. VERIFY ALL ELEVATIONS SHOWN ON PLAN FROM BASIS OF ELEVATION CONTROL STATION (IF APPLICABLE) PRIOR TO BEGINNING CONSTRUCTION.
- 11. THE CONTRACTOR SHALL PROVIDE THE SWPPP DOCUMENT (IF NECESSARY) AND SHALL ABIDE BY ALL LOCAL, STATE, AND FEDERAL LAWS, RULES AND REGULATIONS WHICH APPLY TO THE CONSTRUCTION OF THESE IMPROVEMENTS, INCLUDING EPA REQUIREMENTS WITH RESPECT TO STORM WATER DISCHARGE.

- LEGEND**
- 27.8 PROPOSED TOP OF GRADE/PVMT ELEVATIONS
 - FL27.8 PROPOSED FLOW LINE/GUTTER ELEVATIONS
 - TC27.8 PROPOSED TOP OF CURB ELEVATIONS
 - TC27.8 PROPOSED TOP OF GRATE ELEVATION
 - 515 EXISTING CONTOUR
 - 515 PROPOSED CONTOUR
 - EXISTING STORM DRAIN
 - FLOW LINE
 - RIDGE LINE

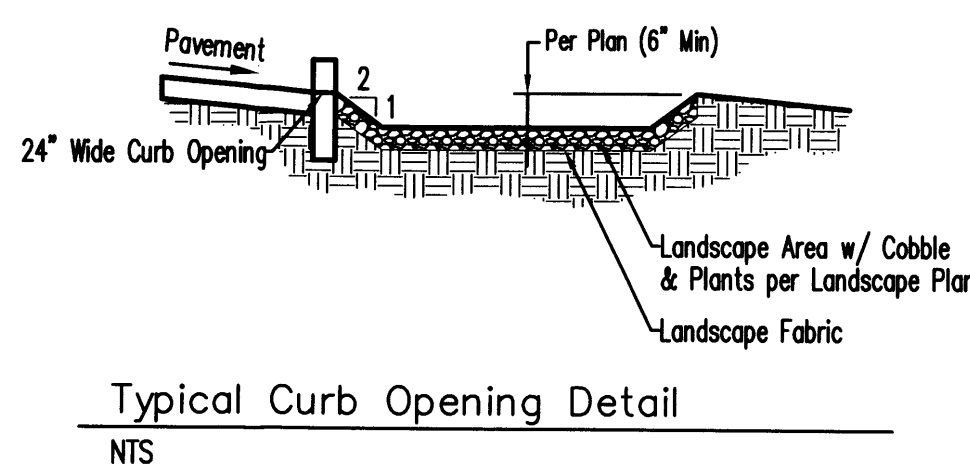

REV	DATE	BY	REVISION
1			
2			
3			
100			

MODULUS ARCHITECTS
220 COPPER AVE. N.W. SUITE 350
ALBUQUERQUE, NEW MEXICO 87102
PHONE (505) 338-1499 FAX (505) 338-1498

JEFFREY TODD WOOTEN
16892
PROFESSIONAL ENGINEER
7/27/2016

PROJECT TITLE	WEST CENTRAL PLAZA - PROP. ADDITION
4208 CENTRAL AVE. SW	
ALBUQUERQUE NEW MEXICO	
PROJECT MANAGER	JEFF WOOTEN
JOB NO.	2015064
DRAWN BY:	JTW
SHEET TITLE	GRADING PLAN

Wooten Engineering
1005 21st Street SE, Suite B1
Rio Rancho, NM 87124
Ph: 505.980.3560


DATE	3/28/2016	SHEET	1
SCALE	AS NOTED	C1.2	
		of	3

NOTICE TO CONTRACTORS

1. AN EXCAVATION/CONSTRUCTION PERMIT WILL BE REQUIRED BEFORE BEGINNING ANY WORK WITHIN CITY RIGHT-OF-WAY.
2. ALL WORK DETAILED ON THESE PLANS TO BE PERFORMED, EXCEPT AS OTHERWISE STATED OR PROVIDED HEREON, SHALL BE CONSTRUCTED IN ACCORDANCE WITH CITY OF ALBUQUERQUE INTERIM STANDARD SPECIFICATIONS FOR PUBLIC WORKS CONSTRUCTION, 1986 UPDATE NO. 8.
3. TWO WORKING DAYS PRIOR TO ANY EXCAVATION, CONTRACTOR MUST CONTACT NM ONE CALL FOR LOCATION OF EXISTING UTILITIES. (NM ONE CALL = "811")
4. PRIOR TO CONSTRUCTION, THE CONTRACTOR SHALL EXCAVATE AND VERIFY THE HORIZONTAL AND VERTICAL LOCATIONS OF ALL CONSTRUCTIONS. SHOULD A CONFLICT EXIST, THE CONTRACTOR SHALL NOTIFY THE ENGINEER SO THAT THE CONFLICT CAN BE RESOLVED WITH A MINIMUM AMOUNT OF DELAY.
5. BACKFILL COMPACTION SHALL BE ACCORDING TO TRAFFIC/STREET USE.
6. MAINTENANCE OF THESE FACILITIES SHALL BE THE RESPONSIBILITY OF THE OWNER OF THE PROPERTY SERVED.
7. WORK ON ARTERIAL STREETS SHALL BE PERFORMED ON A 24-HOUR BASIS.

CAUTION - NOTICE TO CONTRACTOR


THE CONTRACTOR IS SPECIFICALLY CAUTIONED THAT THE LOCATION AND/OR ELEVATION OF EXISTING UTILITIES AS SHOWN ON THESE PLANS IS BASED ON RECORDS OF THE VARIOUS UTILITY COMPANIES AND, WHERE POSSIBLE, MEASUREMENTS TAKEN IN THE FIELD. THE INFORMATION IS NOT TO BE RELIED ON AS BEING EXACT OR COMPLETE. THE CONTRACTOR MUST CALL THE APPROPRIATE UTILITY COMPANY AT LEAST 48 HOURS BEFORE ANY EXCAVATION TO REQUEST EXACT FIELD LOCATION OF UTILITIES. IT SHALL BE THE RESPONSIBILITY OF THE CONTRACTOR TO RELOCATE ALL EXISTING UTILITIES WHICH CONFLICT WITH THE PROPOSED IMPROVEMENTS SHOWN ON THE PLANS.

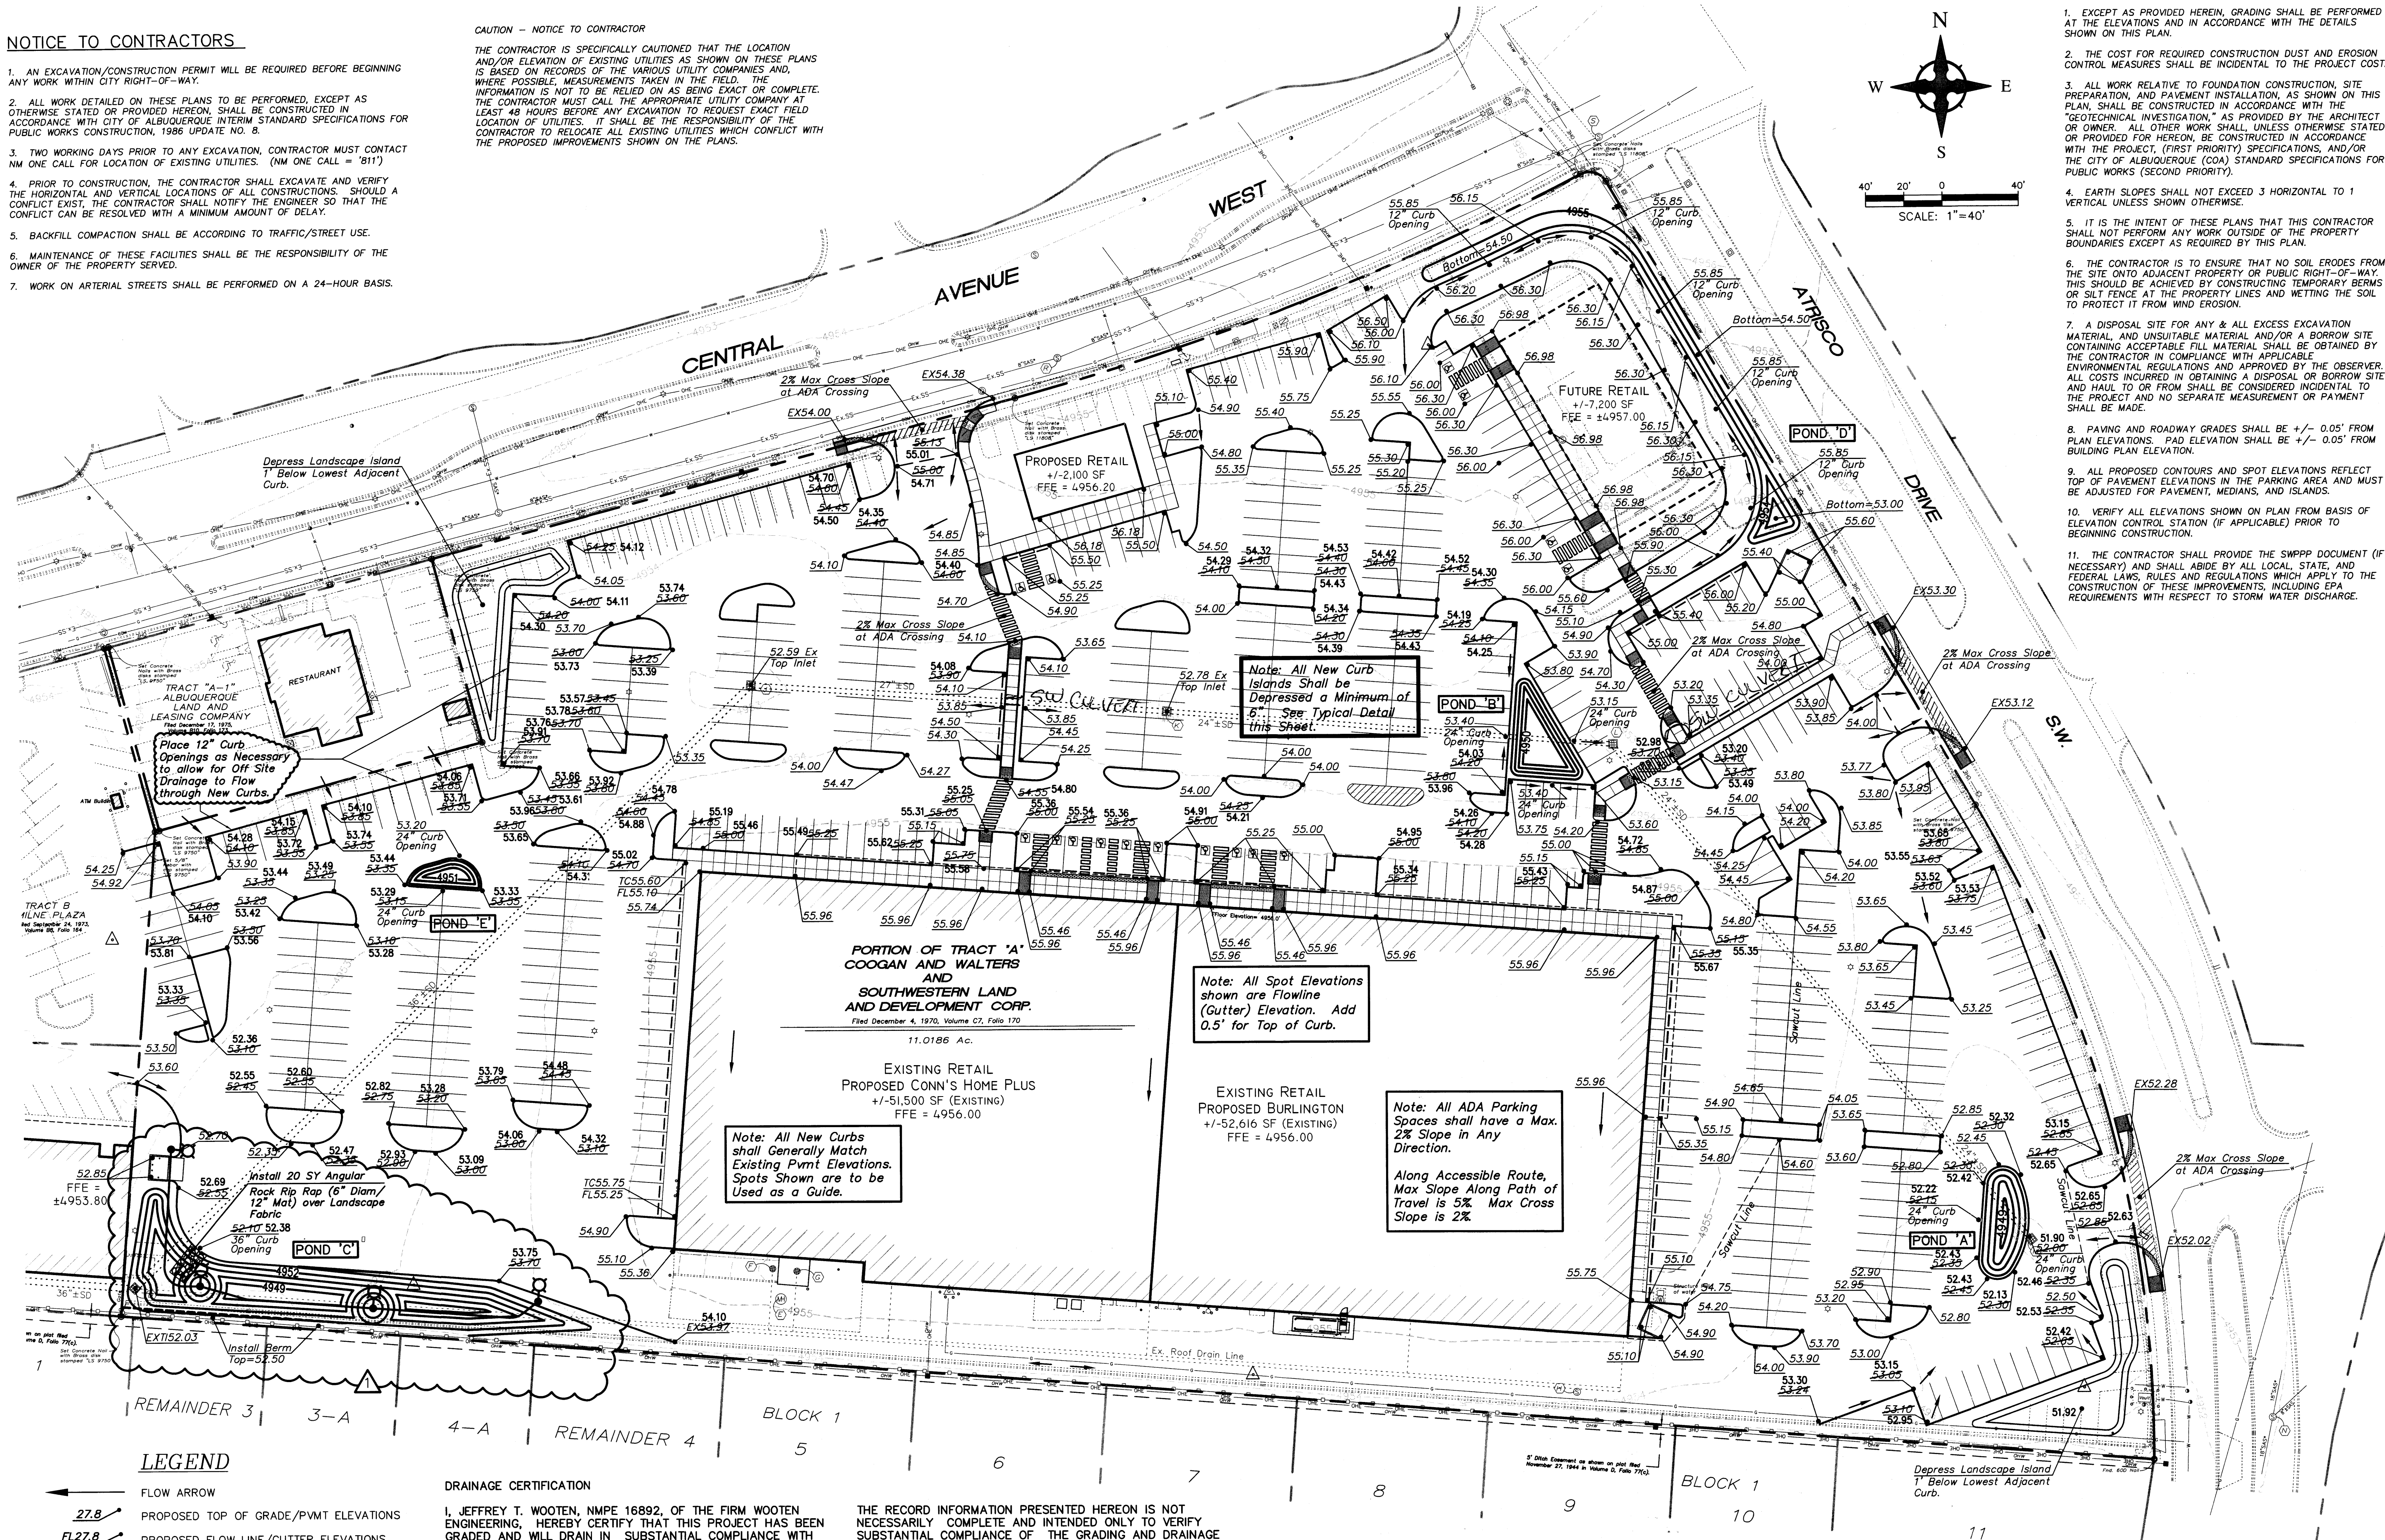


1. EXCEPT AS PROVIDED HEREIN, GRADING SHALL BE PERFORMED AT THE ELEVATIONS AND IN ACCORDANCE WITH THE DETAILS SHOWN ON THIS PLAN.
2. THE COST FOR REQUIRED CONSTRUCTION DUST AND EROSION CONTROL MEASURES SHALL BE INCIDENTAL TO THE PROJECT COST.
3. ALL WORK RELATIVE TO FOUNDATION CONSTRUCTION, SITE PREPARATION, AND PAVEMENT INSTALLATION, AS SHOWN ON THIS PLAN, SHALL BE CONSTRUCTED IN ACCORDANCE WITH THE "GEOTECHNICAL INVESTIGATION," AS PROVIDED BY THE ARCHITECT OR OWNER. ALL OTHER WORK SHALL, UNLESS OTHERWISE STATED OR PROVIDED FOR HEREON, BE CONSTRUCTED IN ACCORDANCE WITH THE PROJECT, (FIRST PRIORITY) SPECIFICATIONS, AND/OR THE CITY OF ALBUQUERQUE (COA) STANDARD SPECIFICATIONS FOR PUBLIC WORKS (SECOND PRIORITY).
4. EARTH SLOPES SHALL NOT EXCEED 3 HORIZONTAL TO 1 VERTICAL UNLESS SHOWN OTHERWISE.
5. IT IS THE INTENT OF THESE PLANS THAT THIS CONTRACTOR SHALL NOT PERFORM ANY WORK OUTSIDE OF THE PROPERTY BOUNDARIES EXCEPT AS REQUIRED BY THIS PLAN.
6. THE CONTRACTOR IS TO ENSURE THAT NO SOIL ERODES FROM THE SITE ONTO ADJACENT PROPERTY OR PUBLIC RIGHT-OF-WAY. THIS SHOULD BE ACHIEVED BY CONSTRUCTING TEMPORARY BERMS OR SILT FENCE AT THE PROPERTY LINES AND WETTING THE SOIL TO PROTECT IT FROM WIND EROSION.
7. A DISPOSAL SITE FOR ANY & ALL EXCESS EXCAVATION MATERIAL, AND UNSUITABLE MATERIAL AND/OR A BORROW SITE CONTAINING ACCEPTABLE FILL MATERIAL SHALL BE OBTAINED BY THE CONTRACTOR IN COMPLIANCE WITH APPLICABLE ENVIRONMENTAL REGULATIONS AND APPROVED BY THE OBSERVER. ALL COSTS INCURRED IN OBTAINING A DISPOSAL OR BORROW SITE AND HAUL TO OR FROM SHALL BE CONSIDERED INCIDENTAL TO THE PROJECT AND NO SEPARATE MEASUREMENT OR PAYMENT SHALL BE MADE.
8. PAVING AND ROADWAY GRADES SHALL BE +/- 0.05' FROM PLAN ELEVATIONS. PAD ELEVATION SHALL BE +/- 0.05' FROM BUILDING PLAN ELEVATION.
9. ALL PROPOSED CONTOURS AND SPOT ELEVATIONS REFLECT TOP OF PAVEMENT ELEVATIONS IN THE PARKING AREA AND MUST BE ADJUSTED FOR PAVEMENT, MEDIANS, AND ISLANDS.
10. VERIFY ALL ELEVATIONS SHOWN ON PLAN FROM BASIS OF ELEVATION CONTROL STATION (IF APPLICABLE) PRIOR TO BEGINNING CONSTRUCTION.
11. THE CONTRACTOR SHALL PROVIDE THE SWPPP DOCUMENT (IF NECESSARY) AND SHALL ABIDE BY ALL LOCAL, STATE, AND FEDERAL LAWS, RULES AND REGULATIONS WHICH APPLY TO THE CONSTRUCTION OF THESE IMPROVEMENTS, INCLUDING EPA REQUIREMENTS WITH RESPECT TO STORM WATER DISCHARGE.

MODULUS ARCHITECTS

220 COPPER AVE. N.W. SUITE 350
ALBUQUERQUE, NEW MEXICO 87102
PHONE (505) 338-1499 FAX (505) 338-1498

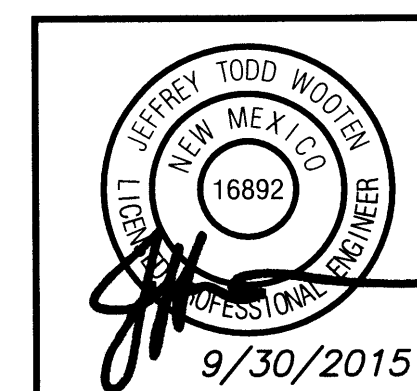

PROJECT TITLE	WEST CENTRAL-ATRISCO
LOCATION	4208 CENTRAL AVE. SW ALBUQUERQUE NEW MEXICO
PROJECT MANAGER	JEFF WOOTEN
DATE	9/22/15
SCALE	AS NOTED
DRAWN BY	JTW
JOB NO.	2015033
SHEET TITLE	GRADING PLAN
SHEET NO.	1
TOTAL SHEETS	3

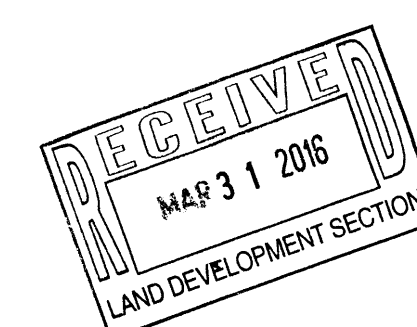

Wooten Engineering
1368 Reynosa Loop SE
Rio Rancho, NM 87124
Ph: 505.980.3560




JEFFREY T. WOOTEN, NMPE 16892

NOTICE TO CONTRACTORS


1. AN EXCAVATION/CONSTRUCTION PERMIT WILL BE REQUIRED BEFORE BEGINNING ANY WORK WITHIN CITY RIGHT-OF-WAY.
2. ALL WORK DETAILED ON THESE PLANS TO BE PERFORMED, EXCEPT AS OTHERWISE STATED OR PROVIDED HEREON, SHALL BE CONSTRUCTED IN ACCORDANCE WITH CITY OF ALBUQUERQUE INTERIM STANDARD SPECIFICATIONS FOR PUBLIC WORKS CONSTRUCTION, 1986 UPDATE NO. 8.
3. TWO WORKING DAYS PRIOR TO ANY EXCAVATION, CONTRACTOR MUST CONTACT NM ONE CALL FOR LOCATION OF EXISTING UTILITIES. (NM ONE CALL = '811')
4. PRIOR TO CONSTRUCTION, THE CONTRACTOR SHALL EXCAVATE AND VERIFY THE HORIZONTAL AND VERTICAL LOCATIONS OF ALL CONSTRUCTIONS. SHOULD A CONFLICT EXIST, THE CONTRACTOR SHALL NOTIFY THE ENGINEER SO THAT THE CONFLICT CAN BE RESOLVED WITH A MINIMUM AMOUNT OF DELAY.
5. BACKFILL COMPACTION SHALL BE ACCORDING TO TRAFFIC/STREET USE.
6. MAINTENANCE OF THESE FACILITIES SHALL BE THE RESPONSIBILITY OF THE OWNER OF THE PROPERTY SERVED.
7. WORK ON ARTERIAL STREETS SHALL BE PERFORMED ON A 24-HOUR BASIS.

CAUTION - NOTICE TO CONTRACTOR

THE CONTRACTOR IS SPECIFICALLY CAUTIONED THAT THE LOCATION AND/OR ELEVATION OF EXISTING UTILITIES AS SHOWN ON THESE PLANS IS BASED ON RECORDS OF THE VARIOUS UTILITY COMPANIES AND, WHERE POSSIBLE, MEASUREMENTS TAKEN IN THE FIELD. THE INFORMATION IS NOT TO BE RELIED ON AS BEING EXACT OR COMPLETE. THE CONTRACTOR MUST CALL THE APPROPRIATE UTILITY COMPANY AT LEAST 48 HOURS BEFORE ANY EXCAVATION TO REQUEST EXACT FIELD LOCATION OF UTILITIES. IT SHALL BE THE RESPONSIBILITY OF THE CONTRACTOR TO RELOCATE ALL EXISTING UTILITIES WHICH CONFLICT WITH THE PROPOSED IMPROVEMENTS SHOWN ON THE PLANS.

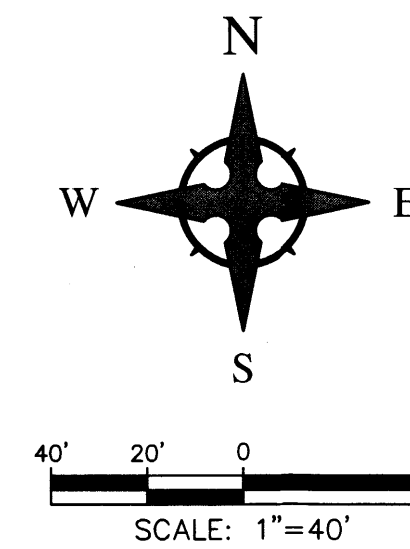

1. EXCEPT AS PROVIDED HEREIN, GRADING SHALL BE PERFORMED AT THE ELEVATIONS AND IN ACCORDANCE WITH THE DETAILS SHOWN ON THIS PLAN.
2. THE COST FOR REQUIRED CONSTRUCTION DUST AND EROSION CONTROL MEASURES SHALL BE INCIDENTAL TO THE PROJECT COST.
3. ALL WORK RELATIVE TO FOUNDATION CONSTRUCTION, SITE PREPARATION, AND PAVEMENT INSTALLATION, AS SHOWN ON THIS PLAN, SHALL BE CONSTRUCTED IN ACCORDANCE WITH THE "GEOTECHNICAL INVESTIGATION," AS PROVIDED BY THE ARCHITECT OR OWNER. ALL OTHER WORK SHALL, UNLESS OTHERWISE STATED OR PROVIDED FOR HEREON, BE CONSTRUCTED IN ACCORDANCE WITH THE PROJECT, (FIRST PRIORITY) SPECIFICATIONS, AND/OR THE CITY OF ALBUQUERQUE (COA) STANDARD SPECIFICATIONS FOR PUBLIC WORKS (SECOND PRIORITY).
4. EARTH SLOPES SHALL NOT EXCEED 3 HORIZONTAL TO 1 VERTICAL UNLESS SHOWN OTHERWISE.
5. IT IS THE INTENT OF THESE PLANS THAT THIS CONTRACTOR SHALL NOT PERFORM ANY WORK OUTSIDE OF THE PROPERTY BOUNDARIES EXCEPT AS REQUIRED BY THIS PLAN.
6. THE CONTRACTOR IS TO ENSURE THAT NO SOIL ERODES FROM THE SITE ONTO ADJACENT PROPERTY OR PUBLIC RIGHT-OF-WAY. THIS SHOULD BE ACHIEVED BY CONSTRUCTING TEMPORARY BERM OR SILT FENCE AT THE PROPERTY LINES AND WETTING THE SOIL TO PROTECT IT FROM WIND EROSION.
7. A DISPOSAL SITE FOR ANY & ALL EXCESS EXCAVATION MATERIAL, AND UNSUITABLE MATERIAL AND/OR A BORROW SITE CONTAINING ACCEPTABLE FILL MATERIAL SHALL BE OBTAINED BY THE CONTRACTOR IN COMPLIANCE WITH APPLICABLE ENVIRONMENTAL REGULATIONS AND APPROVED BY THE OBSERVER. ALL COSTS INCURRED IN OBTAINING A DISPOSAL OR BORROW SITE AND HAIL TO UNIFORM SHALL BE CONSIDERED INCIDENTAL TO THE PROJECT AND NO SEPARATE MEASUREMENT OR PAYMENT SHALL BE MADE.
8. PAVING AND ROADWAY GRADES SHALL BE $\pm 0.05'$ FROM PLAN ELEVATIONS. PAD ELEVATION SHALL BE $\pm 0.05'$ FROM BUILDING PLAN ELEVATION.
9. ALL PROPOSED CONTOURS AND SPOT ELEVATIONS REFLECT TOP OF PAVEMENT ELEVATIONS IN THE PARKING AREA AND MUST BE ADJUSTED FOR PAVEMENT, MEDIANS, AND ISLANDS.
10. VERIFY ALL ELEVATIONS SHOWN ON PLAN FROM BASIS OF ELEVATION CONTROL STATION (IF APPLICABLE) PRIOR TO BEGINNING CONSTRUCTION.
11. THE CONTRACTOR SHALL PROVIDE THE SWPPP DOCUMENT (IF NECESSARY) AND SHALL ABIDE BY ALL LOCAL, STATE, AND FEDERAL LAWS, RULES AND REGULATIONS WHICH APPLY TO THE CONSTRUCTION OF THESE IMPROVEMENTS, INCLUDING EPA REQUIREMENTS WITH RESPECT TO STORM WATER DISCHARGE.

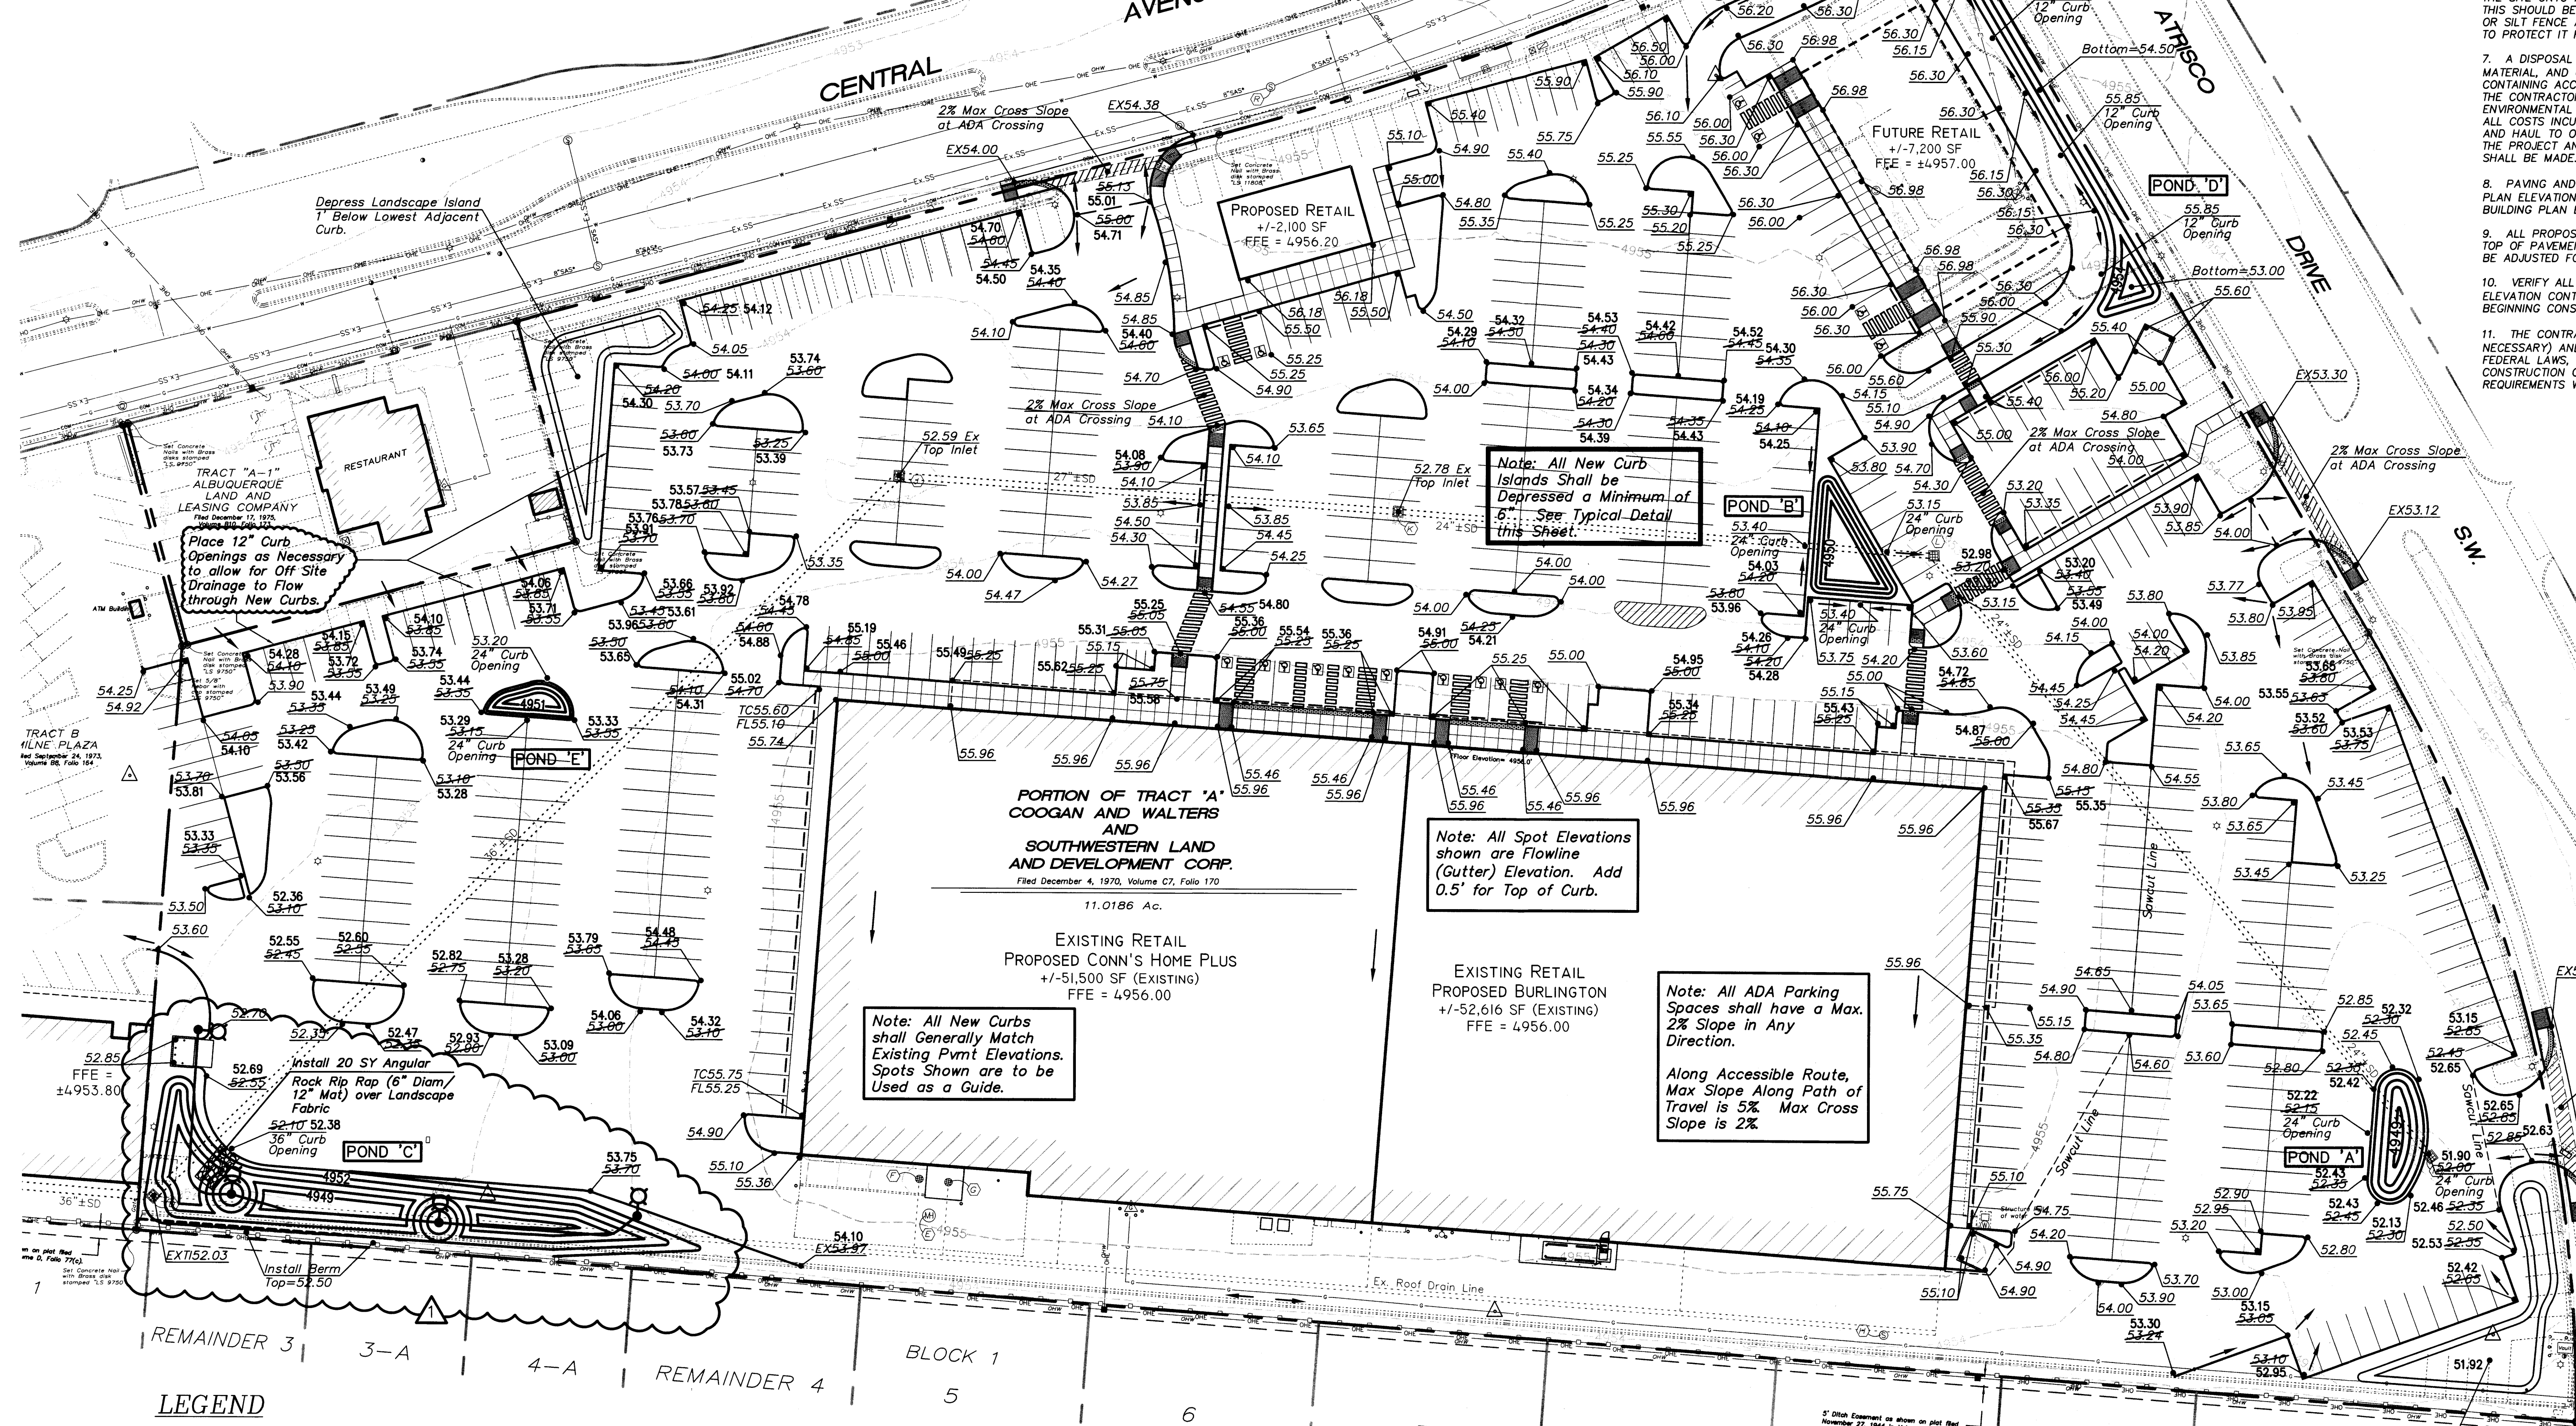


- ### LEGEND
- 27.8 FLOW ARROW
 - FL27.8 PROPOSED TOP OF GRADE/PVMT ELEVATIONS
 - TC27.8 PROPOSED FLOW LINE/GUTTER ELEVATIONS
 - TG27.8 PROPOSED TOP OF CURB ELEVATIONS
 - 515 PROPOSED TOP OF GRATE ELEVATION
 - 515 EXISTING CONTOUR
 - 515 PROPOSED CONTOUR
 - EXISTING STORM DRAIN
 - FLOW LINE
 - RIDGE LINE

DRAINAGE CERTIFICATION

I, JEFFREY T. WOOTEEN, NMPE 16892, OF THE FIRM WOOTEEN ENGINEERING, HEREBY CERTIFY THAT THIS PROJECT HAS BEEN GRADED AND WILL DRAIN IN SUBSTANTIAL COMPLIANCE WITH AND IN ACCORDANCE WITH THE DESIGN INTENT OF THE APPROVED PLAN DATED 09/30/15. THE RECORD INFORMATION EDITED ONTO THE ORIGINAL DESIGN DOCUMENT HAS BEEN OBTAINED BY CHRISTOPHER A. MEDINA, NMPS 15702. I FURTHER CERTIFY THAT I PERSONALLY VISITED THE PROJECT SITE ON 03/24/16 AND HAVE DETERMINED BY VISUAL INSPECTION THAT THE SURVEY DATA PROVIDED IS REPRESENTATIVE OF ACTUAL SITE CONDITIONS AND IS TRUE AND CORRECT TO THE BEST OF MY KNOWLEDGE AND BELIEF. THIS CERTIFICATION IS SUBMITTED IN SUPPORT OF A REQUEST FOR FINAL CERTIFICATE OF OCCUPANCY (FINAL C.O.).

THE RECORD INFORMATION PRESENTED HEREON IS NOT NECESSARILY COMPLETE AND INTENDED ONLY TO VERIFY SUBSTANTIAL COMPLIANCE OF THE GRADING AND DRAINAGE ASPECTS OF THIS PROJECT. THOSE RELYING ON THIS RECORD DOCUMENT ARE ADVISED TO OBTAIN INDEPENDENT VERIFICATION OF ITS ACCURACY BEFORE USING IT FOR ANY OTHER PURPOSE.



JEFFREY T. WOOTEEN, NMPE 16892

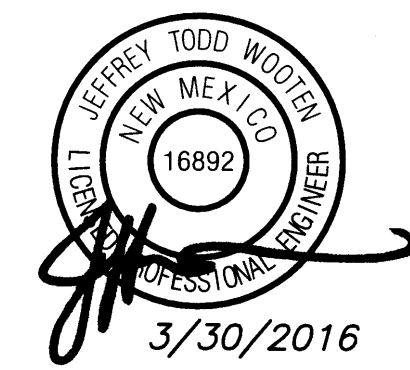

Wooten Engineering
1368 Reynosa Loop SE
Rio Rancho, NM 87124
Ph: 505.980.3560

REV	DATE	BY	REVISION
1	1/29/2016	JTW	Removed parking and increased Pond 'C' capacity.

MODULUS ARCHITECTS
220 COPPER AVE. N.W. SUITE 350
ALBUQUERQUE, NEW MEXICO 87102
PHONE (505) 338-1499 FAX (505) 338-1498

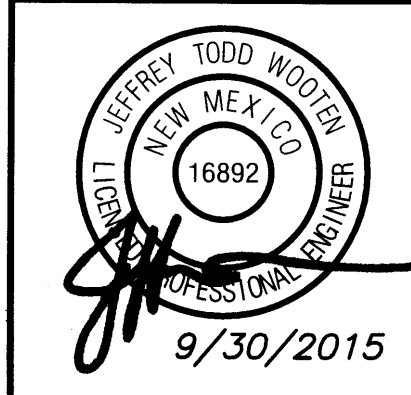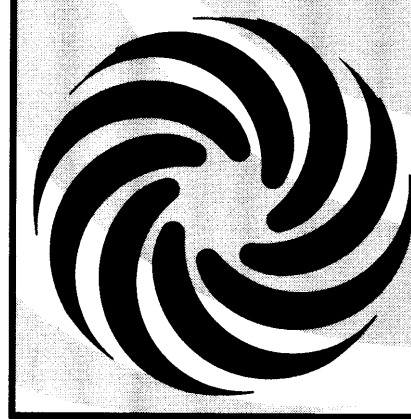


PROJECT TITLE	WEST CENTRAL-ATRISCO
DATE	9/22/15
JOB NO.	2015033
PROJECT MANAGER	JEFF WOOTEEN
DRAWN BY	JTW
SHEET TITLE	GRADING PLAN
SCALE	AS NOTED
SHEET NO.	1
OF	3

NOTICE TO CONTRACTORS

1. AN EXCAVATION/CONSTRUCTION PERMIT WILL BE REQUIRED BEFORE BEGINNING ANY WORK WITHIN CITY RIGHT-OF-WAY.
2. ALL WORK DETAILED ON THESE PLANS TO BE PERFORMED, EXCEPT AS OTHERWISE STATED OR PROVIDED HEREON, SHALL BE CONSTRUCTED IN ACCORDANCE WITH CITY OF ALBUQUERQUE INTERIM STANDARD SPECIFICATIONS FOR PUBLIC WORKS CONSTRUCTION, 1986 UPDATE NO. 8.
3. TWO WORKING DAYS PRIOR TO ANY EXCAVATION, CONTRACTOR MUST CONTACT NM ONE CALL FOR LOCATION OF EXISTING UTILITIES. (NM ONE CALL = "811")
4. PRIOR TO CONSTRUCTION, THE CONTRACTOR SHALL EXCAVATE AND VERIFY THE HORIZONTAL AND VERTICAL LOCATIONS OF ALL CONSTRUCTIONS. SHOULD A CONFLICT EXIST, THE CONTRACTOR SHALL NOTIFY THE ENGINEER SO THAT THE CONFLICT CAN BE RESOLVED WITH A MINIMUM AMOUNT OF DELAY.
5. BACKFILL COMPACTION SHALL BE ACCORDING TO TRAFFIC/STREET USE.
6. MAINTENANCE OF THESE FACILITIES SHALL BE THE RESPONSIBILITY OF THE OWNER OF THE PROPERTY SERVED.
7. WORK ON ARTERIAL STREETS SHALL BE PERFORMED ON A 24-HOUR BASIS.

CAUTION - NOTICE TO CONTRACTOR

THE CONTRACTOR IS SPECIFICALLY CAUTIONED THAT THE LOCATION AND/OR ELEVATION OF EXISTING UTILITIES AS SHOWN ON THESE PLANS IS BASED ON RECORDS OF THE VARIOUS UTILITY COMPANIES AND, WHERE POSSIBLE, MEASUREMENTS TAKEN IN THE FIELD. THE INFORMATION IS NOT TO BE RELIED ON AS BEING EXACT OR COMPLETE. THE CONTRACTOR MUST CALL THE APPROPRIATE UTILITY COMPANY AT LEAST 48 HOURS BEFORE ANY EXCAVATION TO REQUEST EXACT FIELD LOCATION OF UTILITIES. IT SHALL BE THE RESPONSIBILITY OF THE CONTRACTOR TO RELOCATE ALL EXISTING UTILITIES WHICH CONFLICT WITH THE PROPOSED IMPROVEMENTS SHOWN ON THE PLANS.

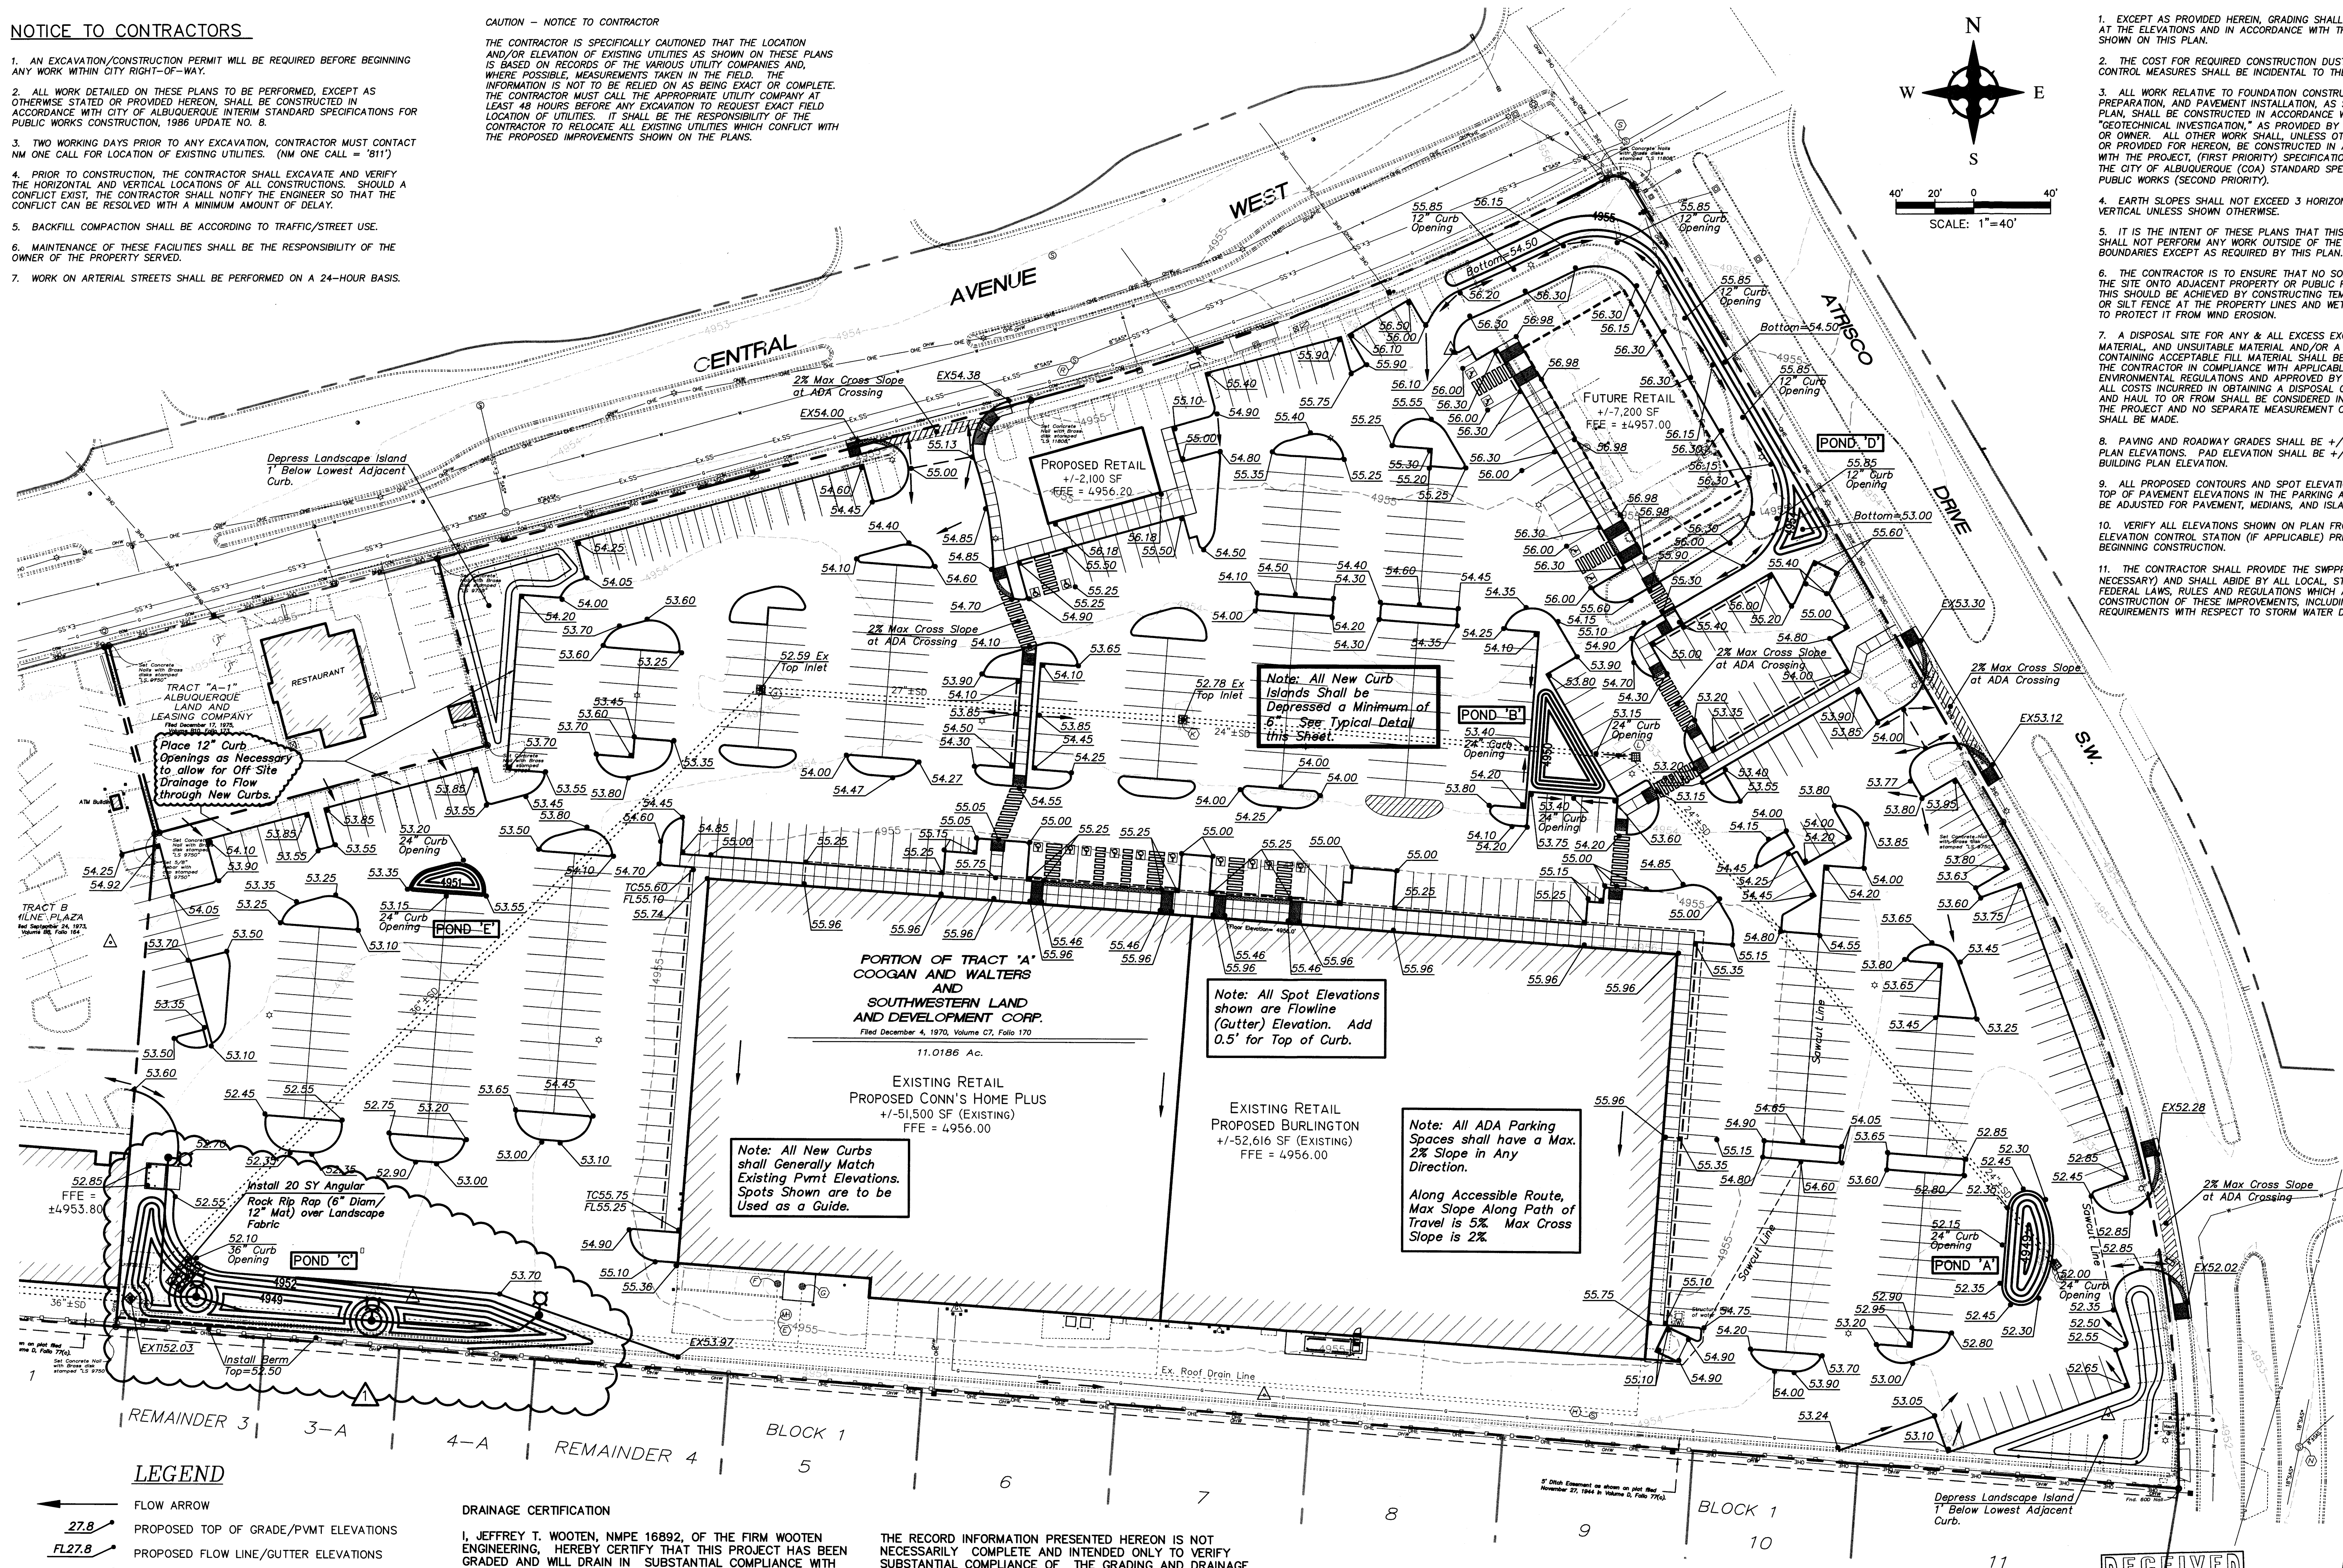

1. EXCEPT AS PROVIDED HEREIN, GRADING SHALL BE PERFORMED AT THE ELEVATIONS AND IN ACCORDANCE WITH THE DETAILS SHOWN ON THIS PLAN.
2. THE COST FOR REQUIRED CONSTRUCTION DUST AND EROSION CONTROL MEASURES SHALL BE INCIDENTAL TO THE PROJECT COST.
3. ALL WORK RELATIVE TO FOUNDATION CONSTRUCTION, SITE PREPARATION, AND PAVEMENT INSTALLATION, AS SHOWN ON THIS PLAN, SHALL BE CONSTRUCTED IN ACCORDANCE WITH THE "GEOTECHNICAL INVESTIGATION," AS PROVIDED BY THE ARCHITECT OR OWNER. ALL OTHER WORK SHALL, UNLESS OTHERWISE STATED OR PROVIDED FOR HEREON, BE CONSTRUCTED IN ACCORDANCE WITH THE PROJECT, (FIRST PRIORITY) SPECIFICATIONS, AND/OR THE CITY OF ALBUQUERQUE (COA) STANDARD SPECIFICATIONS FOR PUBLIC WORKS (SECOND PRIORITY).
4. EARTH SLOPES SHALL NOT EXCEED 3 HORIZONTAL TO 1 VERTICAL UNLESS SHOWN OTHERWISE.
5. IT IS THE INTENT OF THESE PLANS THAT THIS CONTRACTOR SHALL NOT PERFORM ANY WORK OUTSIDE OF THE PROPERTY BOUNDARIES EXCEPT AS REQUIRED BY THIS PLAN.
6. THE CONTRACTOR IS TO ENSURE THAT NO SOIL ERODES FROM THE SITE ONTO ADJACENT PROPERTY OR PUBLIC RIGHT-OF-WAY. THIS SHOULD BE ACHIEVED BY CONSTRUCTING TEMPORARY BERMS OR SILT FENCE AT THE PROPERTY LINES AND WETTING THE SOIL TO PROTECT IT FROM WIND EROSION.
7. A DISPOSAL SITE FOR ANY & ALL EXCESS EXCAVATION MATERIAL, AND UNSUITABLE MATERIAL AND/OR A BORROW SITE CONTAINING ACCEPTABLE FILL MATERIAL SHALL BE OBTAINED BY THE CONTRACTOR IN COMPLIANCE WITH APPLICABLE ENVIRONMENTAL REGULATIONS AND APPROVED BY THE OBSERVER. ALL COSTS INCURRED IN OBTAINING A DISPOSAL OR BORROW SITE AND HAUL TO OR FROM SHALL BE CONSIDERED INCIDENTAL TO THE PROJECT AND NO SEPARATE MEASUREMENT OR PAYMENT SHALL BE MADE.
8. PAVING AND ROADWAY GRADES SHALL BE +/- 0.05' FROM PLAN ELEVATIONS. PAD ELEVATION SHALL BE +/- 0.05' FROM BUILDING PLAN ELEVATION.
9. ALL PROPOSED CONTOURS AND SPOT ELEVATIONS REFLECT TOP OF PAVEMENT ELEVATIONS IN THE PARKING AREA AND MUST BE ADJUSTED FOR PAVEMENT, MEDIANS, AND ISLANDS.
10. VERIFY ALL ELEVATIONS SHOWN ON PLAN FROM BASIS OF ELEVATION CONTROL STATION (IF APPLICABLE) PRIOR TO BEGINNING CONSTRUCTION.
11. THE CONTRACTOR SHALL PROVIDE THE SWPPP DOCUMENT (IF NECESSARY) AND SHALL ABIDE BY ALL LOCAL, STATE, AND FEDERAL LAWS, RULES AND REGULATIONS WHICH APPLY TO THE CONSTRUCTION OF THESE IMPROVEMENTS, INCLUDING EPA REQUIREMENTS WITH RESPECT TO STORM WATER DISCHARGE.

LEGEND

- 27.8 FLOW ARROW
- FL27.8 PROPOSED TOP OF GRADE/PVMT ELEVATIONS
- TC27.8 PROPOSED FLOW LINE/GUTTER ELEVATIONS
- TC27.8 PROPOSED TOP OF CURB ELEVATIONS
- TC27.8 PROPOSED TOP OF GRATE ELEVATION
- 515 EXISTING CONTOUR
- 515 PROPOSED CONTOUR
- EXISTING STORM DRAIN
- FLOW LINE
- RIDGE LINE

DRAINAGE CERTIFICATION


I, JEFFREY T. WOOTEN, NMPE 16892, OF THE FIRM WOOTEN ENGINEERING, HEREBY CERTIFY THAT THIS PROJECT HAS BEEN GRADED AND WILL DRAIN IN SUBSTANTIAL COMPLIANCE WITH AND IN ACCORDANCE WITH THE DESIGN INTENT OF THE APPROVED PLAN DATED 09/30/15. I FURTHER CERTIFY THAT I PERSONALLY VISITED THE PROJECT SITE ON 12/30/15 AND HAVE DETERMINED BY VISUAL INSPECTION THAT THE IMPROVEMENTS INSTALLED TO DATE ARE REPRESENTATIVE OF ACTUAL SITE CONDITIONS AND IS TRUE AND CORRECT TO THE BEST OF MY KNOWLEDGE AND BELIEF. THIS CERTIFICATION IS SUBMITTED IN SUPPORT OF A REQUEST FOR TEMPORARY CERTIFICATE OF OCCUPANCY (TEMP C.O.). WE ARE AWAITING SURVEY DATA FOR THE NEW PONDS THAT WERE INSTALLED TO CONFIRM VOLUMES AND WILL SUBMIT FOR PERMANENT CERTIFICATE OF OCCUPANCY AT THAT TIME.

THE RECORD INFORMATION PRESENTED HEREON IS NOT NECESSARILY COMPLETE AND INTENDED ONLY TO VERIFY SUBSTANTIAL COMPLIANCE OF THE GRADING AND DRAINAGE ASPECTS OF THIS PROJECT. THOSE RELYING ON THIS RECORD DOCUMENT ARE ADVISED TO OBTAIN INDEPENDENT VERIFICATION OF ITS ACCURACY BEFORE USING IT FOR ANY OTHER PURPOSE.

JEFFREY T. WOOTEN, NMPE 16892




3/10/2016

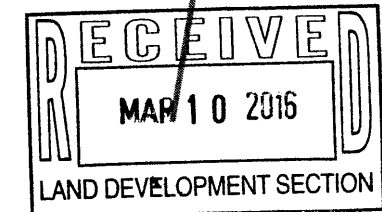

Wooten Engineering
1368 Reynosa Loop SE
Rio Rancho, NM 87124
Ph: 505.980.3560

REV	DATE	BY	REVISION
1	1/29/2016	JTW	Removed parking and increased Pond 'C' capacity.
2			
3			
4			

MODULUS ARCHITECTS
220 COPPER AVE. N.W. SUITE 350
ALBUQUERQUE, NEW MEXICO 87102
PHONE (505) 338-1499 FAX (505) 338-1498

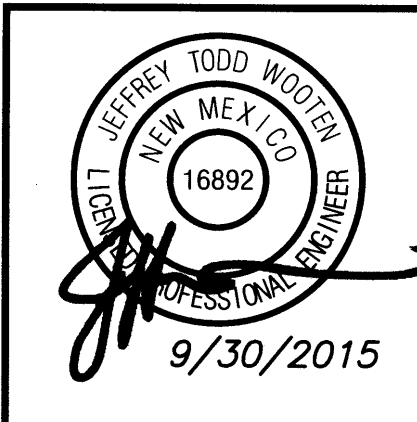


PROJECT TITLE	WEST CENTRAL-ATRISCO
PROJECT ADDRESS	4208 CENTRAL AVE. SW ALBUQUERQUE NEW MEXICO
PROJECT MANAGER	JEFF WOOTEN
JOB NO.	2015033
DRAWN BY:	JTW
SHEET TITLE	GRADING PLAN
DATE:	9/22/15
SCALE:	AS NOTED
SHEET NO.	1
TOTAL SHEETS	3

NOTICE TO CONTRACTORS

1. AN EXCAVATION/CONSTRUCTION PERMIT WILL BE REQUIRED BEFORE BEGINNING ANY WORK WITHIN CITY RIGHT-OF-WAY.
2. ALL WORK DETAILED ON THESE PLANS TO BE PERFORMED, EXCEPT AS OTHERWISE STATED OR PROVIDED HEREON, SHALL BE CONSTRUCTED IN ACCORDANCE WITH CITY OF ALBUQUERQUE INTERIM STANDARD SPECIFICATIONS FOR PUBLIC WORKS CONSTRUCTION, 1986 UPDATE NO. 8.
3. TWO WORKING DAYS PRIOR TO ANY EXCAVATION, CONTRACTOR MUST CONTACT NM ONE CALL FOR LOCATION OF EXISTING UTILITIES. (NM ONE CALL = "811")
4. PRIOR TO CONSTRUCTION, THE CONTRACTOR SHALL EXCAVATE AND VERIFY THE HORIZONTAL AND VERTICAL LOCATIONS OF ALL CONSTRUCTIONS. SHOULD A CONFLICT EXIST, THE CONTRACTOR SHALL NOTIFY THE ENGINEER SO THAT THE CONFLICT CAN BE RESOLVED WITH A MINIMUM AMOUNT OF DELAY.
5. BACKFILL COMPACTION SHALL BE ACCORDING TO TRAFFIC/STREET USE.
6. MAINTENANCE OF THESE FACILITIES SHALL BE THE RESPONSIBILITY OF THE OWNER OF THE PROPERTY SERVED.
7. WORK ON ARTERIAL STREETS SHALL BE PERFORMED ON A 24-HOUR BASIS.

CAUTION - NOTICE TO CONTRACTOR

THE CONTRACTOR IS SPECIFICALLY CAUTIONED THAT THE LOCATION AND/OR ELEVATION OF EXISTING UTILITIES AS SHOWN ON THESE PLANS IS BASED ON RECORDS OF THE VARIOUS UTILITY COMPANIES AND, WHERE POSSIBLE, MEASUREMENTS TAKEN IN THE FIELD. THE INFORMATION IS NOT TO BE RELIED ON AS BEING EXACT OR COMPLETE. THE CONTRACTOR MUST CALL THE APPROPRIATE UTILITY COMPANY AT LEAST 48 HOURS BEFORE ANY EXCAVATION TO REQUEST EXACT FIELD LOCATION OF UTILITIES. IT SHALL BE THE RESPONSIBILITY OF THE CONTRACTOR TO RELOCATE ALL EXISTING UTILITIES WHICH CONFLICT WITH THE PROPOSED IMPROVEMENTS SHOWN ON THE PLANS.

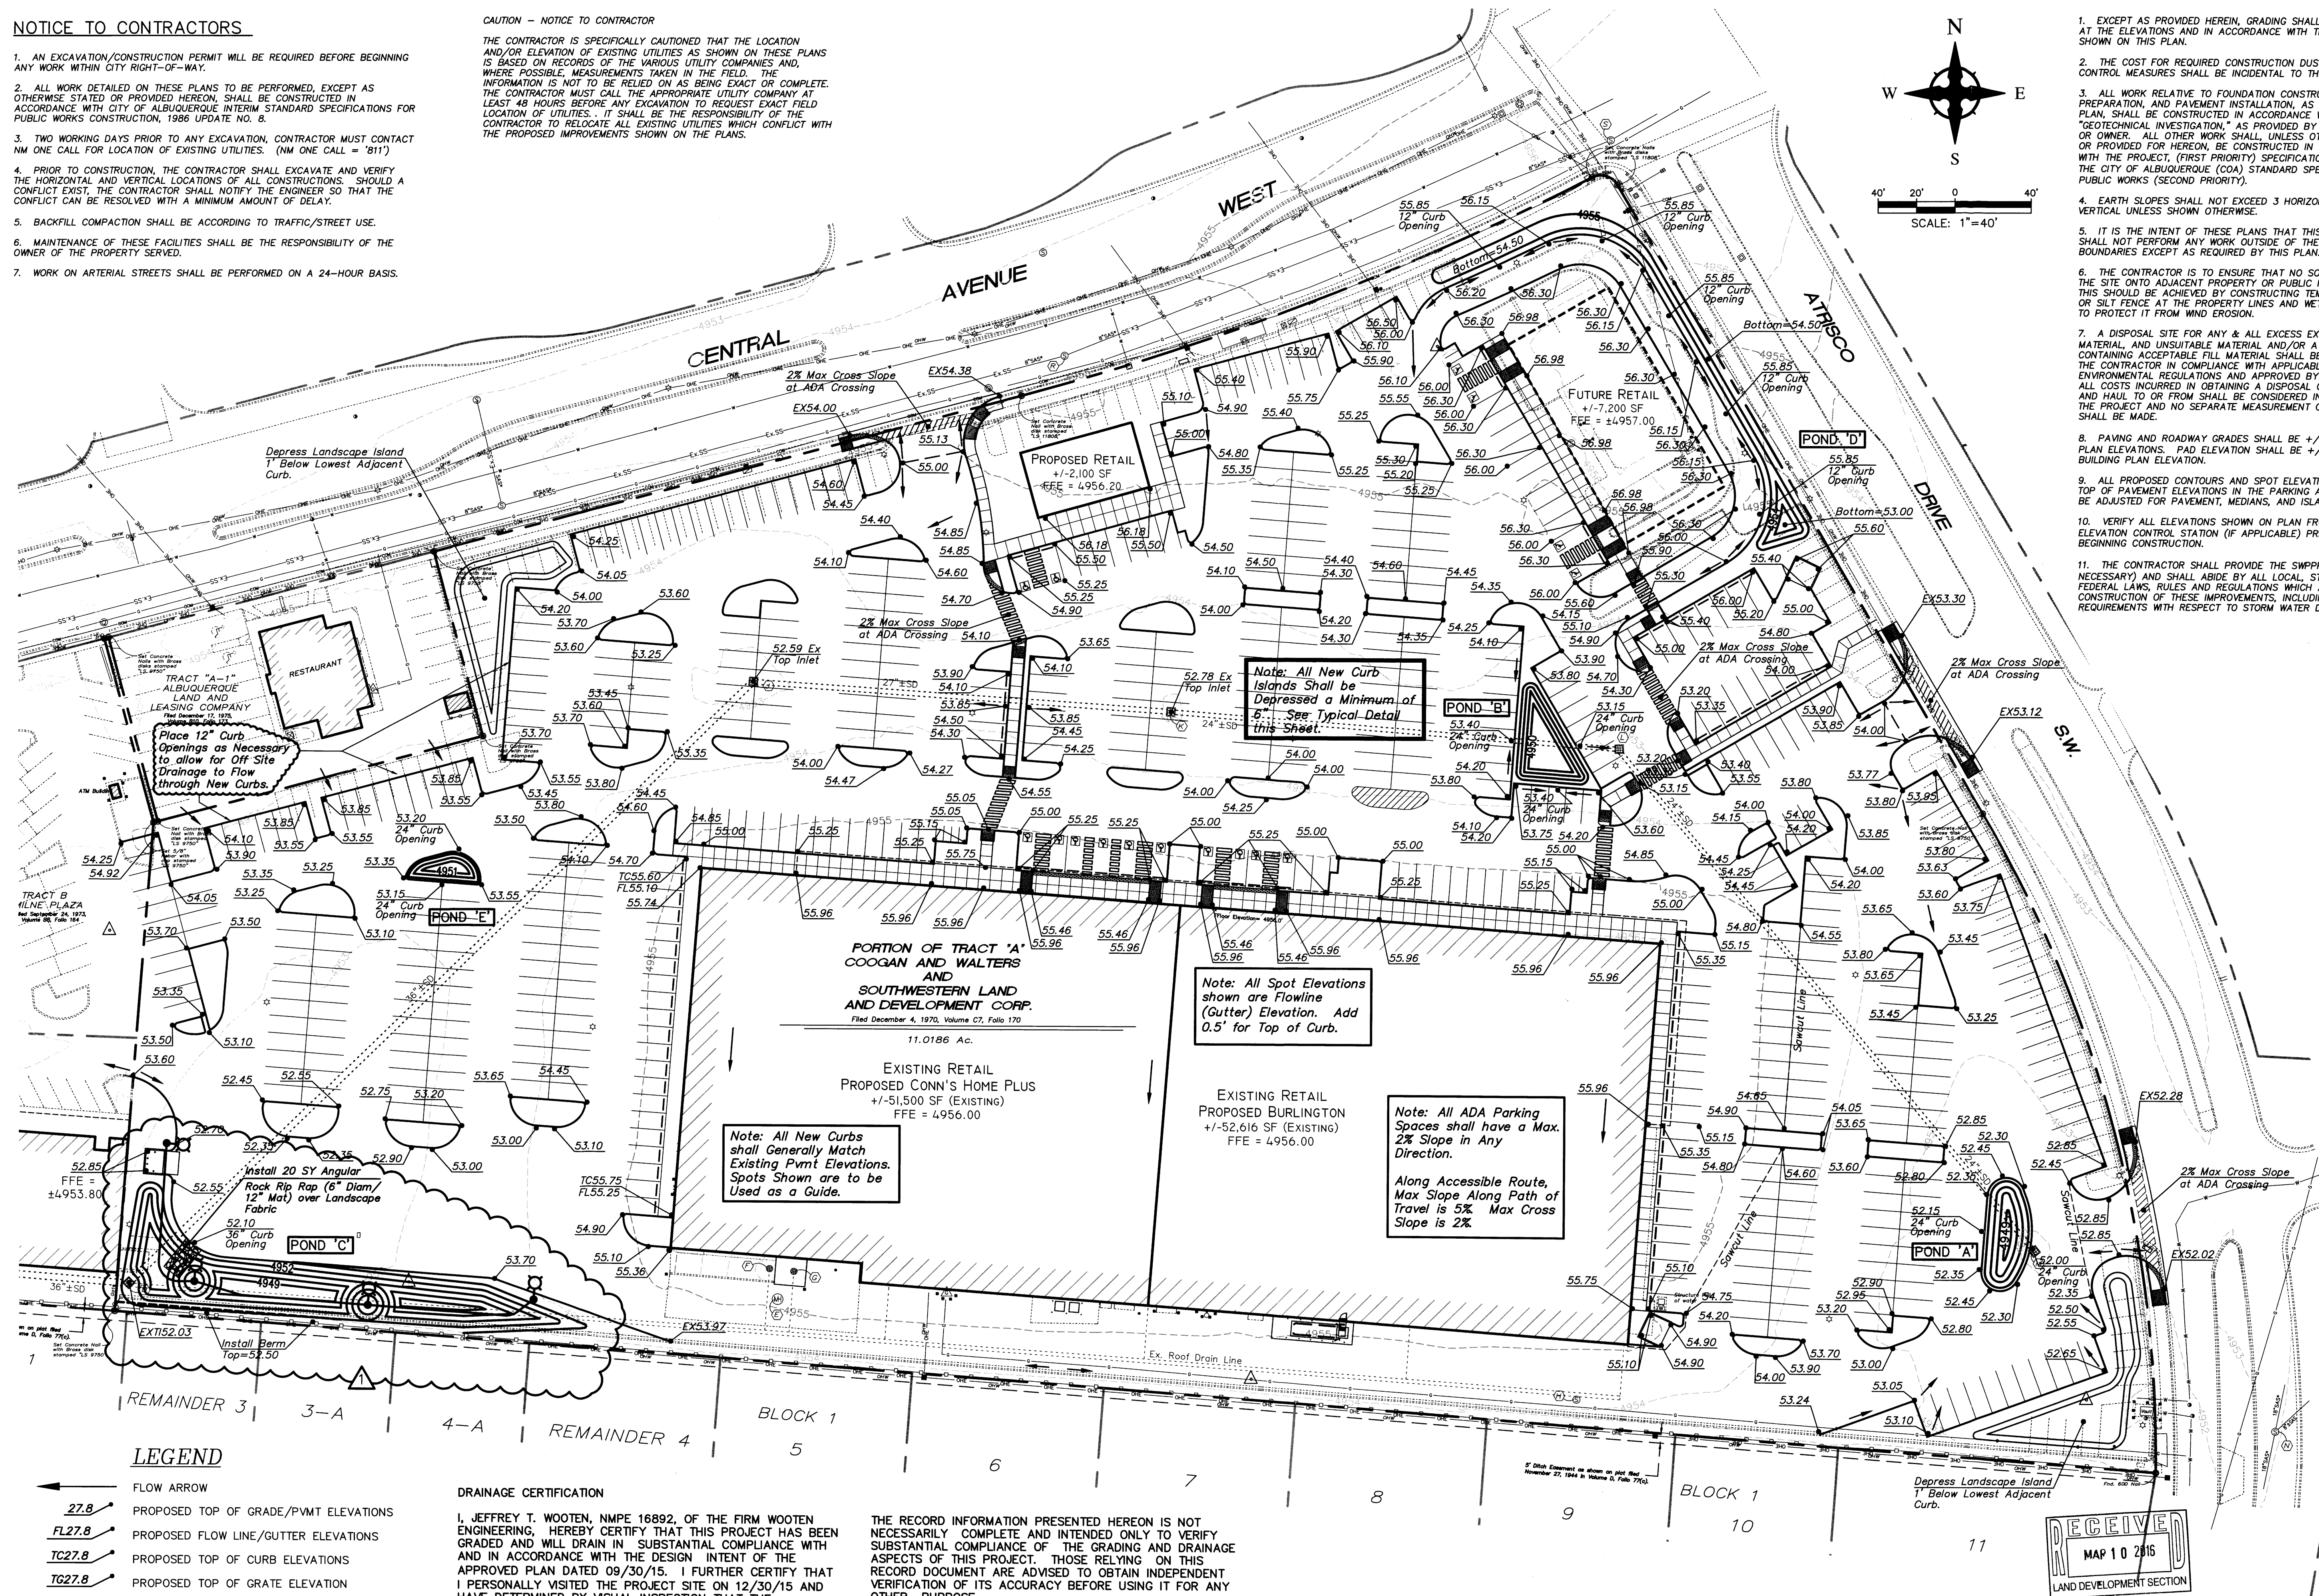

LEGEND

- FLOW ARROW
- 27.8 PROPOSED TOP OF GRADE/PVMT ELEVATIONS
- FL27.8 PROPOSED FLOW LINE/GUTTER ELEVATIONS
- TC27.8 PROPOSED TOP OF CURB ELEVATIONS
- TG27.8 PROPOSED TOP OF GRATE ELEVATION
- 515 EXISTING CONTOUR
- 515 PROPOSED CONTOUR
- EXISTING STORM DRAIN
- FLOW LINE
- RIDGE LINE

DRAINAGE CERTIFICATION

I, JEFFREY T. WOOTEEN, NMPE 16892, OF THE FIRM WOOTEEN ENGINEERING, HEREBY CERTIFY THAT THIS PROJECT HAS BEEN GRADED AND WILL DRAIN IN SUBSTANTIAL COMPLIANCE WITH AND IN ACCORDANCE WITH THE DESIGN INTENT OF THE APPROVED PLAN DATED 09/30/15. I FURTHER CERTIFY THAT I PERSONALLY VISITED THE PROJECT SITE ON 12/30/15 AND HAVE DETERMINED BY VISUAL INSPECTION THAT THE IMPROVEMENTS INSTALLED TO DATE ARE REPRESENTATIVE OF ACTUAL SITE CONDITIONS AND IS TRUE AND CORRECT TO THE BEST OF MY KNOWLEDGE AND BELIEF. THIS CERTIFICATION IS SUBMITTED IN SUPPORT OF A REQUEST FOR TEMPORARY CERTIFICATE OF OCCUPANCY (TEMP C.O.). WE ARE AWAITING SURVEY DATA FOR THE NEW PONDS THAT WERE INSTALLED TO CONFIRM VOLUMES AND WILL SUBMIT FOR PERMANENT CERTIFICATE OF OCCUPANCY AT THAT TIME.

THE RECORD INFORMATION PRESENTED HEREON IS NOT NECESSARILY COMPLETE AND INTENDED ONLY TO VERIFY SUBSTANTIAL COMPLIANCE OF THE GRADING AND DRAINAGE ASPECTS OF THIS PROJECT. THOSE RELYING ON THIS RECORD DOCUMENT ARE ADVISED TO OBTAIN INDEPENDENT VERIFICATION OF ITS ACCURACY BEFORE USING IT FOR ANY OTHER PURPOSE.

JEFFREY T. WOOTEEN, NMPE 16892



1. EXCEPT AS PROVIDED HEREIN, GRADING SHALL BE PERFORMED AT THE ELEVATIONS AND IN ACCORDANCE WITH THE DETAILS SHOWN ON THIS PLAN.
2. THE COST FOR REQUIRED CONSTRUCTION DUST AND EROSION CONTROL MEASURES SHALL BE INCIDENTAL TO THE PROJECT COST.
3. ALL WORK RELATIVE TO FOUNDATION CONSTRUCTION, SITE PREPARATION, AND PAVEMENT INSTALLATION, AS SHOWN ON THIS PLAN, SHALL BE CONSTRUCTED IN ACCORDANCE WITH THE "GEOTECHNICAL INVESTIGATION," AS PROVIDED BY THE ARCHITECT OR OWNER. ALL OTHER WORK SHALL, UNLESS OTHERWISE STATED OR PROVIDED FOR HEREON, BE CONSTRUCTED IN ACCORDANCE WITH THE PROJECT, (FIRST PRIORITY) SPECIFICATIONS, AND/OR THE CITY OF ALBUQUERQUE (COA) STANDARD SPECIFICATIONS FOR PUBLIC WORKS (SECOND PRIORITY).
4. EARTH SLOPES SHALL NOT EXCEED 3 HORIZONTAL TO 1 VERTICAL UNLESS SHOWN OTHERWISE.
5. IT IS THE INTENT OF THESE PLANS THAT THIS CONTRACTOR SHALL NOT PERFORM ANY WORK OUTSIDE OF THE PROPERTY BOUNDARIES EXCEPT AS REQUIRED BY THIS PLAN.
6. THE CONTRACTOR IS TO ENSURE THAT NO SOIL ERODES FROM THE SITE ONTO ADJACENT PROPERTY OR PUBLIC RIGHT-OF-WAY. THIS SHOULD BE ACHIEVED BY CONSTRUCTING TEMPORARY BERMS OR SILT FENCE AT THE PROPERTY LINES AND WETTING THE SOIL TO PROTECT IT FROM WIND EROSION.
7. A DISPOSAL SITE FOR ANY & ALL EXCESS EXCAVATION MATERIAL, AND UNSUITABLE MATERIAL AND/OR A BORROW SITE CONTAINING ACCEPTABLE FILL MATERIAL SHALL BE OBTAINED BY THE CONTRACTOR IN COMPLIANCE WITH APPLICABLE ENVIRONMENTAL REGULATIONS AND APPROVED BY THE OBSERVER. ALL COSTS INCURRED IN OBTAINING A DISPOSAL OR BORROW SITE AND HAUL TO OR FROM SHALL BE CONSIDERED INCIDENTAL TO THE PROJECT AND NO SEPARATE MEASUREMENT OR PAYMENT SHALL BE MADE.
8. PAVING AND ROADWAY GRADES SHALL BE +/- 0.05' FROM PLAN ELEVATIONS. PAD ELEVATION SHALL BE +/- 0.05' FROM BUILDING PLAN ELEVATION.
9. ALL PROPOSED CONTOURS AND SPOT ELEVATIONS REFLECT TOP OF PAVEMENT ELEVATIONS IN THE PARKING AREA AND MUST BE ADJUSTED FOR PAVEMENT, MEDIANS, AND ISLANDS.
10. VERIFY ALL ELEVATIONS SHOWN ON PLAN FROM BASIS OF ELEVATION CONTROL STATION (IF APPLICABLE) PRIOR TO BEGINNING CONSTRUCTION.
11. THE CONTRACTOR SHALL PROVIDE THE SWPPP DOCUMENT (IF NECESSARY) AND SHALL ABIDE BY ALL LOCAL, STATE, AND FEDERAL LAWS, RULES AND REGULATIONS WHICH APPLY TO THE CONSTRUCTION OF THESE IMPROVEMENTS, INCLUDING EPA REQUIREMENTS WITH RESPECT TO STORM WATER DISCHARGE.

MODULUS ARCHITECTS
220 COPPER AVE. N.W. SUITE 350
ALBUQUERQUE, NEW MEXICO 87102
PHONE (505) 338-1499 FAX (505) 338-1498



9/30/2015

PROJECT TITLE: WEST CENTRAL-ATRISCO
4208 CENTRAL AVE. SW
ALBUQUERQUE NEW MEXICO
PROJECT MANAGER: JEFF WOOTEEN
JOB NO.: 2015033
DRAWN BY: JTW
SHEET TITLE: GRADING PLAN

DATE: 9/22/15
SCALE: AS NOTED
SHEET: 1
C1.1
3



Wooten Engineering
1368 Reynosa Loop SE
Rio Rancho, NM 87124
Ph: 505.980.3560

NOTICE TO CONTRACTORS

1. AN EXCAVATION/CONSTRUCTION PERMIT WILL BE REQUIRED BEFORE BEGINNING ANY WORK WITHIN CITY RIGHT-OF-WAY.
2. ALL WORK DETAILED ON THESE PLANS TO BE PERFORMED, EXCEPT AS OTHERWISE STATED OR PROVIDED HEREON, SHALL BE CONSTRUCTED IN ACCORDANCE WITH CITY OF ALBUQUERQUE INTERIM STANDARD SPECIFICATIONS FOR PUBLIC WORKS CONSTRUCTION, 1986 UPDATE NO. 8.
3. TWO WORKING DAYS PRIOR TO ANY EXCAVATION, CONTRACTOR MUST CONTACT NM ONE CALL FOR LOCATION OF EXISTING UTILITIES. (NM ONE CALL = 811)
4. PRIOR TO CONSTRUCTION, THE CONTRACTOR SHALL EXCAVATE AND VERIFY THE HORIZONTAL AND VERTICAL LOCATIONS OF ALL CONSTRUCTIONS. SHOULD A CONFLICT EXIST, THE CONTRACTOR SHALL NOTIFY THE ENGINEER SO THAT THE CONFLICT CAN BE RESOLVED WITH A MINIMUM AMOUNT OF DELAY.
5. BACKFILL COMPACTION SHALL BE ACCORDING TO TRAFFIC/STREET USE.
6. MAINTENANCE OF THESE FACILITIES SHALL BE THE RESPONSIBILITY OF THE OWNER OF THE PROPERTY SERVED.
7. WORK ON ARTERIAL STREETS SHALL BE PERFORMED ON A 24-HOUR BASIS.

CAUTION - NOTICE TO CONTRACTOR

THE CONTRACTOR IS SPECIFICALLY CAUTIONED THAT THE LOCATION AND/OR ELEVATION OF EXISTING UTILITIES AS SHOWN ON THESE PLANS IS BASED ON RECORDS OF THE VARIOUS UTILITY COMPANIES AND, WHERE POSSIBLE, MEASUREMENTS TAKEN IN THE FIELD. THE INFORMATION IS NOT TO BE RELIED ON AS BEING EXACT OR COMPLETE. THE CONTRACTOR MUST CALL THE APPROPRIATE UTILITY COMPANY AT LEAST 48 HOURS BEFORE ANY EXCAVATION TO REQUEST EXACT FIELD LOCATION OF UTILITIES. IT SHALL BE THE RESPONSIBILITY OF THE CONTRACTOR TO RELOCATE ALL EXISTING UTILITIES WHICH CONFLICT WITH THE PROPOSED IMPROVEMENTS SHOWN ON THE PLANS.

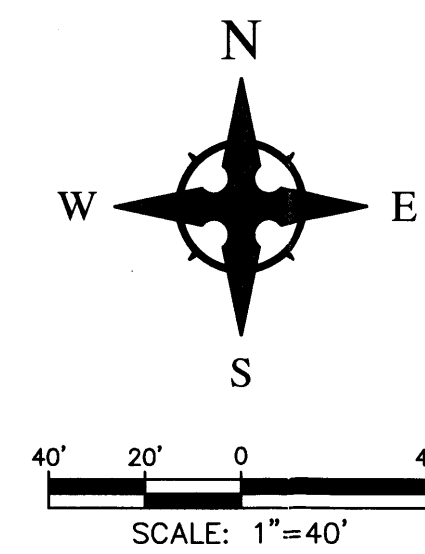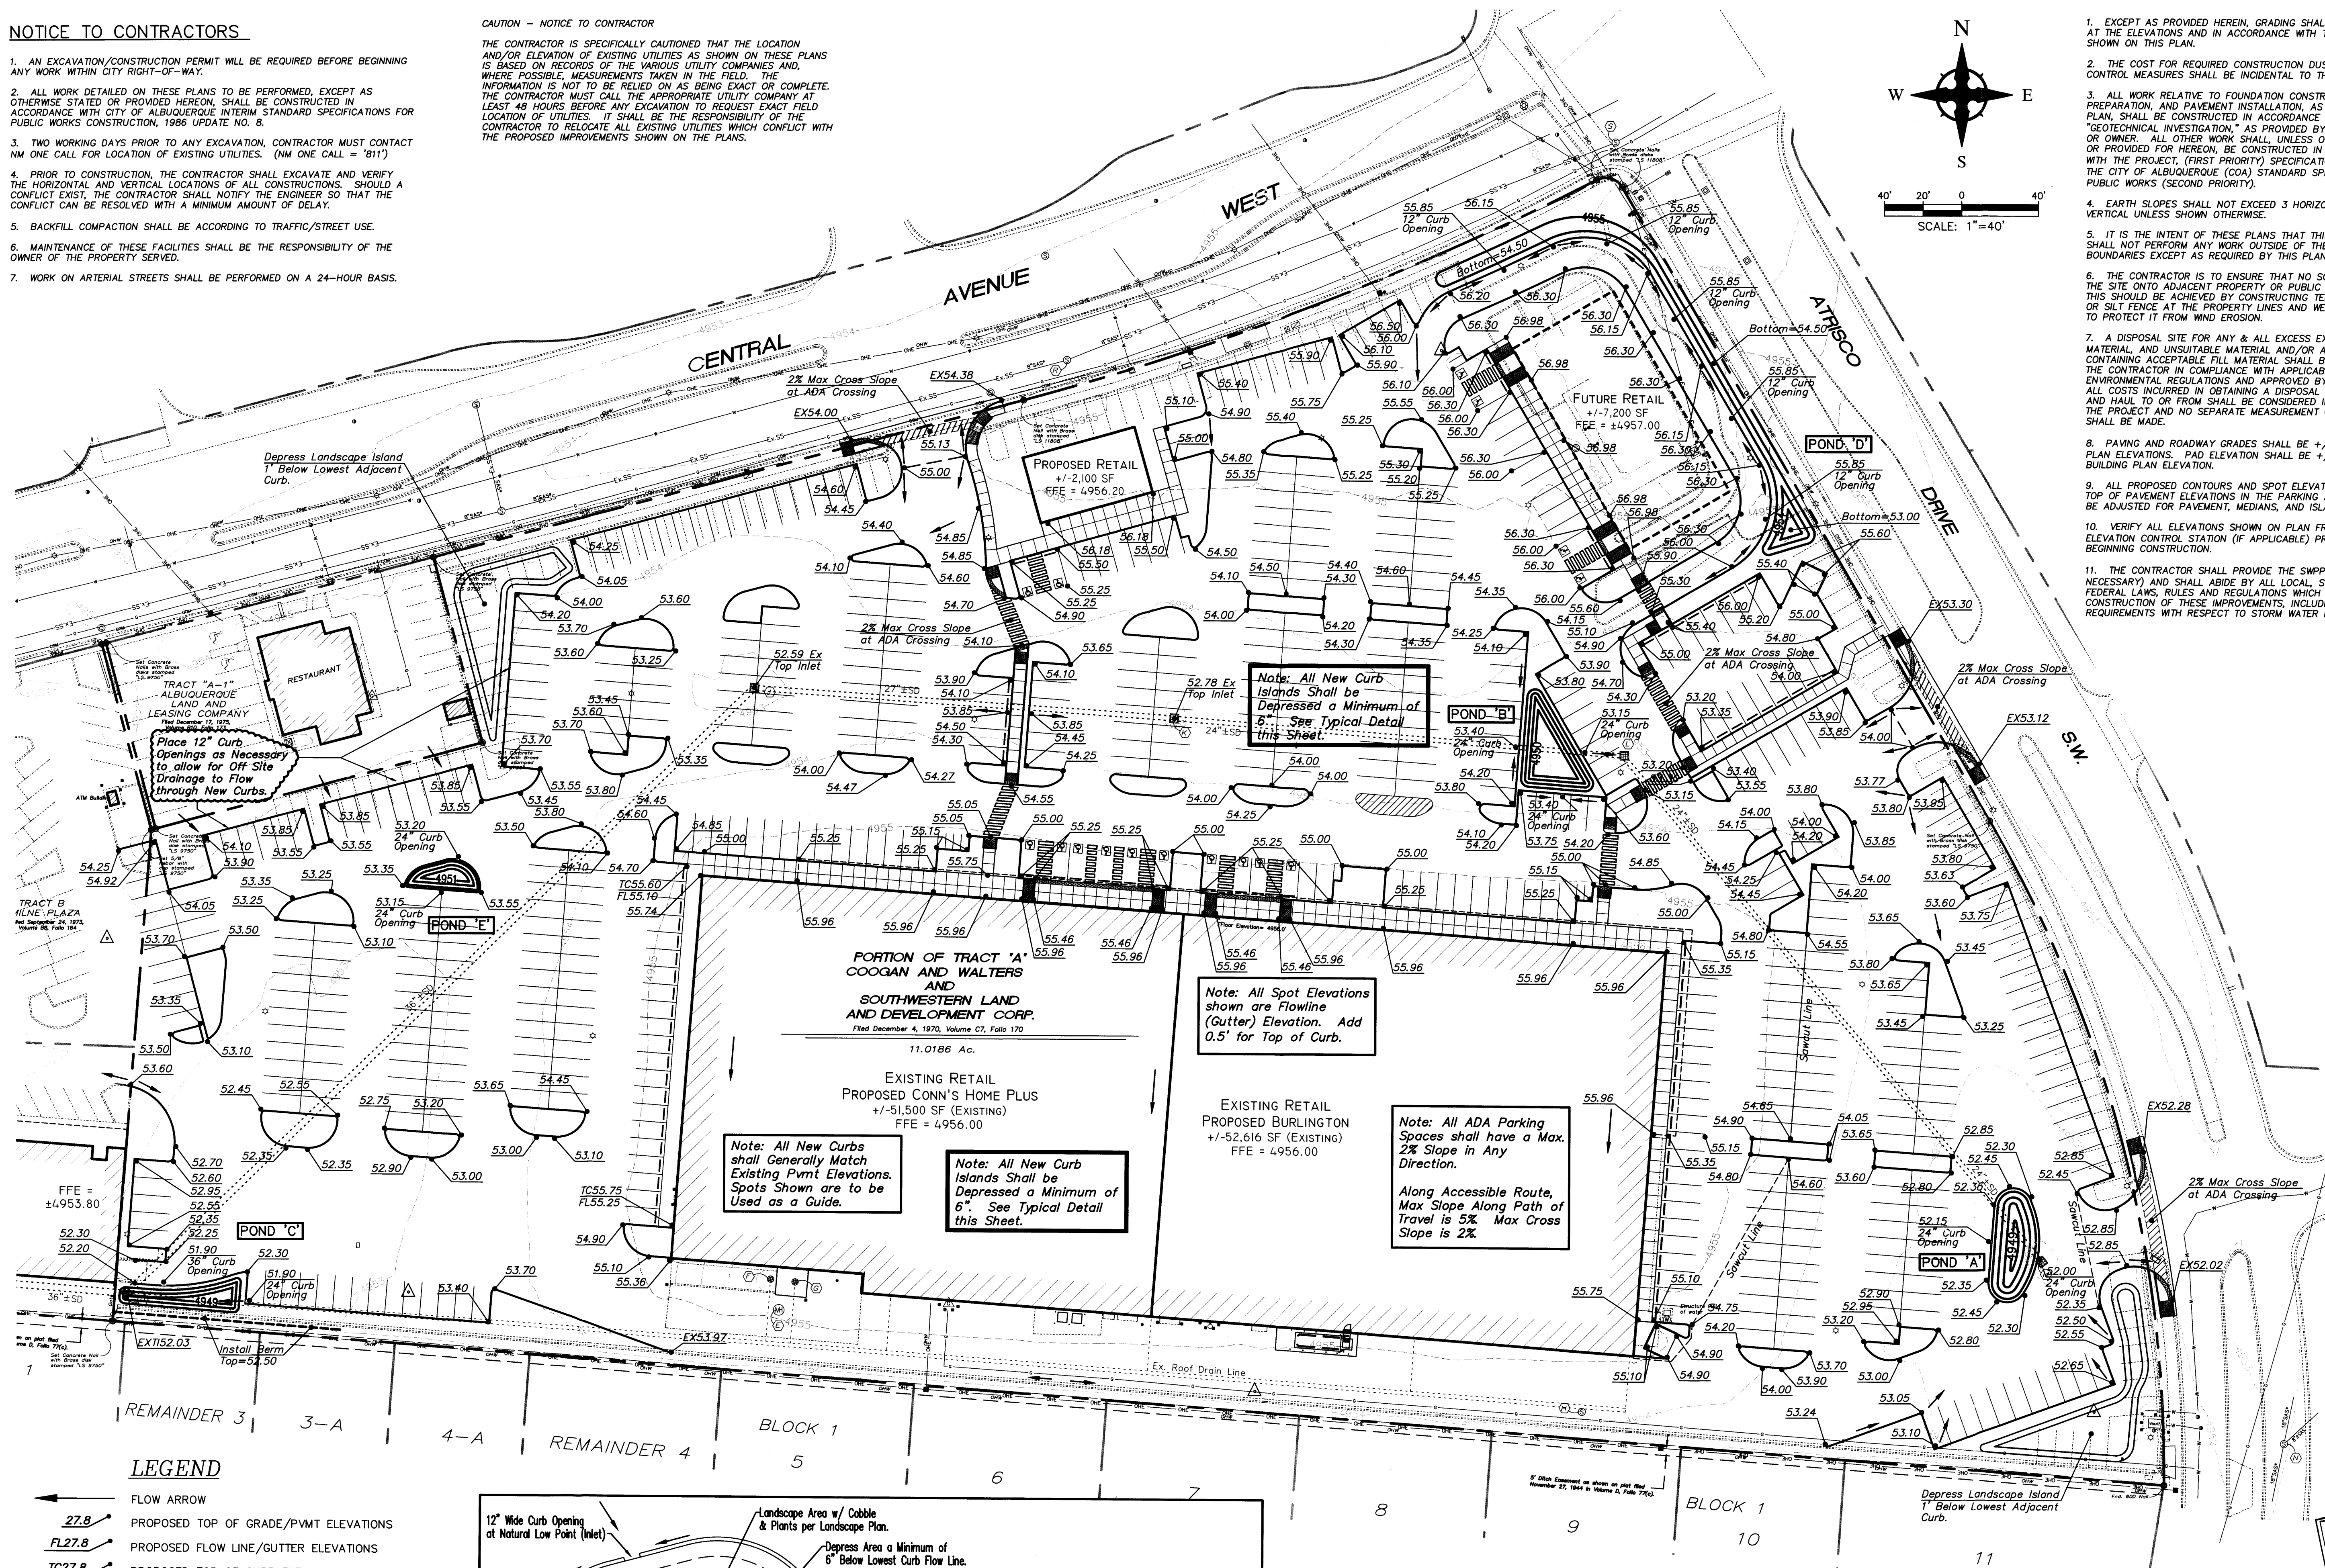

1. EXCEPT AS PROVIDED HEREIN, GRADING SHALL BE PERFORMED AT THE ELEVATIONS AND IN ACCORDANCE WITH THE DETAILS SHOWN ON THIS PLAN.
2. THE COST FOR REQUIRED CONSTRUCTION DUST AND EROSION CONTROL MEASURES SHALL BE INCIDENTAL TO THE PROJECT COST.
3. ALL WORK RELATIVE TO FOUNDATION CONSTRUCTION, SITE PREPARATION, AND PAVEMENT INSTALLATION, AS SHOWN ON THIS PLAN, SHALL BE CONSTRUCTED IN ACCORDANCE WITH THE "GEOTECHNICAL INVESTIGATION," AS PROVIDED BY THE ARCHITECT OR OWNER. ALL OTHER WORK SHALL, UNLESS OTHERWISE STATED OR PROVIDED FOR HEREON, BE CONSTRUCTED IN ACCORDANCE WITH THE PROJECT, (FIRST PRIORITY) SPECIFICATIONS, AND/OR THE CITY OF ALBUQUERQUE (COA) STANDARD SPECIFICATIONS FOR PUBLIC WORKS (SECOND PRIORITY).
4. EARTH SLOPES SHALL NOT EXCEED 3 HORIZONTAL TO 1 VERTICAL UNLESS SHOWN OTHERWISE.
5. IT IS THE INTENT OF THESE PLANS THAT THIS CONTRACTOR SHALL NOT PERFORM ANY WORK OUTSIDE OF THE PROPERTY BOUNDARIES EXCEPT AS REQUIRED BY THIS PLAN.
6. THE CONTRACTOR IS TO ENSURE THAT NO SOIL ERODES FROM THE SITE ONTO ADJACENT PROPERTY OR PUBLIC RIGHT-OF-WAY. THIS SHOULD BE ACHIEVED BY CONSTRUCTING TEMPORARY BERM OR SILT FENCE AT THE PROPERTY LINES AND WETTING THE SOIL TO PROTECT IT FROM WIND EROSION.
7. A DISPOSAL SITE FOR ANY & ALL EXCESS EXCAVATION MATERIAL AND UNSUITABLE MATERIAL AND/OR A BORROW SITE CONTAINING ACCEPTABLE FILL MATERIAL SHALL BE OBTAINED BY THE CONTRACTOR IN COMPLIANCE WITH APPLICABLE ENVIRONMENTAL REGULATIONS AND APPROVED BY THE OBSERVER. ALL COSTS INCURRED IN OBTAINING A DISPOSAL OR BORROW SITE AND HAIL TO OR FROM SHALL BE CONSIDERED INCIDENTAL TO THE PROJECT AND NO SEPARATE MEASUREMENT OR PAYMENT SHALL BE MADE.
8. PAVING AND ROADWAY GRADES SHALL BE $\pm 0.05'$ FROM PLAN ELEVATIONS. PAD ELEVATION SHALL BE $\pm 0.05'$ FROM BUILDING PLAN ELEVATION.
9. ALL PROPOSED CONTOURS AND SPOT ELEVATIONS REFLECT TOP OF PAVEMENT ELEVATIONS IN THE PARKING AREA AND MUST BE ADJUSTED FOR PAVEMENT, MEDIANS, AND ISLANDS.
10. VERIFY ALL ELEVATIONS SHOWN ON PLAN FROM BASIS OF ELEVATION CONTROL STATION (IF APPLICABLE) PRIOR TO BEGINNING CONSTRUCTION.
11. THE CONTRACTOR SHALL PROVIDE THE SWPPP DOCUMENT (IF NECESSARY) AND SHALL ABIDE BY ALL LOCAL, STATE, AND FEDERAL LAWS, RULES AND REGULATIONS WHICH APPLY TO THE CONSTRUCTION OF THESE IMPROVEMENTS, INCLUDING EPA REQUIREMENTS WITH RESPECT TO STORM WATER DISCHARGE.

MODULUS ARCHITECTS
220 COPPER AVE. N.W. SUITE 350
ALBUQUERQUE, NEW MEXICO 87102
PHONE (505) 338-1499 FAX (505) 338-1498



PROJECT TITLE WEST CENTRAL - ATRISCO 4208 CENTRAL AVE. SW ALBUQUERQUE NEW MEXICO	DRAWN BY: JTW
JOB NO. 2015033	SHEET TITLE GRADING PLAN





Wooten Engineering
1368 Reynosa Loop SE
Rio Rancho, NM 87124
Ph: 505.980.3560

DATE 9/22/15	SHEET 1
SCALE AS NOTED	C1.1

LEGEND


- 27.8 FLOW ARROW
- FL27.8 PROPOSED TOP OF GRADE/PVMT ELEVATIONS
- TC27.8 PROPOSED FLOW LINE/GUTTER ELEVATIONS
- TC27.8 PROPOSED TOP OF CURB ELEVATIONS
- TC27.8 PROPOSED TOP OF GRATE ELEVATION
- 515- EXISTING CONTOUR
- 515- PROPOSED CONTOUR
- EXISTING STORM DRAIN
- FLOW LINE
- RIDGE LINE

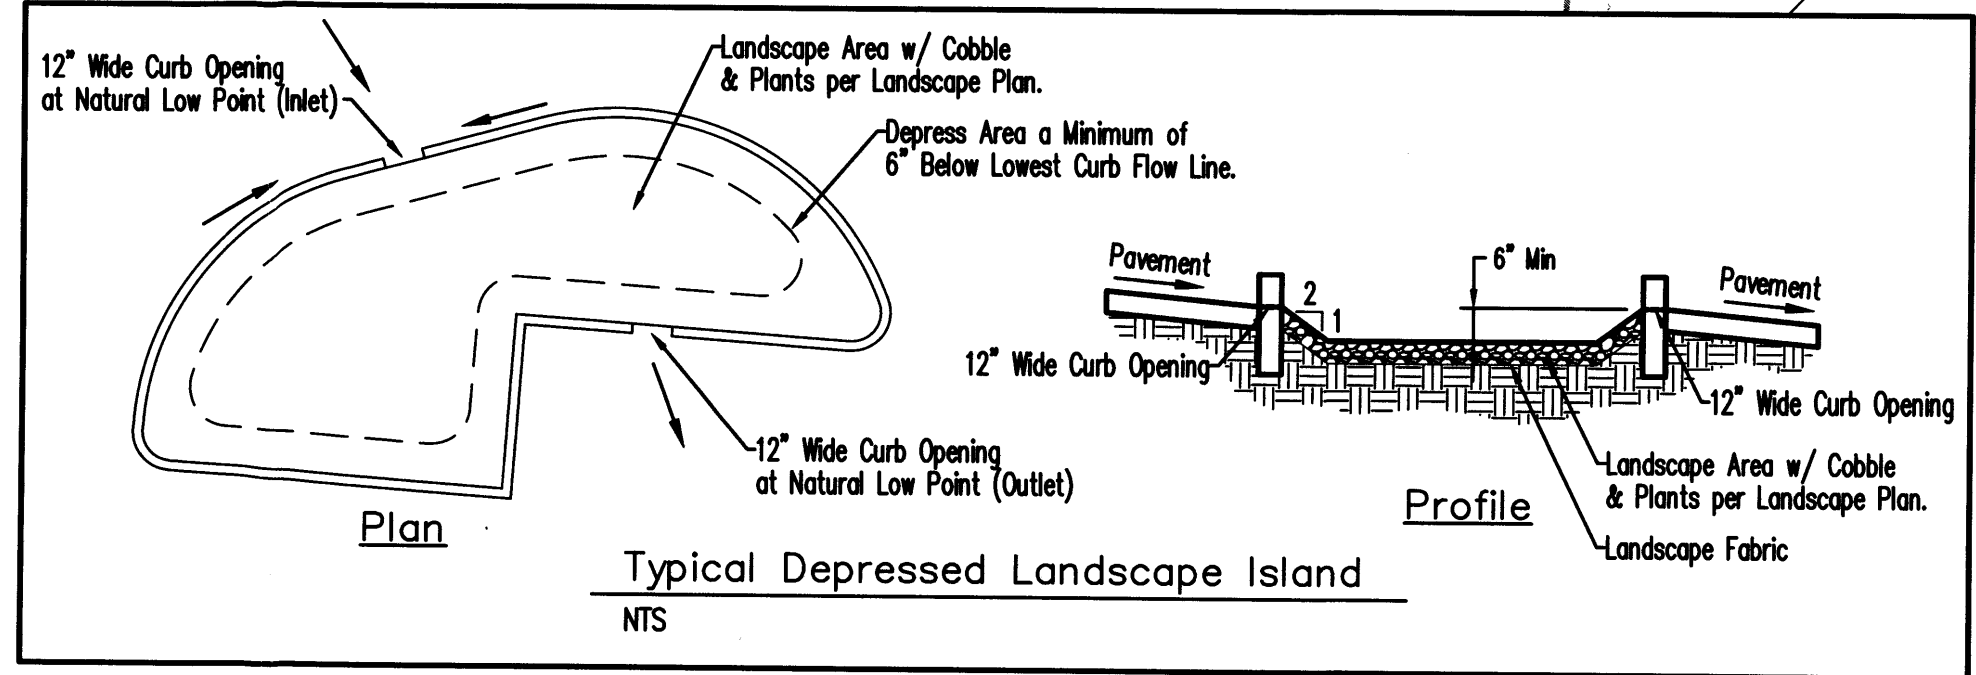

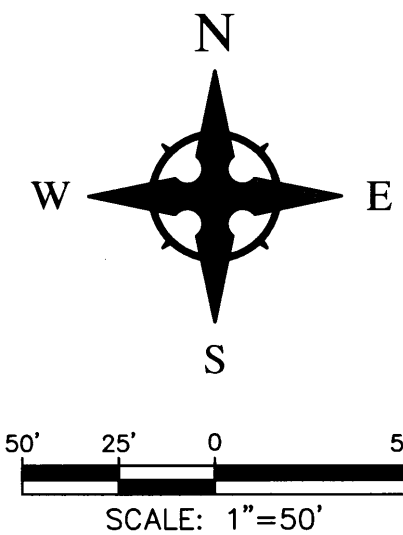

CAUTION - NOTICE TO CONTRACTOR

THE CONTRACTOR IS SPECIFICALLY CAUTIONED THAT THE LOCATION AND/OR ELEVATION OF EXISTING UTILITIES AS SHOWN ON THESE PLANS IS BASED ON RECORDS OF THE VARIOUS UTILITY COMPANIES AND, WHERE POSSIBLE, MEASUREMENTS TAKEN IN THE FIELD. THE INFORMATION IS NOT TO BE RELIED ON AS BEING EXACT OR COMPLETE. THE CONTRACTOR MUST CALL THE APPROPRIATE UTILITY COMPANY AT LEAST 48 HOURS BEFORE ANY EXCAVATION TO REQUEST EXACT FIELD LOCATION OF UTILITIES. IT SHALL BE THE RESPONSIBILITY OF THE CONTRACTOR TO RELOCATE ALL EXISTING UTILITIES WHICH CONFLICT WITH THE PROPOSED IMPROVEMENTS SHOWN ON THE PLANS.

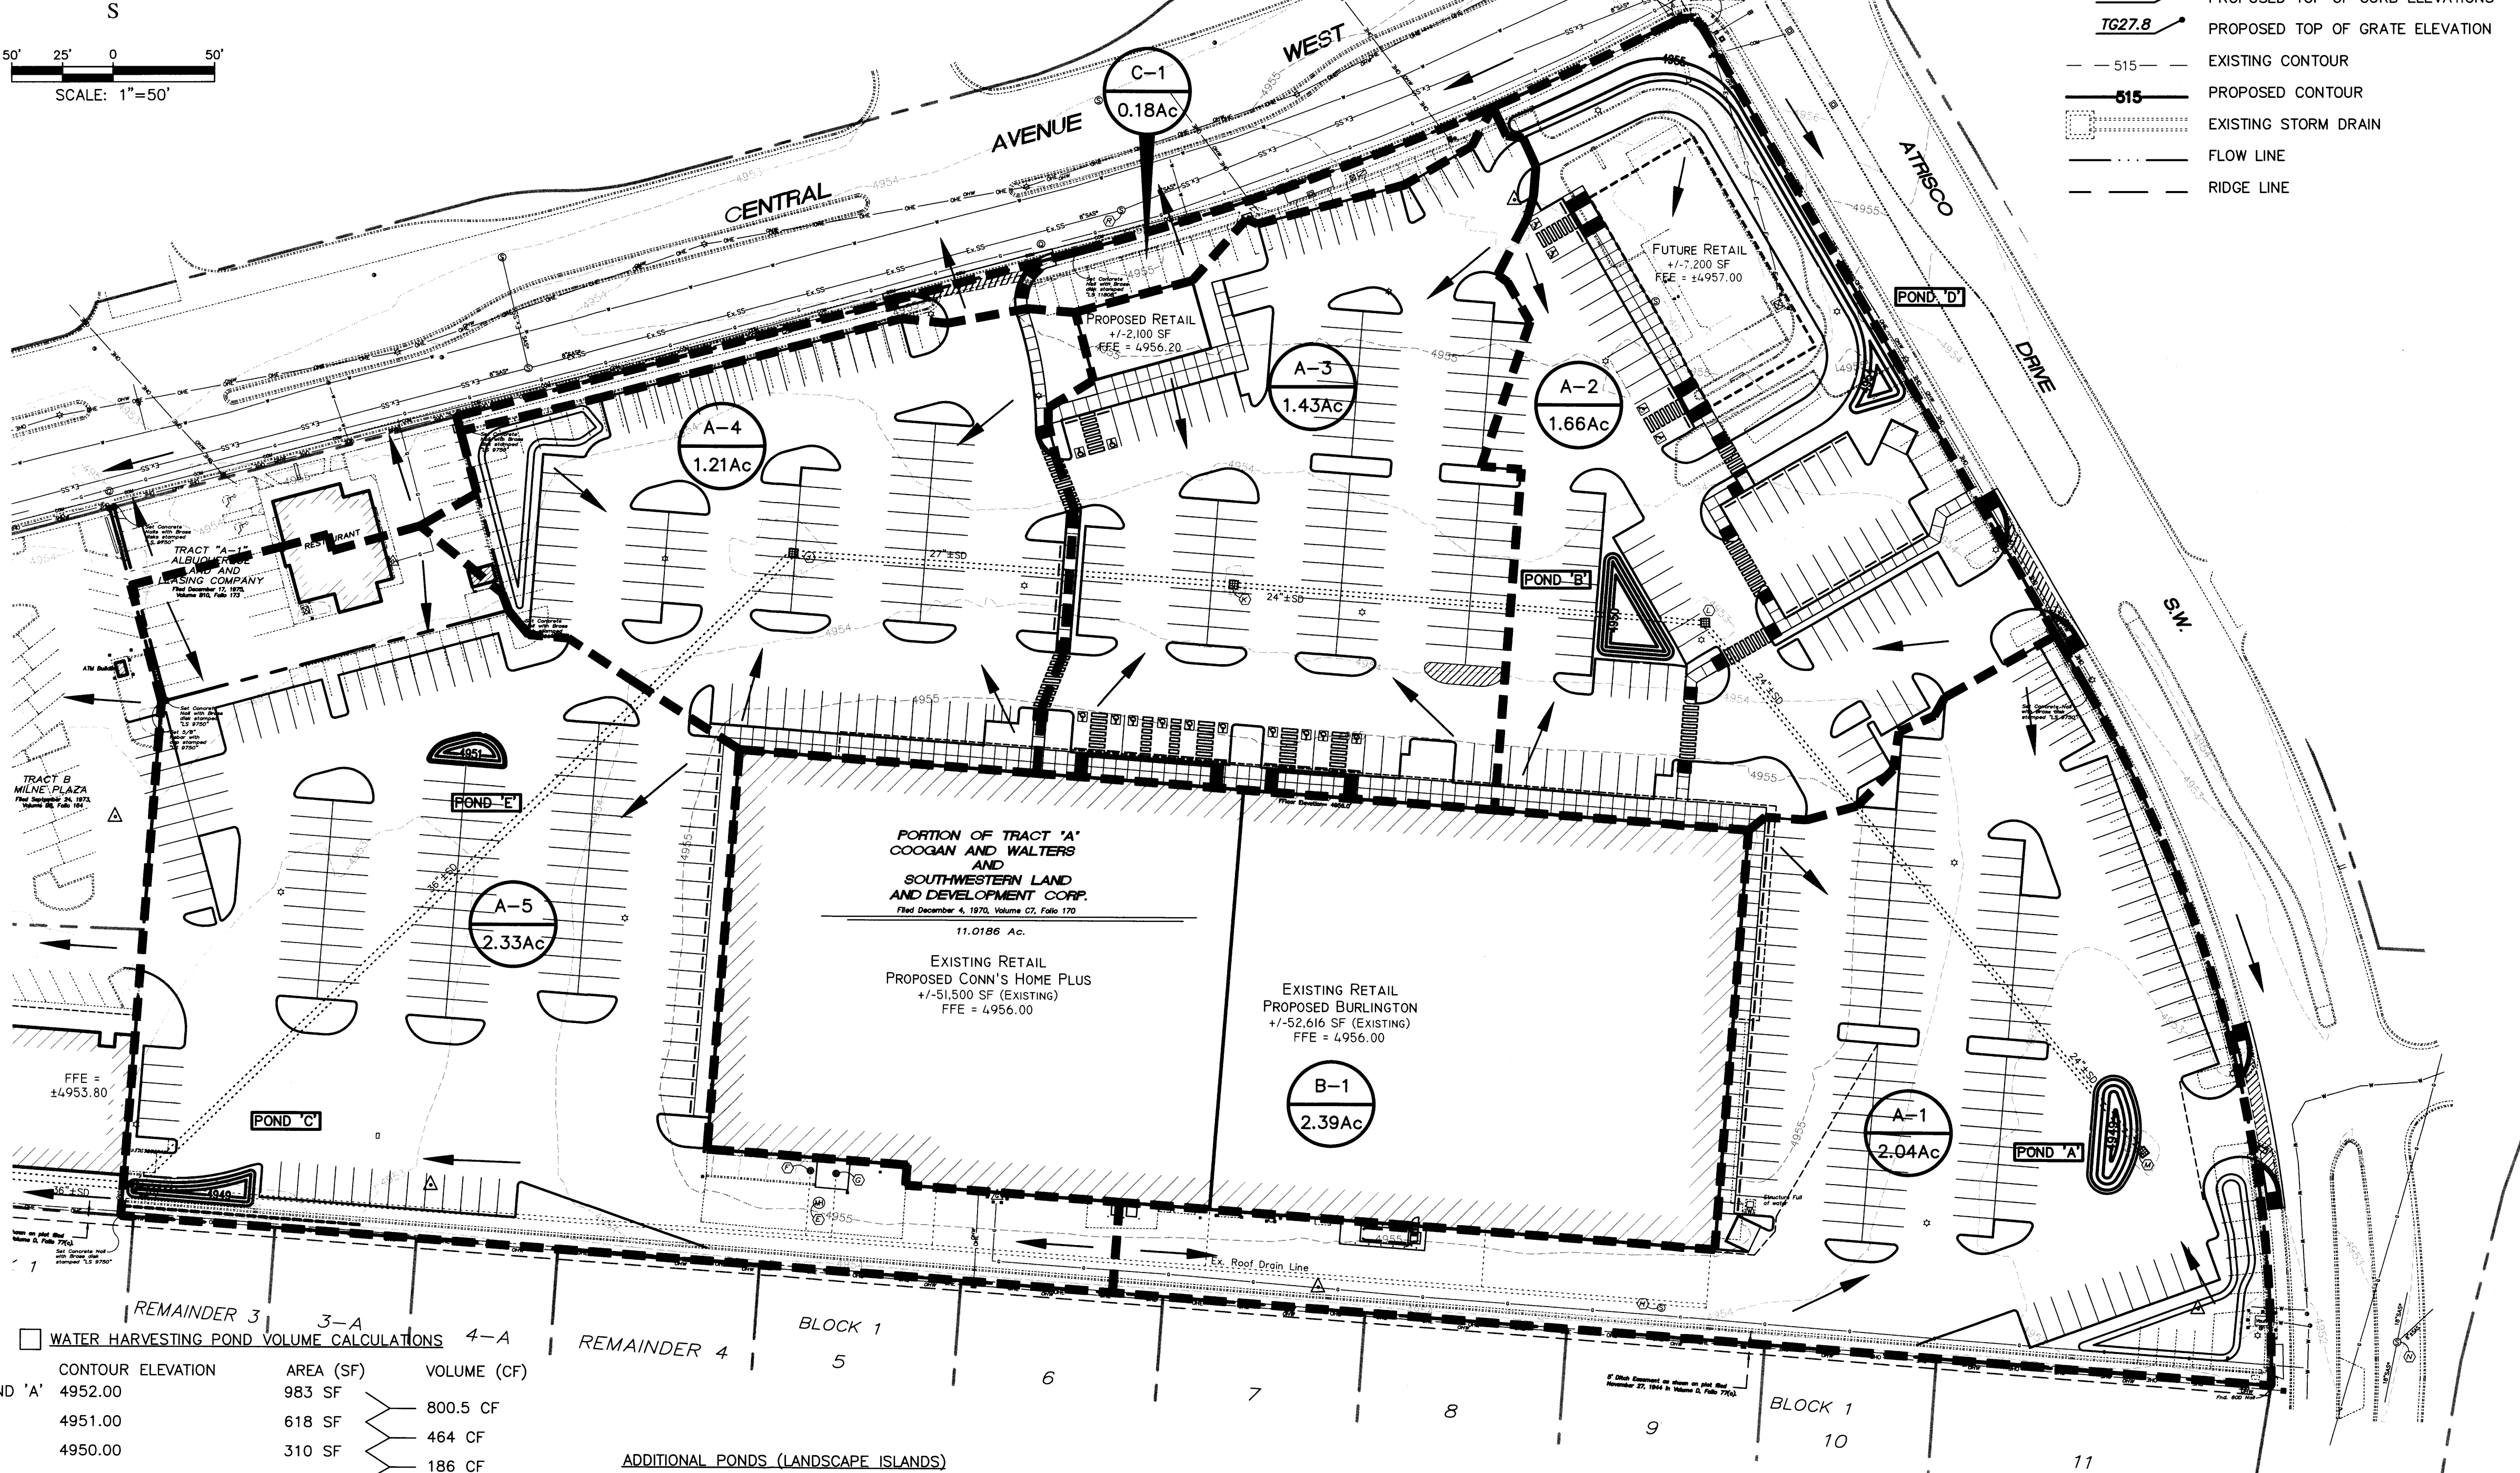

WATER HARVESTING POND VOLUME CALCULATIONS			
CONTAINER ELEVATION	AREA (SF)	VOLUME (CF)	
POND 'A'	4952.00	983 SF	800.5 CF
	4951.00	618 SF	464 CF
	4950.00	310 SF	186 CF
	4949.00	62 SF	
TOTAL			1,450.5 CF
POND 'B'	4953.00	1,166 SF	1,024 CF
	4952.00	882 SF	752 CF
	4951.00	622 SF	511 CF
	4950.00	400 SF	
TOTAL			2,287 CF
POND 'C'	4951.00	676 SF	536 CF
	4950.00	396 SF	268 CF
	4949.00	140 SF	804 CF
TOTAL			804 CF
POND 'D'	4955.00	1,844 SF	699.5 CF
	4954.50	955 SF	304.5 CF
	4954.00	263 SF	168.5 CF
	4953.00	74 SF	
TOTAL			1,172.5 CF
POND 'E'	4953.00	378 SF	299 CF
	4952.00	220 SF	157 CF
	4951.00	94 SF	
TOTAL			456 CF
SUBTOTAL			6,170 CF

ADDITIONAL PONDS (LANDSCAPE ISLANDS)
AVERAGE AREA PER LANDSCAPE ISLAND = 300 SF
AVERAGE DEPTH PER LANDSCAPE ISLAND = 6"
AVERAGE VOLUME PER LANDSCAPE ISLAND = 150 CF
TOTAL NUMBER OF ISLANDS = 40
TOTAL VOLUME = 6,000 CF
GRAND TOTAL = 6,170 CF + 6,000 CF = 12,170 CF

IMPERVIOUS AREA CALCULATIONS
EXISTING SITE CONDITIONS
PERVIOUS AREA: 16,526 SF
IMPERVIOUS AREA: 463,443 SF
TOTAL SITE AREA: 479,969 SF
% IMPERVIOUS = 96.56%
PROPOSED SITE CONDITIONS
PERVIOUS AREA: 65,301 SF
IMPERVIOUS AREA (EXCL BLDGS): 310,553 SF
MAIN RETAIL BUILDING AREA: 104,115 SF
TOTAL SITE AREA: 479,969 SF
% IMPERVIOUS = 86.39%
TOTAL REDUCTION OF IMPERVIOUS AREA = 48,775 SF
NOTE: THE MAIN RETAIL BUILDING IS TO BE EXCLUDED FROM THE FIRST FLUSH CALCULATIONS SINCE IT DRAINS TO A BELOW GRADE STORM DRAIN SYSTEM AND CANNOT BE CAPTURED IN THE LANDSCAPE AREAS.
FIRST FLUSH CALCULATION
TOTAL IMPERVIOUS AREA (LESS MAIN RETAIL BLDG) = 310,553 SF
FIRST FLUSH = 310,553 * 0.34" / 12 = **8,799 CF**


Existing West Central/Atrisco Drainage Calculations													
This table is based on the COA DPM Section 22.2, Zone 1													
BASIN	Area (SQ. FT)	Area (AC)	Land Treatment Percentages				Q(100) (cfs/ac)	Q(100) (CFS)	WTE (inches)	V(100) ₃₆₀ (CF)	V(100) ₄₄₀ (CF)	V(100) _{100yr} (CF)	
A-1	88652	2.04	0.0%	0.0%	3.4%	96.6%	4.32	8.79	1.94	14308	17162	25726	
A-2	72473	1.66	0.0%	0.0%	3.4%	96.6%	4.32	7.19	1.94	11696	14030	21031	
A-3	62387	1.43	0.0%	0.0%	3.4%	96.6%	4.32	6.19	1.94	10069	12077	18104	
A-4	52756	1.21	0.0%	0.0%	3.4%	96.6%	4.32	5.23	1.94	8514	10213	15309	
A-5	101524	2.33	0.0%	0.0%	3.4%	96.6%	4.32	10.07	1.94	16385	19654	29461	
B-1	104116	2.39	0.0%	0.0%	3.4%	96.6%	4.32	10.32	1.94	16803	20156	30213	
C-1	7960	0.18	0.0%	0.0%	3.4%	96.6%	4.32	0.79	1.94	1285	1541	2310	
TOTAL	489868	11.25						48.57		79060	94834	142155	

Proposed West Central/Atrisco Drainage Calculations													
Ultimate Development Conditions Basin Data Table													
This table is based on the COA DPM Section 22.2, Zone 1													
BASIN	Area (SQ. FT)	Area (AC)	Land Treatment Percentages				Q(100) (cfs/ac)	Q(100) (CFS)	WTE (inches)	V(100) ₃₆₀ (CF)	V(100) ₄₄₀ (CF)	V(100) _{100yr} (CF)	
A-1	88652	2.04	0.0%	0.0%	13.4%	86.4%	4.16	8.47	1.83	13554	16108	23767	
A-2	72473	1.66	0.0%	0.0%	13.4%	86.4%	4.16	6.92	1.83	11081	13168	19430	
A-3	62387	1.43	0.0%	0.0%	13.4%	86.4%	4.16	5.96	1.83	9539	11335	16726	
A-4	52756	1.21	0.0%	0.0%	13.4%	86.4%	4.16	5.04	1.83	8066	9586	14144	
A-5	101524	2.33	0.0%	0.0%	13.4%	86.4%	4.16	9.70	1.83	15523	18446	27218	
B-1	104116	2.39	0.0%	0.0%	13.4%	86.4%	4.16	9.94	1.83	15919	18917	27913	
C-1	7960	0.18	0.0%	0.0%	13.4%	86.4%	4.16	0.76	1.83	1217	1446	2134	
TOTAL	489868	11.25						46.79		74898	89007	131331	


$$\%D = (11.25)(.864) = 9.72 \text{ ac}$$

LEGEND

- FLOW ARROW
- 27.8 PROPOSED TOP OF GRADE/PVMT ELEVATIONS
- FL27.8 PROPOSED FLOW LINE/GUTTER ELEVATIONS
- TC27.8 PROPOSED TOP OF CURB ELEVATIONS
- TG27.8 PROPOSED TOP OF GRATE ELEVATION
- 515 - EXISTING CONTOUR
- 515 - PROPOSED CONTOUR
- EXISTING STORM DRAIN
- FLOW LINE
- RIDGE LINE

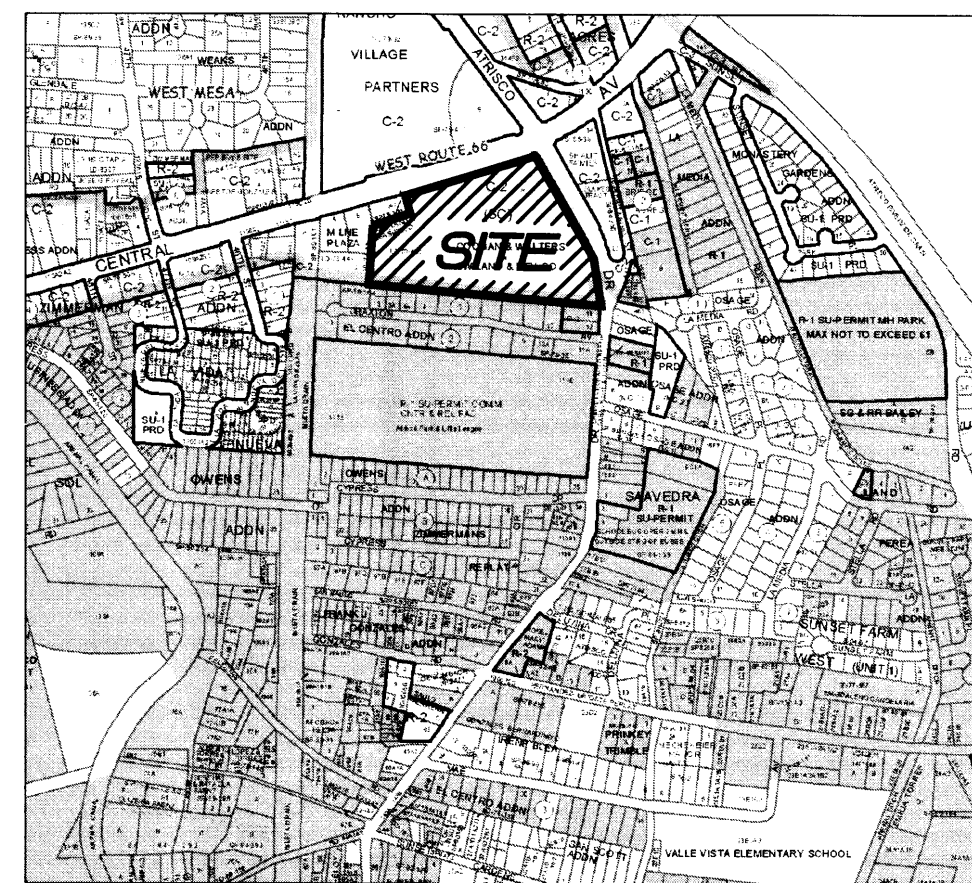

VICINITY MAP - Zone Atlas K-12

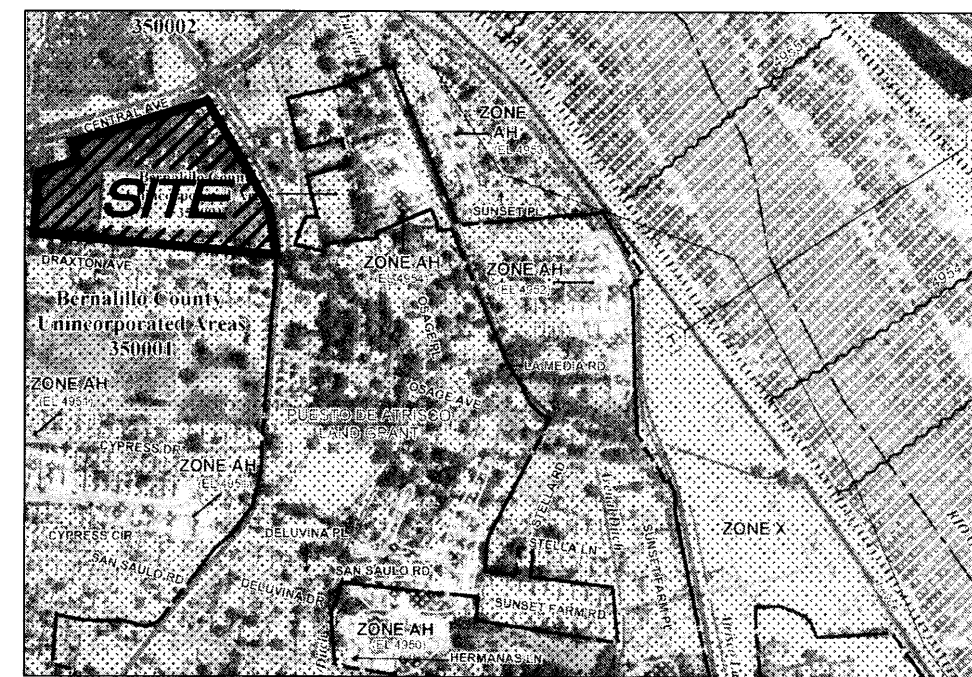

FIRM MAP 35001C0333H

Per FIRM Map 35001C0333H, dated August 16, 2012, the site is located in the 0.2% chance Annual Floodplain with Average Depth of less than 1 foot.

DRAINAGE MANAGEMENT PLAN

INTRODUCTION

The purpose of this submittal is to provide a final drainage management plan for the Redevelopment of West Central/Atrisco, located at the SW of Central Ave SW and Atrisco Dr SW in Albuquerque, NM. The site contains approximately 11.02 acres. We were unable to locate an existing Drainage Study for the site; however, the site is currently 100% Developed and the site is currently +/- 96.6% Impervious.

EXISTING HYDROLOGIC CONDITIONS

The site is currently developed and drains via an underground storm drain system which outfalls to an existing 36" storm drain in the alley to the west of the site. The parking lot currently surface drains to several Type 'D' inlets as shown on the Grading Plan. The roof of the existing main retail building (the old Kmart) drains to downspouts which are connected to a storm drain system on the south side of the building. This roof drain connects to the main site storm sewer system located at the southwest corner of the site. There is a small off-site drainage area that flows onto the site from the existing Long John Silver's site as shown within Basins 'A-4' and 'A-5'. Per the Calculations table this sheet, the total existing flow leaving the site in the storm drain system is 47.78 cfs during the 100-Yr Storm Event. This excludes Basin 'C-1', which is a small area that drains to Central Ave. We calculate that approximately 96.6% of the site is currently impervious.

PROPOSED HYDROLOGIC CONDITIONS

In Redeveloping this site, we are trying to use as much of the existing pavement as possible while increasing the pervious areas in order to reduce runoff volumes from the site. The drainage patterns remain the same as the Pre-Developed condition; however, we have added some water harvesting ponds in key areas in order to capture the first flush from the site. Without accounting for the detention/retention in the proposed Water Harvesting ponds, the total runoff from the site (excluding Basin 'C-1') is 46.03 cfs during the 100-Yr Storm Event. This is a 1.75 cfs reduction below Pre-Developed condition.

In addition, per the Calculations Table this sheet there is a reduction of the 100-Yr, 24-Hr Volume of 5,827 CF. Adding this volume reduction to the Water Harvesting Pond Volume provided (12,170 CF) gives us a total Volume reduction of 17,977 CF.

FIRST FLUSH CALCULATIONS

Per the First Flush Calculations on this sheet, the total First Flush Volume required to be collected for the site is 8,799 CF. Since the roof of the existing large retail building is flowing directly into a storm drain system and cannot be routed through a landscape area, we have not taken the building roof area into account for the calculation. Per the Water Harvesting Pond Calculations table this sheet, we are collecting 12,170 CF of flow from the site which is greater than that required.

CONCLUSION

This drainage management plan provides for grading and drainage elements which reduce the impact to downstream systems; are capable of safely passing the 100 year storm, do not burden downstream systems, and meet city requirements. In addition, the proposed water harvesting ponds will help treat stormwater runoff per the DPM. The proposed improvements to the site should not have any negative impacts to facilities downstream. With this submittal, we are requesting Drainage Management Plan and Building Permit approval for both the Conn's Home Plus and Burlington Coat Factory projects. Each project located on site will apply for a separate Building Permit.

Wooten Engineering
1368 Reynosa Loop SE
Rio Rancho, NM 87124
Ph: 505.980.3560

REV	DATE	BY	REVISION
1			
2			
3			
4			
5			

MODULUS ARCHITECTS
220 COPPER AVE. N.W. SUITE 350
ALBUQUERQUE, NEW MEXICO 87102
PHONE (505) 338-1499 FAX (505) 338-1498

JEFFREY TODD WOOTEN
NEW MEXICO
16892
PROFESSIONAL ENGINEER
9/30/2015

PROJECT TITLE	WEST CENTRAL - ATRISCO	JOB NO.	2015033	DRAWN BY:	JTW
PROJECT MANAGER	JEFF WOOTEN	SHEET NO.	1	DRAINAGE MANAGEMENT PLAN	
DATE:	9/22/15	SCALE:	AS NOTED		

- KEYED NOTES:**
- PROPOSED PAINTED CROSSWALK
 - PROPOSED PYLON SIGN TO BE PERMITTED SEPARATELY
 - PROPOSED CONC. SIDEWALK ADJACENT TO BLDG. RE: DET. 1/6P1
 - PROPOSED CONC. PATIO AREA ADJACENT BLDG. RE: DET. 1/6P2
 - EXISTING PYLON SIGN LOCATION TO REMAIN
 - PROPOSED 6' WIDE PEDESTRIAN PATH
 - PROPOSED HANDICAP RAMP RE: 1/6P1
 - PROPOSED HANDICAP RAMP RE: 1/6P1
 - PROPOSED HANDICAP RAMP RE: 1/6P1
 - PROPOSED LANDSCAPE PLANTING AREA TO PROVIDE AND COORDINATE REG. SLEEVING FOR EA. WELL LOCATION WITH LANDSCAPER. RE: LANDSCAPE PLAN FOR INFO
 - PROPOSED DRIVE AISLE PAINT DETAIL RE: DET. 1/6P12
 - PROPOSED CONC. HEADER CURB TYPICAL RE: DET. 1/6P1
 - PROPOSED REFUSE ENCLOSURE RE: DET. 1/6P13
 - PROPOSED HC PARKING STALL RE: DET. 2/6P12
 - PROPOSED WHEELSTOP RE: DET. 4/6P13
 - PROPOSED MOTORCYCLE PARKING STALL LOCATION RE: SITE PLAN FOR LOCATIONS. RE: DET. 1/6P12
 - PAINTED STRIPPING/SIGNING AS INDICATED ON SITE PLAN. ALL STANDARD PARKING STALL STRIPPING SHALL BE YELLOW
 - EXISTING CURB & GUTTER TO REMAIN
 - EXISTING SIDEWALK TO REMAIN
 - EXISTING ASPHALT PAVES TO BE SEAL COATED AND RESTRIPTED AS SHOWN ON THIS PLAN
 - PROPOSED ELECTRICAL TRANSFORMER LOCATION
 - EXISTING HYDRANT LOCATION TO REMAIN

- GENERAL NOTES:**
- A SHARED ACCESS & PARKING AGREEMENT IS REQUIRED WITH ANY PLATTING ACTION.
 - FUTURE LEASE AREA "B" MUST BE APPROVED THROUGH A SEPARATE ADMINISTRATIVE AMENDMENT WITH NOTIFICATION PER SECTION 14-16-1-22(A)(6).

PROPOSED SITE DATA TABLE	
LEGAL DESCRIPTION:	PART OF TRACT A COOGAN AND WALTER & BU LAND DEV CORP
TOTAL ACRES:	RE: SITE PLAN FOR BUILDING PERMIT
EXISTING ZONING:	C-3 (BC)
PROPOSED USE:	GENERAL RETAIL
EXISTING BUILDING SIZE:	18,416 SF + 15,500 SF + 2,851 SF = 36,767 SF OF EXIST. RETAIL
PROPOSED BUILDING SIZE:	23,675 SF + 1,500 SF NEW RETAIL + 12,675 SF LESS THAN 2% ADDTL.
TOTAL PARKING PROVIDED:	PHASE 1: 350 SPACES + PHASE 2: 315 SPACES = 665 TOTAL
TOTAL PARKING REQ:	PHASE 1: 285 SPACES + PHASE 2: 255 SPACES = 540 TOTAL
HC PROVIDED:	PHASE 1: 9 SPACES + PHASE 2: 8 SPACES = 17 TOTAL
HC REQUIRED:	PHASE 1: 8 SPACES + PHASE 2: 8 SPACES = 16 TOTAL
BIKE SPACES PROVIDED:	PHASE 1: 10 SPACES + PHASE 2: 10 SPACES = 20 TOTAL
BIKE SPACES REQUIRED:	PHASE 1: 10 SPACES + PHASE 2: 10 SPACES = 20 TOTAL
MOTORCYCLE SPACES PROVIDED:	PHASE 1: 5 SPACES + PHASE 2: 5 SPACES = 10 TOTAL
MOTORCYCLE SPACES REQUIRED:	PHASE 1: 5 SPACES + PHASE 2: 5 SPACES = 10 TOTAL

REQUIRED PARKING FORMULA: ONE SPACE PER 200 SF FOR THE FIRST 15,000 SF (75 SPACES); THEN ONE SPACE PER 250 SF FOR THE NEXT 45,000 SF (180 SPACES); THEN ONE SPACE PER 300 SQUARE FEET FOR THE AREA THAT EXCEEDS 60,000 SF.
PHASE 1 AREA IN EXCESS OF 60,000 SF: 33,675/300 = 112 SPACES.
PHASE 2 AREA IN EXCESS OF 60,000 SF: 44,850/300 = 149 SPACES.
 112 TO 300 REQUIRED PARKING SPACES = 9 HC SPACES.
 PHASE 1 AND PHASE 2 REQUIRE 9 HC SPACES EACH.
 181 TO 300 REQUIRED PARKING SPACES = 9 MOTORCYCLE SPACES.
 PHASE 1 AND PHASE 2 REQUIRE 9 MOTORCYCLE SPACES EACH.

REQUIRED HC PARKING:


REQUIRED MC PARKING:



LINE TYPE LEGEND

INTERNAL PHASE LINE	---
PROPOSED LOT LINE	---
PROJECT AREA AND OUTER PHASE AREA LIMIT	---
EXISTING PROPERTY LINE	---
EXISTING CURB LINE	---
PROPOSED CURB LINE	---
6' PEDESTRIAN PATH	---

ADMINISTRATIVE AMENDMENT
 FILE # 10028 PROJECT # 1010346
 REMODEL OF EXISTING BUILDING +
 NEW 700 SF RETAIL BLDG/REASBP
 PARKING + LANDSCAPING
 APPROVED BY: [Signature] DATE: 9.29.15

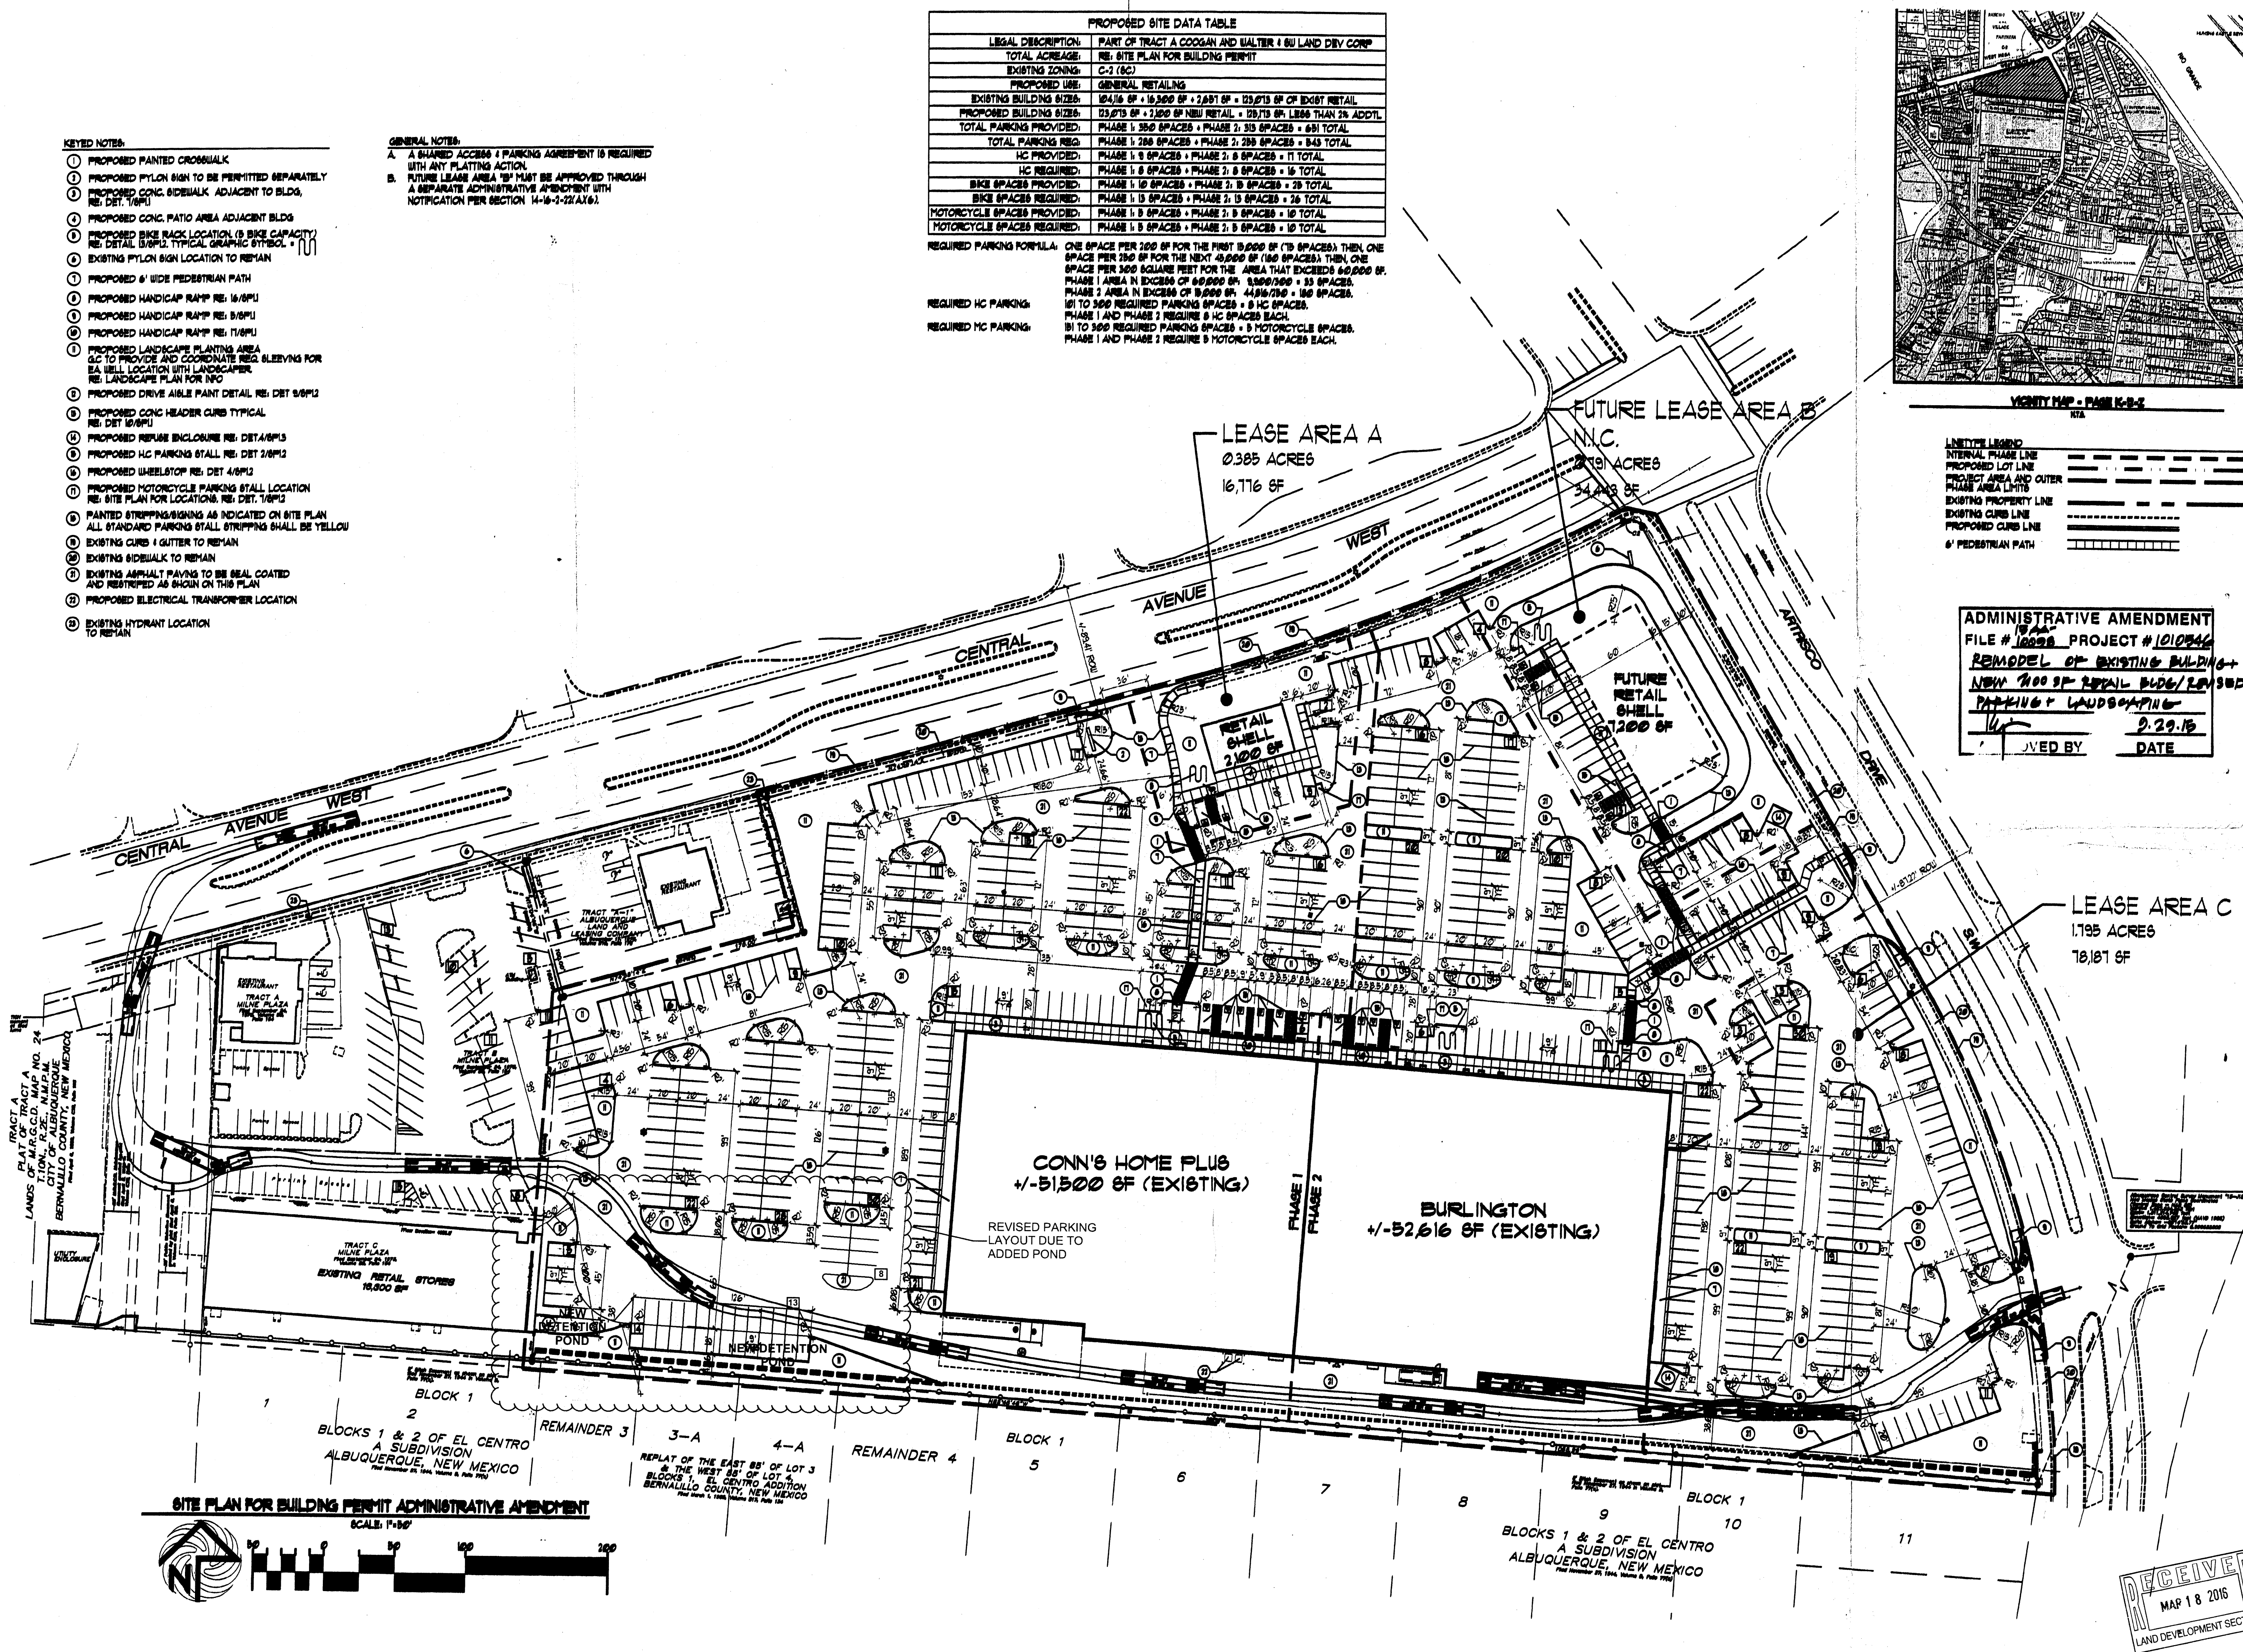

REV	DATE	BY	REVISION
1			
2			
3			
4			
5			

MODULUS ARCHITECTS
 220 COPPER AVE. N.W. SUITE 350
 ALBUQUERQUE, NEW MEXICO 87102
 PHONE (505) 338-1499 FAX (505) 338-1498



PROJECT TITLE	WEST CENTRAL-ATRISCO
PROJECT NUMBER	4008 CENTRAL AVE SW ALBUQUERQUE NEW MEXICO
JOB NO.	K-AT
DRAWN BY	C-S
CHECKED BY	CRANE CALVERT
DATE	9/24/15
SCALE	AS NOTED
REVISION	CP1

