#### Location

LOT 8-A, BLOCK 2, NEW BIDGE ACRES ADDITION, is located at 144 40th Street, SW, containing 1.4668 acre. See attached portion of Vicinity Map K-12-Z for exact location.

#### **Purpose**

The purpose of this drainage report is to present a grading and drainage solution for new 26 Unit apartments on this parcel.

#### **Existing Drainage Conditions**

This lot is very flat and drains east to west to 40th Street, SW. No offiste runoff enters this site.

#### Proposed Conditions and On-Site Drainage Management Plan

The draiage patterns will remain the same. The additional runoff volume generated by the construction of the apartmend will be retained on site. We have provided several ponds on this site. The total volume requirement under proposed conditions is 12,805.69 CF. The retetion pond provided has a volume of 16,468.93 CF.

#### **VOLUME CALCULATIONS FOR 10 DAY STORM**

BASIN	AREA (SF)	AREA (AC)	AREA (MI²)	
ON-SITE	63,895.00	1.4668	0.002292	

 $E = \frac{EA(AA) + EB(AB) + EC(AC) + ED(AD)}{AA + AB + AC + AD}$ 

V-360 = E(AA + AB + AC + AD)

EA = 0.55

EB = 0.73EC = 0.95

ED = 2.24

P-60 = 1.69P-360 = 2.17

P-1440 = 2.49

P-10 Day = 3.90

## EXISTING CONDITIONS PROPOSED CONDITIONS

AA = 95.00%	AA = 0.00%
AB = 00.00%	AB = 18.00%
AC = 00.00%	AC = 08.00%
AD = 05.00%	AD = 74.00%

E = 0.6535 IN E = 1.8650 IN V-360 = 0.0799 AC-FT V-360 = 0.2280 AC-FT AD = 0.0733 AC AD = 1.0855 AC V-10 DAY = 0.0905 AC-FT V-10 DAY = 0.3845 AC-FT V-10 DAY = 3,940.19 CF V-10 DAY = 16,748.88.79 CF


V (REQUIRED) = 16,746.88 - 3,940.19 = 12,805.69 CF

## POND VOLUME REQUIRED FOR FIRST FLUSH

0.62 INCHES x IMPERVIOUS AREA =  $(0.62/12 \times 47123.45) = 2,434.71$  CF THIS VOLUME IS PART OF THE PONDING PROVIDED.

# POND VOLUME CALCULATIONS

PONI	D NO.	TOP AREA	BOT. AREA	DEPT	VOLUME PROVIDE
A		3147.32	1196.42	3.00'	6515.61 CF
E	}	1000.65	294.17	2.00'	1294.82 CF
	,	1604.22	770.53	2.00'	2374.75 CF
L	)	691.32	<i>375.51</i>	1.00'	533.415 CF
E	<del>-</del>	3076.46	1632.66	2.00'	4709.09 CF
F	_	862.76	862.76	0.50'	431.38 CF
	7	937.00	937.00	0.50'	468.50 CF
		TC	TAL VOL. PR	OVIDED	16468.93 CF

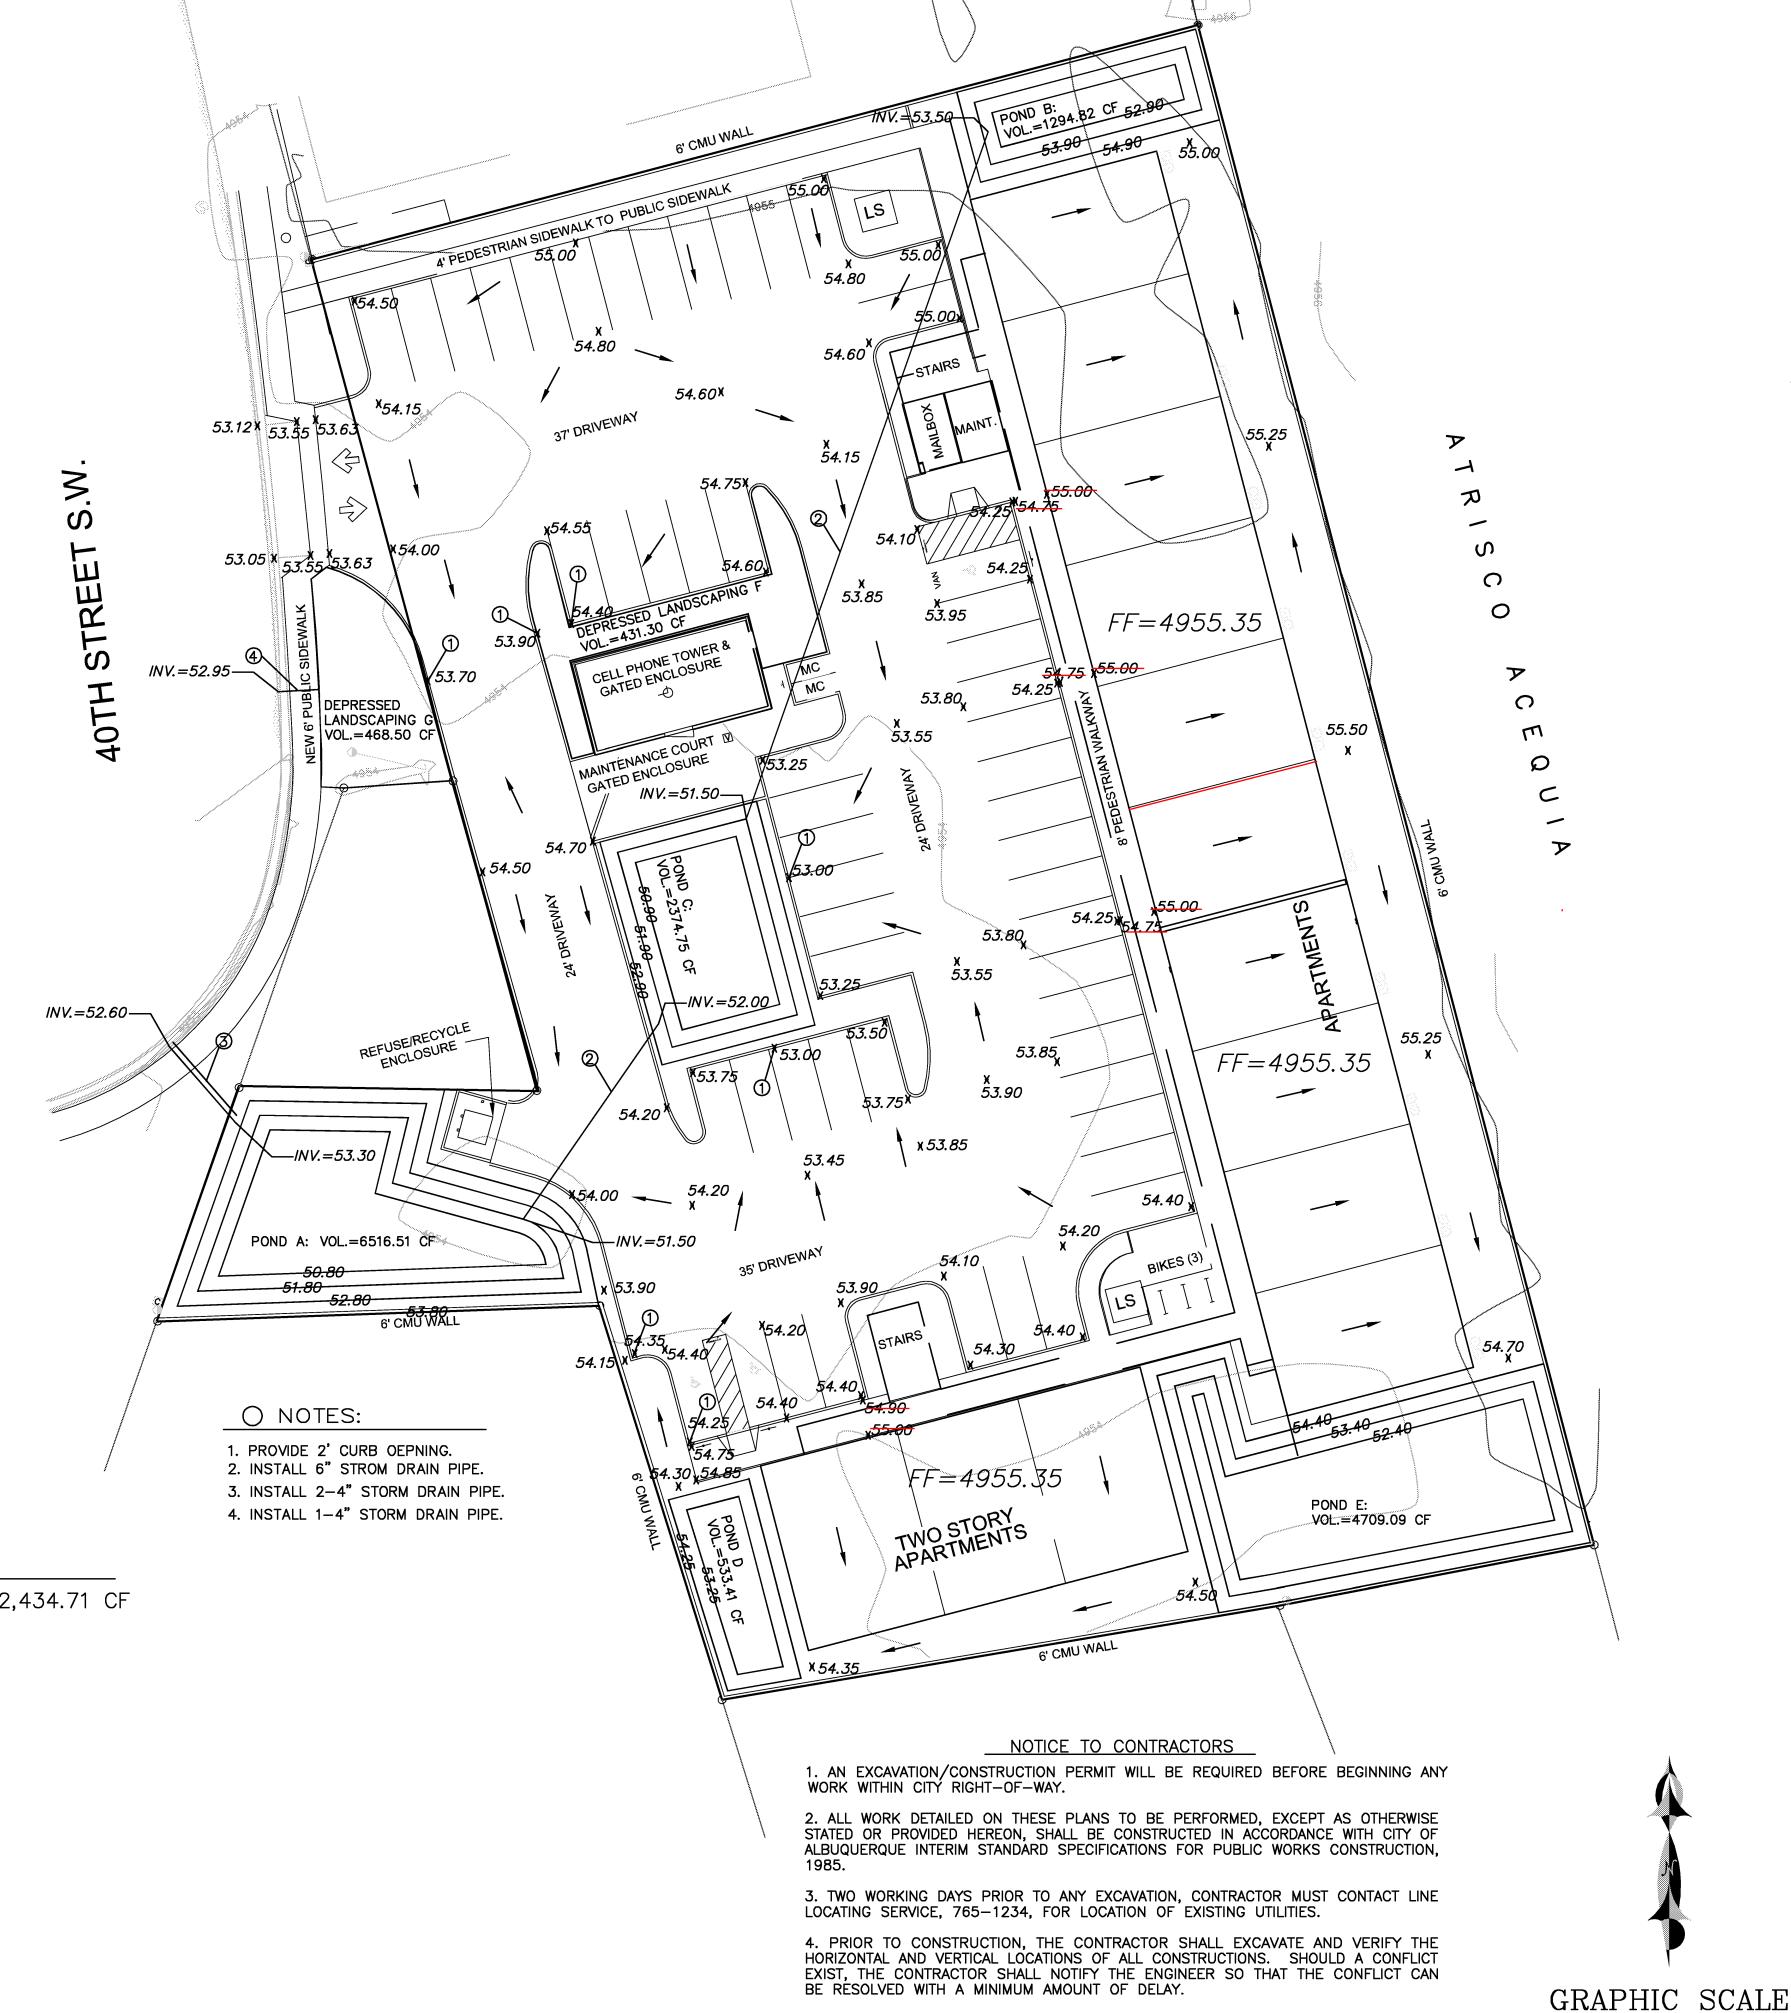



LEGAL DESCRIPTION:

LOT 8-A, BLOCK 2, NEW BIDGE ACRES ADDITION

ADDRESS: 144 40TH STREET, SW

## EXISTING CONDITIONS

THE ENGINEER HAS PERSONALLY INSPECTED THE LAND, AND NO GRADING, FILLING, OR EXCAVATION HAS OCCURRED THEREON SINCE THE EXISTING CONTOUR MAP WAS PREPARED.



#### LEGEND

	EXISTING CONTOUR (MAJOR) EXISTING CONTOUR (MINOR)
X 42.70	BOUNDARY LINE PROPOSED SPOT ELEVATION
<b>×</b> 5029.16	EXISTING GRADE
× 5075.65 FL	EXISTING FLOWLINE ELEVATION
	PROPOSED RETAINING WALL
BC = 41.30	BOTTOM OF CHANEL
TF=42.00	TOP OF FOOTING
TRW=45.12	TOP OF RETAINING WALL
HP	HIGH POINT
42.40 <del>-42.45</del> -	AS-BUILT GRADES
69.77 ×	AS-BUILT SPOT ELEVATIONS



# SBS CONSTRUCTION AND ENGINEERING, LLC

SHAHAB BIAZAR PE NO. 13479 7632 WILLIAM MOYERS AVE., NE ALBUQUERQUE, NEW MEXICO 87122 (505) 804-5013 EMAIL: AECLLC@AOL.COM

## 144 40TH STREET, SW, APARTMETS GRADING PLAN

DRAWING: DRAWN BY: DATE: SHEET #
202307-GD.DWG SH-B 8-15-2022 CIVIL 101

5. BACKFILL COMPACTION SHALL BE ACCORDING TO TRAFFIC/STREET USE.
6. MAINTENANCE OF THESE FACILITIES SHALL BE THE RESPONSIBILITY OF THE OWNER OF THE PROPERTY SERVED.

7. WORK ON ARTERIAL STREETS SHALL BE PERFORMED ON A 24-HOUR BASIS.

LAST REVISION: 12-4-2023

SCALE: 1"=20'