

GENERAL NOTES

- A. THE CONTRACTOR SHALL ABIDE BY ALL STATE, LOCAL, AND FEDERAL LAWS, CODES, RULES AND REGULATIONS WHICH APPLY TO THE CONSTRUCTION OF THESE IMPROVEMENTS, INCLUDING EPA AND ADA REQUIREMENTS.
- B. ALL WORK DETAILED ON THESE PLANS TO BE PERFORMED UNDER CONTRACT SHALL, EXCEPT AS OTHERWISE STATED ON OR PROVIDED FOR HEREON, BE CONSTRUCTED IN ACCORDANCE WITH THE CURRENT EDITION OF THE CITY OF ALBUQUERQUE STANDARD SPECIFICATIONS FOR PUBLIC WORKS (COA SPEC.).
- C. THE CONTRACTOR IS SOLELY RESPONSIBLE FOR OBTAINING ALL REQUIRED PERMITS FOR THE PROJECT PRIOR TO COMMENCING CONSTRUCTION, OR PRIOR TO OCCUPANCY, AS APPROPRIATE.
- D. COORDINATE WORK WITH SITE PLAN, UTILITY PLAN, DEMOLITION PLAN, AND LANDSCAPE PLAN.
- E. IT IS THE CONTRACTOR'S RESPONSIBILITY TO FIELD VERIFY
 HORIZONTAL AND VERTICAL LOCATIONS OF ALL EXISTING
 OBSTRUCTIONS, AND CONDITION OF ALL EXISTING INFRASTRUCTURE
 PRIOR TO CONSTRUCTION. REPORT ALL DISCREPANCIES TO THE
 ARCHITECT AND VERIFY THE ARCHITECT INTENT BEFORE PROCEEDING.
- F. THE CONTRACTOR SHALL BE SOLELY RESPONSIBLE FOR SITE SAFETY.

 G. THE CONTRACTOR SHALL MAINTAIN DECORD DRAWNICS ON SITE AT
- G. THE CONTRACTOR SHALL MAINTAIN RECORD DRAWINGS ON SITE AT ALL TIMES.
- H. THE CONTRACTOR SHALL OBTAIN ALL REQUIRED INSPECTIONS OF THE
- I. CONSTRUCTION ACTIVITY SHALL BE LIMITED TO THE PROJECT LIMITS. ANY DAMAGE TO ADJACENT STRUCTURES RESULTING FROM THE CONSTRUCTION PROCESS SHALL BE REPAIRED OR REPLACED AT THE CONTRACTOR'S EXPENSE. CONTRACTOR SHALL BE RESPONSIBLE FOR DOCUMENTING EXISTING CONDITIONS PRIOR TO CONSTRUCTION.
- THE CONTRACTOR SHALL MAINTAIN ALL BARRICADING AND CONSTRUCTION SIGNING AT ALL TIMES. THE CONTRACTOR SHALL VERIFY THE PROPER LOCATION OF ALL BARRICADING AT THE END AND BEGINNING OF FACH DAY.
- K. EXISTING UTILITY LINES ARE SHOWN IN AN APPROXIMATE MANNER ONLY AND MAY BE INCOMPLETE OR OBSOLETE. SUCH LINES MAY OR MAY NOT EXIST WHERE SHOWN OR NOT SHOWN. CONTRACTOR SHALL CONTACT NM—811 FOR UTILITY LINE SPOTS FIVE WORKING DAYS PRIOR TO CONDUCTING SITE FIELD WORK. CONTRACTOR SHALL FIELD VERIFY AND LOCATE ALL UTILITIES PRIOR TO COMMENCEMENT OF ANY CONSTRUCTION. CONTRACTOR IS FULLY RESPONSIBLE FOR ANY AND ALL DAMAGE CAUSED BY ITS FAILURE TO LOCATE, IDENTIFY AND PRESERVE ANY AND ALL EXISTING UTILITIES, PIPELINES, AND UNDERGROUND UTILITY LINES. THE CONTRACTOR SHALL BE RESPONSIBLE FOR COORDINATION OF NECESSARY DRY UTILITY ADJUSTMENTS.
- L. FIVE WORKING DAYS PRIOR TO ANY EXCAVATION, THE CONTRACTOR MUST CONTACT NM811 (811) FOR LOCATION OF EXISTING UTILITIES.
- M. ALL SITE PREPARATION, GRADING OPERATIONS, FOUNDATION CONSTRUCTION, AND PAVEMENT INSTALLATION WORK SHALL BE CONSTRUCTED IN ACCORDANCE WITH THE GEOTECHNICAL REPORT, WHICH WILL BE PROVIDED BY THE OWNER OR ARCHITECT.
- N. ALL TRASH, DEBRIS, & SURFACE VEGETATION SHALL BE CLEARED AND LEGALLY DISPOSED OF OFFSITE.
- O. VIBRATORY COMPACTION SHALL NOT BE USED OVER IN-PLACE
- P. SOIL TESTING AND INSPECTION SERVICES DURING SITE OPERATIONS ARE REQUIRED. CONTRACTOR SHALL ALLOW TESTING LABS TO INSPECT AND APPROVE COMPACTED SUBGRADES, BACKFILL, AND FILL LAYERS BEFORE FURTHER CONSTRUCTION WORK IS DONE. SHOULD COMPACTION TESTS INDICATE INADEQUATE DENSITY, CONTRACTOR SHALL PROVIDE ADDITIONAL COMPACTION AND TESTING AT THE
- Q. ADJUST ANY RIMS OF EXISTING UTILITY FEATURES AS NECESSARY TO MATCH NEW GRADES. UTILITIES IN PAVED AREAS SHALL BE HS-25 TRAFFIC RATED.
- R. CONTRACTOR SHALL COMPLY WITH LOCAL REGULATIONS FOR RESEEDING OF DISTURBED AREAS.

GRADING NOTES

- a. GRADING SHALL BE PERFORMED AT THE ELEVATIONS AND IN ACCORDANCE WITH THE DETAILS SHOWN ON THIS PLAN.
- b. PROPOSED SPOT AND CONTOUR ELEVATIONS SHOWN
 REPRESENT TOP OF FINISH MATERIAL (I.E. TOP OF CONCRETE,
 TOP OF CONCRETE BUILDING PAD, TOP OF PAVEMENT
 MATERIAL, TOP OF LANDSCAPING MATERIAL, ETC.).
 CONTRACTOR SHALL GRADE, COMPACT SUBGRADE AND
 DETERMINE EARTHWORK ESTIMATES BASED ON ELEVATIONS
 SHOWN MINUS FINISH MATERIAL THICKNESSES.
- c. IF FIELD GRADE ADJUSTMENTS ARE REQUIRED, THE CONTRACTOR SHALL NOTIFY THE ARCHITECT.
- d. THE ENVIRONMENTAL PROTECTION AGENCY (EPA) AND THE CITY OF ALBUQUERQUE REQUIRE A STORM WATER POLLUTION PREVENTION PLAN (SWPPP), AN NDPES PERMIT, AND AN EROSION AND SEDIMENT CONTROL (ESC) PERMIT FOR PROJECTS WHERE CONSTRUCTION ACTIVITIES MEET THE EPA THRESHOLD. (SWPPP, NPDES PERMIT, AND ESC PLAN BY OTHERS.) A CURRENT CITY—APPROVED ESC PERMIT MUST BE INCLUDED WITH THE CONTRACTOR'S SUBMITTAL FOR A ROUGH GRADING, GRADING, PAVING, BUILDING, OR WORK ORDER
- DETERMINE WHO WILL PREPARE SWPPP AND INSPECT REQUIRED ELEMENTS.

 e. ALL NEW PAVEMENT SURFACES SHALL BE CONSTRUCTED WITH POSITIVE SLOPE AWAY FROM BUILDINGS AND POSITIVE SLOPE TOWARD EXISTING AND/OR PROPOSED DRAINAGE PATHS. PAVING AND ROADWAY GRADES SHALL BE ±0.1' FROM PLAN


PERMIT. CONTRACTOR SHALL COORDINATE WITH OWNER TO

f. WHERE GRADES BETWEEN NEW AND EXISTING ARE SHOWN AS 'MATCH' OR '±', TRANSITIONS SHALL BE SMOOTH.

ELEVATIONS. BUILDING PAD ELEVATION SHALL BE ±0.05'

- g. ALL EROSION PROTECTION SHALL BE 6" AVG. DIA. ANGULAR FACED ROCK (F.F. ROCK) PLACED OVER GEOTEX 501 NON-WOVEN GEOTEXTILE (O.E.). NOTE: IF APPROVED BY ENGINEER, ALTERNATIVE EROSION PROTECTION MAY BE SUBSTITUTED.
- h. STORMWATER RETENTION POND ELEVATIONS AND SITE STORMWATER CONTROL MEASURES SHOWN ON THIS PLAN SHALL BE STRICTLY ADHERED TO FOR CERTIFICATION PURPOSES.
- i. POST-CONSTRUCTION MAINTENANCE FOR STORMWATER FACILITIES WILL BE THE RESPONSIBILITY OF THE FACILITIES OWNER. ENGINEER RECOMMENDS THAT OWNER INSPECT SITE YEARLY AND AFTER EACH RAINFALL TO IDENTIFY NEW AREAS OF EROSION AND INSTALL ADDITIONAL EROSION PROTECTION AS NEEDED BASED ON ACTUAL OCCURRENCES.

VICINITY MAP

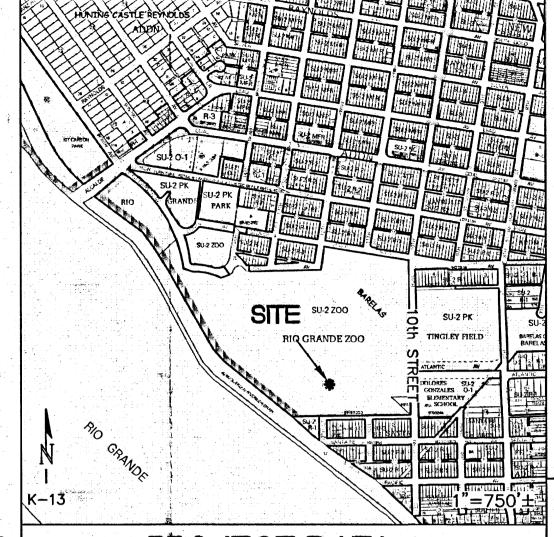

PROJECT DATA

PROPERTY: THE SITE IS A PORTION OF THE ALBUQUERQUE RIO GRANDE ZOO PROPERTY LOCATED WITHIN C.O.A. VICINITY MAP K-13. THE SITE IS BOUND TO THE NORTH AND WEST BY THE MAIN PARK AREA AND BANDSTAND POND, AND TO THE SOUTH AND EAST BY EXISTING ANIMAL EXHIBIT

PROPOSED IMPROVEMENTS: THE PROPOSED IMPROVEMENTS INCLUDE A NEW FACILITY HOUSING THE PROPOSED PENGUIN EXHIBIT WITH ASSOCIATED CONCRETE WALKS AND LANDSCAPING. DRAINAGE IMPROVEMENTS WILL BE CONSTRUCTED TO ADDRESS BUILDING DISCHARGE.

ALBUQUERQUE, NM

BENCHMARK: VERTICAL DATUM IS BASED UPON THE ALBUQUERQUE

LEGAL: TROPICAL AMERICA AND ADJACENT AREAS, RIO GRANDE ZOO,

BENCHMARK: VERTICAL DATUM IS BASED UPON THE ALBUQUERQUE CONTROL STATION MONUMENT "12-L14", ELEVATION = 4947.708 FEET (NAVD 1988), AS PUBLISHED.

OFF-SITE: NO OFFSITE FLOW IMPACTS THIS PROPERTY.

FLOOD HAZARD: PER BERNALILLO COUNTY FIRM MAP #333, THE SITE IS LOCATED WITHIN FLOOD ZONE 'X' (SHADED) DESIGNATED AS AREA OF MODERATE FLOOD HAZARD, USUALLY THE AREA BETWEEN THE LIMITS OF THE 100-YEAR AND 500-YEAR FLOODS.

DRAINAGE PLAN CONCEPT: THE PROPOSED AREA TO BE DEVELOPED PREVIOUSLY HOUSED THE TROPICAL AMERICA EXHIBIT AND EXTENSIVE WALKS AND COVERED AREAS. THE TOTAL PROPOSED IMPERVIOUS AREA WILL BE APPROXIMATELY THE SAME AS THE PRE-DEVELOPED CONDITION. HISTORICALLY, THE MAJORITY OF THIS AREA DRAINED TO LOCALIZED WATER HARVESTING AREAS WITHIN THE LANDSCAPING OVERFLOWING TO THE MAIN PARK. THE PROPOSED DEVELOPMENT WILL ALSO UTILIZE TEMPORARILY ALL WATER HARVESTING BASINS FOR INFILTRATION. EXCESS STORMWATER WOULD DISCHARGE TO THE MAIN PARK AREA WHICH, HISTORICALLY, IS USED TO INFILTRATE STORMWATER. THE FINAL LANDSCAPING FOR THIS EXHIBIT WILL BE DESIGNED AS PART OF A DIFFERENT PROJECT. FUTURE DESIGN WILL PROVIDE AREA PONDS SIZED TO RETAIN THE 100-YEAR, 6-HOUR VOLUME FOR INFILTRATION WITH EMERGENCY OVERFLOW TO THE PARK AT AN ELEVATION </E

KEYED NOTES

KEYED NOTES REFERENCE OVERALL GRADING (SCALE 1:20) AROUND BUILDING. SEE CG-101 AND CG-102 FOR SPECIFIC KEYED NOTES FOR UPPER LEVEL (SHOWN FADED) AND LOWER LEVEL GRADING AND DRAINAGE (SCALE 1:10).

- 1. SEE CG-101 FOR UPPER LEVEL GRADES THIS AREA. SEE CG-102
 FOR LOWER LEVEL GRADES THIS AREA.
- 2. FINAL SITE LANDSCAPE PLAN TO BE DESIGNED UNDER SEPARATE CONTRACT. CONSTRUCT TEMPORARY STORMWATER RETENTION PONDS BASINS TO ELEVATIONS SHOWN. SEE OVERALL GRADING AND DRAINAGE PLAN (CG-001) FOR FULL EXTENT OF TEMPORARY GRADING.
- 3. OVERFLOW BETWEEN WATER HARVESTING BASINS = 47.5.
- 4. INSTALL TWO 12* CULVERTS WITH END SECTIONS. PROVIDE EROSION PROTECTION EACH END.
- 5. GRADE THIS AREA WITH BERM (TOP OF BERM 49.0) TO PREVENT STORMWATER FROM BACKING UP INTO REPTILE AND AMPHIBIAN AREA.
- EXISTING STORMWATER FROM THIS AREA WILL CONTINUE TO DRAIN TO THE REPTILE AND AMPHIBIAN AREA.

LEGEND EXISTING CONTOUR PROPOSED CONTOUR PROPOSED SPOT ELEVATION FLOW ARROW (PROPOSED) FF=4946.20 FINISH FLOOR ELEVATION



EROSION PROTECTION

Van H. Gilbert Architect PC

ARCHITECTURE • INTERIORS • PLANNING



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Alvine and Associates, Inc.

Isaacson & Arfman, P.,

Bridgers and Paxtor



LIFE SUPPORT ENGINEERS:





NO. DATE REVISION/REMARKS

DESIGNED BY: BJB DATE: 9/15/16
DRAWN BY: BJB DATE: 9/15/16
CHECKED BY: FCA DATE: 9/15/16
SUBMITTAL / DATE CONSTRUCTION DOCUMENTS 15/16

PROJECT NUMBER 16200
PROJECT FILENAME 2140 CG-001 dwg Sep 15,2010



ALBUQUERQUE BIOPARK ZOO PENGUIN EXHIBIT


Albuquerque, New Mexico


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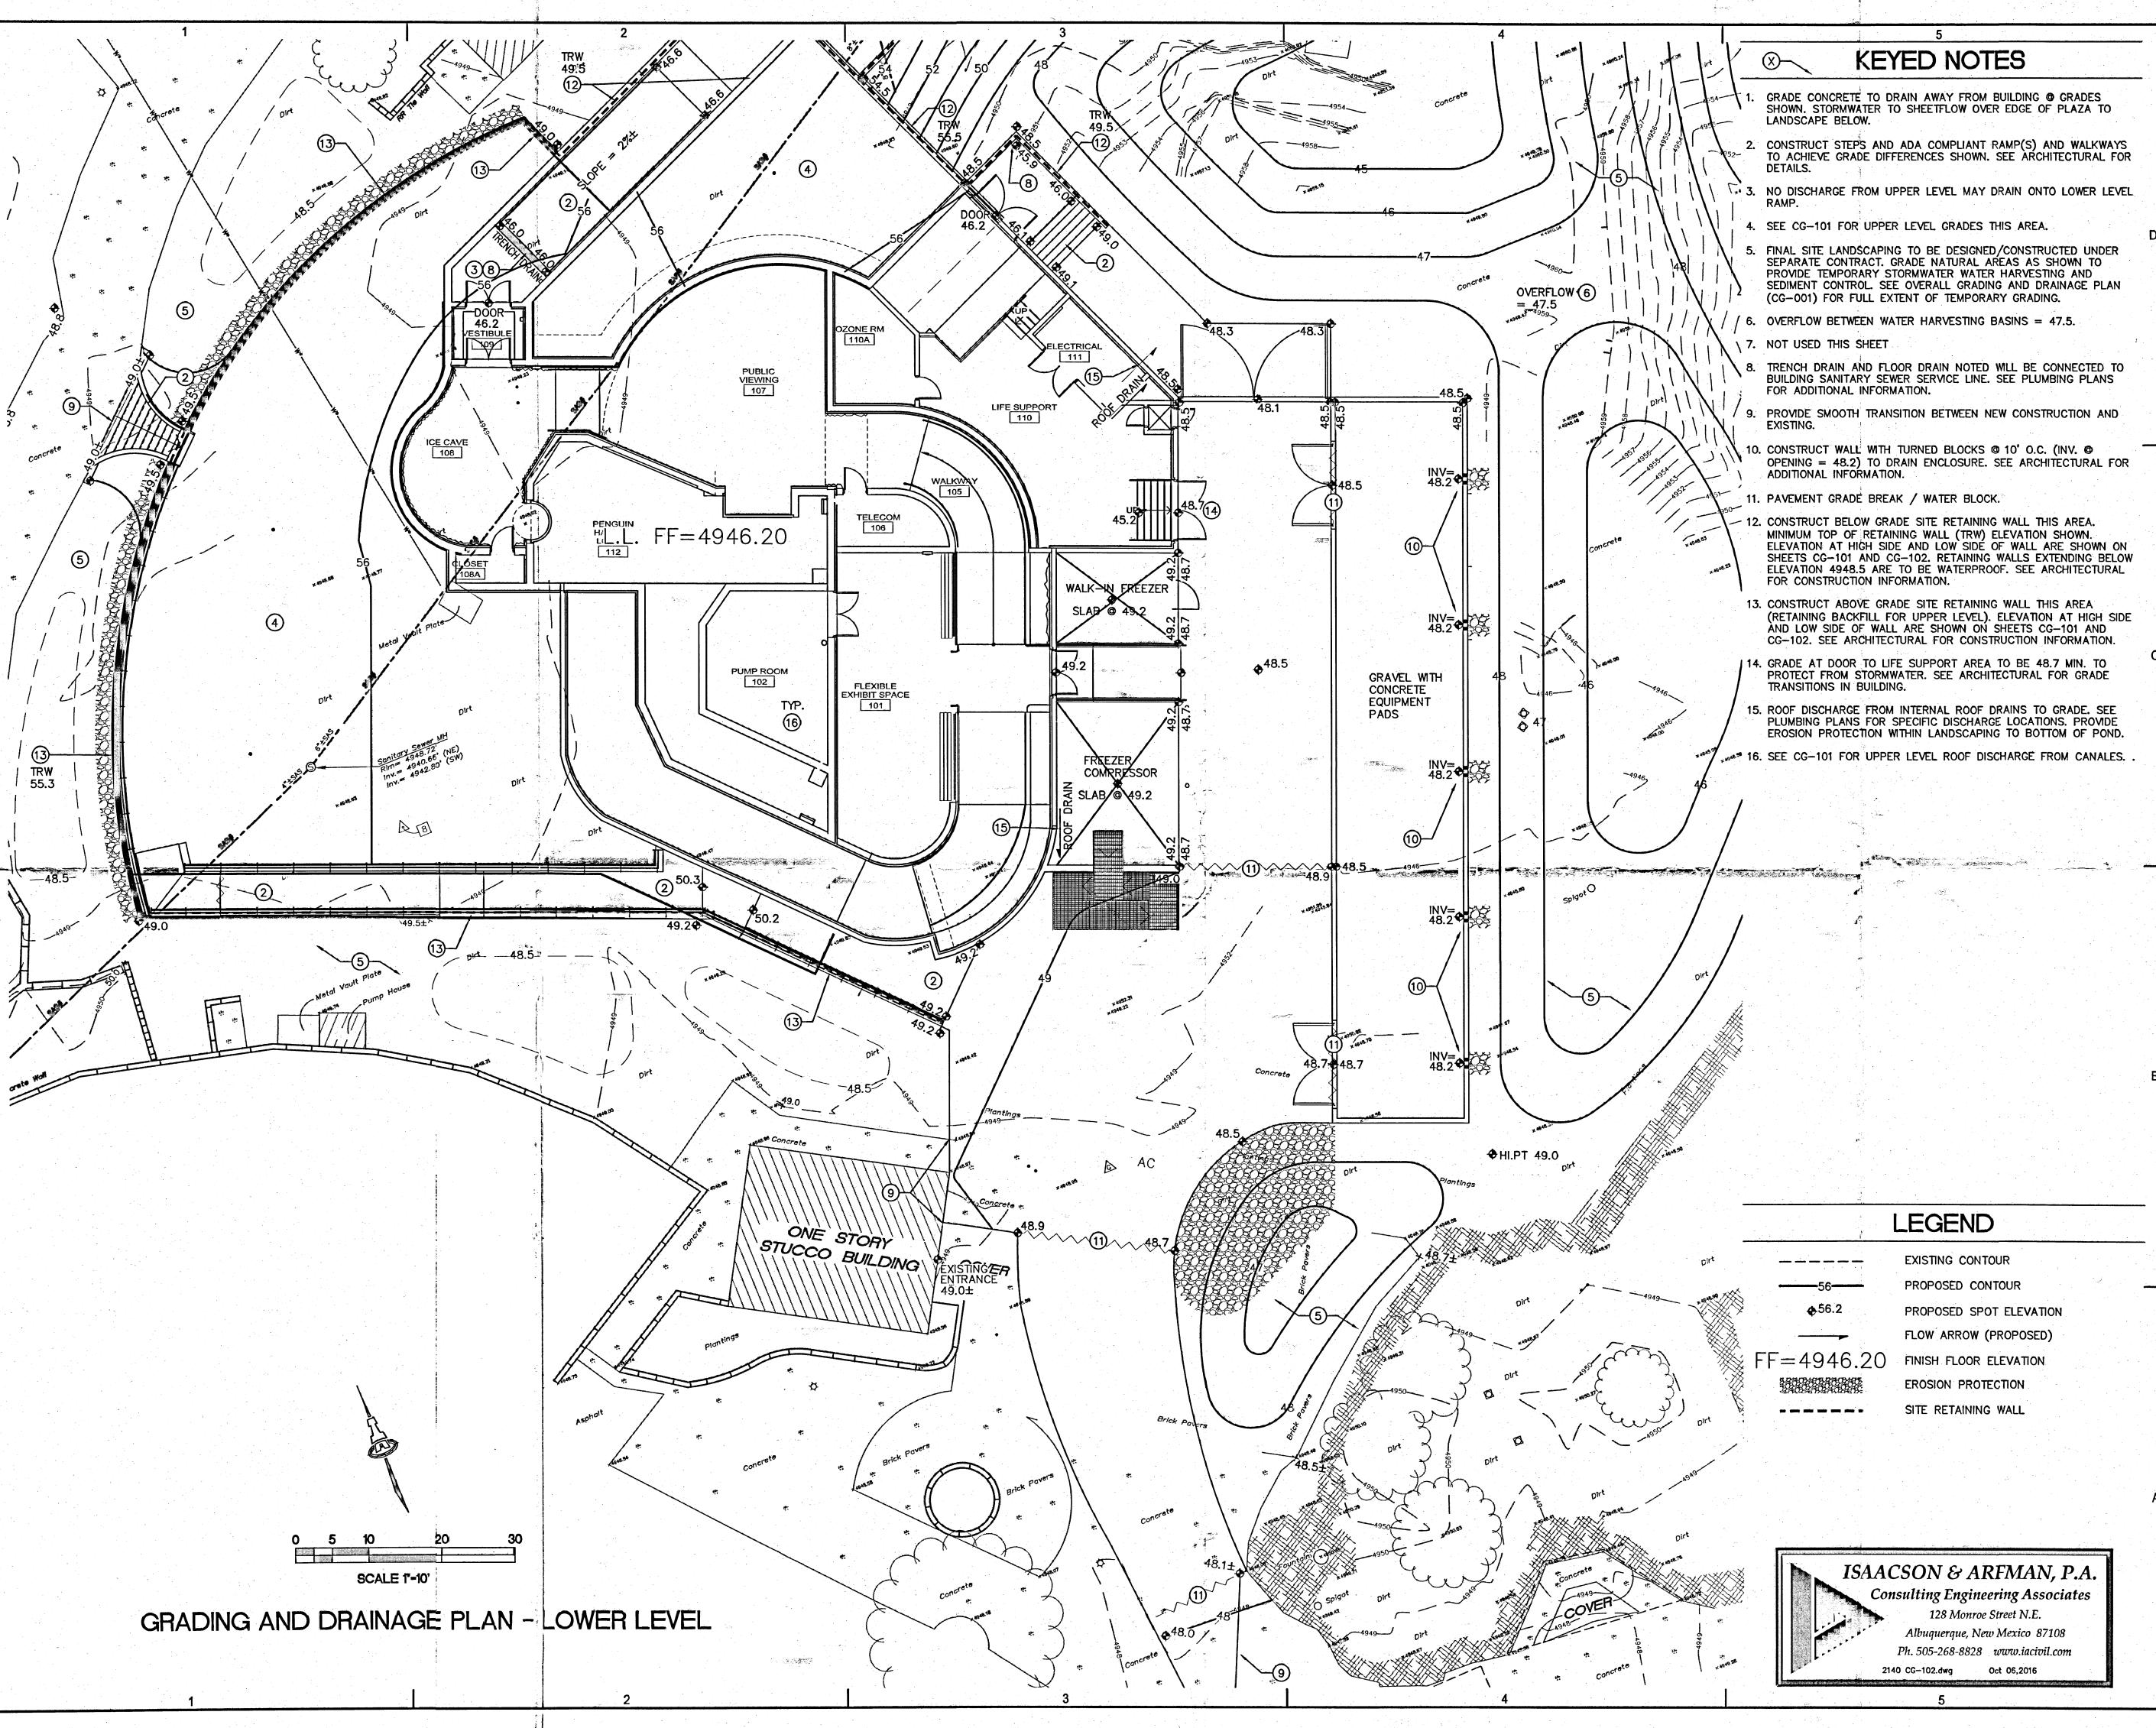
OVERALL GRADING AND DRAINAGE PLAN

CG-100

OF .



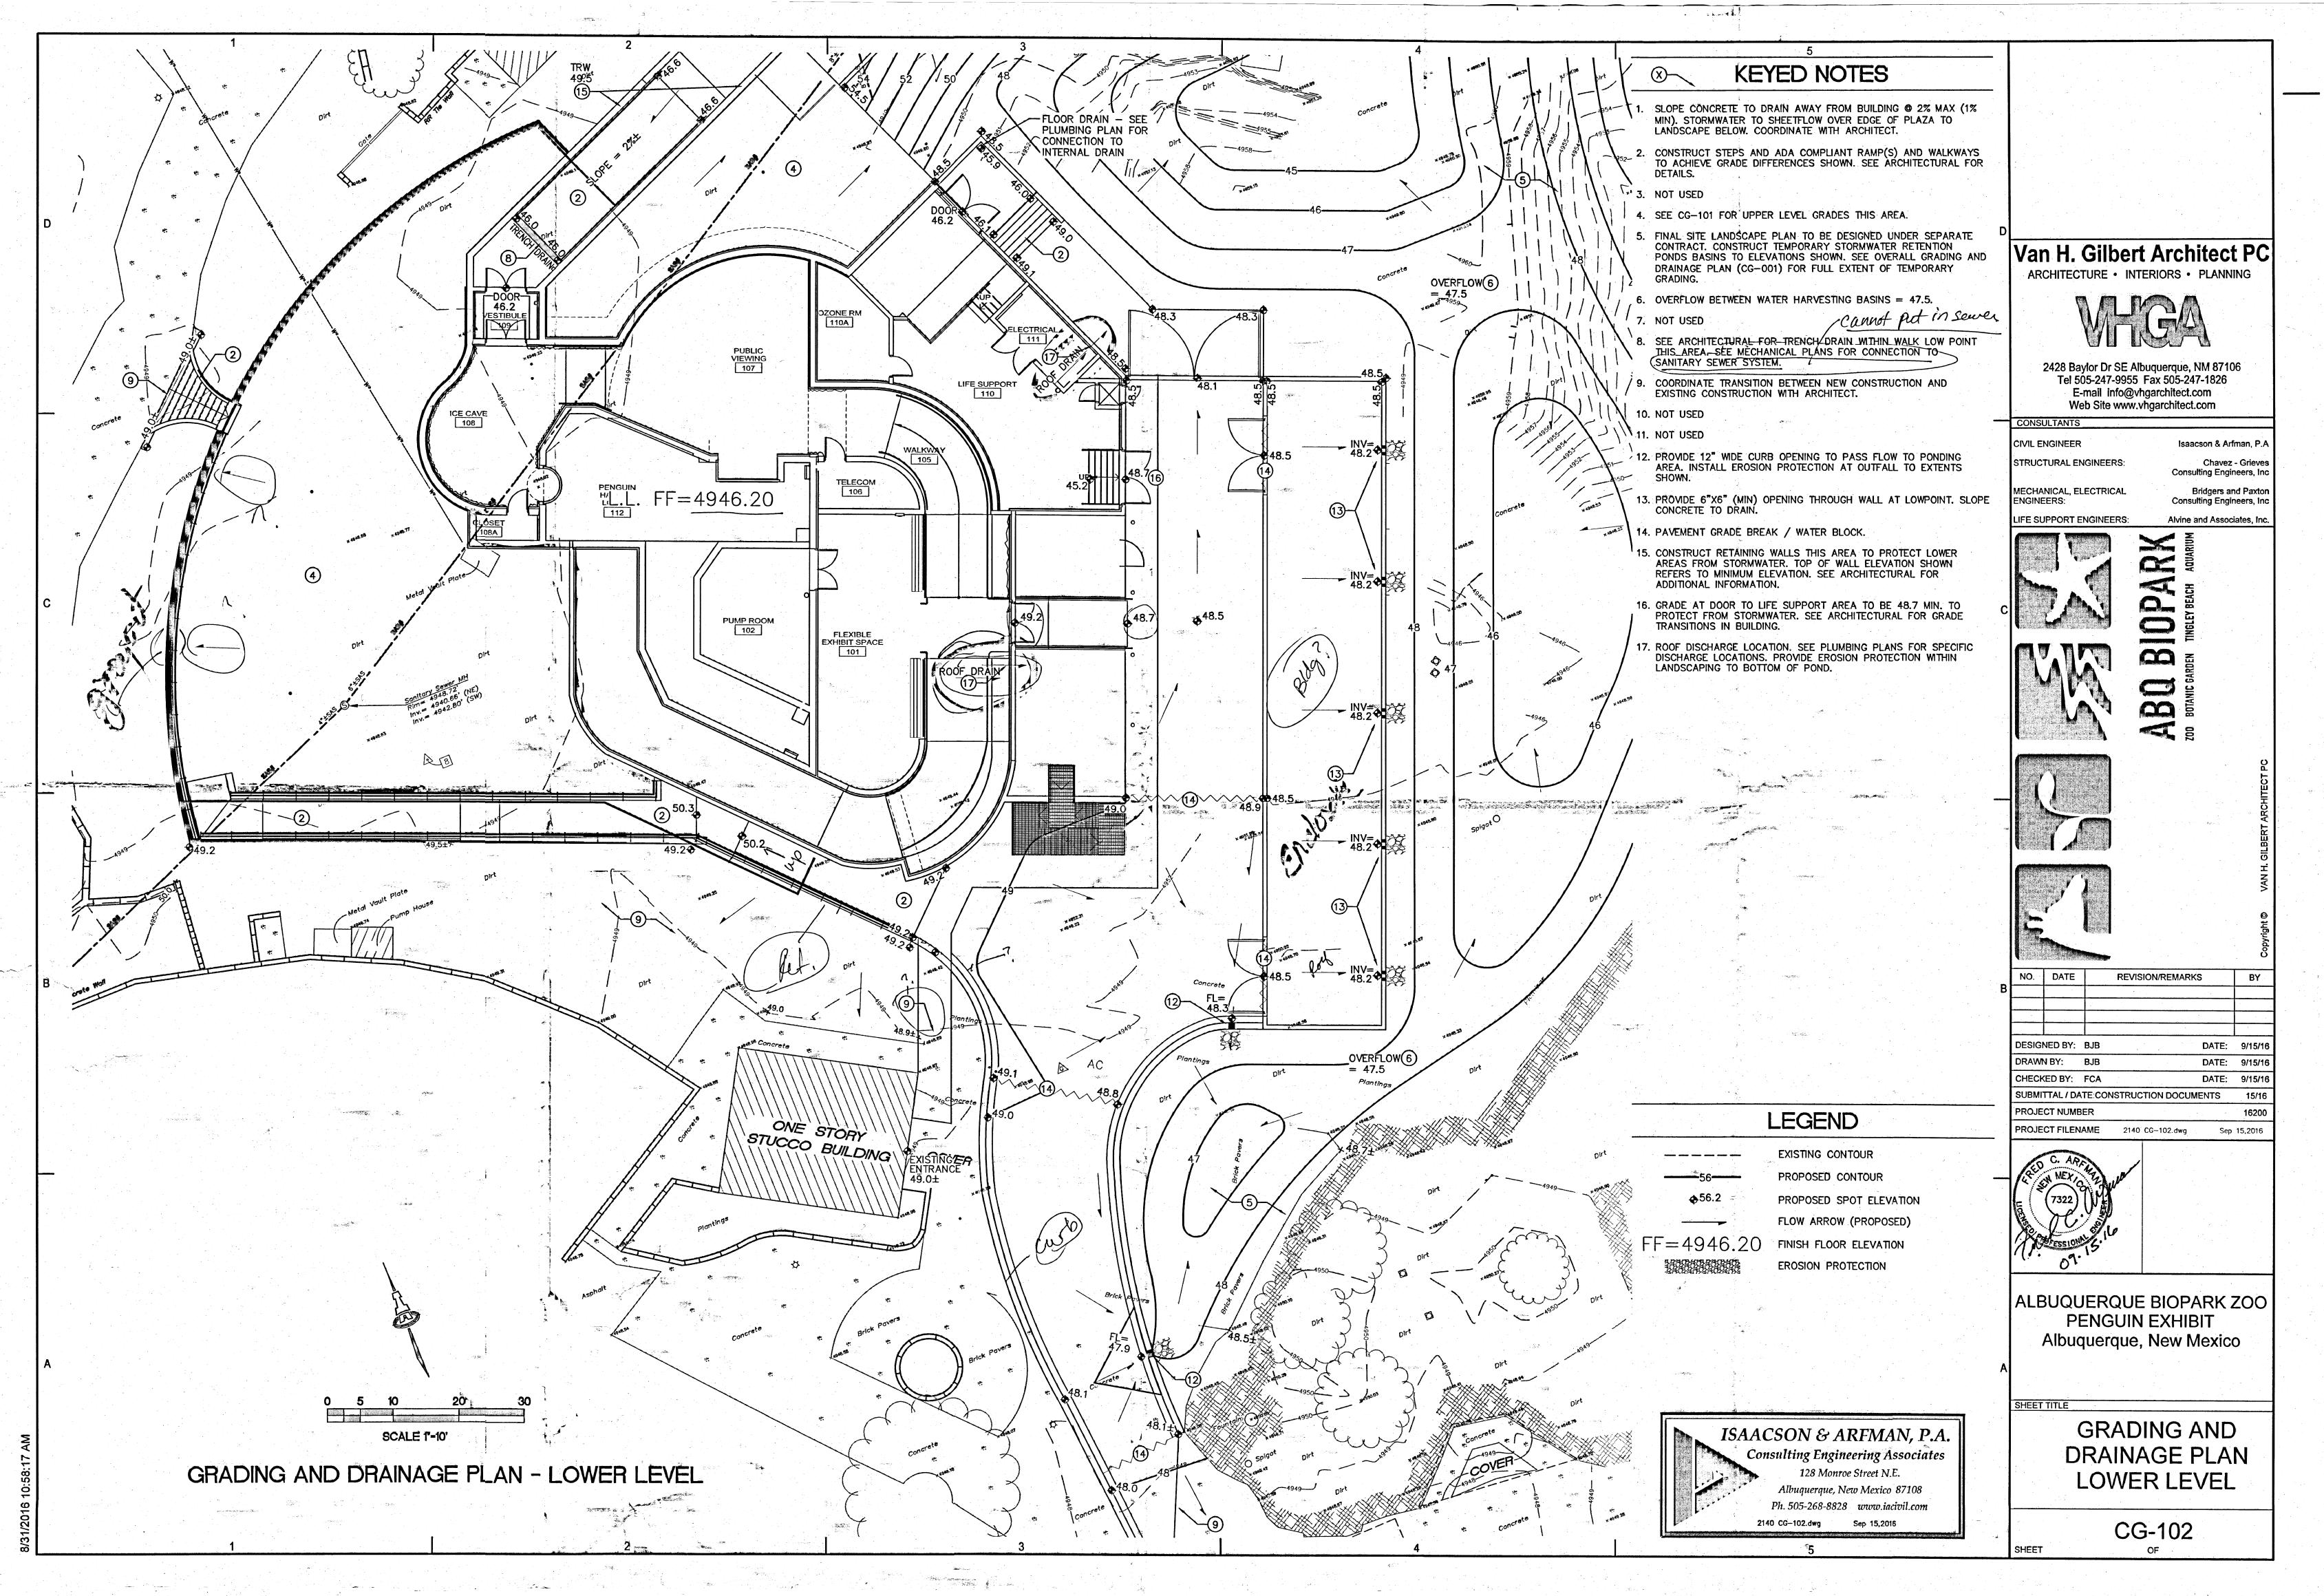

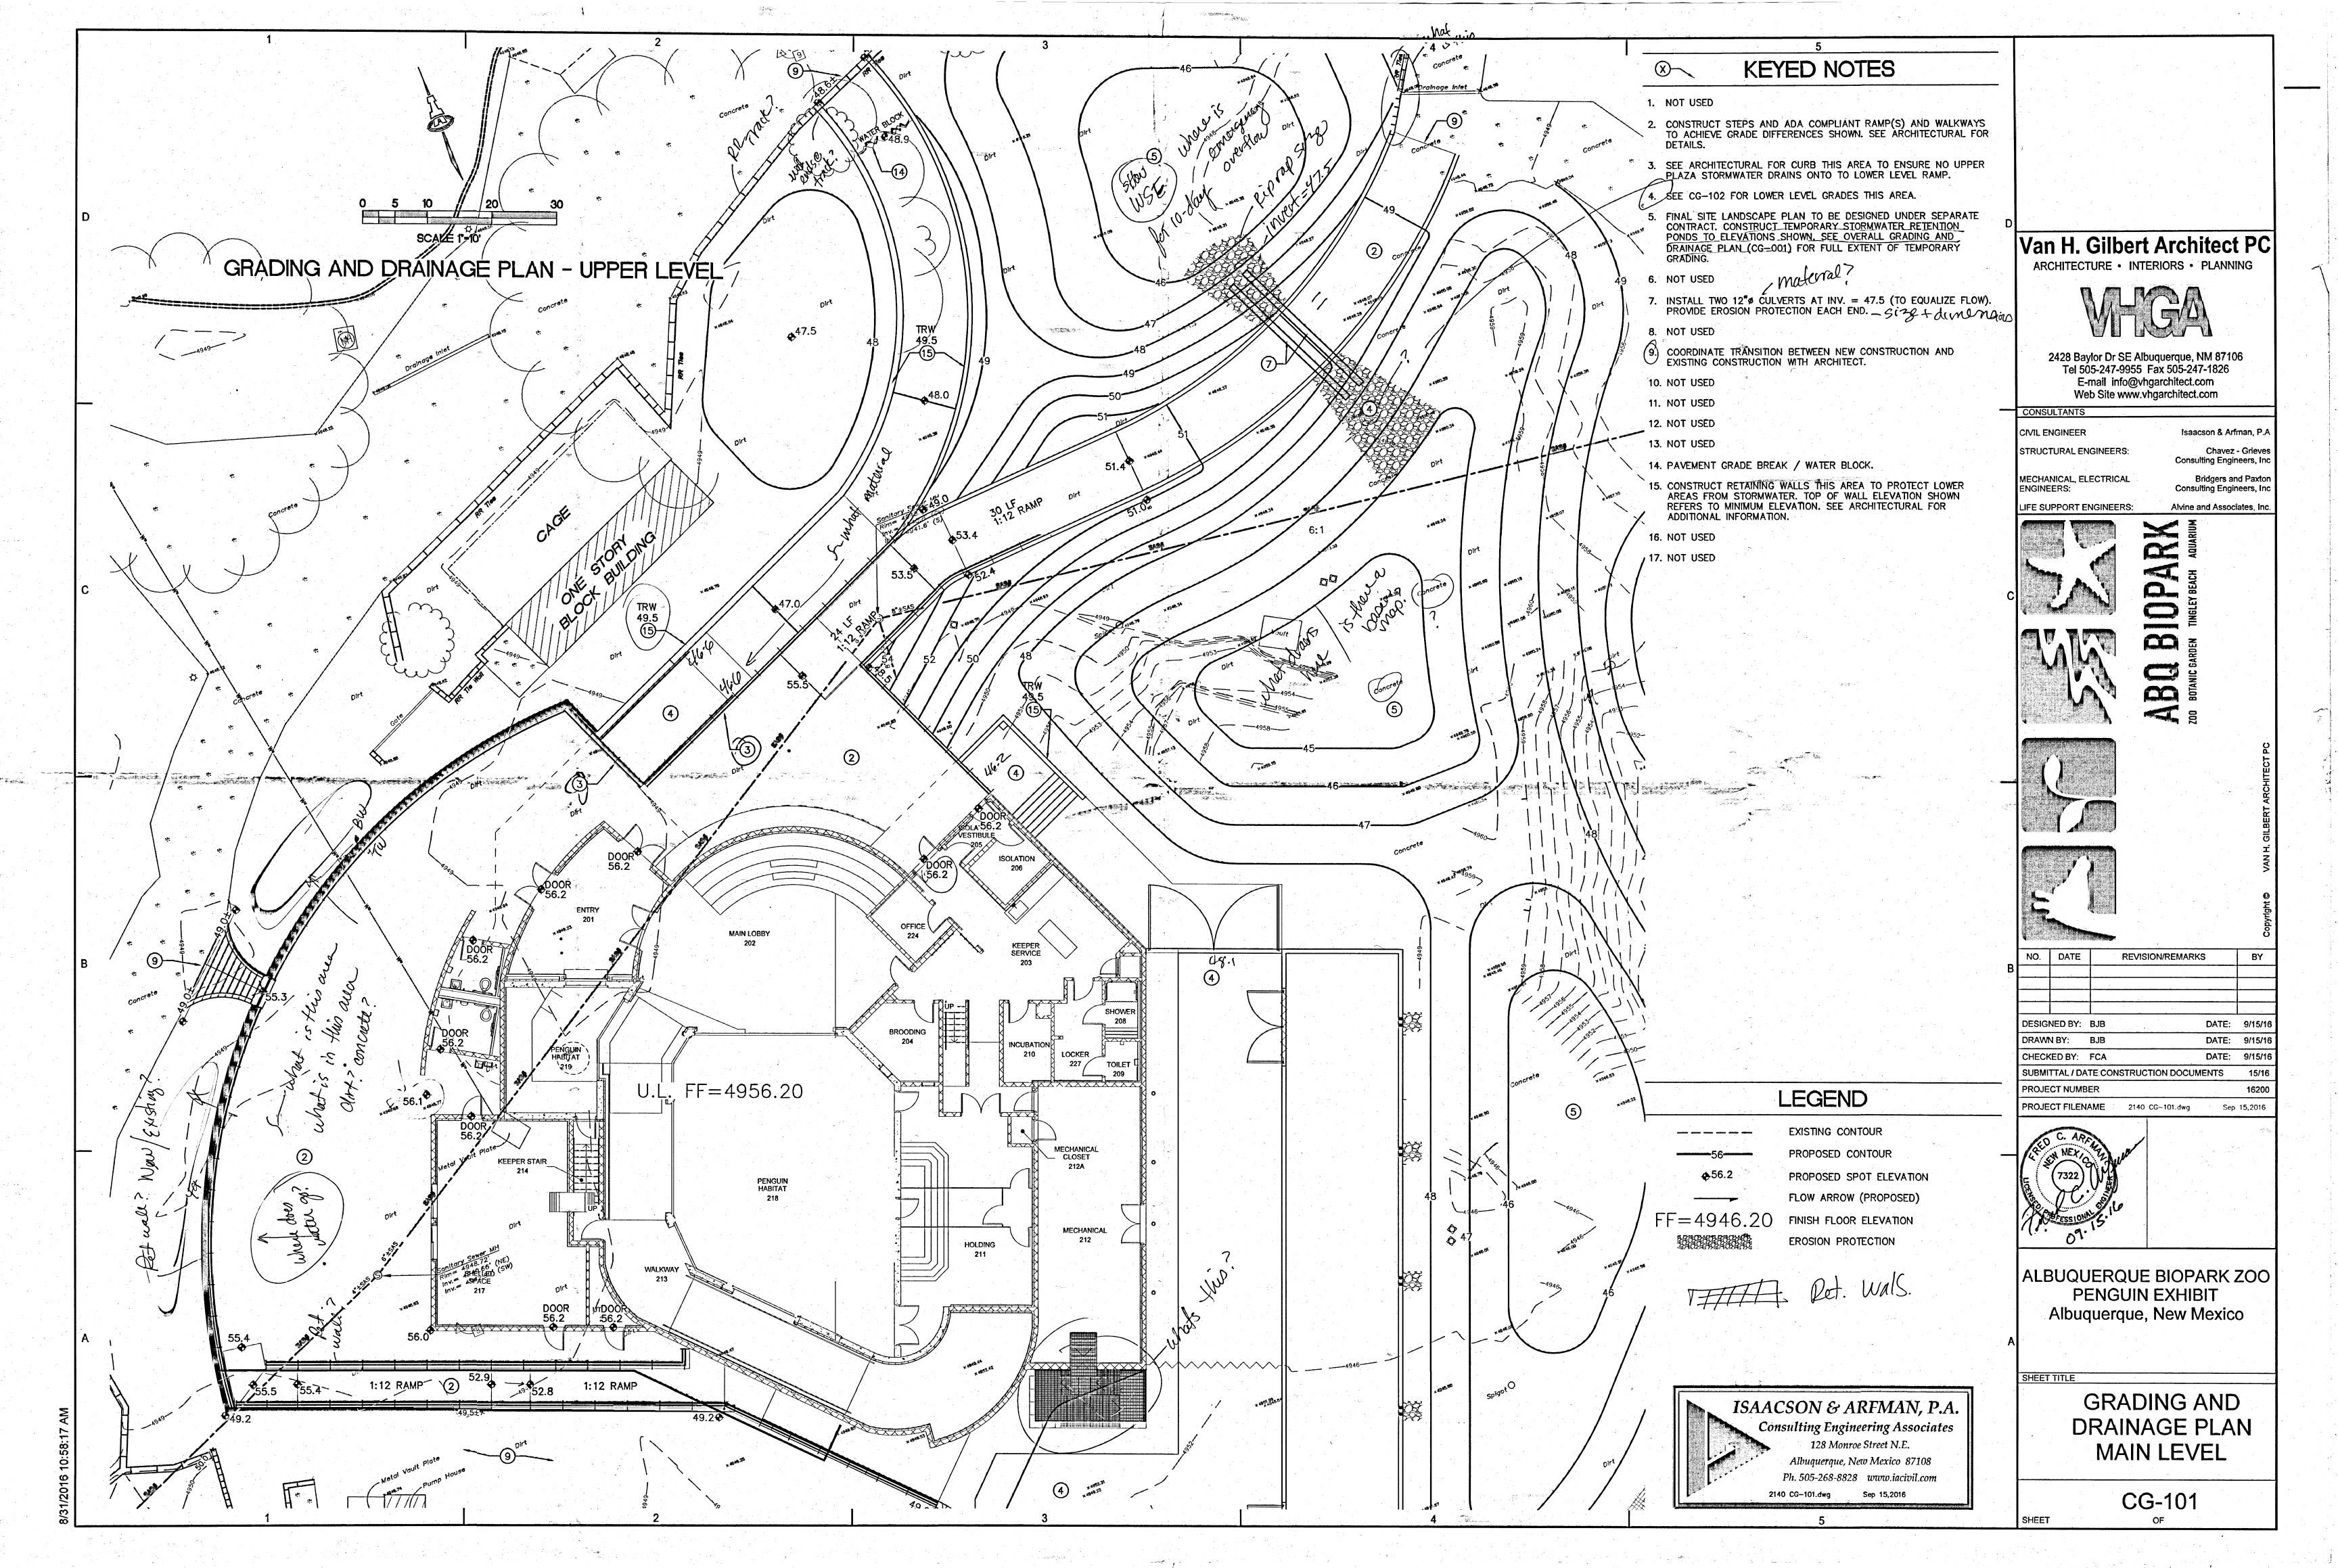

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MECHANICAL, ELECTRICAL **ENGINEERS:**

LIFE SUPPORT ENGINEERS:


Consulting Engineers, Inc Alvine and Associates, Inc

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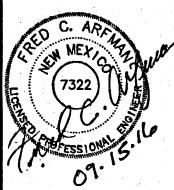




LAND DEVELOPMENT SECTION REVISION/REMARKS **FULL SHEET UPDATE**

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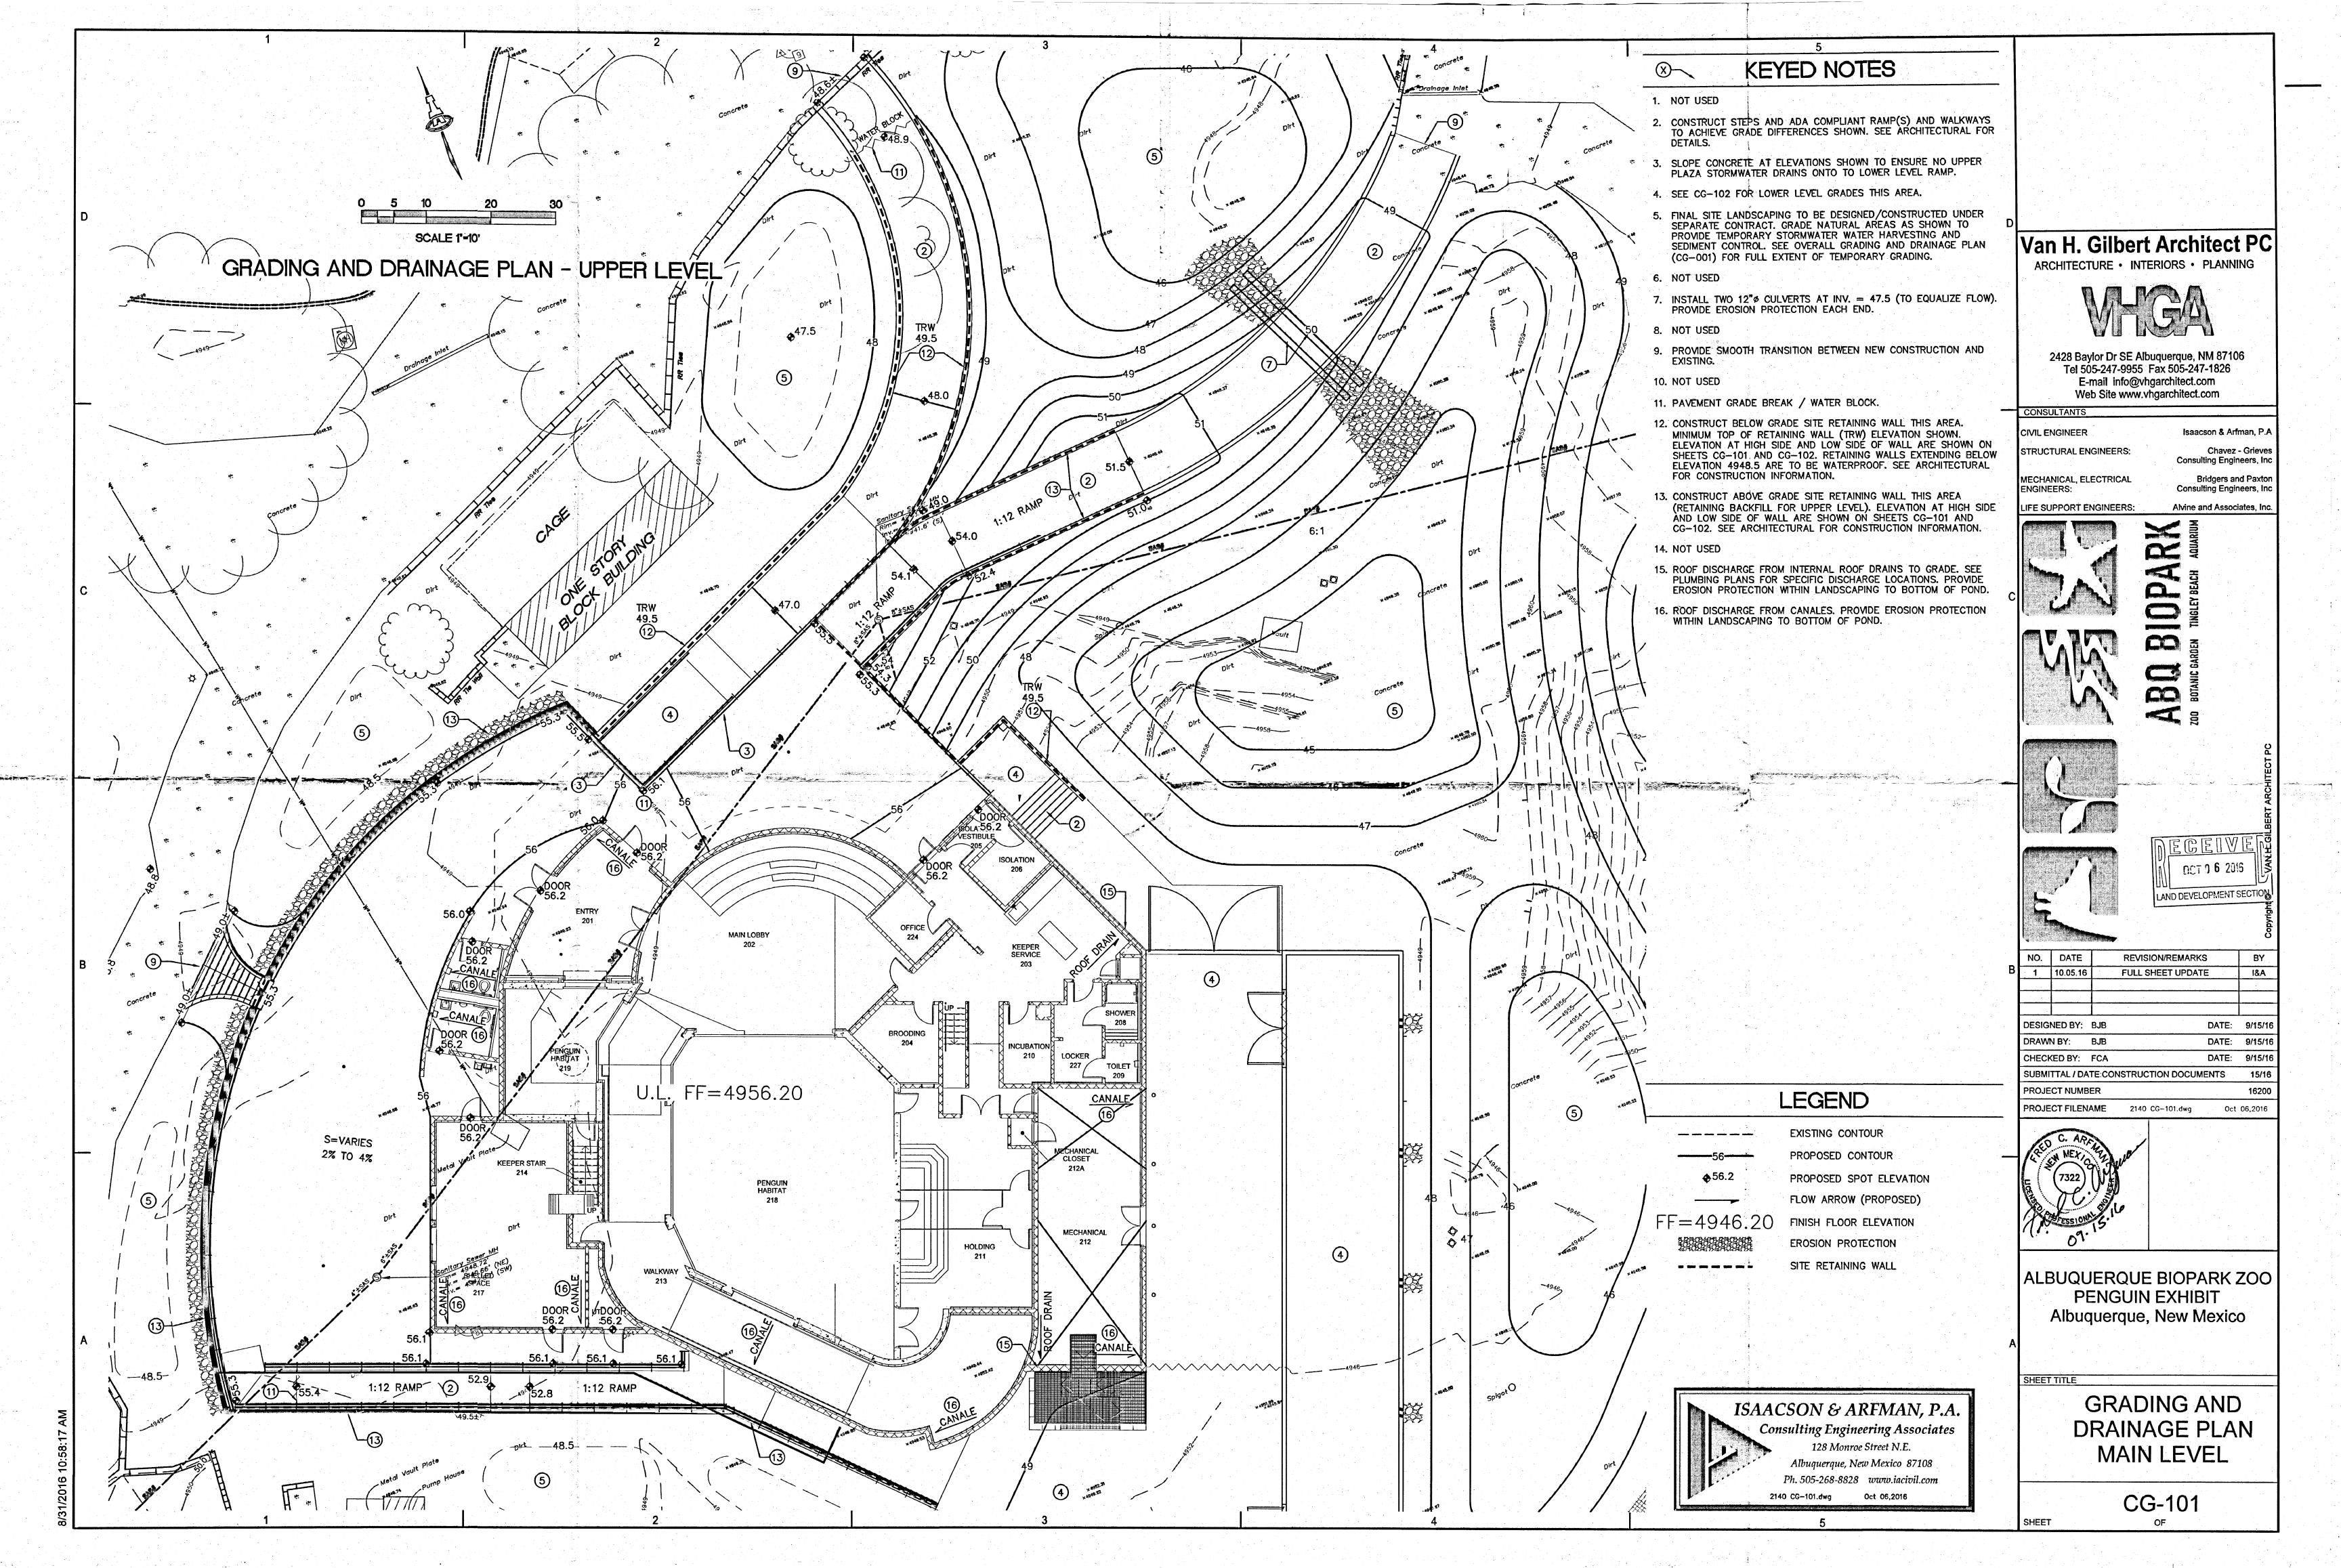
DESIGNED BY: BJB DATE: 9/15/1 DRAWN BY: BJB DATE: 9/15/1 CHECKED BY: FCA DATE: 9/15/1 SUBMITTAL / DATE: CONSTRUCTION DOCUMENTS

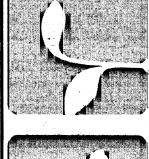


ALBUQUERQUE BIOPARK ZOO **PENGUIN EXHIBIT** Albuquerque, New Mexico

SHEET TITLE

GRADING AND DRAINAGE PLAN LOWER LEVEL



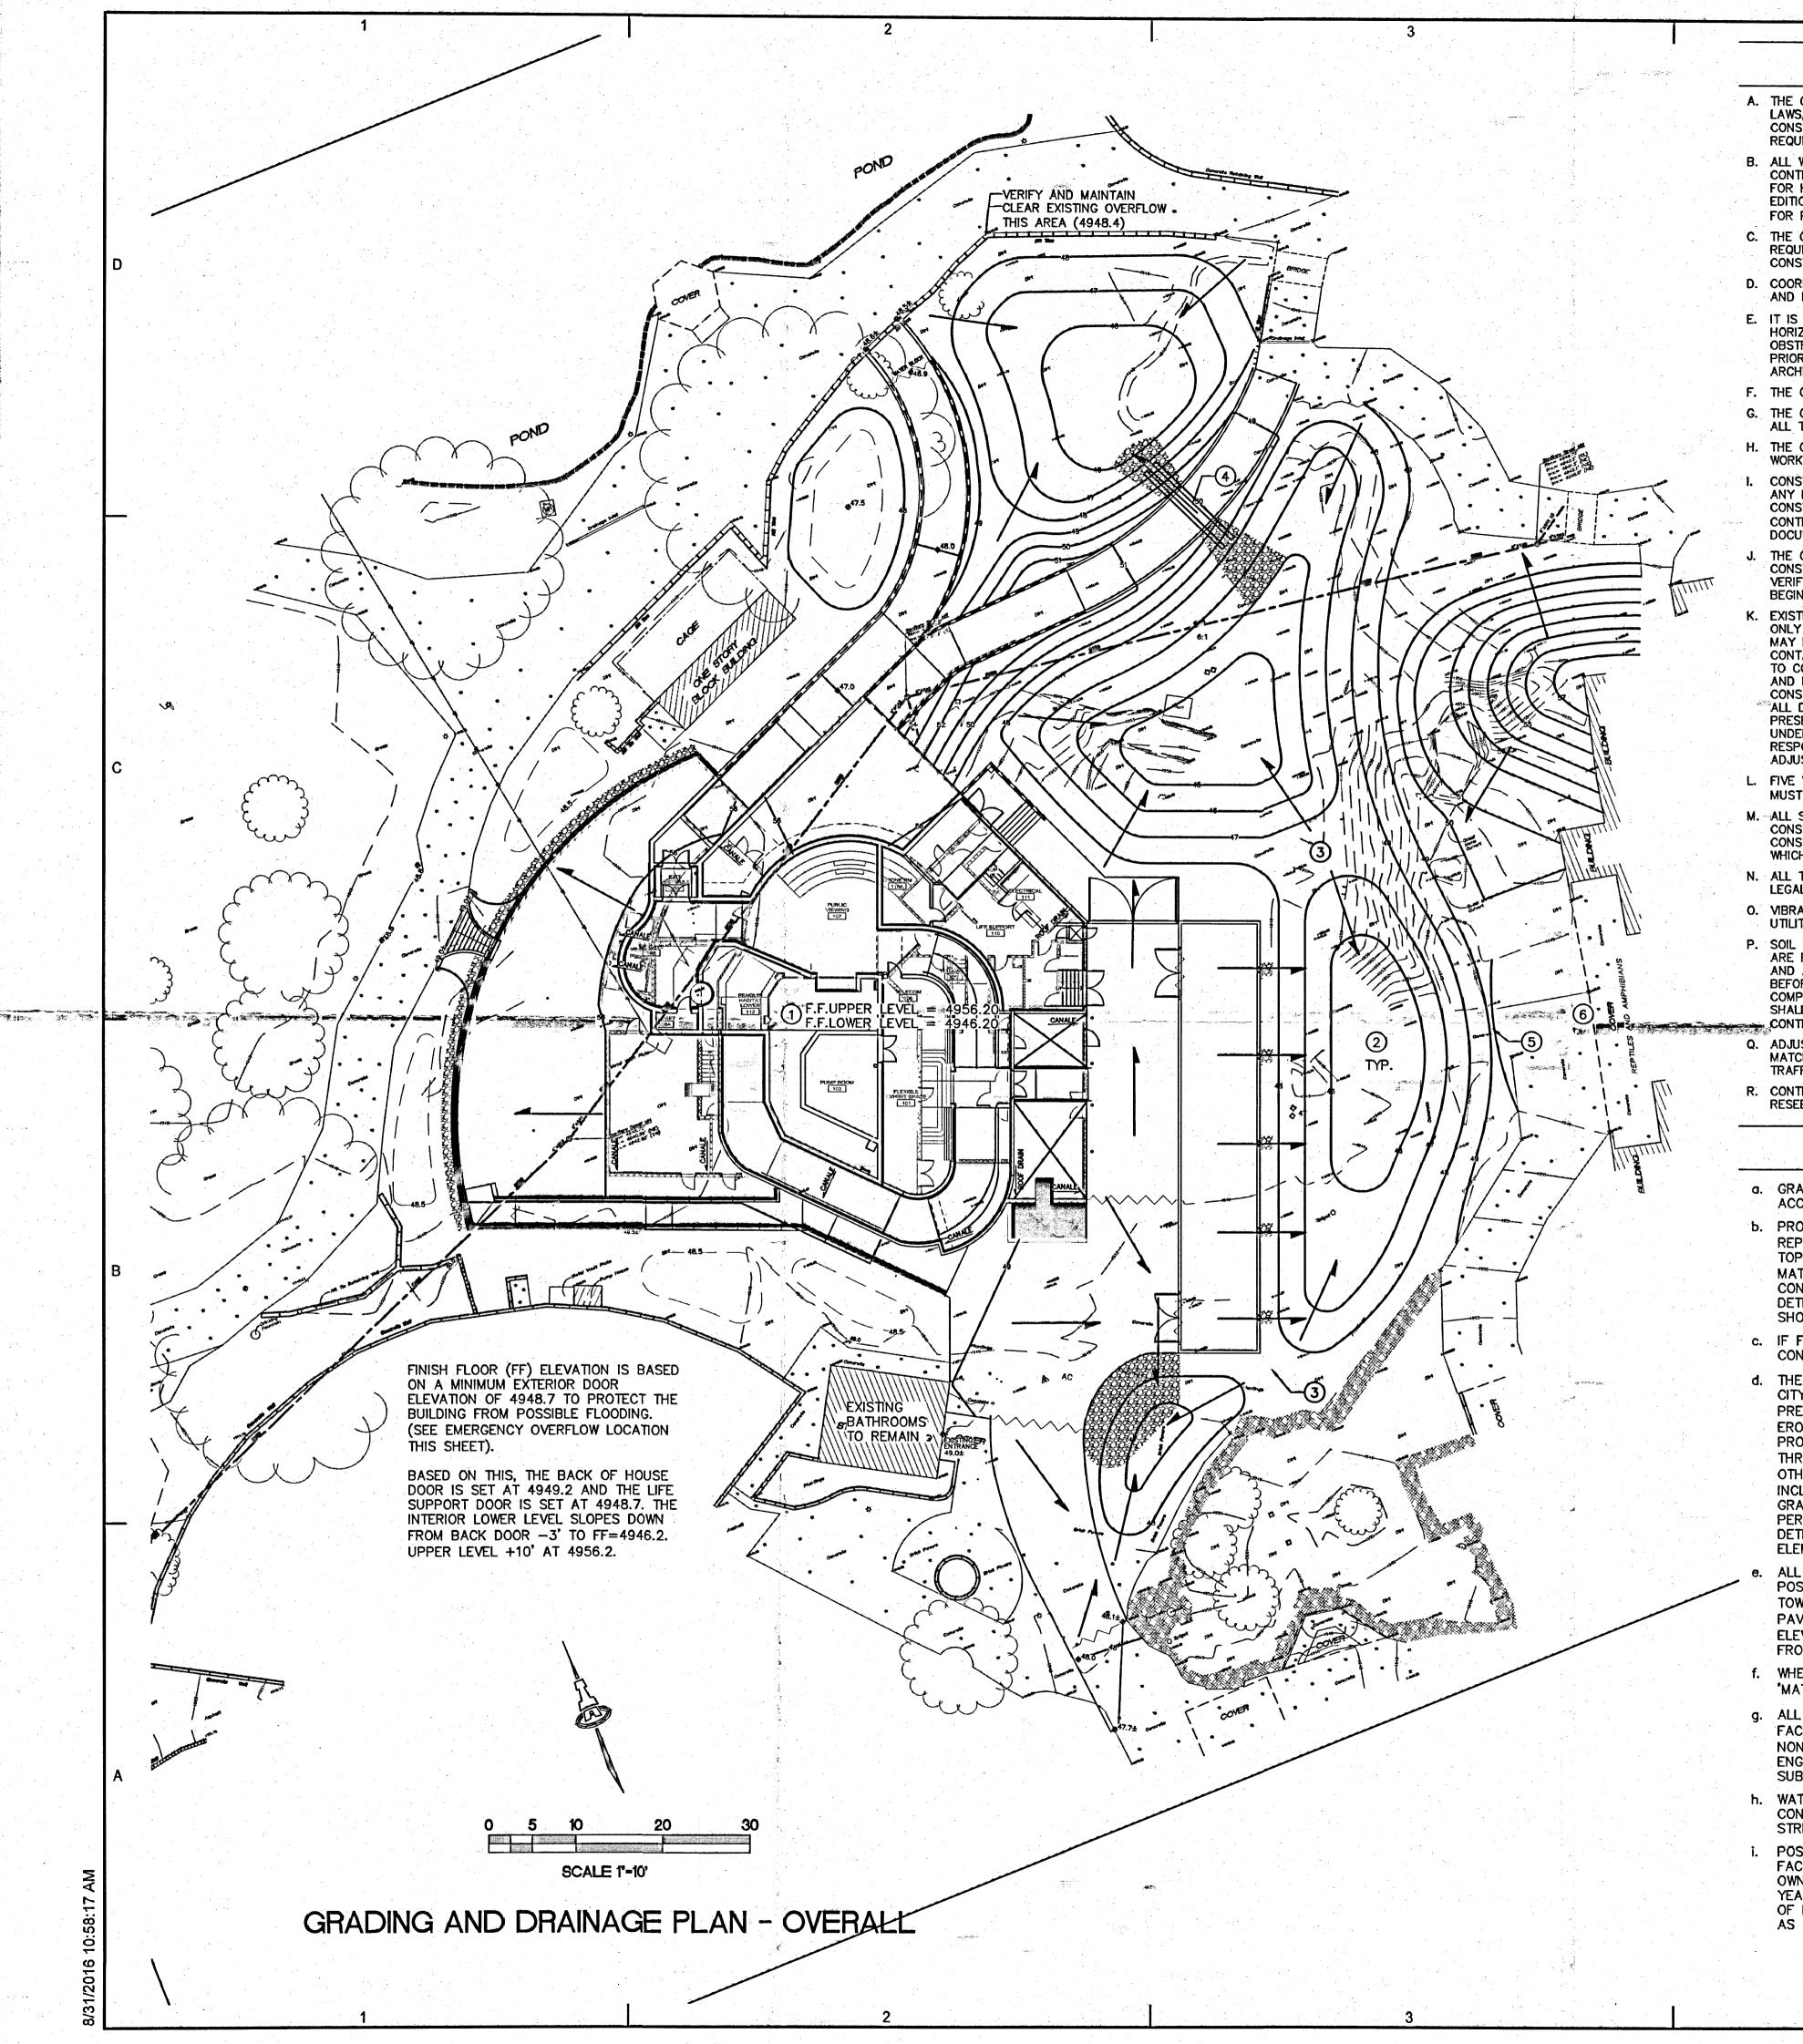


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VICINITY MAP



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LEGAL: TROPICAL AMERICA AND ADJACENT AREAS, RIO GRANDE ZOO, ALBUQUERQUE, NM

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KEYED NOTES

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LEGEND

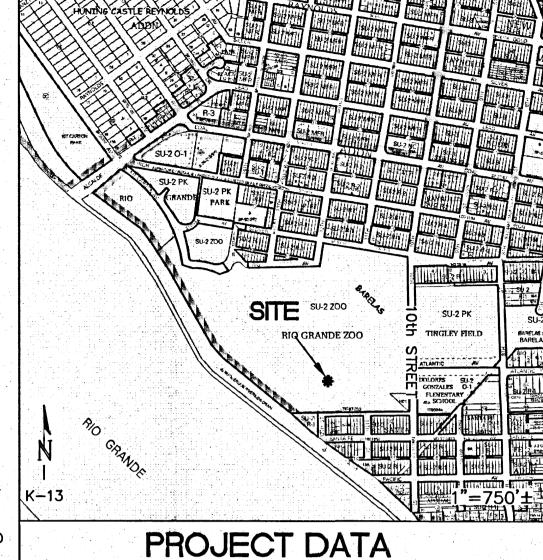EXISTING CONTOUR

FLOW ARROW (PROPOSED)

FINISH FLOOR ELEVATION

PROPOSED CONTOUR PROPOSED SPOT ELEVATION

FF = 4946.20

EROSION PROTECTION

ISAACSON & ARFMAN, P.A. Consulting Engineering Associates 128 Monroe Street N.E. Albuquerque, New Mexico 87108 Ph. 505-268-8828 www.iacivil.com 2140 CG-100.dwg Sep 16,2016

Van H. Gilbert Architect PC



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IVIL ENGINEER

CONSULTANTS

STRUCTURAL ENGINEERS

MECHANICAL, ELECTRICAL

LIFE SUPPORT ENGINEERS:

ENGINEERS:


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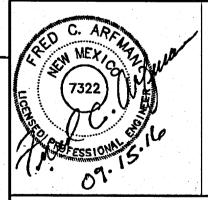




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NO. DATE REVISION/REMARKS 1 10.05.16 **FULL SHEET UPDATE** DESIGNED BY: BJB DATE: 9/15/16 DRAWN BY: BJB DATE: 9/15/16 DATE: 9/15/16


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ALBUQUERQUE BIOPARK ZOO **PENGUIN EXHIBIT** Albuquerque, New Mexico

SHEET TITLE

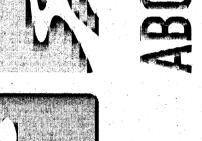OVERALL GRADING AND DRAINAGE PLAN




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- THE CONTRACTOR IS SOLELY RESPONSIBLE FOR OBTAINING ALL REQUIRED PERMITS FOR THE PROJECT PRIOR TO COMMENCING CONSTRUCTION, OR PRIOR TO OCCUPANCY, AS APPROPRIATE.
- AND LANDSCAPE PLAN. . IT IS THE CONTRACTOR'S RESPONSIBILITY TO FIELD VERIFY HORIZONTAL AND VERTICAL LOCATIONS OF ALL EXISTING
- OBSTRUCTIONS, AND CONDITION OF ALL EXISTING INFRASTRUCTURE PRIOR TO CONSTRUCTION. REPORT ALL DISCREPANCIES TO THE ARCHITECT AND VERIFY THE ARCHITECT INTENT BEFORE PROCEEDING.
- G. THE CONTRACTOR SHALL MAINTAIN RECORD DRAWINGS ON SITE AT
- I. THE CONTRACTOR SHALL OBTAIN ALL REQUIRED INSPECTIONS OF THE
- CONSTRUCTION ACTIVITY SHALL BE LIMITED TO THE PROJECT LIMITS. ANY DAMAGE TO ADJACENT STRUCTURES RESULTING FROM THE CONSTRUCTION PROCESS SHALL BE REPAIRED OR REPLACED AT THE CONTRACTOR'S EXPENSE. CONTRACTOR SHALL BE RESPONSIBLE FOR DOCUMENTING EXISTING CONDITIONS PRIOR TO CONSTRUCTION.
- THE CONTRACTOR SHALL MAINTAIN ALL BARRICADING AND CONSTRUCTION SIGNING AT ALL TIMES. THE CONTRACTOR SHALL VERIFY THE PROPER LOCATION OF ALL BARRICADING AT THE END AND BEGINNING OF EACH DAY.
- EXISTING UTILITY LINES ARE SHOWN IN AN APPROXIMATE MANNER ONLY AND MAY BE INCOMPLETE OR OBSOLETE, SUCH LINES MAY OR MAY NOT EXIST WHERE SHOWN OR NOT SHOWN. CONTRACTOR SHALL CONTACT NM-811 FOR UTILITY LINE SPOTS FIVE WORKING DAYS PRIOR TO CONDUCTING SITE FIELD WORK. CONTRACTOR SHALL FIELD VERIFY AND LOCATE ALL UTILITIES PRIOR TO COMMENCEMENT OF ANY CONSTRUCTION. CONTRACTOR IS FULLY RESPONSIBLE FOR ANY AND ALL DAMAGE CAUSED BY ITS FAILURE TO LOCATE, IDENTIFY AND PRESERVE ANY AND ALL EXISTING UTILITIES, PIPELINES, AND UNDERGROUND UTILITY LINES. THE CONTRACTOR SHALL BE RESPONSIBLE FOR COORDINATION OF NECESSARY DRY UTILITY
- FIVE WORKING DAYS PRIOR TO ANY EXCAVATION, THE CONTRACTOR MUST CONTACT NM811 (811) FOR LOCATION OF EXISTING UTILITIES.
- M. ALL SITE PREPARATION, GRADING OPERATIONS, FOUNDATION CONSTRUCTION, AND PAVEMENT INSTALLATION WORK SHALL BE CONSTRUCTED IN ACCORDANCE WITH THE GEOTECHNICAL REPORT, WHICH WILL BE PROVIDED BY THE OWNER OR ARCHITECT.
- ALL TRASH, DEBRIS, & SURFACE VEGETATION SHALL BE CLEARED AND LEGALLY DISPOSED OF OFFSITE.
- VIBRATORY COMPACTION SHALL NOT BE USED OVER IN-PLACE
- SOIL TESTING AND INSPECTION SERVICES DURING SITE OPERATIONS ARE REQUIRED. CONTRACTOR SHALL ALLOW TESTING LABS TO INSPECT AND APPROVE COMPACTED SUBGRADES, BACKFILL, AND FILL LAYERS BEFORE FURTHER CONSTRUCTION WORK IS DONE. SHOULD COMPACTION TESTS INDICATE INADEQUATE DENSITY, CONTRACTOR SHALL PROVIDE ADDITIONAL COMPACTION AND TESTING AT THE CONTRACTOR'S SOLE EXPENSE.
- ADJUST ANY RIMS OF EXISTING UTILITY FEATURES AS NECESSARY TO MATCH NEW GRADES. UTILITIES IN PAVED AREAS SHALL BE HS-25
- . CONTRACTOR SHALL COMPLY WITH LOCAL REGULATIONS FOR RESEEDING OF DISTURBED AREAS.

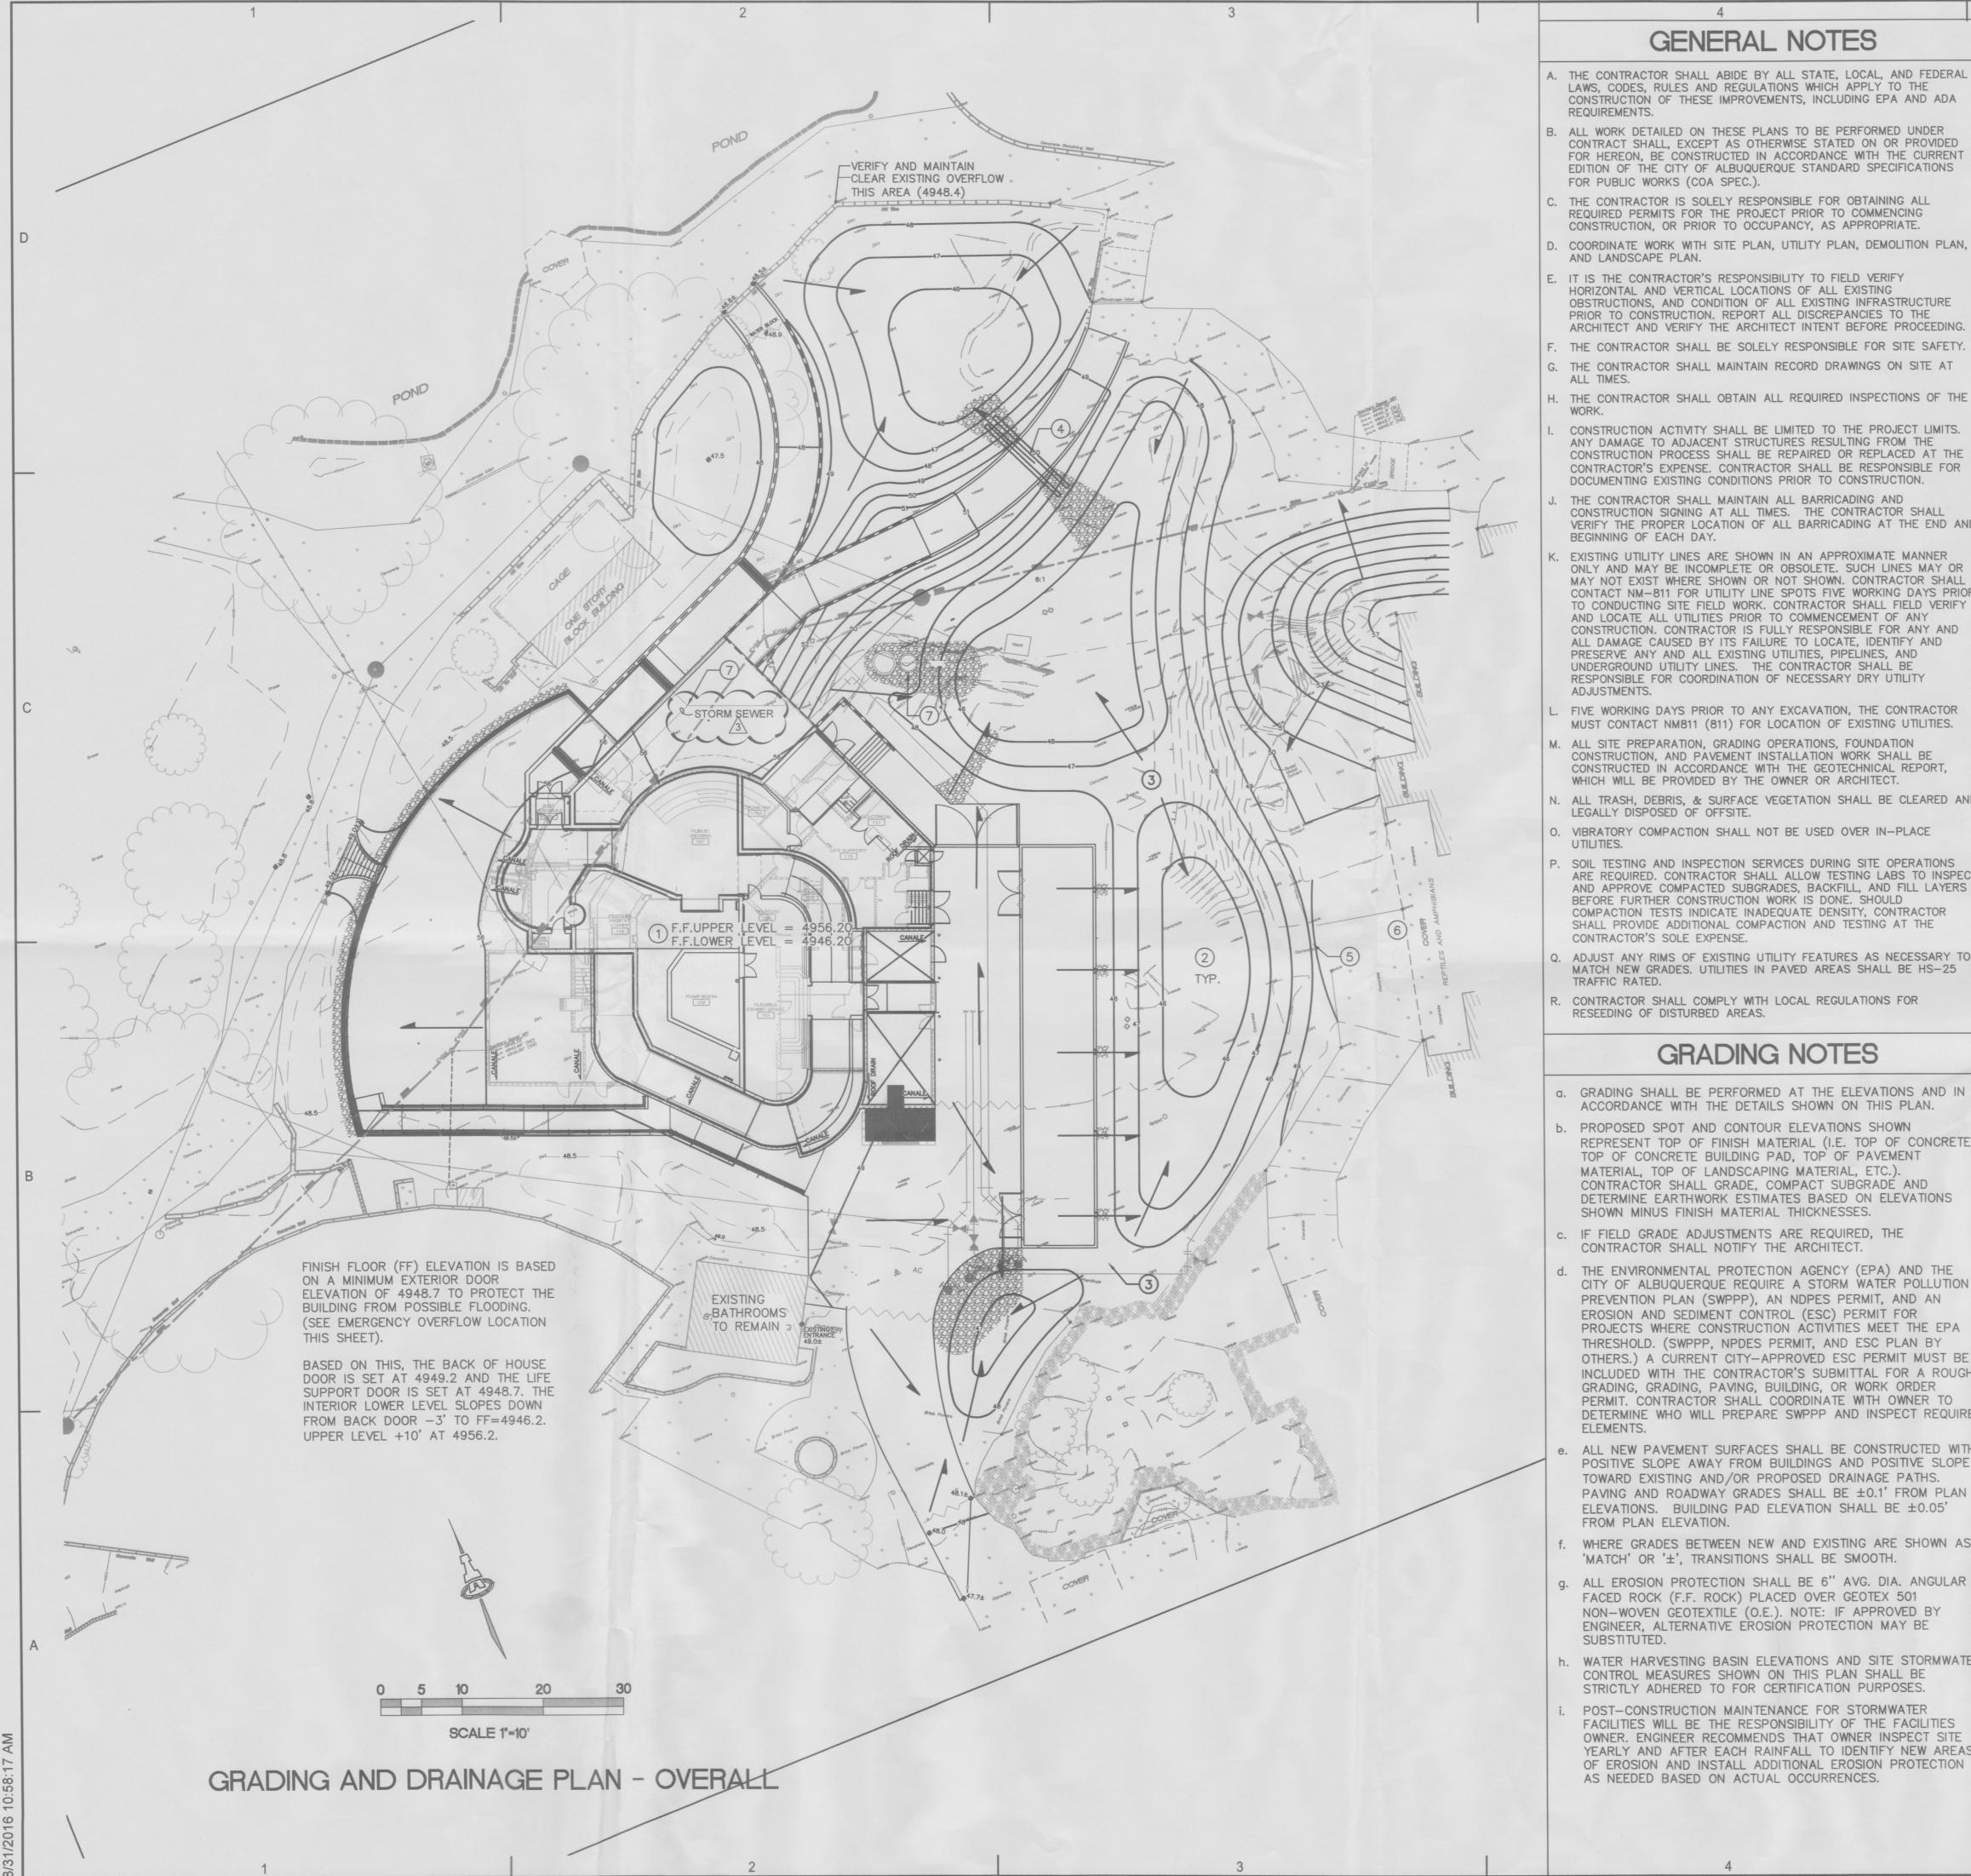GRADING NOTES

- g. GRADING SHALL BE PERFORMED AT THE ELEVATIONS AND IN ACCORDANCE WITH THE DETAILS SHOWN ON THIS PLAN.
- PROPOSED SPOT AND CONTOUR ELEVATIONS SHOWN REPRESENT TOP OF FINISH MATERIAL (I.E. TOP OF CONCRETE, TOP OF CONCRETE BUILDING PAD, TOP OF PAVEMENT MATERIAL, TOP OF LANDSCAPING MATERIAL, ETC.). CONTRACTOR SHALL GRADE, COMPACT SUBGRADE AND DETERMINE EARTHWORK ESTIMATES BASED ON ELEVATIONS SHOWN MINUS FINISH MATERIAL THICKNESSES.
- IF FIELD GRADE ADJUSTMENTS ARE REQUIRED, THE CONTRACTOR SHALL NOTIFY THE ARCHITECT.
- d. THE ENVIRONMENTAL PROTECTION AGENCY (EPA) AND THE CITY OF ALBUQUERQUE REQUIRE A STORM WATER POLLUTION PREVENTION PLAN (SWPPP), AN NDPES PERMIT, AND AN EROSION AND SEDIMENT CONTROL (ESC) PERMIT FOR PROJECTS WHERE CONSTRUCTION ACTIVITIES MEET THE EPA THRESHOLD. (SWPPP, NPDES PERMIT, AND ESC PLAN BY OTHERS.) A CURRENT CITY-APPROVED ESC PERMIT MUST BE INCLUDED WITH THE CONTRACTOR'S SUBMITTAL FOR A ROUGH GRADING, GRADING, PAVING, BUILDING, OR WORK ORDER PERMIT. CONTRACTOR SHALL COORDINATE WITH OWNER TO DETERMINE WHO WILL PREPARE SWPPP AND INSPECT REQUIRED
- ALL NEW PAVEMENT SURFACES SHALL BE CONSTRUCTED WITH POSITIVE SLOPE AWAY FROM BUILDINGS AND POSITIVE SLOPE TOWARD EXISTING AND/OR PROPOSED DRAINAGE PATHS. PAVING AND ROADWAY GRADES SHALL BE ±0.1' FROM PLAN ELEVATIONS. BUILDING PAD ELEVATION SHALL BE ±0.05' FROM PLAN ELEVATION.
- WHERE GRADES BETWEEN NEW AND EXISTING ARE SHOWN AS 'MATCH' OR '±', TRANSITIONS SHALL BE SMOOTH.
- ALL EROSION PROTECTION SHALL BE 6" AVG. DIA. ANGULAR FACED ROCK (F.F. ROCK) PLACED OVER GEOTEX 501 NON-WOVEN GEOTEXTILE (O.E.). NOTE: IF APPROVED BY ENGINEER, ALTERNATIVE EROSION PROTECTION MAY BE SUBSTITUTED.
- WATER HARVESTING BASIN ELEVATIONS AND SITE STORMWATER CONTROL MEASURES SHOWN ON THIS PLAN SHALL BE STRICTLY ADHERED TO FOR CERTIFICATION PURPOSES.
- POST-CONSTRUCTION MAINTENANCE FOR STORMWATER FACILITIES WILL BE THE RESPONSIBILITY OF THE FACILITIES OWNER. ENGINEER RECOMMENDS THAT OWNER INSPECT SITE YEARLY AND AFTER EACH RAINFALL TO IDENTIFY NEW AREAS OF EROSION AND INSTALL ADDITIONAL EROSION PROTECTION AS NEEDED BASED ON ACTUAL OCCURRENCES.

VICINITY MAP

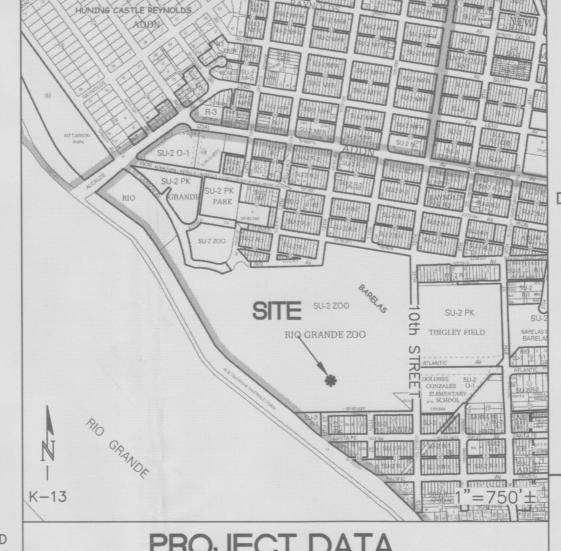

PROJECT DATA

PROPERTY: THE SITE IS A PORTION OF THE ALBUQUERQUE RIO GRANDE ZOO PROPERTY LOCATED WITHIN C.O.A. VICINITY MAP K-13. THE SITE IS BOUND TO THE NORTH AND WEST BY THE MAIN PARK AREA AND BANDSTAND POND, AND TO THE SOUTH AND EAST BY EXISTING ANIMAL

PROPOSED IMPROVEMENTS: THE PROPOSED IMPROVEMENTS INCLUDE A NEW FACILITY HOUSING THE PENGUIN EXHIBIT WITH ASSOCIATED CONCRETE WALKS AND LANDSCAPING. DRAINAGE IMPROVEMENTS WILL BE CONSTRUCTED TO ADDRESS BUILDING DISCHARGE.

LEGAL: TROPICAL AMERICA AND ADJACENT AREAS, RIO GRANDE ZOO, ALBUQUERQUE, NM

BENCHMARK: VERTICAL DATUM IS BASED UPON THE ALBUQUERQUE CONTROL STATION MONUMENT "12-L14", ELEVATION = 4947.708 FEET (NAVD 1988), AS PUBLISHED.

OFF-SITE: NO OFFSITE FLOW IMPACTS THIS PROPERTY.

FLOOD HAZARD: PER BERNALILLO COUNTY FIRM MAP #333, THE SITE IS LOCATED WITHIN FLOOD ZONE 'X' (SHADED) DESIGNATED AS AREA OF MODERATE FLOOD HAZARD, USUALLY THE AREA BETWEEN THE LIMITS OF THE 100-YEAR AND 500-YEAR FLOODS.

DRAINAGE PLAN CONCEPT: THE PROPOSED AREA TO BE DEVELOPED PREVIOUSLY HOUSED THE TROPICAL AMERICA EXHIBIT AND EXTENSIVE WALKS AND COVERED AREAS. THE TOTAL PROPOSED IMPERVIOUS AREA WILL BE APPROXIMATELY THE SAME AS THE PRE-DEVELOPED CONDITION. HISTORICALLY, THIS AREA UTILIZED FLAT GRADING CONCEPT WHICH DIRECTED STORMWATER TO LOCALIZED WATER HARVESTING AREAS WITHIN THE LANDSCAPING WITH EXCESS OVERFLOWING TO THE NORTH AND SOUTH. THE PROPOSED DEVELOPMENT WILL ALSO UTILIZE WATER HARVESTING BASINS FOR INFILTRATION, EXCESS STORMWATER WILL CONTINUE TO OVERFLOW TO THE NORTH AND SOUTH. LANDSCAPING FOR THIS EXHIBIT WILL BE CONTRACTED SEPARATELY BY OWNER. THE DESIGN WILL BE REQUIRED TO MAINTAIN THE FLAT GRADING CONCEPT WITH OVERFLOW ELEVATIONS AS SHOWN.

KEYED NOTES

KEYED NOTES REFERENCE OVERALL GRADING (SCALE 1:20) AROUND BUILDING. SEE CG-101 AND CG-102 FOR SPECIFIC KEYED NOTES FOR UPPER LEVEL (SHOWN FADED) AND LOWER LEVEL GRADING AND DRAINAGE

- . SEE CG-101 FOR UPPER LEVEL GRADES THIS AREA. SEE CG-102
- FOR LOWER LEVEL GRADES THIS AREA. 2. FINAL SITE LANDSCAPE PLAN TO BE DESIGNED UNDER SEPARATE CONTRACT. CONSTRUCT TEMPORARY WATER HARVESTING /
- SEDIMENT CONTROL BASINS TO ELEVATIONS SHOWN. 3. OVERFLOW BETWEEN WATER HARVESTING BASINS = 47.5.
- 4. INSTALL TWO 12" O CULVERTS WITH END SECTIONS. PROVIDE EROSION PROTECTION EACH END.
- 5. GRADE THIS AREA WITH BERM (TOP OF BERM 49.0) TO PREVENT STORMWATER FROM BACKING UP INTO REPTILE AND AMPHIBIAN
- EXISTING STORMWATER FROM THIS AREA WILL CONTINUE TO DRAIN TO THE REPTILE AND AMPHIBIAN AREA. 7. SEE CG-501 AND CG-502 FOR STORM SEWER SYSTEM.

LEGEND

EROSION PROTECTION

EXISTING CONTOUR PROPOSED CONTOUR ____56____ **\$56.2** PROPOSED SPOT ELEVATION

FLOW ARROW (PROPOSED) FF = 4946. FINISH FLOOR ELEVATION

ISAACSON & ARFMAN, P.A. Consulting Engineering Associates 128 Monroe Street N.E. Albuquerque, New Mexico 87108 Ph. 505-268-8828 www.iacivil.com 2140 CG-100.dwg Nov 16,2016

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Chavez - Grieves

Bridgers and Paxton

LIFE SUPPORT ENGINEERS: Alvine and Associates, Inc.

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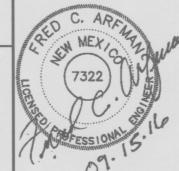




NO. DATE REVISION/REMARKS 1 10.05.16 **FULL SHEET UPDATE** I&A 3 | 11.16.16 | STORM DRAIN ADDED I&A

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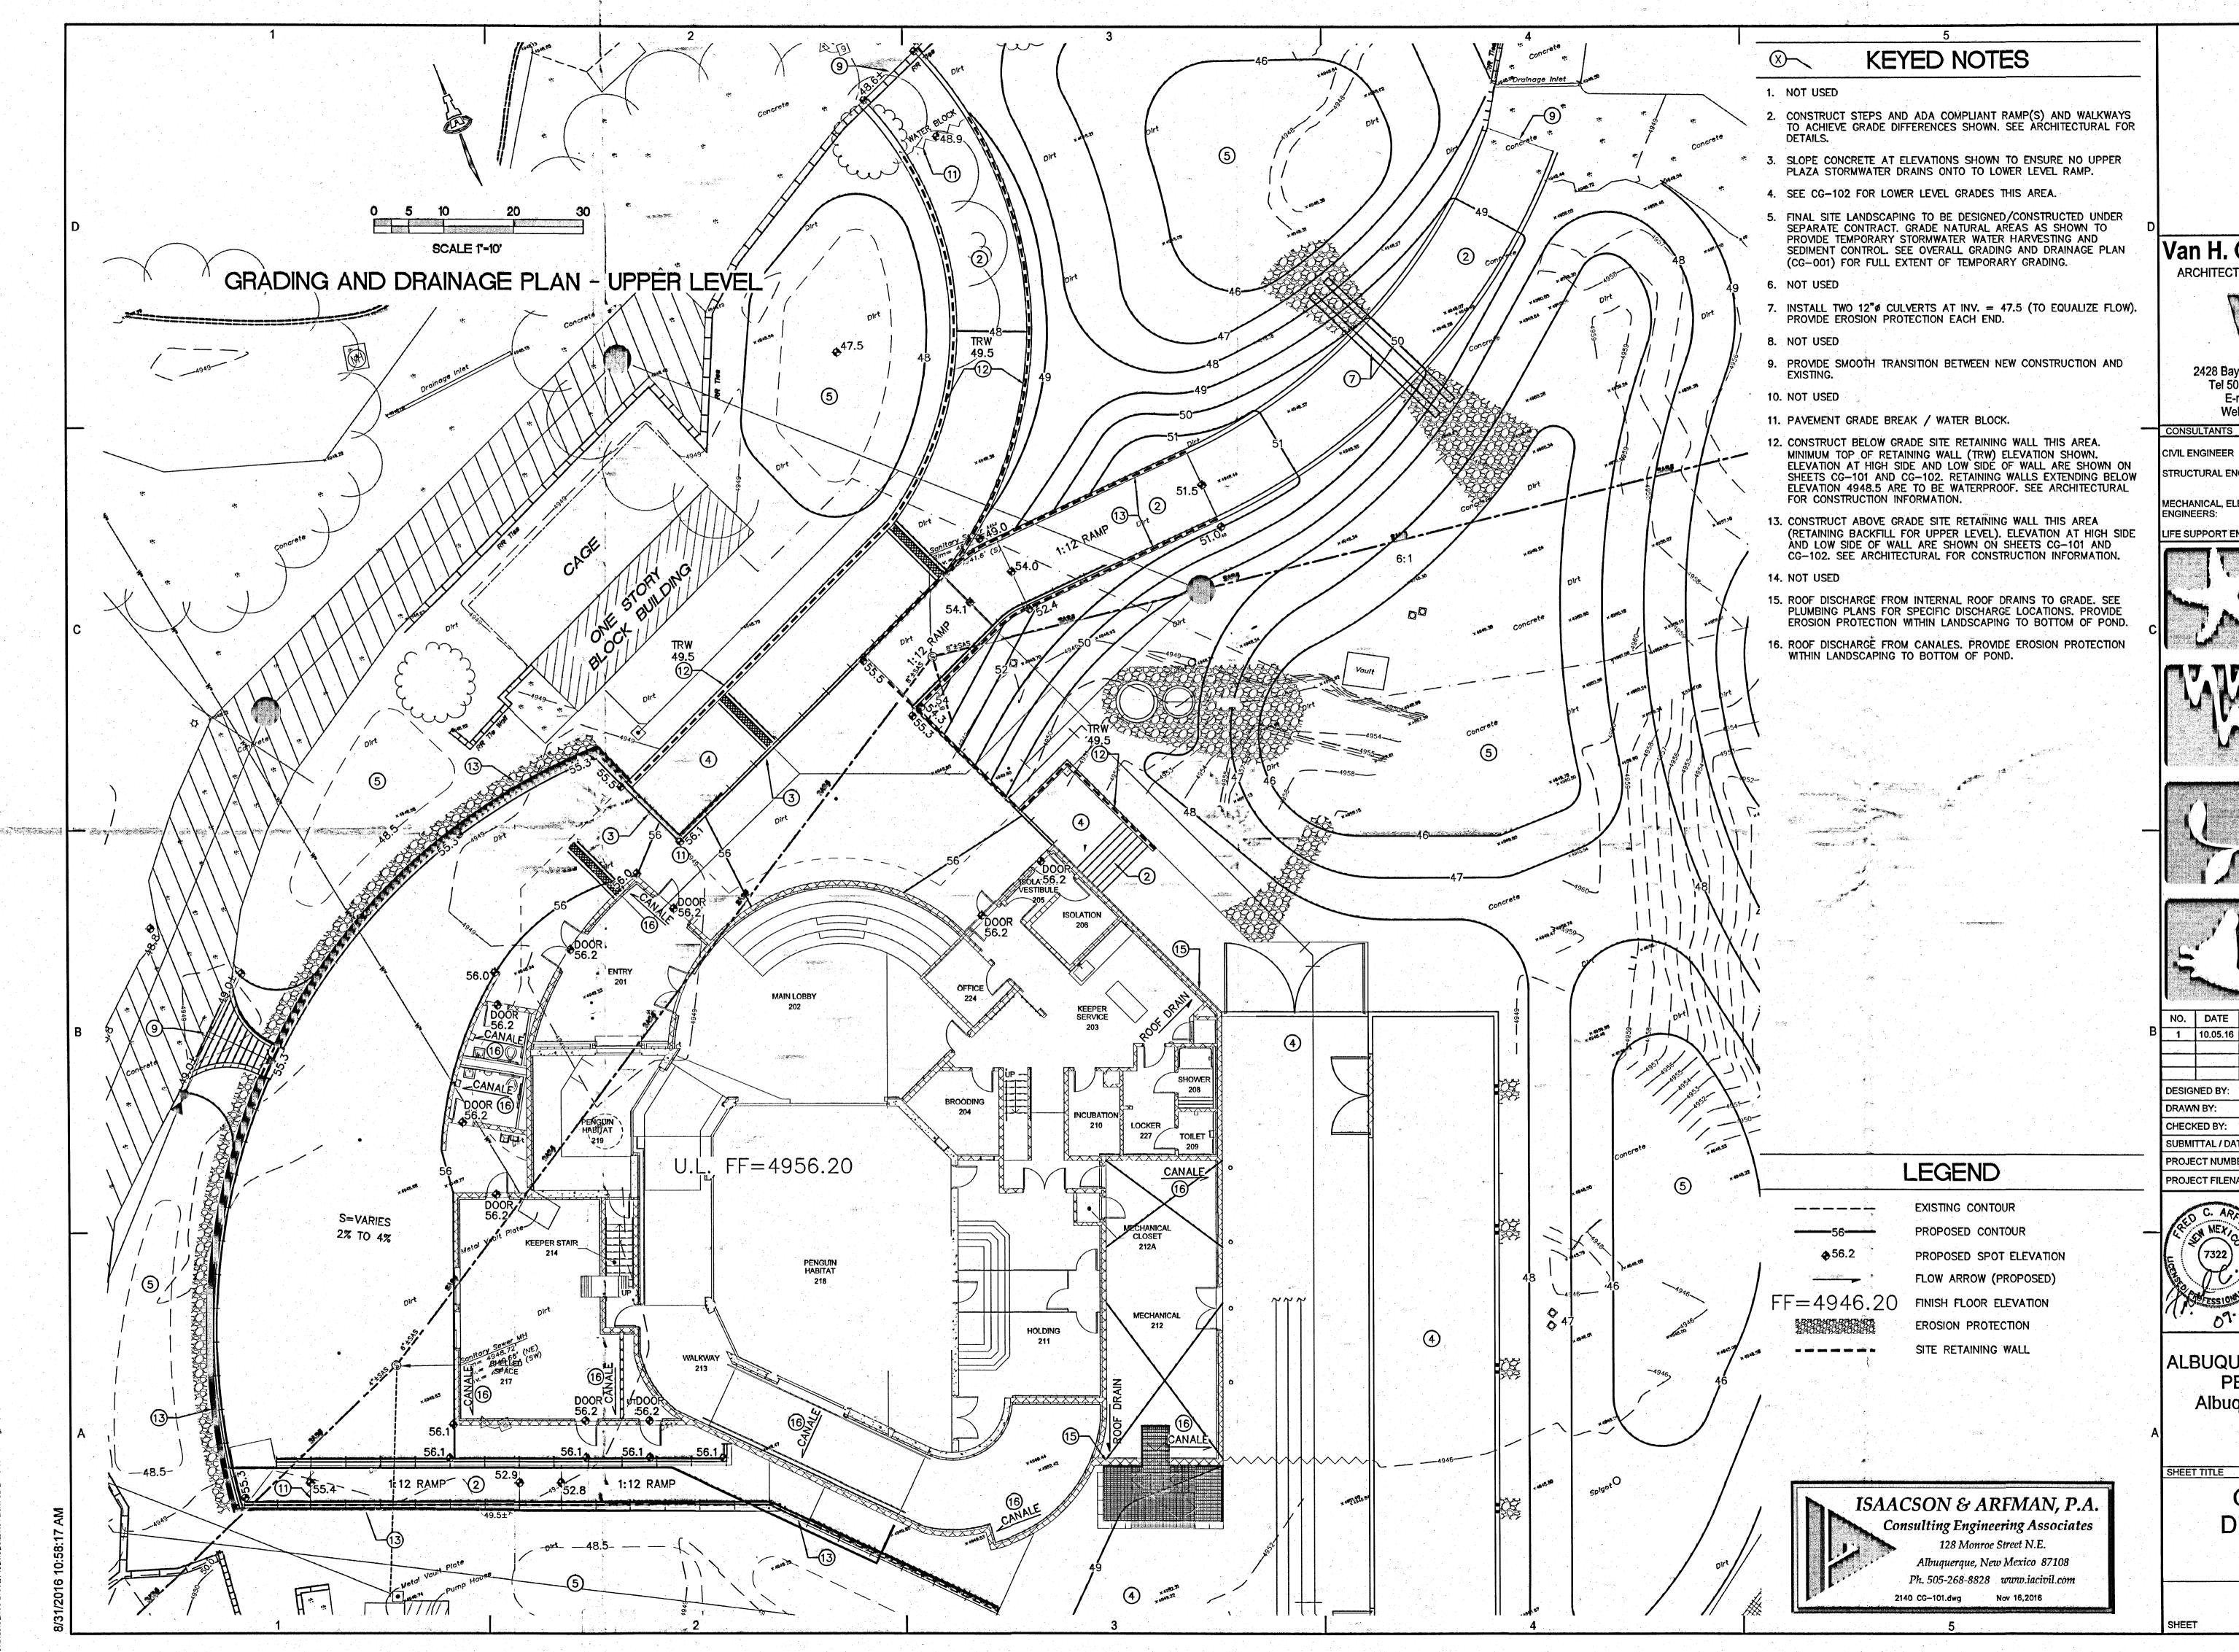


PROJECT FILENAME

ALBUQUERQUE BIOPARK ZOO PENGUIN EXHIBIT Albuquerque, New Mexico

SHEET TITLE

OVERALL GRADING AND DRAINAGE PLAN



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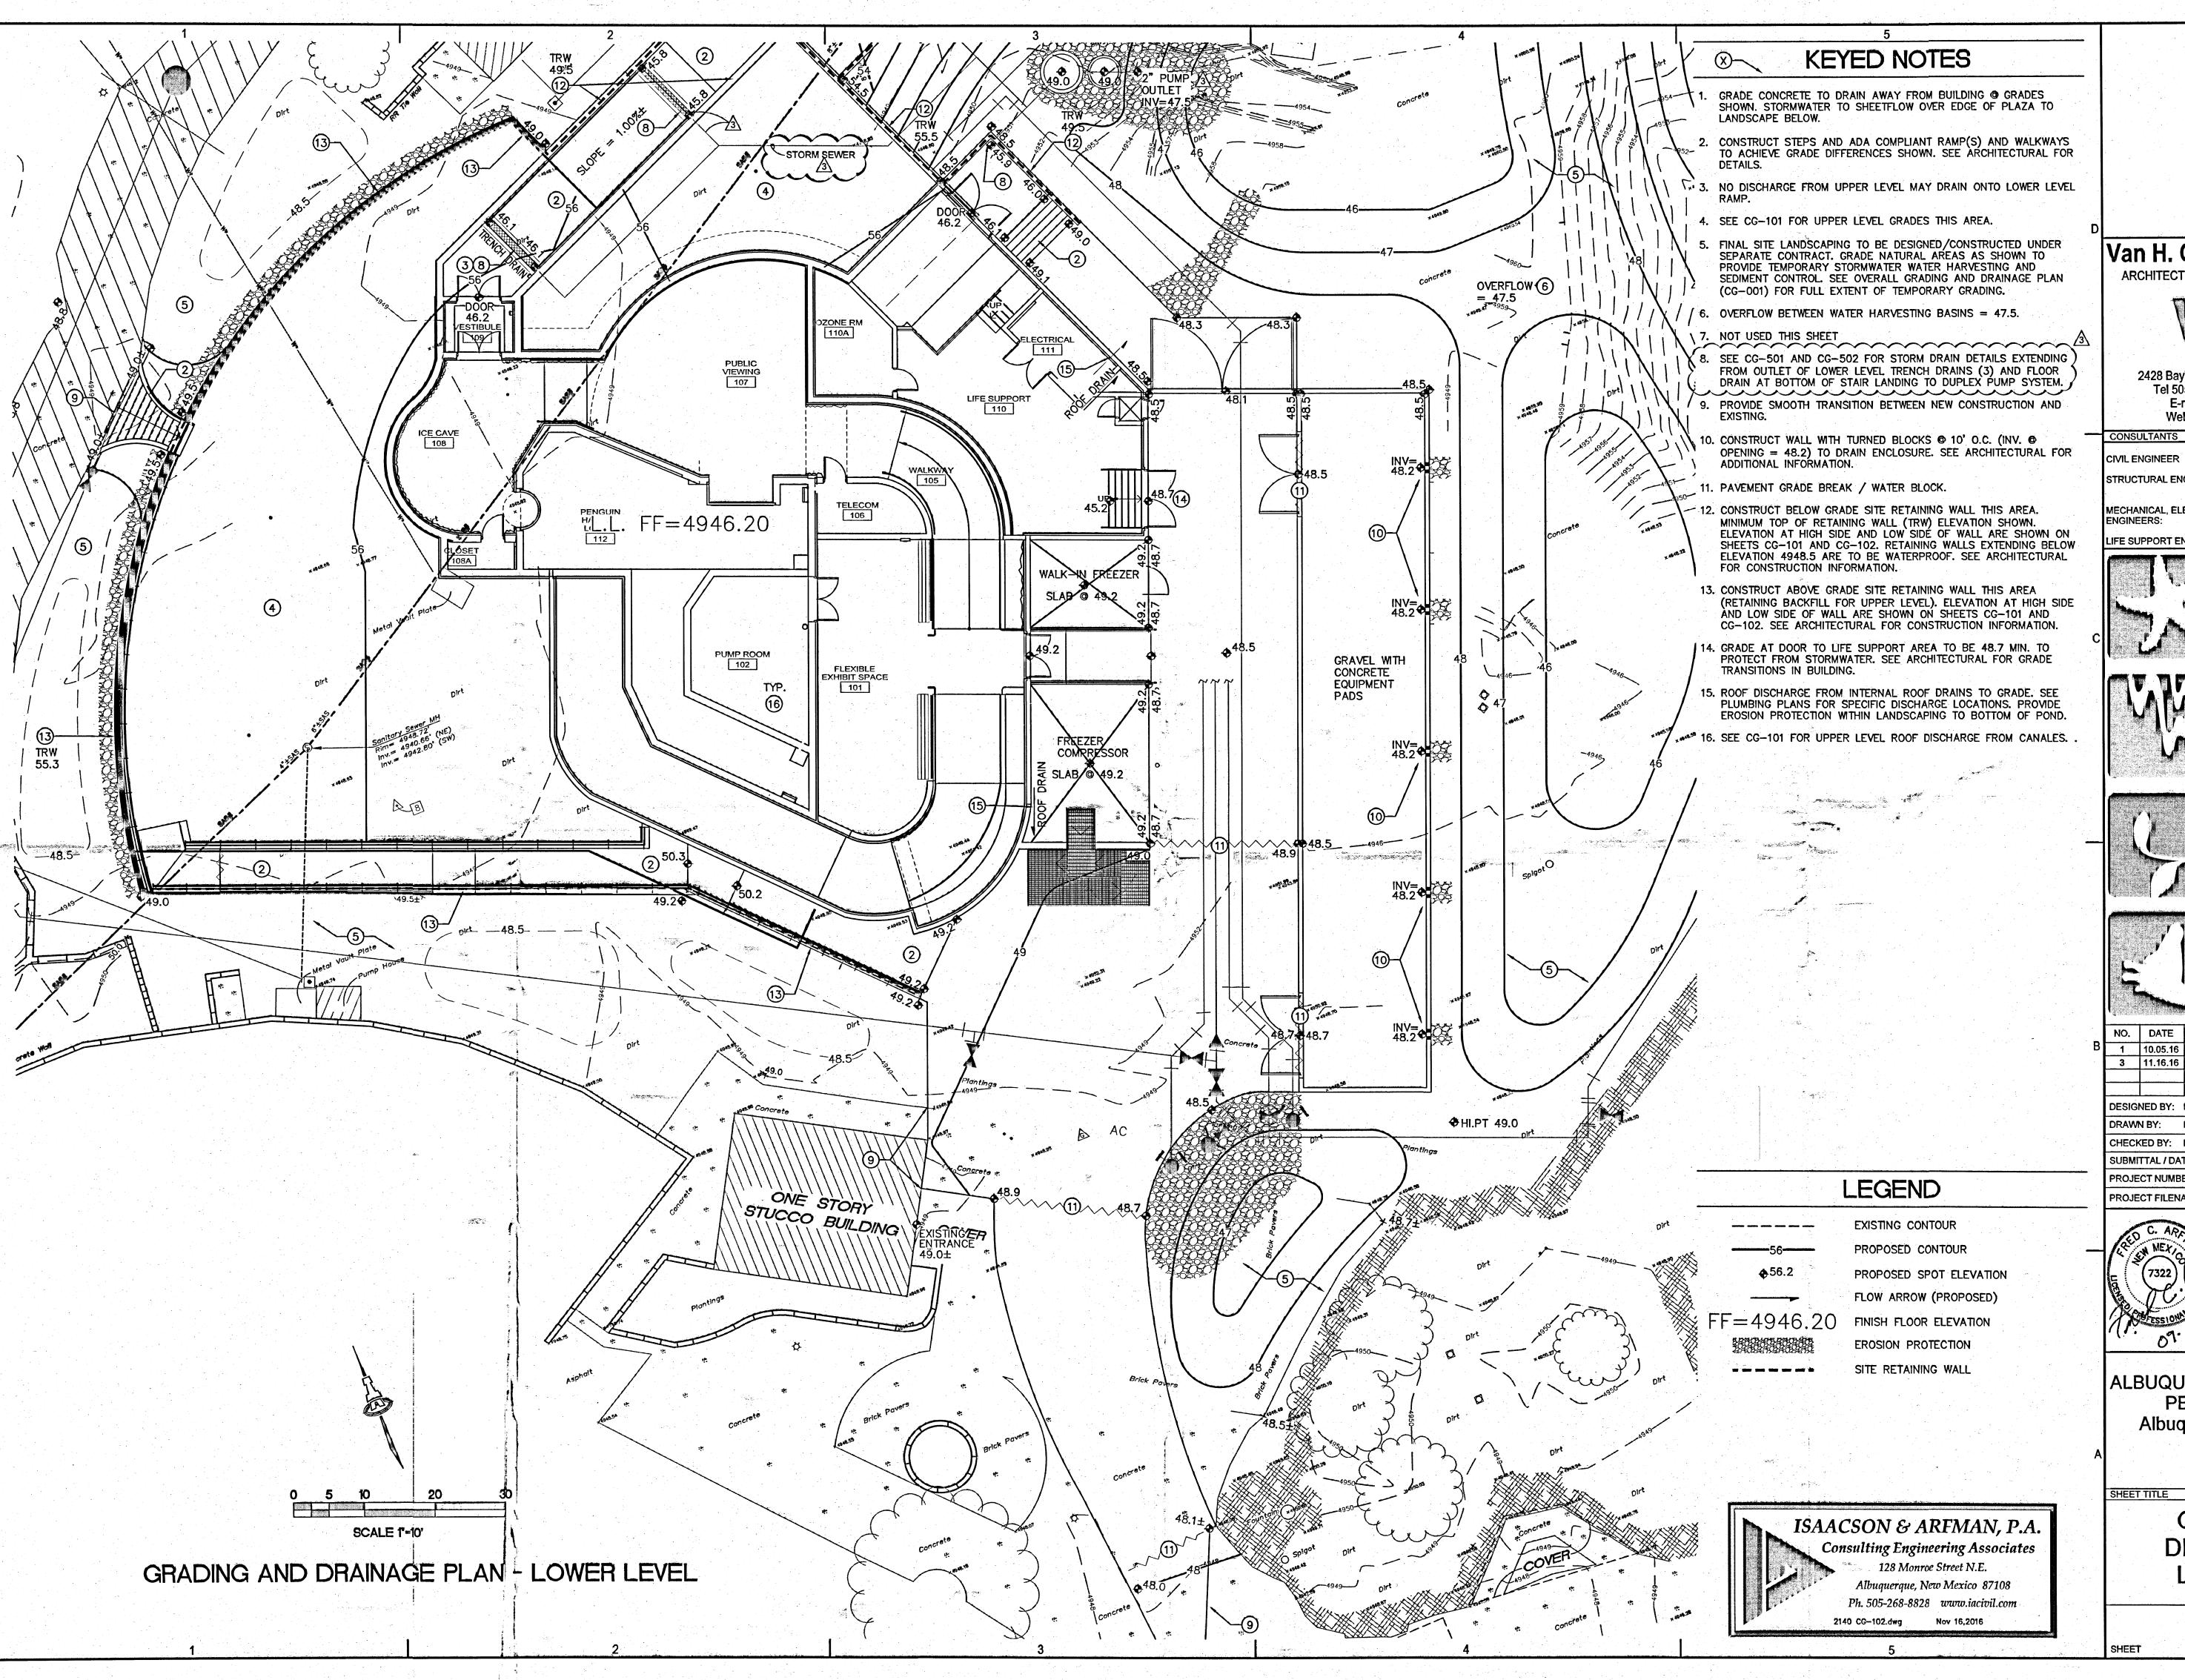


ALBUQUERQUE BIOPARK ZOO PENGUIN EXHIBIT Albuquerque, New Mexico

GRADING AND DRAINAGE PLAN MAIN LEVEL

CG-101

SHEET



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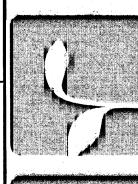
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LIFE SUPPORT ENGINEERS:





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ALBUQUERQUE BIOPARK ZOO **PENGUIN EXHIBIT** Albuquerque, New Mexico

SHEET TITLE

GRADING AND DRAINAGE PLAN LOWER LEVEL

