CITY OF ALBUQUERQUE

Planning Department Alan Varela, Director



Mayor Timothy M. Keller

June 28, 2023

Treveston Elliott Treveston Elliott Architect 811 12th St NW Albuquerque, NM 87102

RE: 1411 Coal Ave. SW Grading and Drainage Plan (Tierra West) Engineer's Stamp Date: 1/15/2014 (K13D050A) Pad Certification Date: 06/2022 Hydrology File: K13D053

Dear Mr. Elliott:

PO Box 1293 Based upon the information provided in your submittal received 06/23/2023 and previously approved Grading & Drainage Plan by Tierra West, this plan is approved for Building Permit and Building Pad Certification for **1411 Coal Ave. SW**. Please attach a copy of the Tierra West Grading & Drainage Plan in the construction sets for Building Permit processing along with a copy of this letter.

PRIOR TO CERTIFICATE OF OCCUPANCY:

NM 87103

1. The site needs to ensure that it follows the Tierra West approved Grading & Drainage Plan.

www.cabq.gov

2. A licensed New Mexico civil engineer will need to submit to Hydrology an Engineer's Certification, per the DPM Part 6-14 (G): Engineer's Certification Checklist for Subdivision and Part 6-14 (H): Required Certification Language is required.

If you have any questions, please contact me at 924-3995 or <u>rbrissette@cabq.gov</u>.

Sincerely,

Renée C. Brissette

Renée C. Brissette, P.E. CFM Senior Engineer, Hydrology Planning Department




City of Albuquerque

Planning Department Development & Building Services Division DRAINAGE AND TRANSPORTATION INFORMATION SHEET (REV 10/2018)


| Project Title: | _Building Permi | t #: Hydrology File #: |
|---|-----------------|--|
| DRB#: | EPC#: | Work Order#: |
| Legal Description: | | |
| City Address: | | |
| Applicant: | | Contact: |
| Address: | | |
| | | E-mail: |
| Other Contact: | | Contact: |
| Address: | | |
| | | E-mail: |
| TYPE OF DEVELOPMENT: PLAT (# 0 | of lots) RES | SIDENCE DRB SITE ADMIN SITE |
| IS THIS A RESUBMITTAL? Yes | No | |
| DEPARTMENT:TRAFFIC/TRANSPORT | TATION | HYDROLOGY/DRAINAGE |
| Check all that Apply: | | TYPE OF APPROVAL/ACCEPTANCE SOUGHT: BUILDING PERMIT APPROVAL |
| TYPE OF SUBMITTAL: ENGINEER/ARCHITECT CERTIFICATION PAD CERTIFICATION CONCEPTUAL G & D PLAN GRADING PLAN DRAINAGE MASTER PLAN DRAINAGE REPORT FLOODPLAIN DEVELOPMENT PERMIT A ELEVATION CERTIFICATE CLOMR/LOMR TRAFFIC CIRCULATION LAYOUT (TCL TRAFFIC IMPACT STUDY (TIS) OTHER (SPECIFY) PRE-DESIGN MEETING? | APPLIC .) | CERTIFICATE OF OCCUPANCY PRELIMINARY PLAT APPROVAL SITE PLAN FOR SUB'D APPROVAL SITE PLAN FOR BLDG. PERMIT APPROVAL FINAL PLAT APPROVAL SIA/ RELEASE OF FINANCIAL GUARANTEE FOUNDATION PERMIT APPROVAL GRADING PERMIT APPROVAL SO-19 APPROVAL PAVING PERMIT APPROVAL GRADING/ PAD CERTIFICATION WORK ORDER APPROVAL CLOMR/LOMR FLOODPLAIN DEVELOPMENT PERMIT OTHER (SPECIFY) |
| | • | |
| COA STAFF: | | BMITTAL RECEIVED: |

FEE PAID:

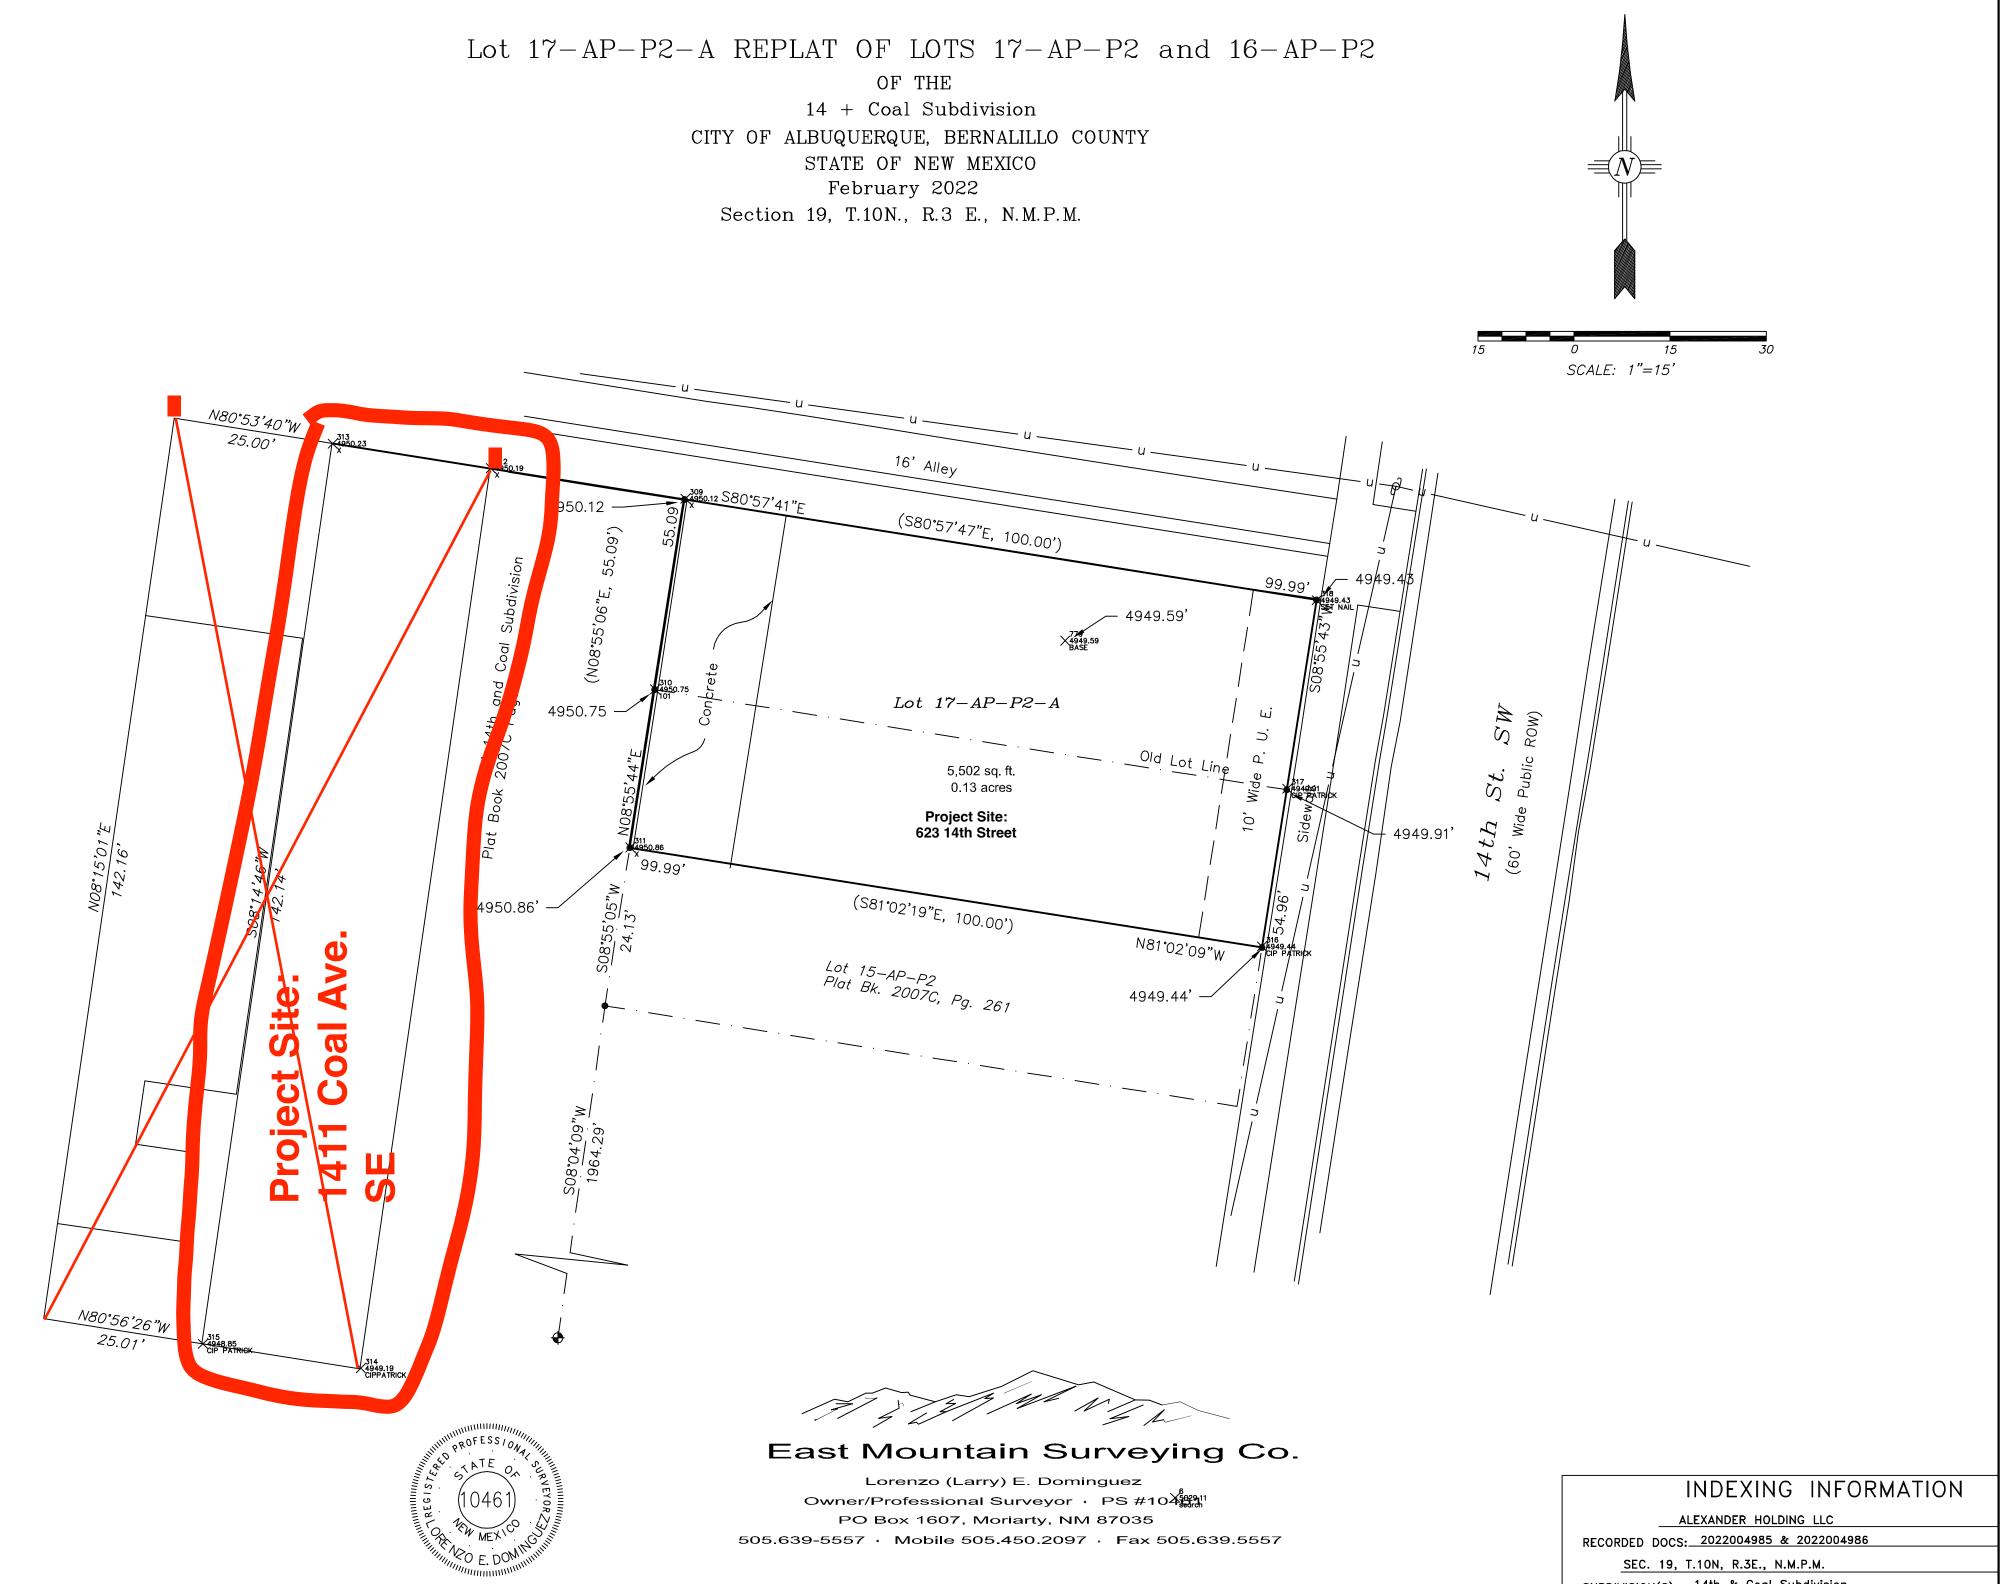

SUBDIVISION(S): <u>14th & Coal Subdivision</u> PROJECT No. EM.21-232

Sheet 2 of 2

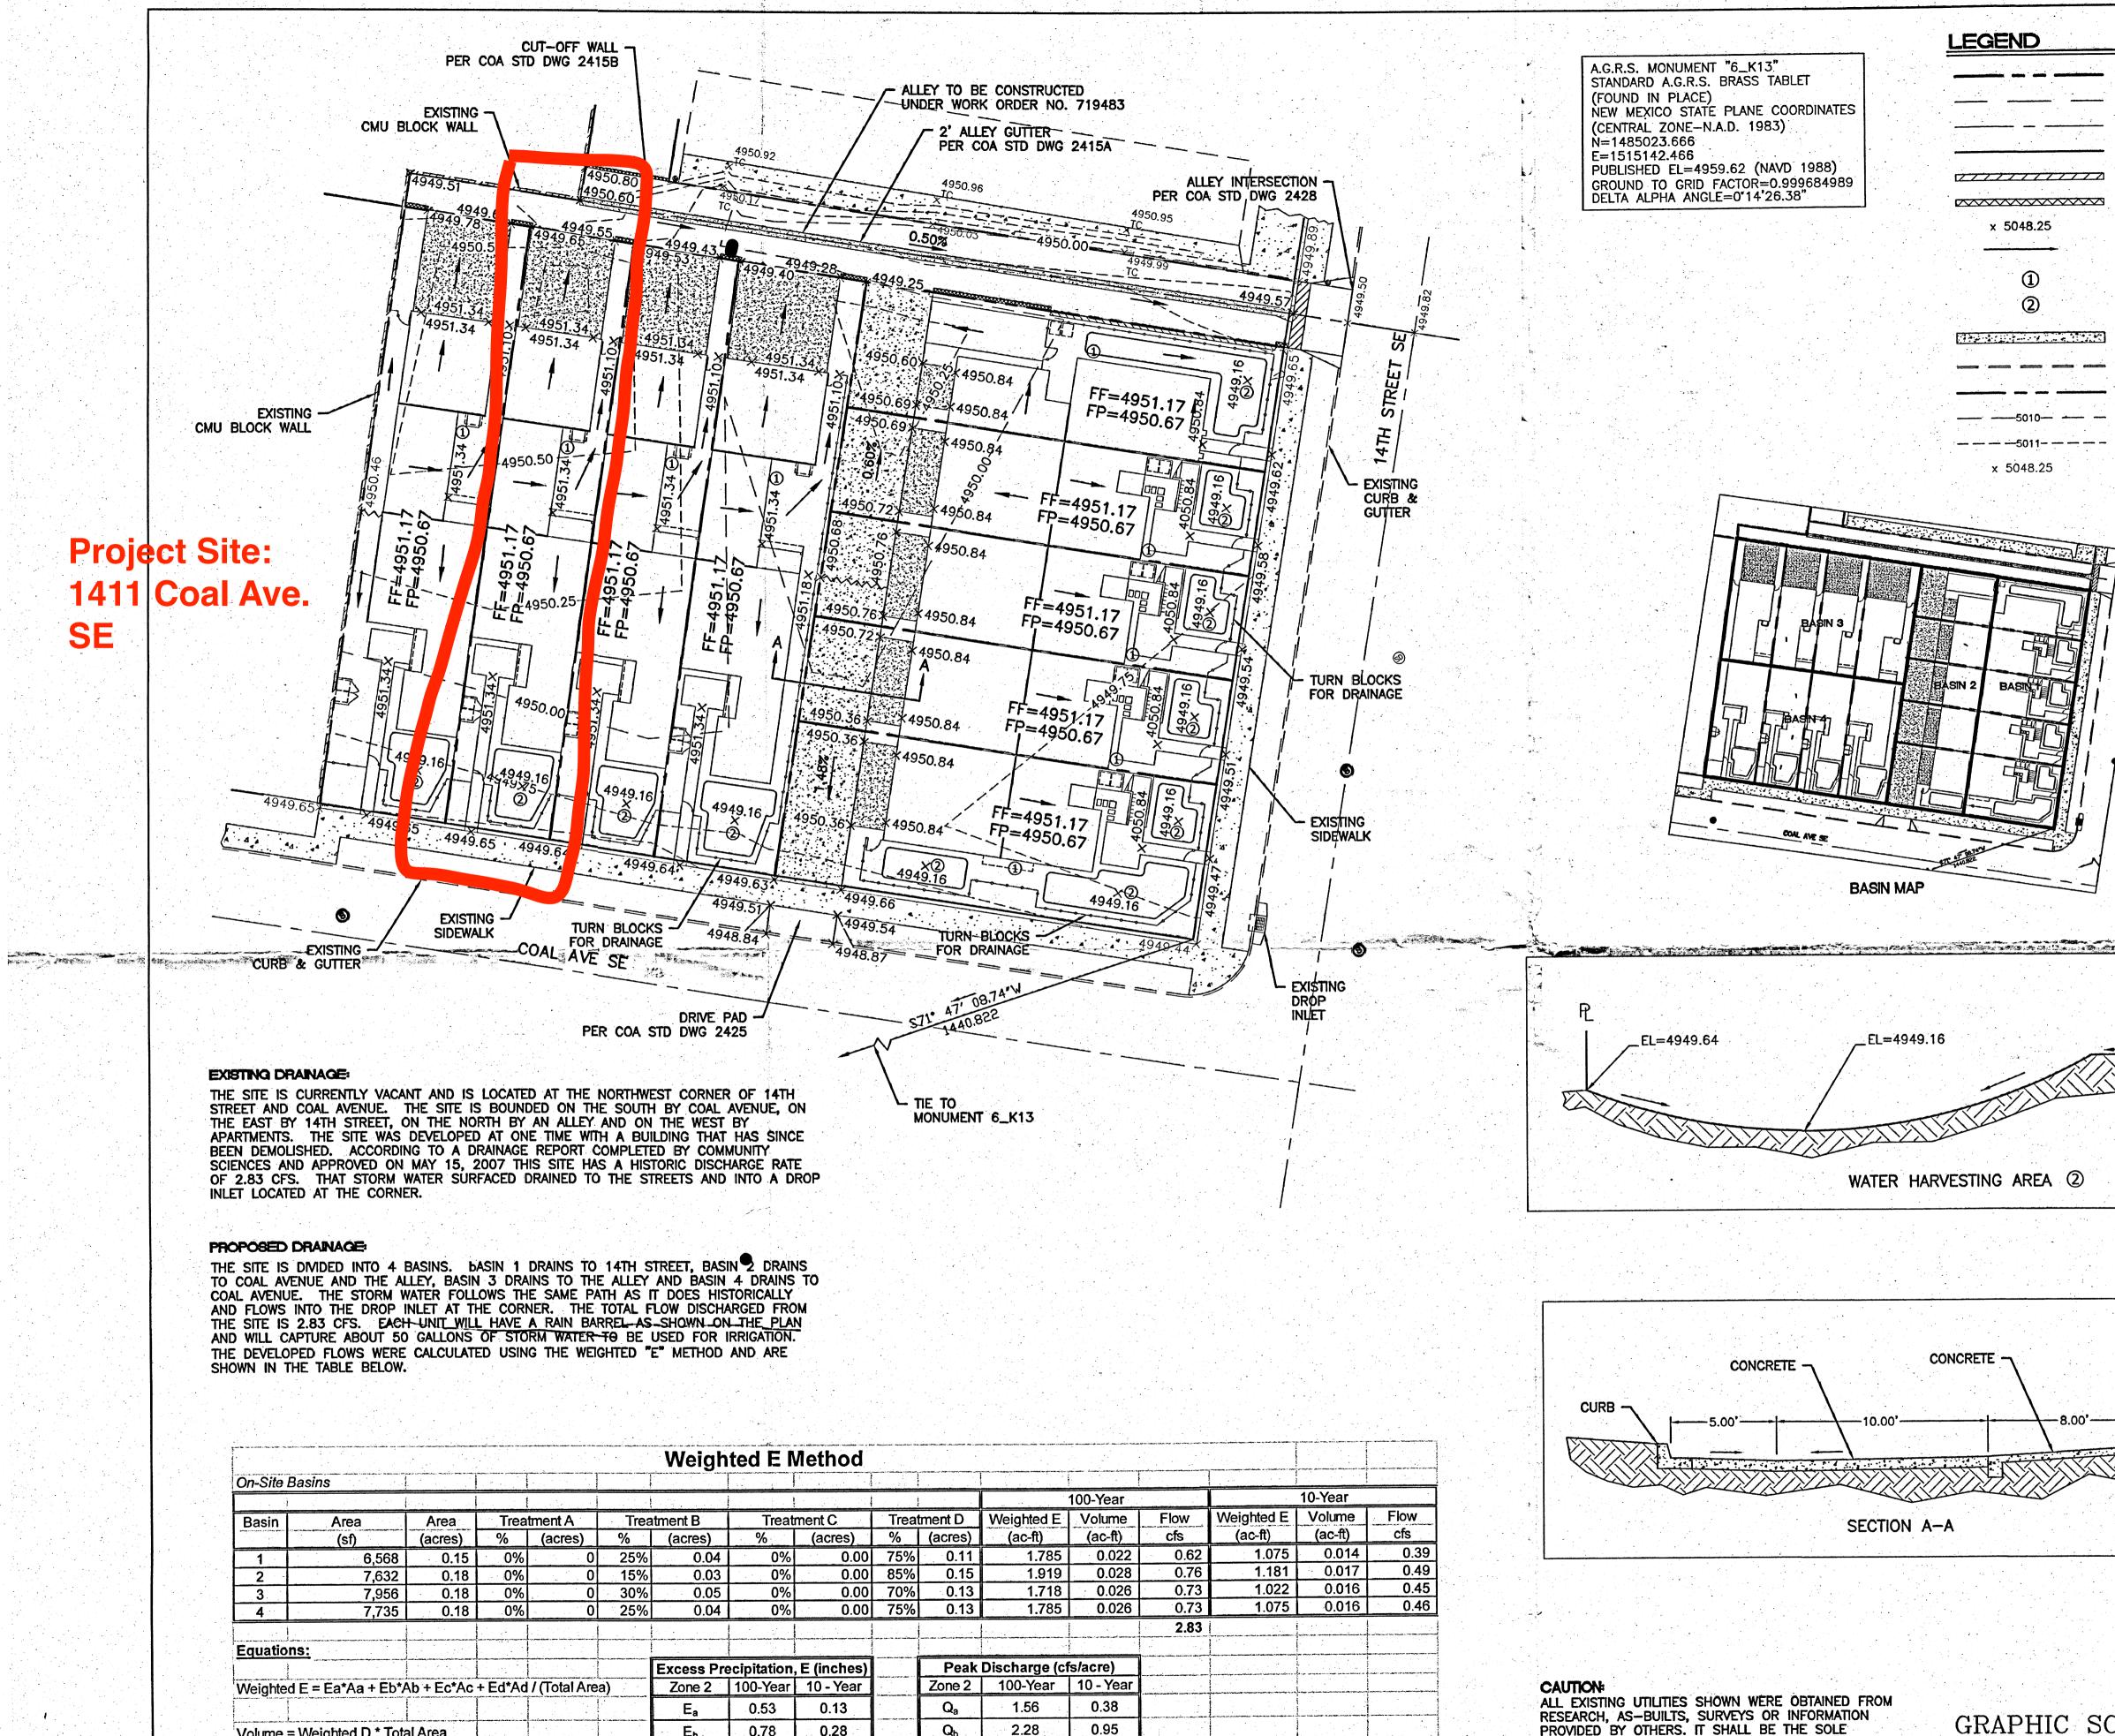

1.71

3.14

| | | | | | | Weigh | ted E N | lethod | | | |
|---|--------------------|--|---------|---------------|-------------------------------|----------------------------------|-------------|-----------|-------------|----------------|----------|
| On-Site E | Bas ins | | | | | | | | | | |
| 1 | | elle de la cara | | and a start | | | | | | | |
| Basin | Area | Area | Trea | tment A | Treatment B | | Treatment C | | Treatment D | | Weighted |
| anger of a set of the | (sf) | (acres) | % | (acres) | % | (acres) | % | (acres) | %_ | (acres) | (ac-ft) |
| 1 | 6,568 | 0.15 | 0% | 0 | 25% | 0.04 | 0% | 0.00 | 75% | 0.11 | 1.7 |
| 2 - | 7,632 | 0.18 | 0% | 0 | 15% | 0.03 | 0% | 0.00 | 85% | 0.15 | 1.9 |
| 3 | 7,956 | 0.18 | 0% | 0 | 30% | 0.05 | 0% | 0.00 | 70% | 0.13 | 1.7 |
| 4 | 7,735 | 0.18 | 0% | 0 | 25% | 0.04 | 0% | 0.00 | 75% | 0.13 | 1.7 |
| Equation | | | | | | | | | | | |
| | <u>13.</u> | | | | | Excess Precipitation, E (inches) | | | | Peak Discharge | |
| Weighted | I E = Ea*Aa + Eb*A | b + Ec*Ac | + Ed*Ad | / (Total Area | a) | Zone 2 | 100-Year | 10 - Year | | Zone 2 | 100-Yea |
| | | ан у от от отобутства и от | | | | Ea | 0.53 | 0.13 | | Qa | 1.56 |
| Volume = Weighted D * Total Area | | | | | E _b | 0.78 | 0.28 | | Qb | 2.28 | |
| | | | | | | Ec | 1.13 | 0.52 | | Q _c | 3.14 |
| Elow = 0 | a*Aa+Qb*Ab+ | Oc * Ac + O | bA * b(| | at - and - that with watching | Ed | 2.12 | 1.34 | | Qd | 4.70 |

PROVIDED BY OTHERS. IT SHALL BE THE SOLE RESPONSIBILITY OF THE CONTRACTOR TO CONDUCT ALL NECESSARY FIELD INVESTIGATIONS PRIOR TO AND INCLUDING ANY EXCAVATION, TO DETERMINE THE ACTUAL LOCATION OF UTILITIES AND OTHER IMPROVEMENTS, PRIOR TO STARTING THE WORK. ANY * CHANGES FROM THIS PLAN SHALL BE COORDINATED WITH AND APPROVED BY THE ENGINEER.

10 20 SCALE: 1"=20'

| | | Attention | | | | | |
|---|--|---------------------------------------|--|--|--|--|--|
| | | | | | | | |
| BOUNDARY LINE | | | | | | | |
| EASEMENT | | | | | | | |
| CENTERLINE | | | | | | | |
| RIGHT-OF-WAY CMU BLOCK WALL | A 10 16 CONTRACT CONT | | | | | | |
| ALLEY CUT-OFF WALL | 5 TZ SP P COAL TO FE MARKEN SU-P MFR | | | | | | |
| SPOT ELEVATION | | | | | | | |
| FLOW ARROW | | SU SU | | | | | |
| RAIN BARREL (50 GALLON MI | IN.) $\frac{1}{16} = \frac{1}{16} = \frac{1}$ | | | | | | |
| WATER HARVESTING AREA | N.) SU-2 PK SU | A A A A A A A A A A A A A A A A A A A | | | | | |
| EXISTING SIDEWALK | RIO GRANDE PARK | | | | | | |
| EXISTING CURB & GUTTER | | | | | | | |
| EXISTING BOUNDARY LINE | STOVER & | | | | | | |
| EXISTING CONTOUR MAJOR | VCINITY MAP: | K-13-Z | | | | | |
| EXISTING CONTOUR MINOR EXISTING ELEVATION | | | | | | | |
| | | D | | | | | |
| | | | | | | | |
| | NORTHEADAVE | | | | | | |
| \mathbf{t} | ZONE AO (DEPTH 1) | | | | | | |
| | | ONEX | | | | | |
| | | | | | | | |
| | SITE | ZONE | | | | | |
| | CP TIRONIAVE O | | | | | | |
| | | | | | | | |
| | | | | | | | |
| | ZON | EX | | | | | |
| | STOVERAVE | ZO III. | | | | | |
| | 3 | 5001C0333H | | | | | |
| 에 있는 것이 있는 것이 있는 것이 있는 것이 있는 것이 있는 것이 있다. 같은 것이 있는 것이 있다. 같은 것이 같은 것이 있는 것이 같은 것이 있는 것이 있는 것이 있는 것이 같은 것이 있는 것이 같은 것이 있는 것이 같은 것이 없다. | | | | | | | |
| | NOTICE TO CONTRACTORS | | | | | | |
| | 1. AN EXCAVATION/CONSTRUCTION PERMIT WILL BE REQUIRED BEF BEGINNING ANY WORK WITHIN CITY RIGHT-OF-WAY. | ORE | | | | | |
| | 2. ALL WORK DETAILED ON THESE PLANS TO BE PERFORMED, EX OTHERWISE STATED OR PROVIDED HERON, SHALL BE CONSTRUCT | CEPT AS | | | | | |
| | ACCORDANCE WITH CITY OF ALBUQUERQUE INTERIM STANDARD SPECIFICATIONS FOR PUBLIC WORKS CONSTRUCTION, 1985. | | | | | | |
| BUILDING FF=4951.17 | 3. TWO WORKING DAYS PRIOR TO ANY EXCAVATION, CONTRACTOR MUST | | | | | | |
| | CONTACT LINE LOCATING SERVICE, 765-1234, FOR LOCATION (EXISTING UTILITIES. |)F | | | | | |
| | 4. PRIOR TO CONSTRUCTION, THE CONTRACTOR SHALL EXCAVATE AND | | | | | | |
| | VERIFY THE HORIZONTAL AND VERTICAL LOCATIONS OF ALL CONNECTIONS. SHOULD A CONFLICT EXIST, THE CONTRACTOR SHALL | | | | | | |
| | NOTIFY THE ENGINEER SO THAT THE CONFLICT CAN BE RESOLUTION MINIMUM AMOUNT OF DELAY. | VED WITH A | | | | | |
| | 5. BACKFILL COMPACTION SHALL BE ACCORDING TO TRAFFIC/STRE | ET USE. | | | | | |
| | 6. MAINTENANCE OF THESE FACILITIES SHALL BE THE RESPONSIBIL THE OWNER OF THE PROPERTY SERVED. | LITY OF | | | | | |
| | 7. WORK ON ARTERIAL STREETS SHALL BE PERFORMED ON A 24- | HOUR BASIS. | | | | | |
| | | | | | | | |
| | | | | | | | |
| | | | | | | | |
| | | | | | | | |
| BUILDING | | | | | | | |
| | | | | | | | |
| | | FA | | | | | |
| | MEGEIV | | | | | | |
| | IAN 1 5 2012 | TION | | | | | |
| | LAND DEVELOPMENT | SECTION | | | | | |
| | | | | | | | |
| | | DRAWN BY | | | | | |
| \mathcal{N} | ENGINEER'S THE 14TH WEST | DRAWN BY BJF | | | | | |
| | 14TH AND COAL | <i>DATE</i> 01/15/14 | | | | | |
| | GRADING AND GRAINAGE PLAN | | | | | | |
| CALE | | 2013044_GRE | | | | | |
| 20 | Solf 1/5/ 1 | SHEET # | | | | | |
| | TIERRA WEST, LLC 5571 MIDWAY PARK PLACE NE AL BUQUERQUE, NM 87109 | C1 | | | | | |
| | (505) 858-3100 | JOB # | | | | | |
| | RONALD R. BOHANNAN P.E. #7868 | 2013044 | | | | | |
| | | | | | | | |