CITY OF ALBUQUERQUE



Richard J. Berry, Mayor

June 16, 2017

David Soule, P.E. Rio Grande Engineering P.O. Box 93924 Albuquerque, NM, 87199

RE: Iron Duplex - Resubmittal

Grading and Drainage Plan

Stamp Date: 5/2/17

Hydrology File: K13D074

Dear Mr. Soule:

Based on the Certification received 6/12/17 and site visit on 6/15/17, the site is acceptable

for a Permanent Certificate of Occupancy by Hydrology.

If you have any questions, please contact me at 924-3995 or rbrissette@cabq.gov.

Albuquerque

Sincerely,

New Mexico 87103

www.cabq.gov

Renee C. Brissette Reneé C. Brissette, P.E.

Senior Engineer, Hydrology

Planning Department

1 of 1 Albuquerque - Making History 1706-2006



City of Albuquerque

Planning Department

Development & Building Services Division


DRAINAGE AND TRANSPORTATION INFORMATION SHEET

(REV 02/2013)

Project Title:		Building Permit #:		City Drainage #:
DRB#: E	PC#:		Work Order#:	:
Legal Description:				
City Address:				
			Contact:	
Address:				
Phone#: Fa			E-mail:	
Owner:			Contact:	
Address:			·	
Phone#: Fa	ax#:		E-mail:	
Architect:			Contact:	
Address:				
Phone#: Fa	ax#:		E-mail:	
Surveyor:			Contact:	
Address:				
Phone#: Fa	ax#:		E-mail:	
Contractor:			Contact:	
Address:				
Phone#: Fa	ax#:		E-mail:	
TYPE OF SUBMITTAL:	C	HECK TYPE OF APPROVA	AL/ACCEPTA	ANCE SOUGHT:
DRAINAGE REPORT		SIA/FINANCIAL GUARAN	ΓEE RELEASE	E
DRAINAGE PLAN 1st SUBMITTAL		PRELIMINARY PLAT APPR	ROVAL	
DRAINAGE PLAN RESUBMITTAL		S. DEV. PLAN FOR SUB'D	APPROVAL	
CONCEPTUAL G & D PLAN			T APPROVAL	
GRADING PLAN SECTOR PLAN APPROVA				
EROSION & SEDIMENT CONTROL PLAN	SION & SEDIMENT CONTROL PLAN (ESC) FINAL PLAT APPROVAL			
ENGINEER'S CERT (HYDROLOGY) CERTIFICATE OF OCCUPA		NCY (PERM)		
CLOMR/LOMR	CERTIFICATE OF OCCUPA		NCY (TCL TE	EMP)
TRAFFIC CIRCULATION LAYOUT (TCL)	FOUNDATION PERMIT AP		PROVAL	
ENGINEER'S CERT (TCL)		BUILDING PERMIT APPRO	VAL	
ENGINEER'S CERT (DRB SITE PLAN)		GRADING PERMIT APPRO	VAL	SO-19 APPROVAL
ENGINEER'S CERT (ESC)		PAVING PERMIT APPROVA	AL	ESC PERMIT APPROVAL
SO-19		WORK ORDER APPROVAL		ESC CERT. ACCEPTANCE
OTHER (SPECIFY)		GRADING CERTIFICATION	1	OTHER (SPECIFY)
WAS A PRE-DESIGN CONFERENCE ATTENDED	D:	Yes No Co	py Provided	
DATE SUBMITTED:	· · · · · · · · · · · · · · · · · · ·			
D	C1. 4::-: D1-41	-11 h	1:44-1 Th	

Requests for approvals of Site Development Plans and/or Subdivision Plats shall be accompanied by a drainage submittal. The particular nature, location, and scope to the proposed development defines the degree of drainage detail. One or more of the following levels of submittal may be required based on the followin

- 1. Conceptual Grading and Drainage Plan: Required for approval of Site Development Plans greater than five (5) acres and Sector Plans
- 2. Drainage Plans: Required for building permits, grading permits, paving permits and site plans less than five (5) acres
- **Drainage Report**: Required for subdivision containing more than ten (10) lots or constituting five (5) acres or more
- Erosion and Sediment Control Plan: Required for any new development and redevelopment site with 1-acre or more of land disturbing area, including project less than 1-acre than are part of a larger common plan of development

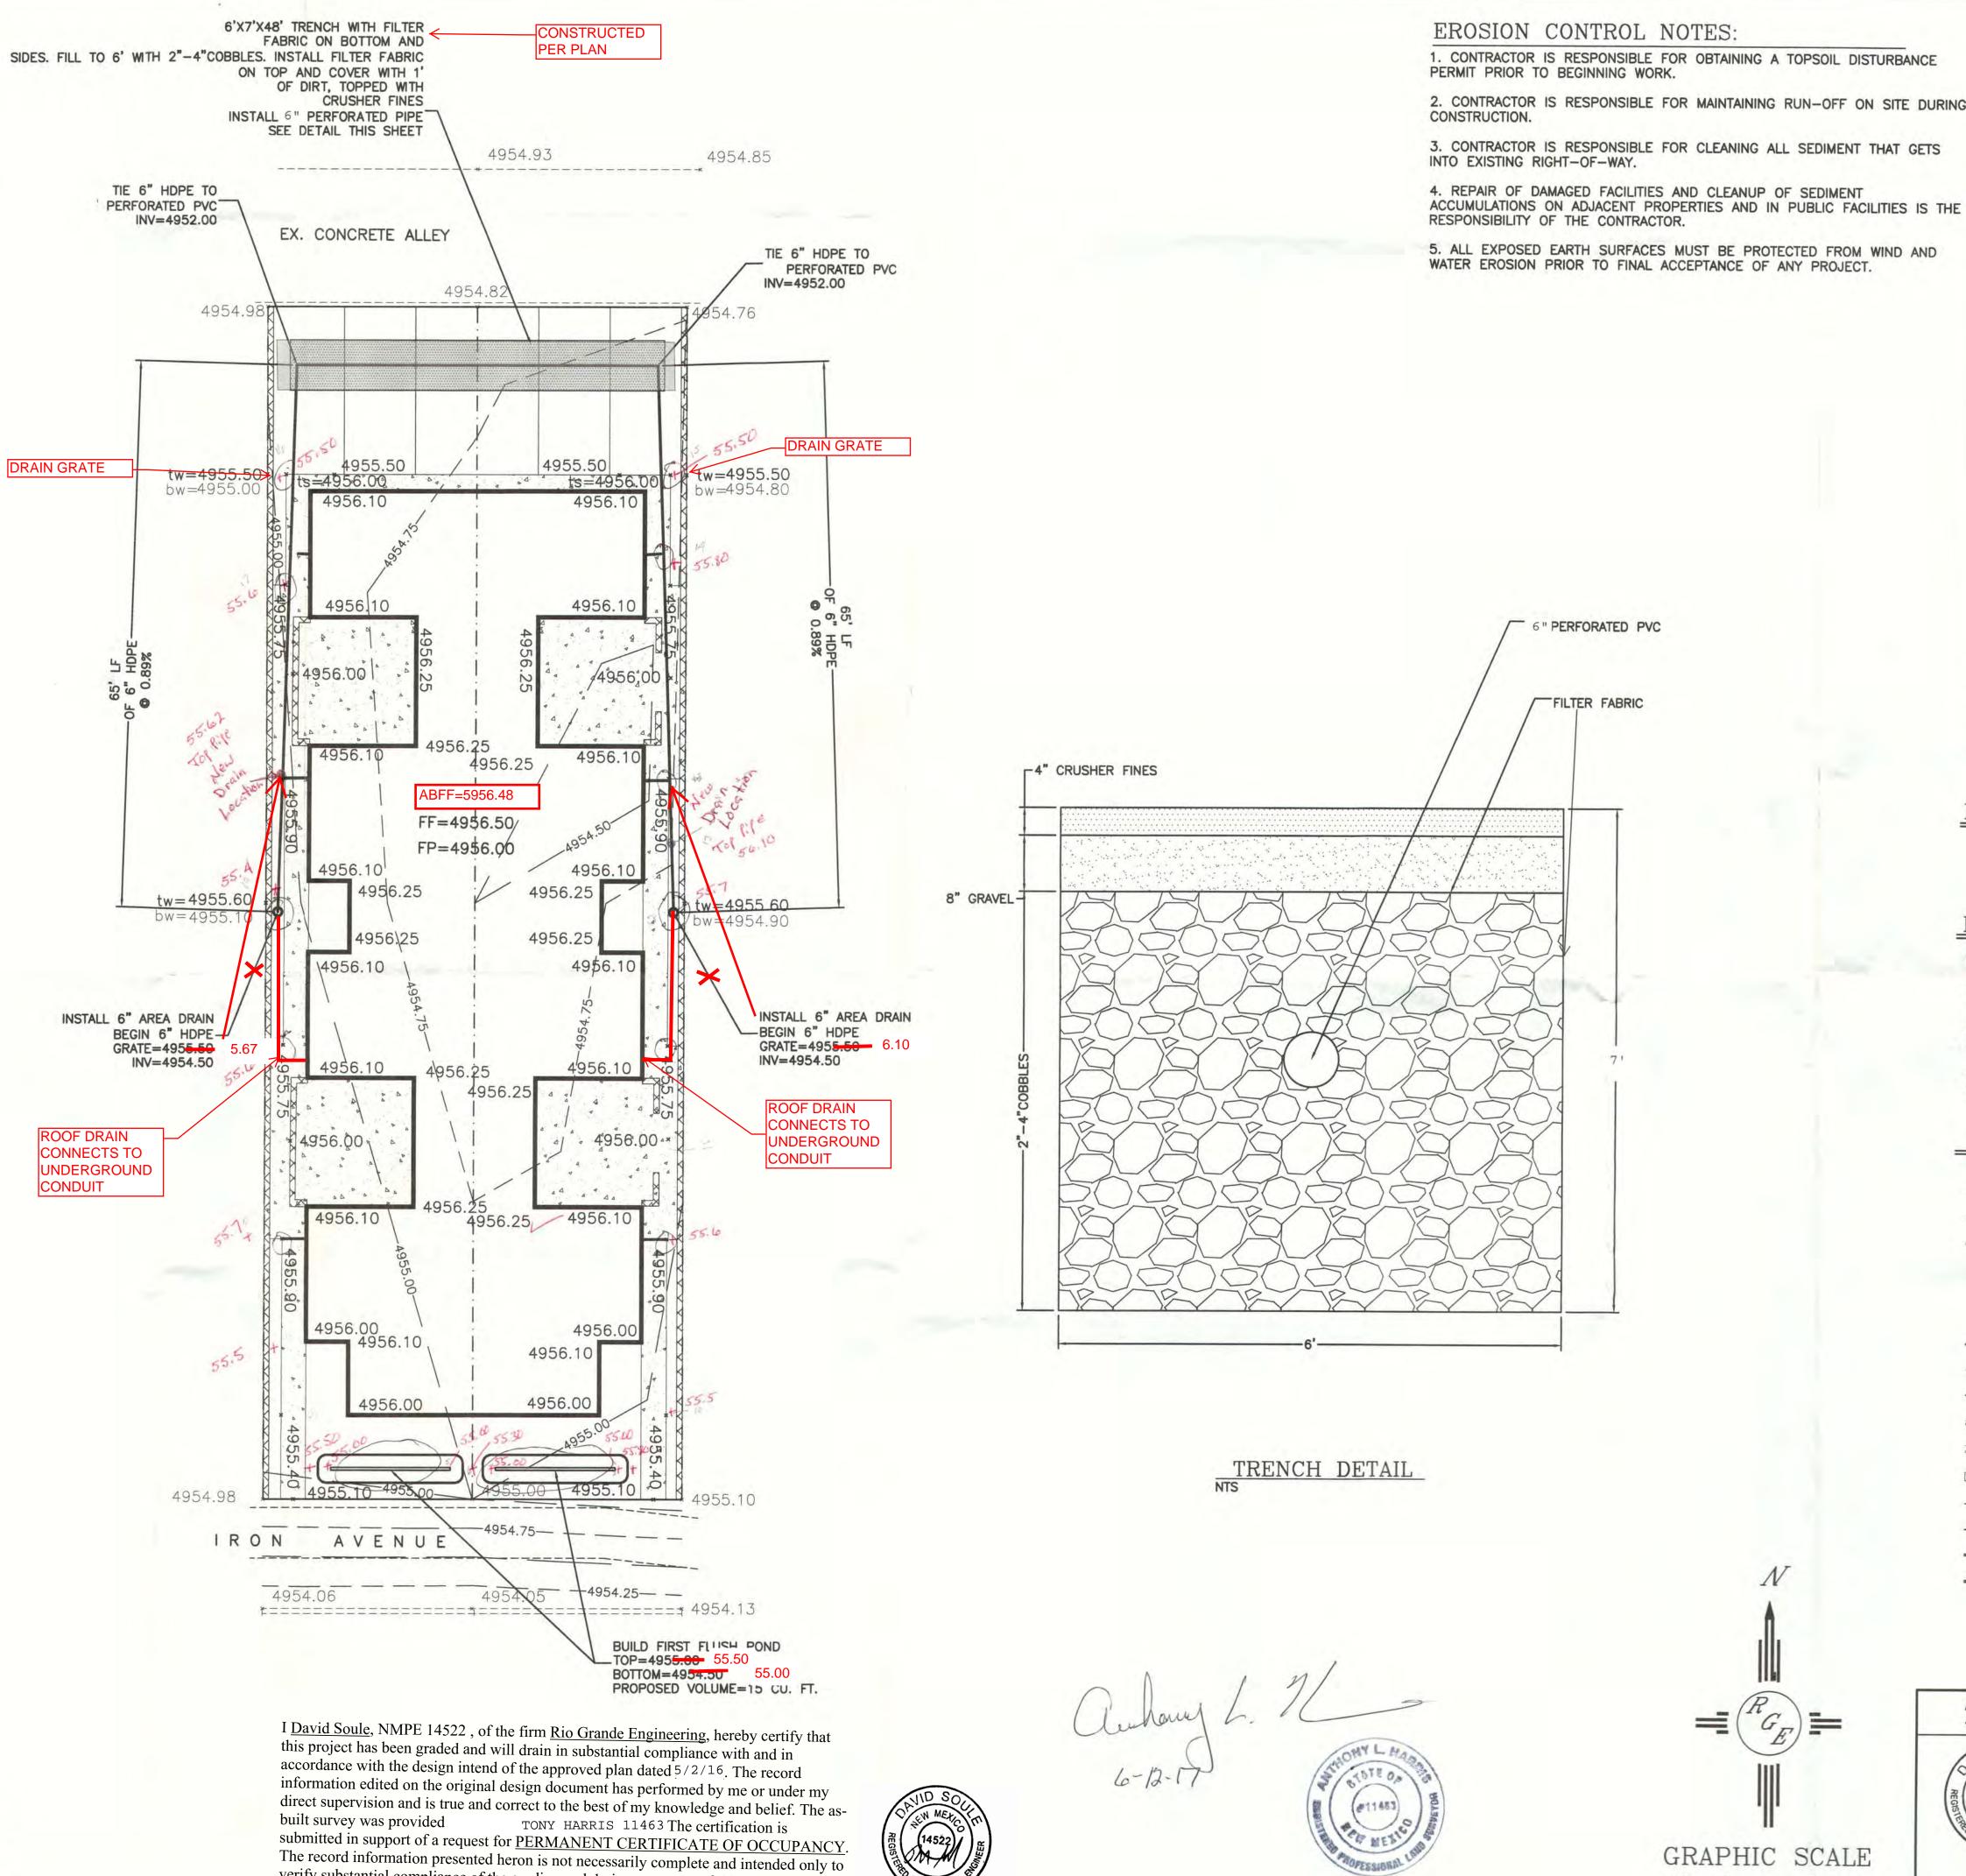


CAUTION


EXISTING UTILITIES ARE NOT SHOWN. IT SHALL BE THE SOLE RESPONSIBILITY OF THE CONTRACTOR TO CONDUCT ALL NECESSARY FIELD INVESTIGATIONS PRIOR TO ANY EXCAVATION TO DETERMINE THE ACTUAL LOCATION OF UTILITIES & OTHER

verify substantial compliance of the grading and drainage aspects of this project. Those relying on this record document are advised to obtain independent verification of its accuracy before using it for any other purpose.

6/12/17

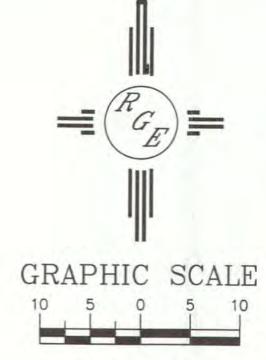

SCALE: 1"=10'

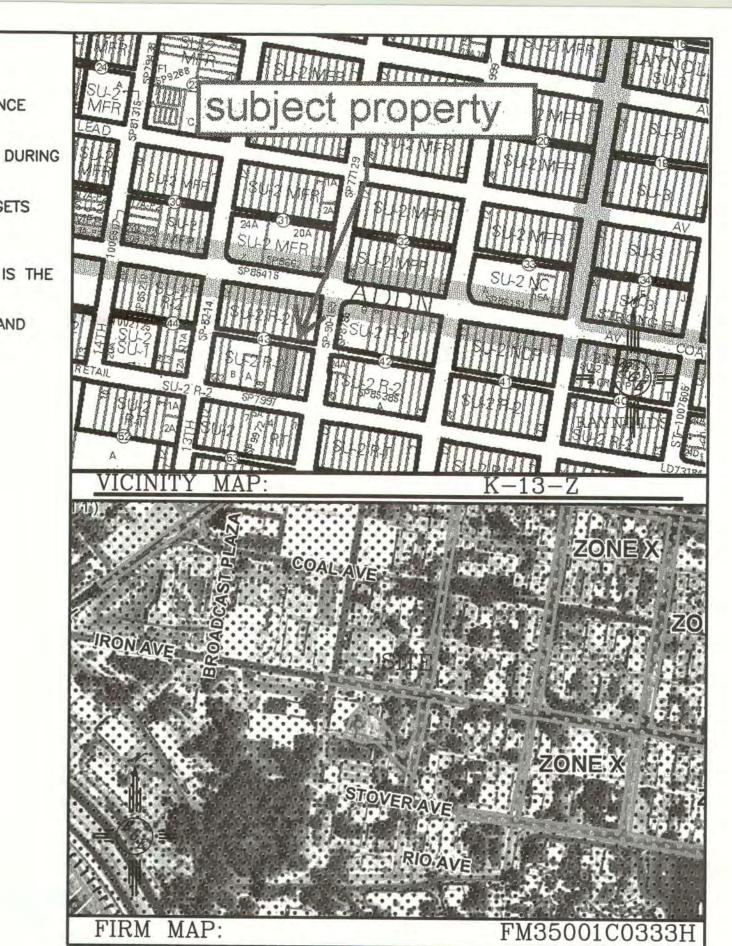

LEGAL DESCRIPTION:

LOTS 2-D AND 2-E, BLOCK 2-A, CHELWOOD PARK

1. ALL SPOT ELEVATIONS REPRESENT FLOWLINE ELEVATION UNLESS OTHERWISE

2. ALL CURBS TO BE 6" HEADER.

3. THE CONTRACTOR WILL BE REQUIRED TO SAWCUT AND REPAIR THOSE PORTIONS OF THE CONCRETE ALLEY THAT ARE DEGRADED BY THE CONSTRUCTION OF THE IMPROVEMENTS.

4. DOWN SPOUTS SHOWN SHALL CONNECT TO A 4" WIDE SIDEWALK TRENCH DRAIN TO ALLOW ROOF DRAINAGE TO DRAIN UNDER SIDEWALKS.

LEGEND

— — —5414— — EXISTING CONTOUR PROPOSED CONTOUR - PROPOSED INDEX CONTOUR SLOPE TIE 4048.25 EXISTING SPOT ELEVATION 4048.25 PROPOSED SPOT ELEVATION BOUNDARY CENTERLINE RIGHT-OF-WAY = PROPOSED CURB AND GUTTER ========== EXISTING CURB AND GUTTER PROPOSED SIDEWALK — — — — — PROPOSED SETBACK PROPOSED LOT LINE PROPOSED SCREEN WALL PROPOSED RETAINING WALL DESIGN BY OTHERS

ENGINEER'S SEAL 1203 IRON DRAWN BY WCWJ DUPLEX DATE 5-02-17 GRADING AND DRAINAGE PLAN 21637-LAYOUT-11-02-16 Rio Grande SHEET # Engineering 5/2/17 1606 CENTRAL AVENUE SUITE 201 ALBUQUERQUE, NM 87106 (505) 872-0999 DAVID SOULE P.E. #14522 JOB # 21637