




		SSMPCArchitects PRINCIPLES OF DESIGN. 219 Central Ave NW, Suite #800 Albuquerque, New Mexico 87102 7 505 255 8668 F 505 268 6665 www.smpcarchitects.com
AINAGE FACILITIES WITHIN CITY	<ul> <li>GRADING KEYED NOTES</li> <li>MATCH EXISTING</li> <li>ADJUST RIM TO MATCH PROPOSED GRADE.</li> <li>FIELD VERIFY EXISTING UTILITY. PROTECT IN PLACE. ADJUST RIM TO NEW GRADES. COORDINATE ANY DISCREPANCIES WITH OWNER, ENGINEER, AND ARCHITECT.</li> <li>INSTALL STORM INLET STRUCTURE WITH 2X2 TRAFFIC RATED GRATE (NYLOPLAST OR APPROVED EQUAL).</li> <li>HDPE (N12 OR APPROVED EQUAL) STORM DRAIN PIPE, SIZE &amp; SLOPE PER PLAN.</li> <li>CONTRACTOR TO POTHOLE EXISTING UTILITY TO CONFIRM SIZE, LOCATION, &amp; INVERT. CONTACT ENGINEER WITH ANY DISCREPANCIES</li> </ul>	HUN M. KLA ME H. H. 24834 BB 06-16-2025 SOFESSIONAL
AINAGE PACILITIES WITHIN CITY WAY NOTICE TO CONTRACTOR CIAL ORDER 19 ~ "SO-19") uvert per COA STD DWG 2236. faintenance at (505) 857-8033 to schedule a meeting ermit will be required before beginning any work within ay. project shall be performed in accordance with applicable d local laws, rules and regulations concerning ety and health. o any excavation, the contractor must contact <b>New</b> <b>II</b> , dial "811" [or (505) 260-1990] for the location of tion, the contractor shall excavate and verify the bstructions. Should a conflict exist, the contractor shall ter so that the conflict can be resolved with a minimum ion shall be according to traffic/street use. the facility shall be the responsibility of the owner of the erved. streets may be required on a 24-hour basis. contact Storm Maintenance at (505) 857-8033 to truction inspection. For excavating and barricading tact Construction Coordination at (505) 924-3416.	CUCATION, & INVERT. CONTACT ENGINEER WITH AND DISCREPANCIES OR CONFLICTS WITH PROPOSED DESIGN.  7. CONNECT NEW STORM DRAIN TO EXISTING STORM DRAIN INLET WITH WATERTIGHT CONNECTION. 8. INSTALL 6" OPENING IN RETAINING WALL FOR PENETRATION OF STORM DRAIN PIPE. SEE STRUCTURAL PLANS FOR MORE INFORMATION. 9. CONTRACTOR TO MAINTAIN CAUTION DURING CONSTRUCTION AND AVOID CONFLICT WITH EXISTING SITE FEATURES (LIGHT POLES, UTILITIES, LANDSCAPING ETC.). 10. PROTECT IN PLACE. 11. EXISTING SIDEWALK TO REMAIN. 12. INSTALL 24" STORM DRAIN STRUCTURE WITH TRAFFIC RATED RIM (NYLOPLAST OR APPROVED EQUAL). 13. EXISTING SLOTTED MANHOLE ACTING AS INLET, PROTECT IN PLACE. 14. CONTRACTOR TO FIELD VERIFY EXISTING OF STORM DRAIN IN THIS LOCATION PRIOR TO CONSTRUCTION. IF PRESENT, CONTACT ENGINEER IMMEDIATELY FOR DESIGN REVISION. 15. REMOVE EXISTING MANHOLE AND CONSTRUCT NEW TYPE E MANHOLE PER COA STD DWG 2101. 16. REMOVE EXISTING MANHOLE AND CONSTRUCT NEW TYPE E MANHOLE PER COA STD DWG 2101. 17. STORM DRAIN PIPE TO DAYLIGHT AT BOTTOM OF TRANSFER TABLE. DOWNSPOUT NOZZLE DETAILS PER PLUMBING PLANS. 18. RE LAY TRACKS TO MATCH FINISHED GRADE. SEE ARCHITECTURAL PLAN FOR MORE INFORMATION.  ELEGEND  C	NEW MEXICO MEDIA ACADEMY + CNM FILM HISTORIC SHELL - 100% CONSTRUCTION DOCUMENTS ALBUQUERQUE RAIL YARDS 777 1ST ST SW, ALBUQUERQUE, NM 87102
	HIGH, FGL=FINISH GROUND LOW HIGH, FGL=FINISH GROUND LOW DIRECTION OF FLOW DIRECTION OF FLOW DIRECTION OF FLOW SD EXISTING STORM DRAIN LINE PROPOSED STORM DRAIN MANHOLE PROPOSED STORM DRAIN MANHOLE PROPOSED STORM DRAIN INLETS PROPOSED INDEX CONTOUR S025 PROPOSED INTERMEDIATE CONTOUR S025 PROPOSED INTERMEDIATE CONTOUR WATER BLOCK GRADING LIMITS NOTE TO CONTRACTOR USE OF HDPE REQUIRES A PRE-CONTRUCTION MEETING WITH MANUFACTURERS REPRESENTATIVE TO ENSURE PROPER INSTALLATION	5       06-16-2025       CHILLER YARD GRADING         4       09-23-2024       ASI-013R0 SITE CURB         3       08-22-2024       GRADING UPDATES         2       07-01-2024       MEP COORDINATION         1       02-14-2024       GRADING EDITS         NO       DATE       DESCRIPTION         DATE:       2023-12-11         PROJECT #:       20230392         DRAWN BY:       DH/DO         CHECKED BY:       KMK         COPYRIGHT:       SMPC Architects © 2023         These documents were prepared for this specific project only. SMPC Architects' liability is limited to this specific project, and does not extend to reuse of these documents for other projects.         SHEET TITLE       GRADING PLAN
15' 0' 30' 1" = 30'	PRACTICES ARE UNDERSTOOD AND USED BY CONTRACTOR. CONTRACTOR SHALL NOTIFY ENGINEER, IN WRITING, THE DATE AND TIME OF THE COMPLETION OF THIS MEETING.	GP001.R5

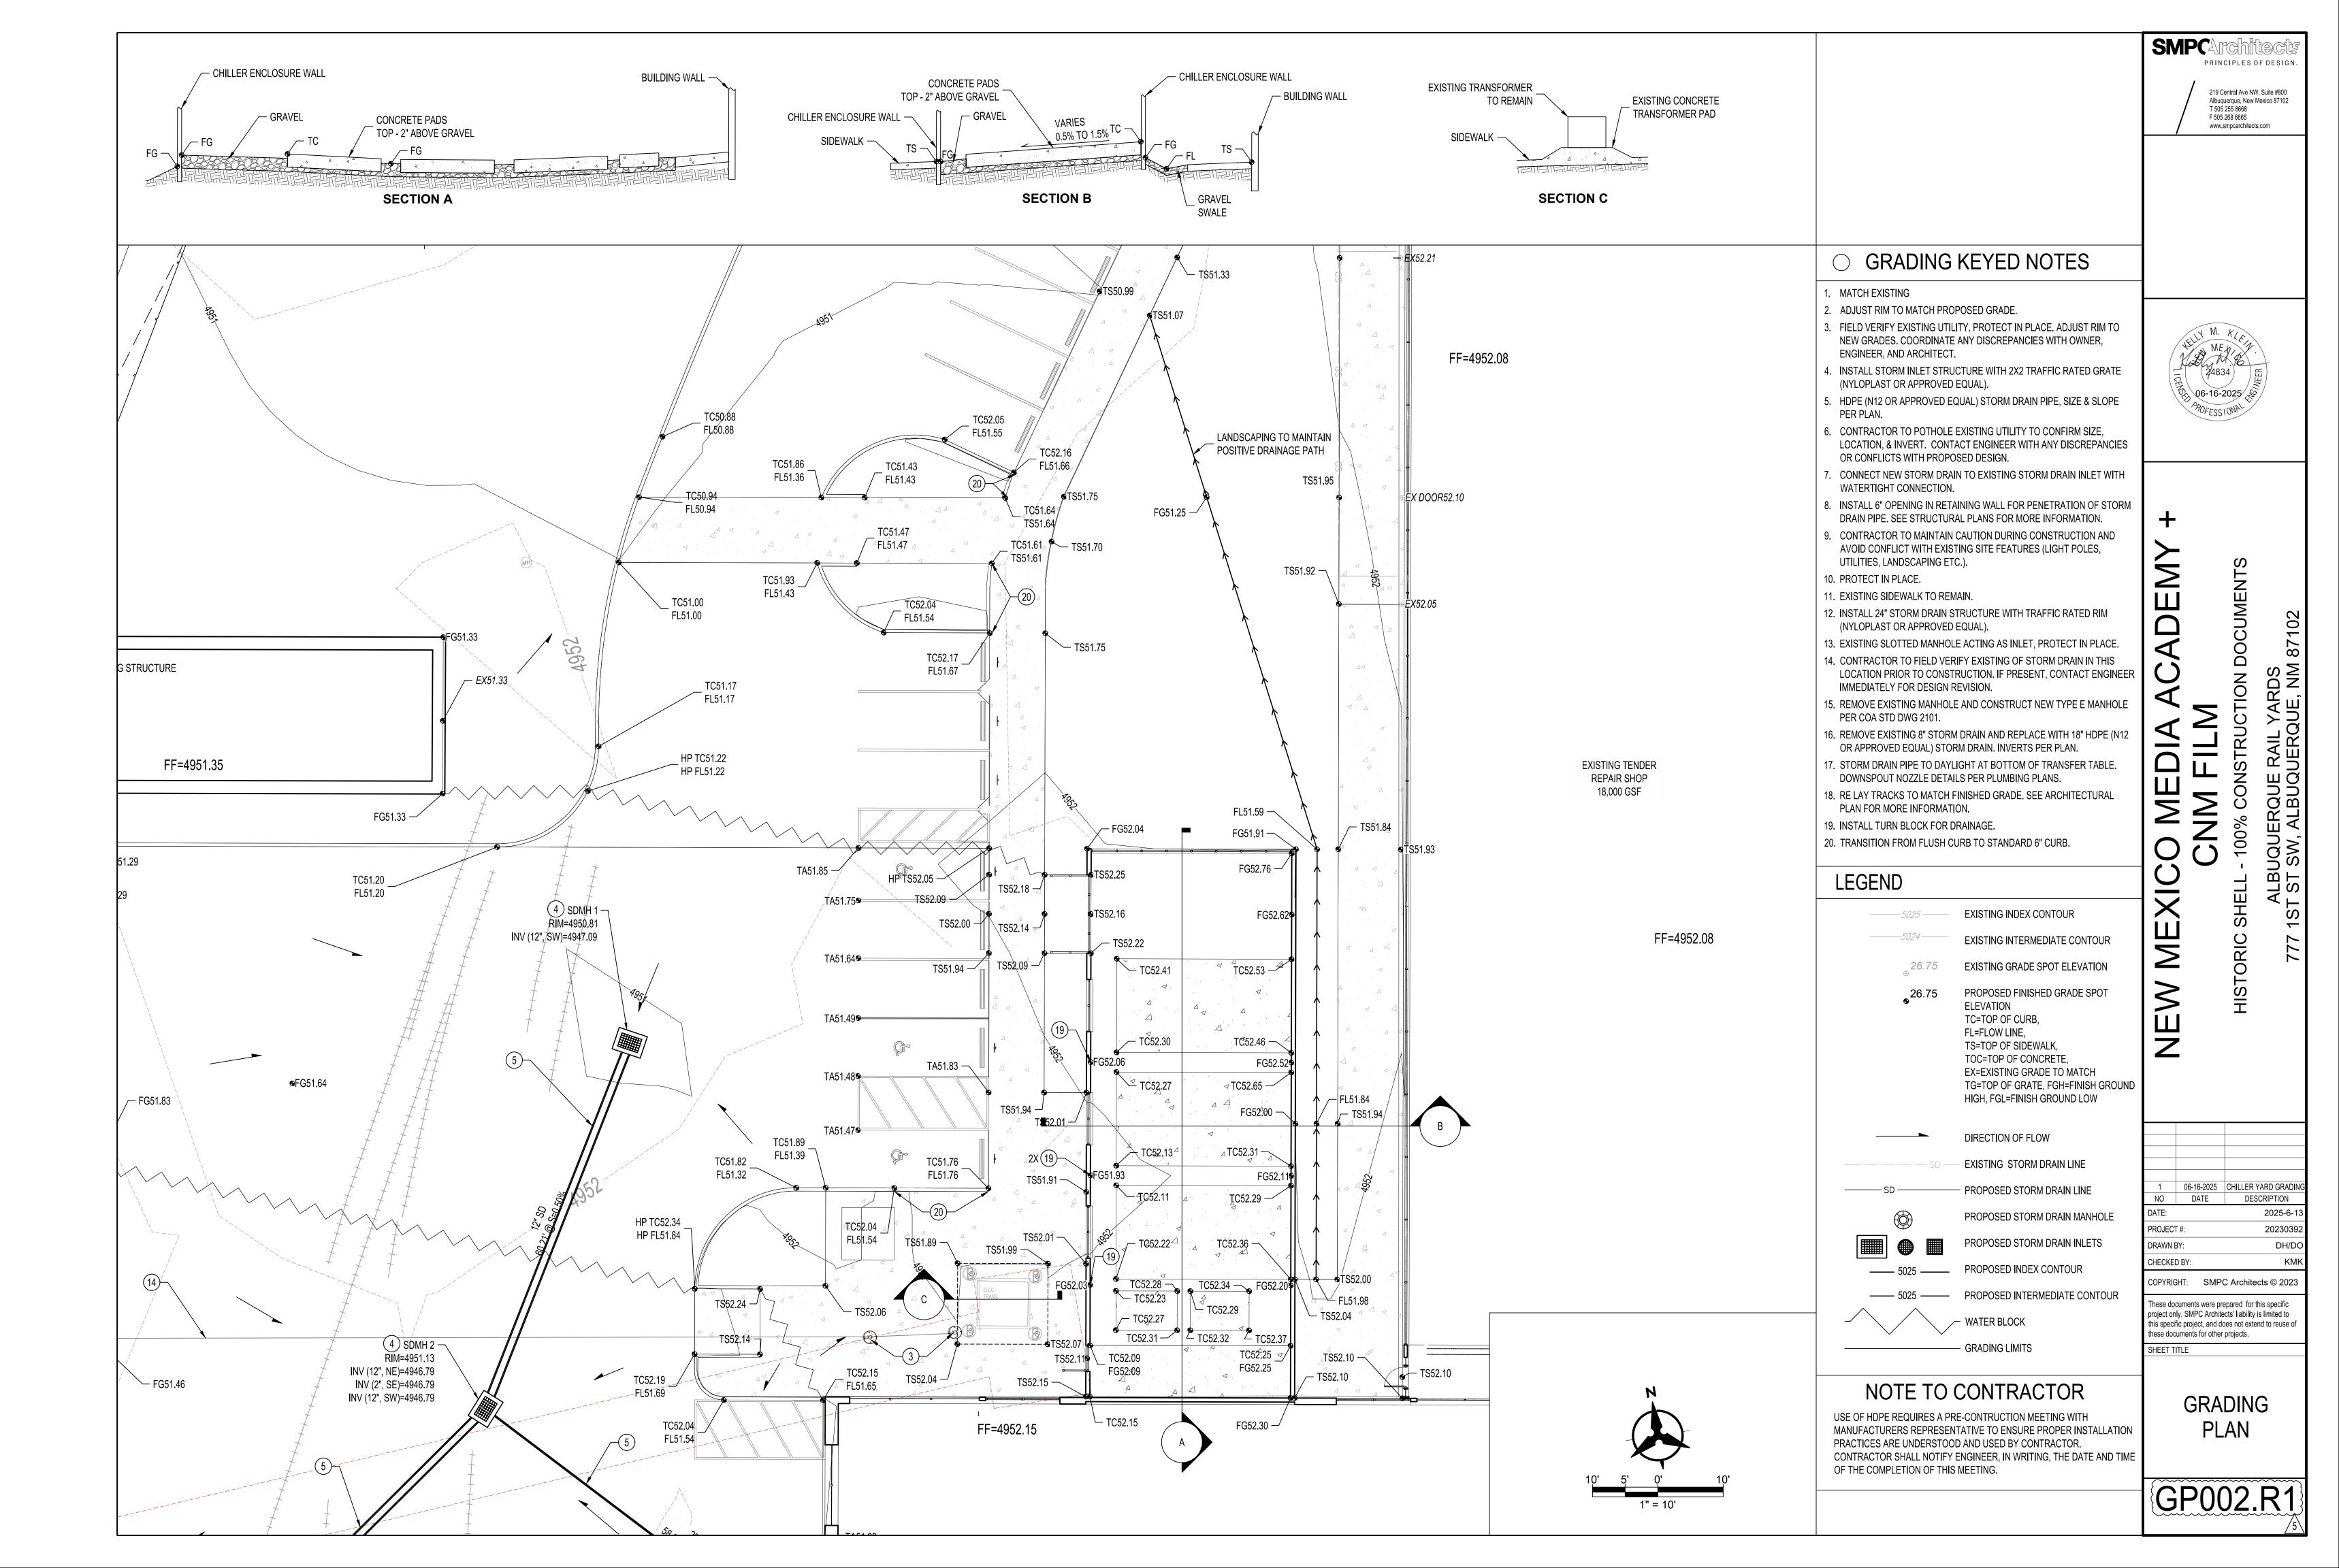

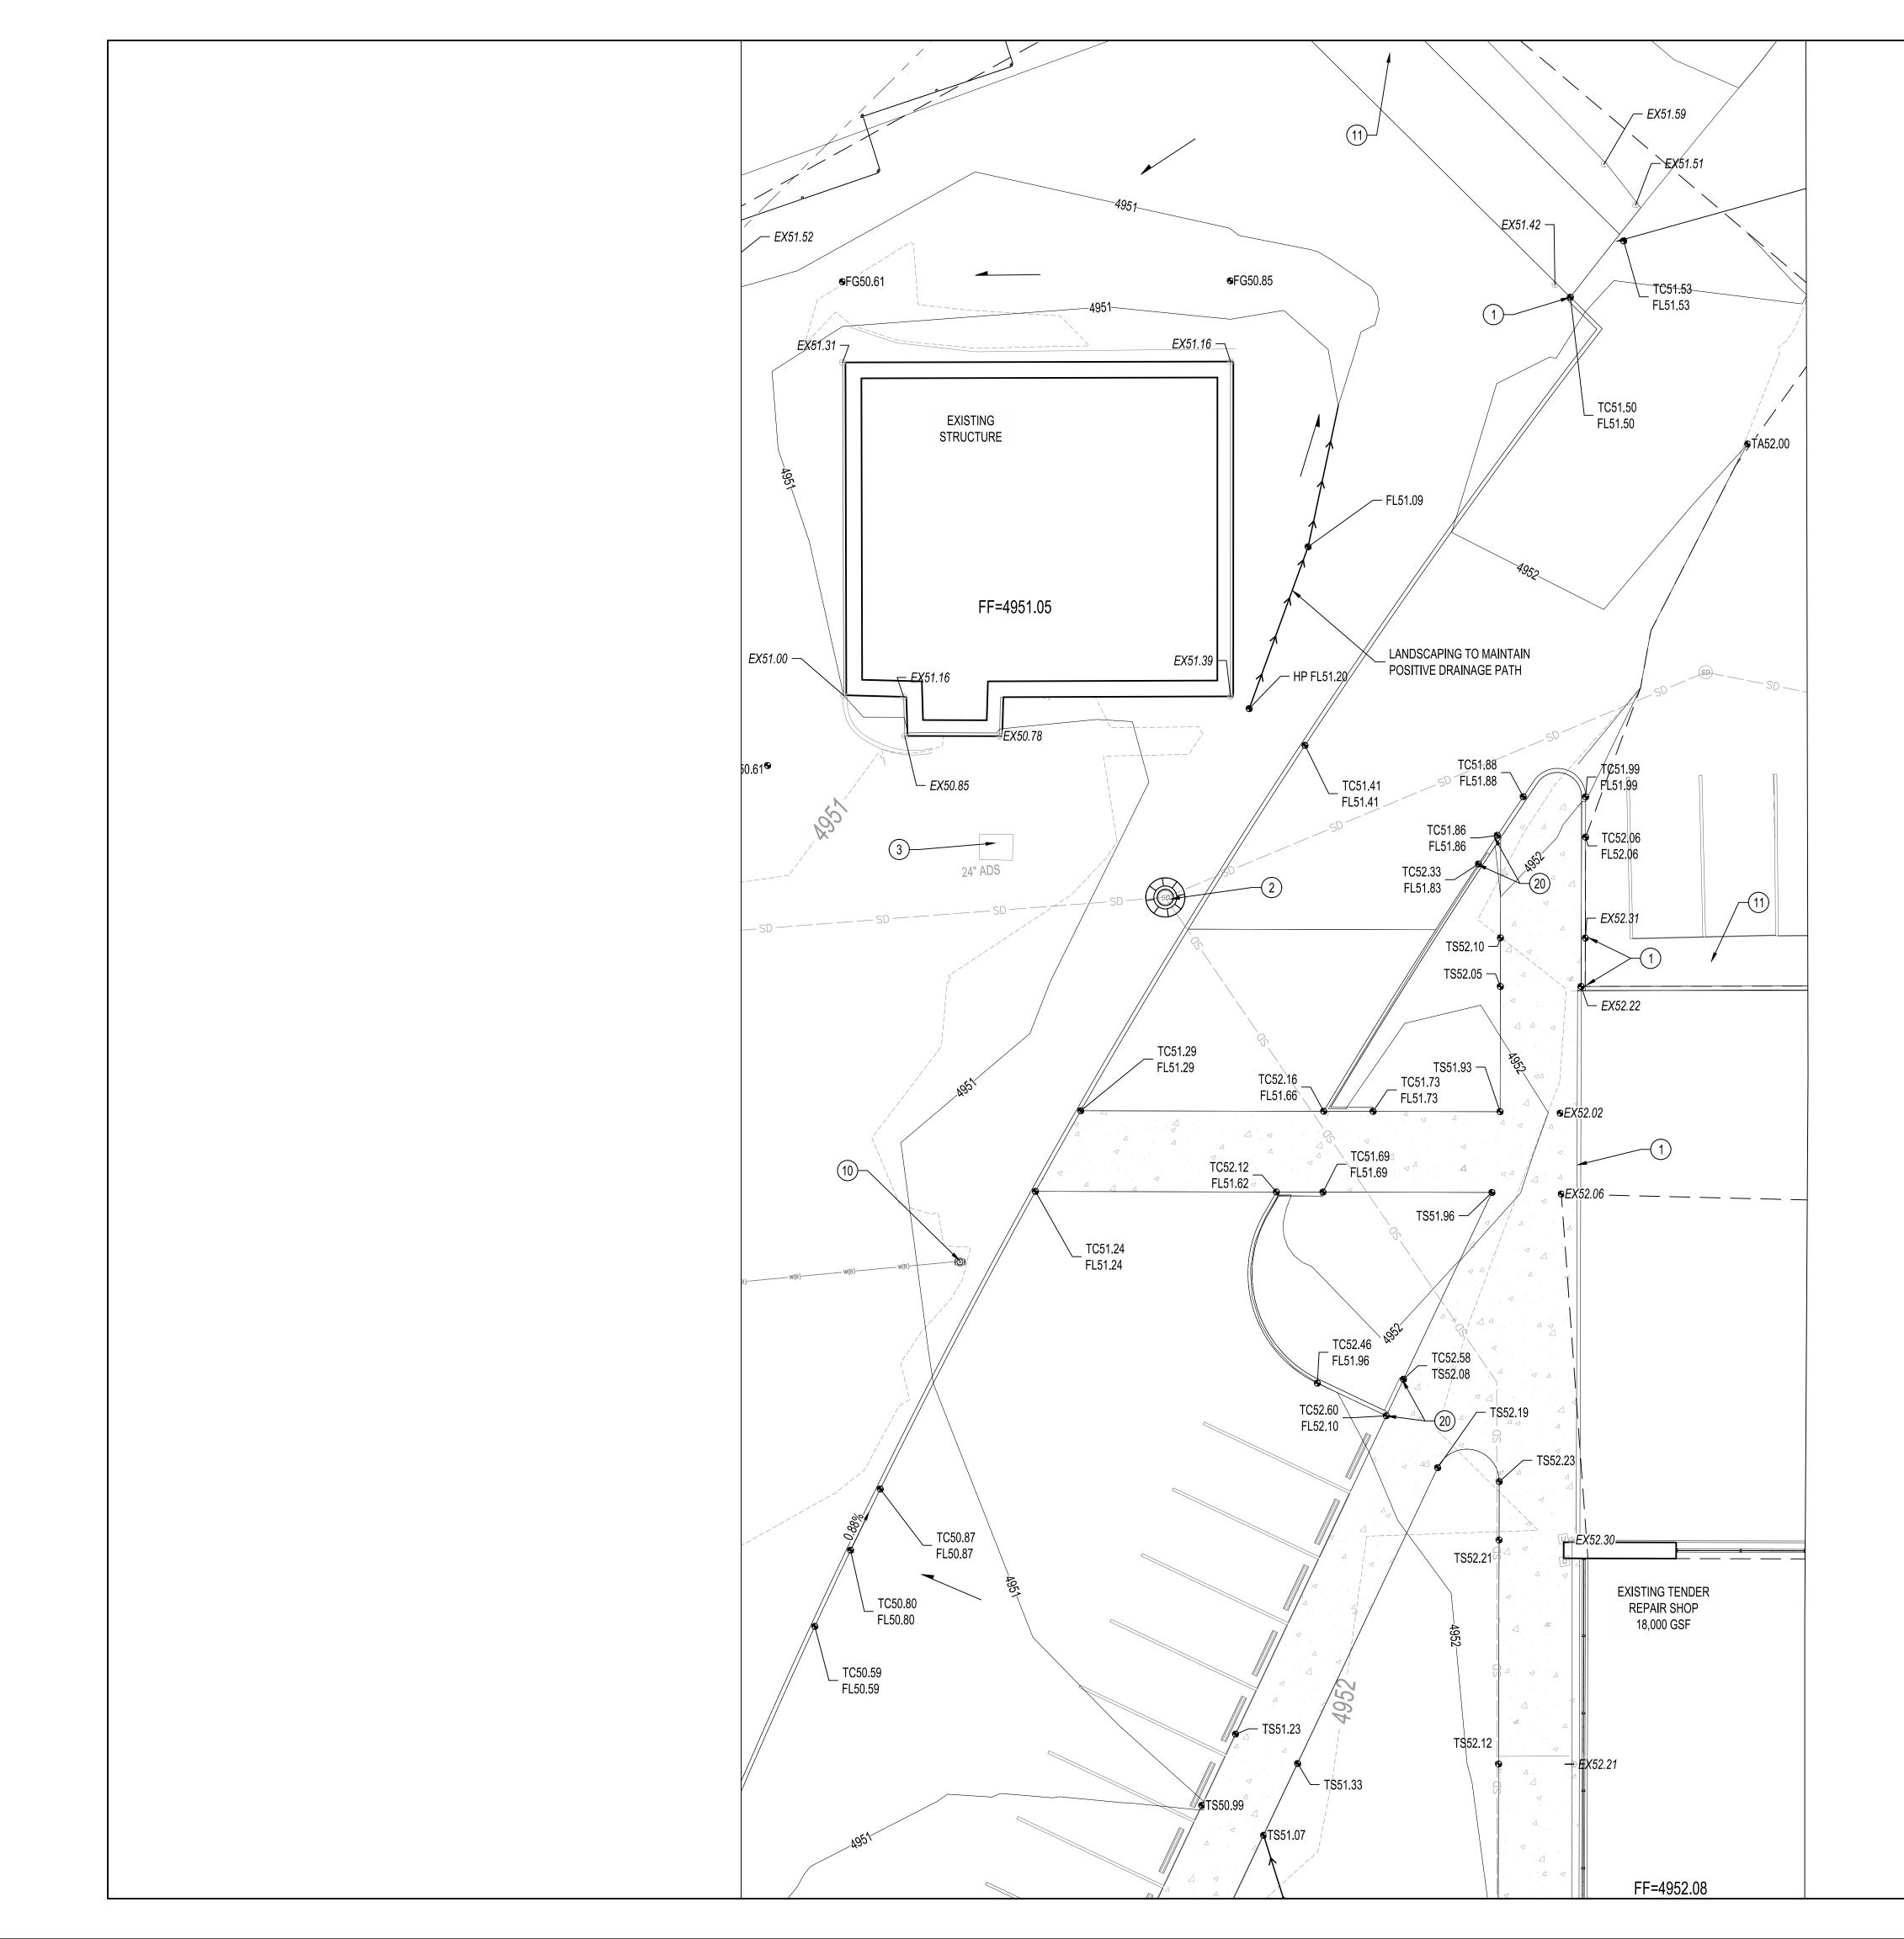

10

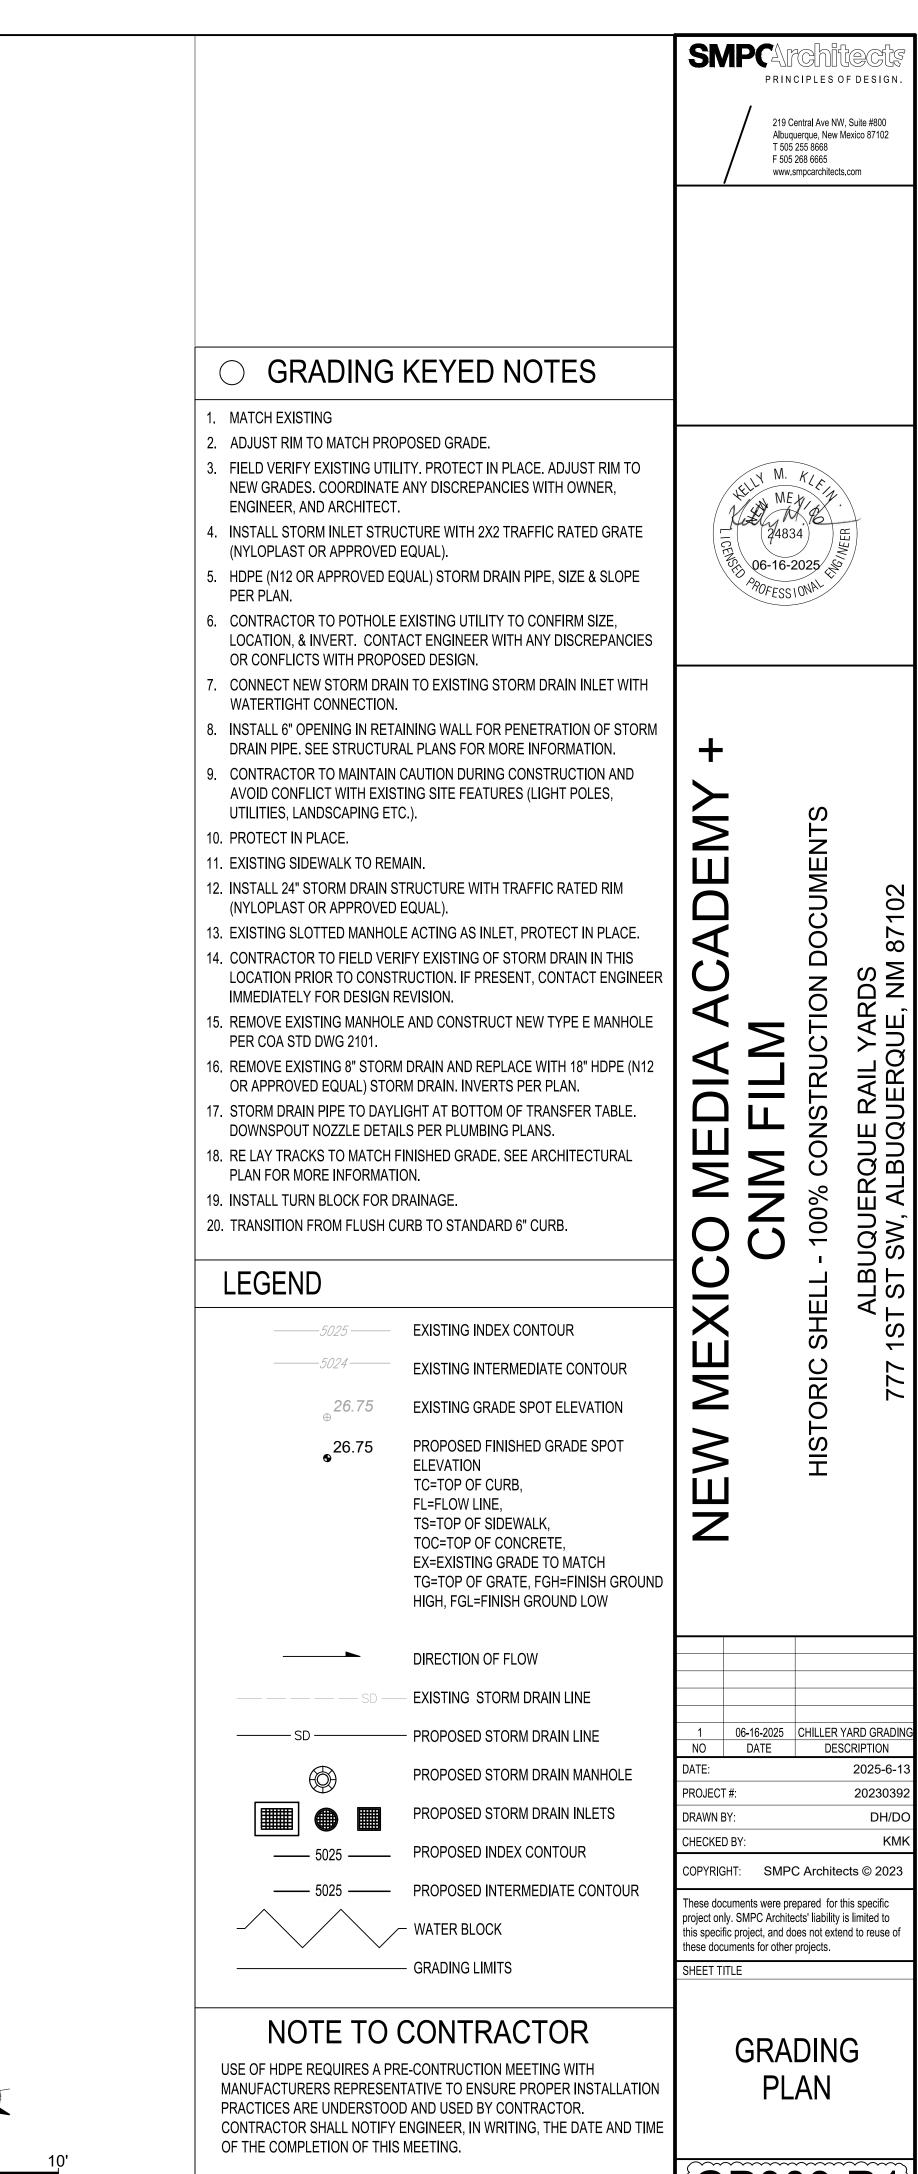

1" = 10'

## (GP003.R1)