CITY OF ALBUQUERQUE

Planning Department
Brennon Williams, Director



January 21, 2022

Phillip B Gallegos, RA Acequia Architects, LLC 431 E Orman Ave. Pueblo, CO 81004

Re: El Encuentro Community Center 907 4th St. NW Traffic Circulation Layout Architect's Stamp 01-20-222 (K14-D121)

Dear Mr.Gallegos,

The TCL submittal received 01-21-2022 is approved for Building Permit. A copy of the stamped and signed plan will be needed for each of the building permit plans. Please keep the original to be used for certification of the site for final C.O. for Transportation.

PO Box 1293

When the site construction is completed and an inspection for Certificate of Occupancy (C.O.) is requested, use the original City stamped approved TCL for certification. Redline any minor changes and adjustments that were made in the field. A NM registered architect or engineer must stamp, sign, and date the certification TCL along with indicating that the development was built in "substantial compliance" with the TCL. Submit this certification, the TCL, and a completed <u>Drainage and Transportation Information Sheet</u> to front counter personnel for log in and evaluation by Transportation.

Albuquerque

Once verification of certification is completed and approved, notification will be made to Building Safety to issue Final C.O. To confirm that a final C.O. has been issued, call Building Safety at 924-3690.

NM 87103

Sincerely,

www.cabq.gov

Jeanne wolfenbarger

Jeanne Wolfenbarger, P.E. Traffic Engineer, Planning Dept. Development Review Services

\xxx via: email C: CO Clerk, File



City of Albuquerque

Planning Department

Development & Building Services Division

DRAINAGE AND TRANSPORTATION INFORMATION SHEET (REV 6/2018)

Project Title: IMMIGRANTOOM	UNUBUILDING Permit #: - 2	121- 31153 Hydrology File #:	
DRB#:	EPC#:	Work Order#:	
Legal Description: LT & PLAT OF			
City Address: 907 4TH ST SW,		7102 0.459 AC	
Applicant: ACEQUIA ARCHITE		Contact: PAIL GALLEGOS	
Address: 431 E CRMAN ANE	PUEBLO, CO SLOO	- ACEQUA ARCHITECTS	
Phone#(303)883-9286	Fax#:	E-mail: g-wail Com	
Other Contact: RON ROMERO 1		Contact: RON ROMERO	
Address: 511 MARBUE NW	ALBUQUERQUE N	14 87102 MESS 1816 MILES	
Phone#: (505) 269-5383	Fax#:	RODROMERO INCO	
TYPE OF DEVELOPMENT:PL	AT (# of lots) RESIDI	ENCE DRB SITE ADMIN SITE	
IS THIS A RESUBMITTAL?Y	'es No		
DEPARTMENT TRANSPORTATIO	ON HYDROLOGY/	DRAINAGE	
Check all that Apply:	/	OF APPROVAL/ACCEPTANCE SOUGHT:	
TABLE OF CURMITTEET.		BUILDING PERMIT APPROVAL	
TYPE OF SUBMITTAL: ENGINEER/ARCHITECT CERTIFICA		CERTIFICATE OF OCCUPANCY	
PAD CERTIFICATION			
	CONCEDIUM C & D DI AN		
GRADING PLAN		SITE PLAN FOR SUB'D APPROVAL	
DRAINAGE REPORT		SITE PLAN FOR BLDG. PERMIT APPROVAL	
DRAINAGE MASTER PLAN	F	FINAL PLAT APPROVAL	
FLOODPLAIN DEVELOPMENT PERM	AIT APPLIC		
ELEVATION CERTIFICATE		SIA/ RELEASE OF FINANCIAL GUARANTEE	
CLOMR/LOMR	-	FOUNDATION PERMIT APPROVAL	
GRADING FERMIT AFROVAL			
TRAFFIC CIRCULATION LAYOUT (TCL)		SO-19 APPROVAL	
ETREPE LICITE LAVOIT			
GRADING FAD CE		FRADING/PAD CERTIFICATION	
	<i>p</i>	VORK ORDER APPROVAL	
PRE-DESIGN MEETING?		LOMR/LOMR	
	F	LOODPLAIN DEVELOPMENT PERMIT	
	C	THER (SPECIFY)	
DATE SUBMITTED: DI 120/22	BY: PHULLE E	ALLEGOS (\$180.22	

COA STAFF:

ELECTRONIC SUBMITTAL RECEIVED:

FEE PAID:

IDO Parking and Zoning Review Parking and Traffic Circulation Layout

November 2020 Edition Amended April 2021

IDO Zone District Designation: MX-L Mixed Use Low Intensity 2-4(B) Barelas Character Protection District Overlay (CPO-1)

LEGAL DESCRIPTION LT A PLAT OF LOTS A & B ATLANTIC & PACIFIC ADDITION CONT 0.4898 AC

Site Information Parcel Area: 0.489 Acres No building additions or exterior building changes

SECTION 2-4(B) MX-L Building Height: 38 Feet Maximum and 18 Feet actual to highest point

SECTION 3 OVERLAY Section 3-4(B) Barelas CPO-1 MX-L Front, Rear, Side Minimum: 0 feet Section 3-4(E) 1 East Downtown CPO-4 Not applicable Out of Area

SECTION 4-2-1 PERMITTED USES Current: Civic Uses Religious Permissive Primary 4-3(C)(9) Proposed: Civic Uses Community Center Permissive Primary 4-3(C)(1) Same size limits required of Religious Institutions Public Notice Use Change not required

SECTION 5-1-2 Mixed Use Zoning Dimension Standards Table 5-1-2 Setbacks Front: 5 Feet Required and 5-foot actual provided from 4th Street SW Side Interior: 5 feet COMPLIES Side Street: 15 feet COMPLIES

Rear: 15 Feet Main Building complies, Overhead Deck

SECTION 5-5 PARKING AND LOADING Table 5-5-1

Permissive uses Civic and Institution Community Center: 2 Spaces per 1000 square feet GFA Building Area Building Area: 60 feet x 120 feet OR 7200 GSF Required Parking: (7200 GSF/1000 GSF x 2 spaces) OR 14.4 Spaces

14 CAR SPACES MINIMUM REQUIRED

Motorcycles:

Section 5-5D(1) Table 5-5-4 Required Off-street parking 1-25 1 Motorcycle Space Required

Bicycles:

Section 5-5E(1) Table 5-5-5 Required Nonresidential Uses 3 Spaces or 10% of Required 3 Spaces Required

ADA Accessible Parking Spaces Required:
ADA Regulation Table 208.2 Parking Spaces
Total Number of Parking Spaces Required: 1-25 Spaces Minimum Number of Required Accessible

Total Number of Accessible Parking Spaces Provided: 1

Parking Spaces: 1

TOTAL PARKING SPACES REQUIRED:

Jeanne Wolfenbarger

14 SPACES

within 15 feet


Existing Parking Zone Lot A Paved 28 Car Spaces 2 ADA Accessible Car Parking

Proposed Parking Zone Lot A Paved 23 Car Parking 1 ADA Accessible Car Parking

2 Motorcycle Spaces 3 Bicycle Rack

SECTION 5-6 LANDSCAPE BUFFERING SCREENING Barelas Improvement District Streetscape: Existing and Neighborhood Review


Section 5-6 (B) (4) Applicability Renovation Permit is less than \$500,000: Exempt

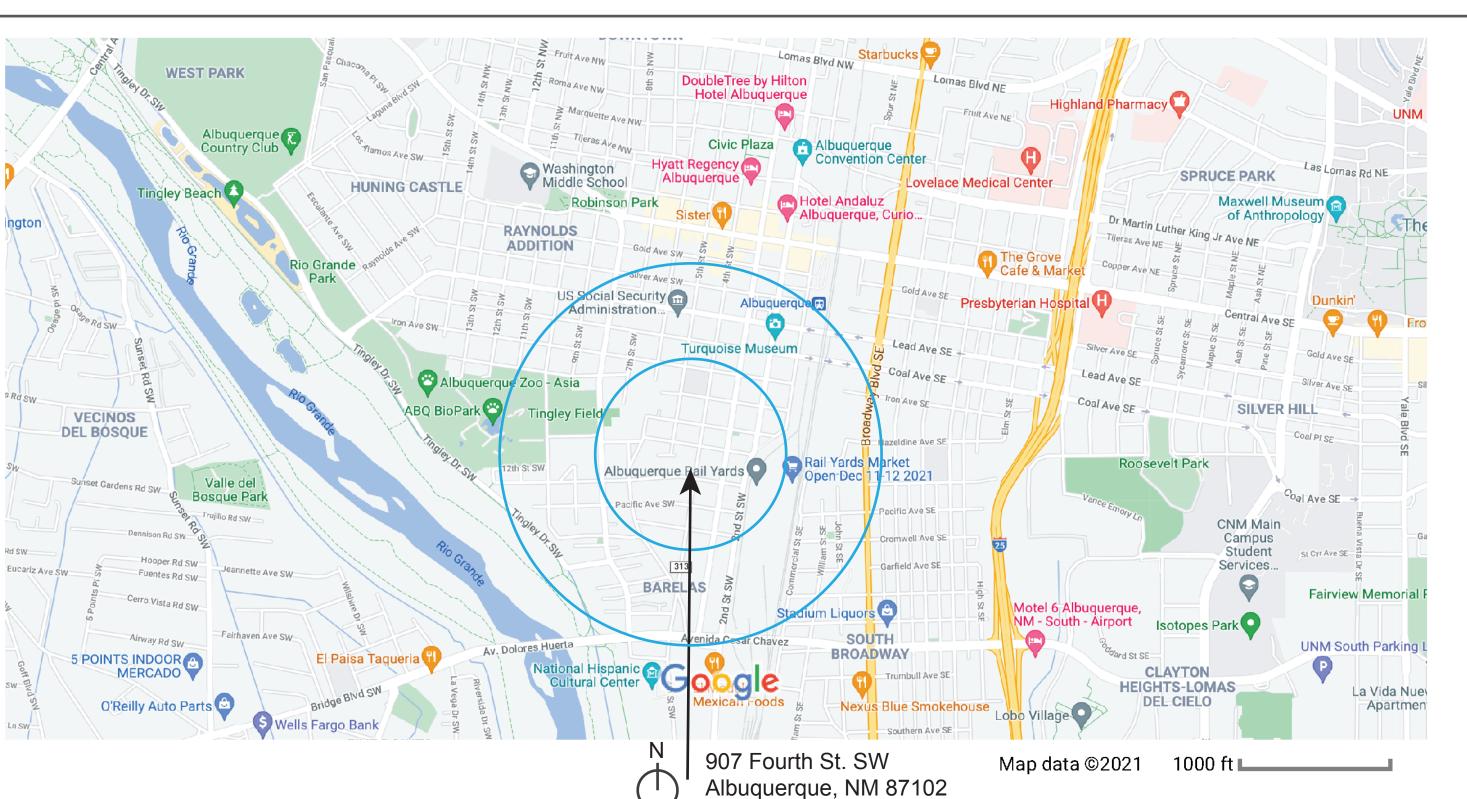




TCL RESPONSE #1:


TRAFFIC CIRCULATION LAYOUT

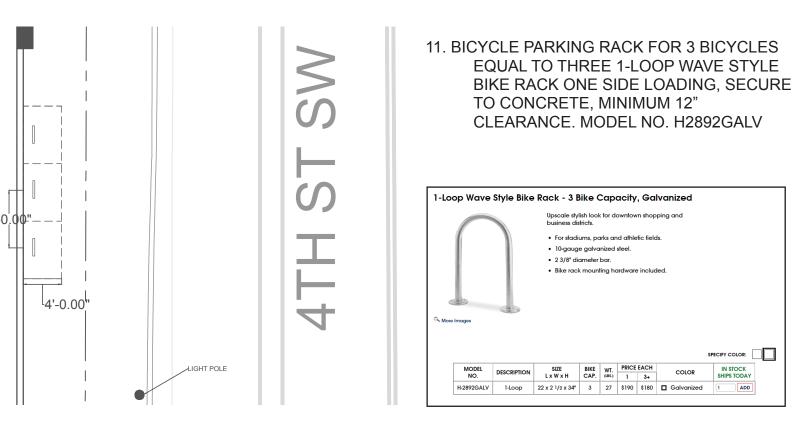

BICYCLE RACK REQUIREMENTS: 3 BICYCLES SCALE 1" = 10'

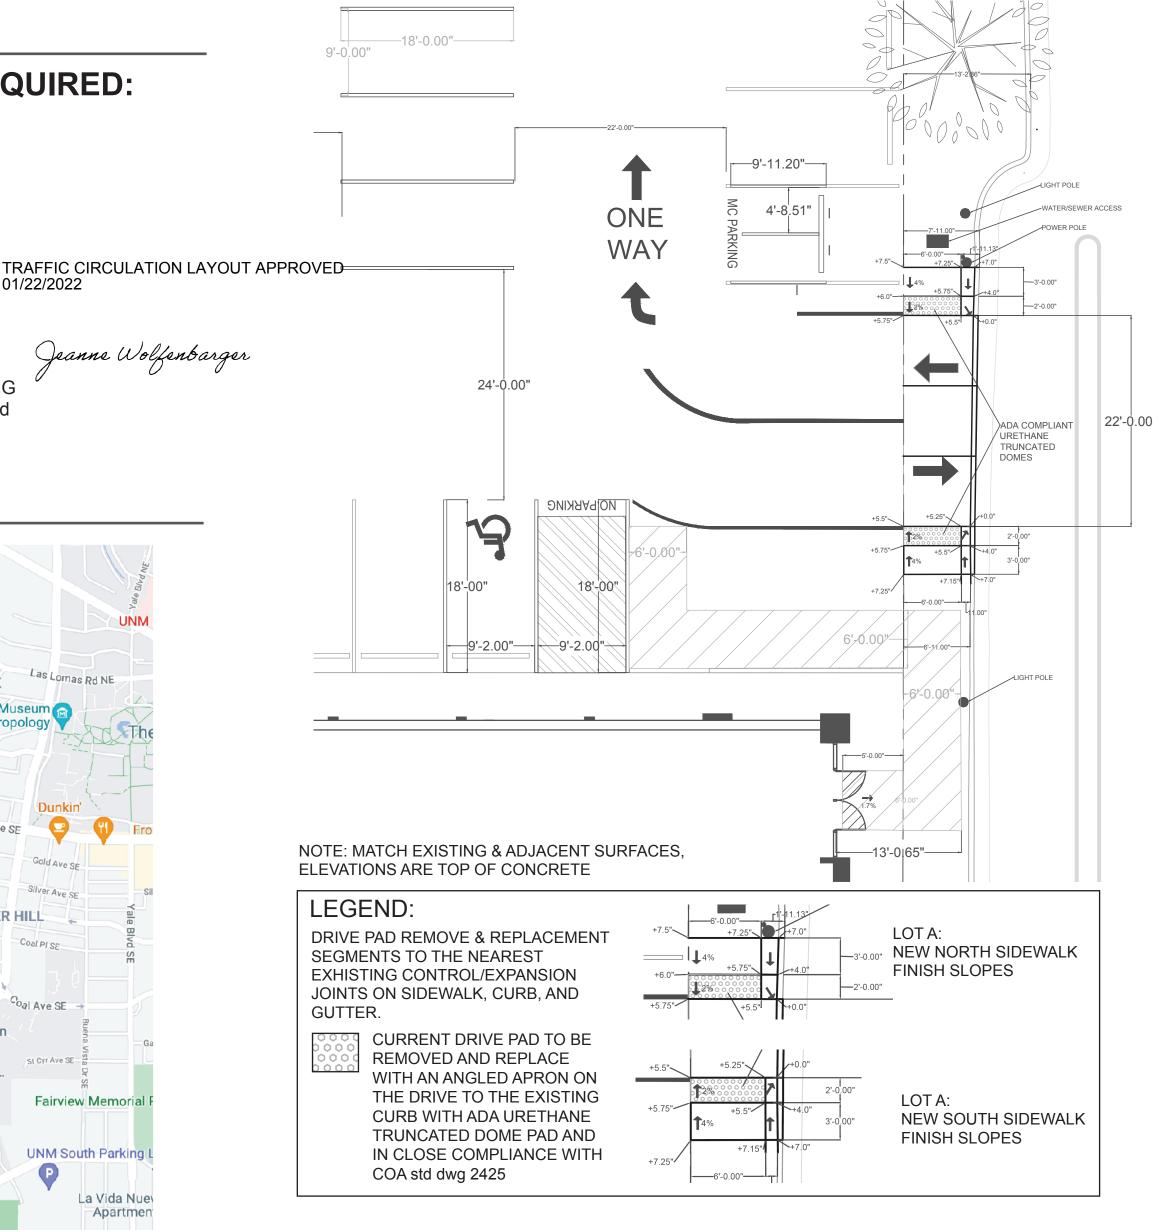


PROPOSED DRIVEWAY-LOTA SCALE 1" = 10'

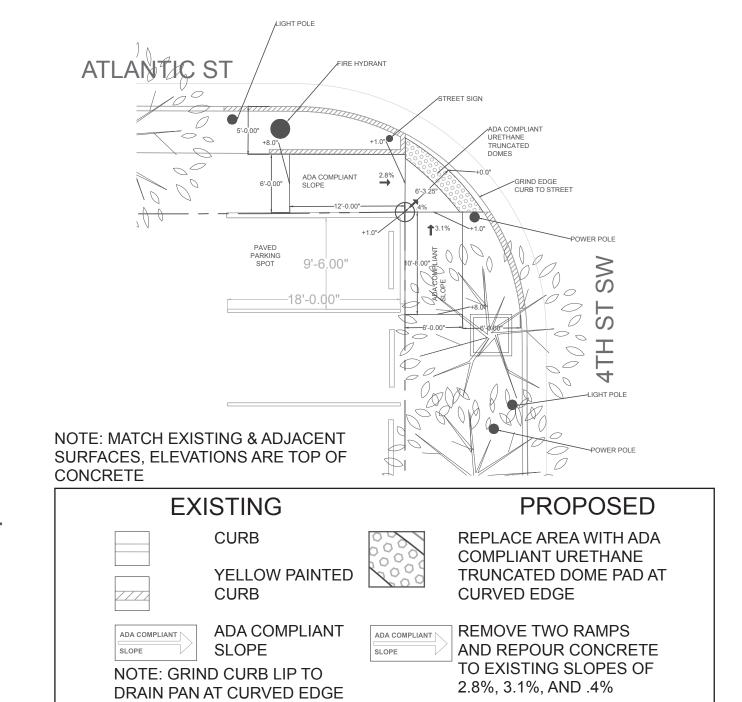

NOTE: CORNER DETAIL REFERENCE COA std drw 2441

EXISTING/ PROPOSED CORNER SCALE 1" = 10'

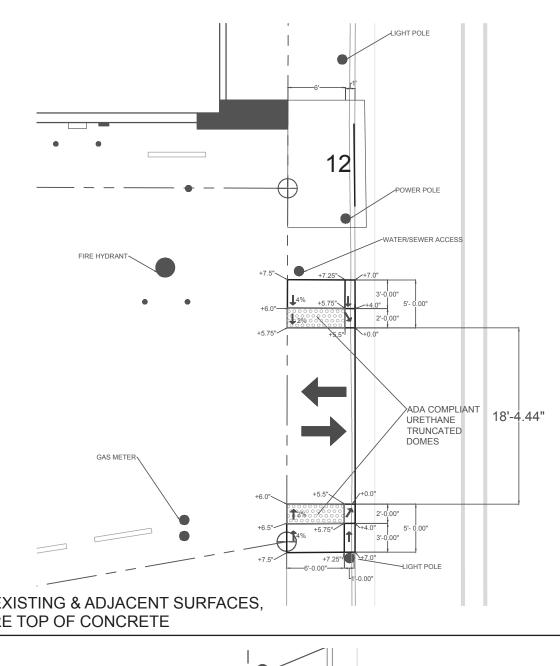

NOTE: MATCH EXISTING & ADJACENT SURFACES **ELEVATIONS ARE TOP OF CONCRETE** LEGEND: 12. REMOVE 8FT DRIVEWAY AND LOT B: REPLACE WITH STANDARD CURB **NEW NORTH** AND GUTTER WITH SIDEWALK TO SIDEWALK MATCH ADJACENT SURFACES IN FINISH SLOPES COMPLIANCE WITH COA std dwg 2415 AND COA std dwg 2430. CURRENT DRIVE PAD TO BE REMOVED AND REPLACE WITH AN ANGLED APRON ON THE DRIVE TO THE EXISTING **NEW SOUTH CURB WITH ADA URETHANE** SIDEWALK TRUNCATED DOME PAD AND IN CLOSE COMPLIANCE WITH COA std dwg 2425.

PROPOSED DRIVEWAY- LOT B SCALE 1" = 10'

ARCHITECT: LOCATION: CLIENT: Acequia Architects, LLC 907 4th Street SW Acequia.architects@gmail.com Albuquerque, NM 87102 303-883-9286



		TEACH CHILD
PROJECT NO:	1	DRAWING SHEET NO:
DRAWN BY:	KM	
CHECKED BY:	PG	TCL 001
DATE:	1/20/2022	1 OF 1

LEGEND: PROPOSED CHANGES: EXHIBIT A. ACCESSIBLE PARKING 1. GAS METER 7.MOTORCYCLE PARKING 4.5+ FEET WIDE WITH 12"X18" "MOTORCYCLE PARKING" POLE SIGN AT 60" ABOVE 2. FIRE HYDRANT/SEWER/ WATER ACCESS GROUND AND PAINTED SURFACE DESIGNATION WITH 3. STREET LIGHT POLE MC PARKING VIOLATORS ARE SUBJECT TO A FINE AND/OR TOWING 4. OVERHEAD ELECTRICAL POLE 5. FIRE SPRINKLER TAP RISER 8. ADA ACCESSIBLE WALL SIGN 12"X18" WITH HANDICAP UNIVERSAL SYMBOL AND "VIOLATORS ARE SUBJECT TO A FINE 6. TRASH BIN ACCESSIBLE AND/OR TOWING" @ 60" ABOVE GROUND- SEE EXHIBIT A. 60'-0" Parking Signage ROW 9. ADA ACCESSIBLE AISLE WITH 4" DIAGONAL BLUE PAINTED 60'-0" STRIPPING AT 60* AND SPACED AT 8" BETWEEN STRIPS. ATLANTIC AVE SW ROW PROVIDE 12"X18" WALL SIGN WITH "NO PARKING" AT 60" ATLANTIC AVE SW ABOVE GROUND AND BLUE PAINTED 1' TALL 2" WIDE "NO PARKING" LOCATED AT THE REAR OF THE PARKING SPOT 10. ACCESSIBLE PARKING WITH UNIVERSAL HANDICAP _98'-1.38"_ SYMBOL PAINTED 11. BICYCLE PARKING RACK FOR 3 BICYCLES EQUAL TO THREE 1-LOOP WAVE STYLE BIKE RACK LOT A +OT ONE SIDE LOADING, SECURE TO CONCRETE, MINIMUM 12" CLEARANCE. MODEL NO. H2892GALV AT MINIMUM 9'-0" x 18'-0" 12. REMOVE 8 FT DRIVEWAY AND REPLACE WITH STANDARD CURB AND GUTTER WITH SIDEWALK TO MATCH ADJACENT SURFACES PER COA STD DWG 2415 AND 115'-8.55" **COA DWG 2430** 13. MINIMUM PARKING SPACE DIMENSIONS CAR 9'X18" **MOTORCYCLE 4.5'X18'** HANDICAP 9'X18' 14. EXISTING 12' ACCESSIBLE ENTRY **ACCESS TO PUBLIC WAY** TRAFFIC CIRCULATION LAYOUT APPROVED -19'-6.00"-15. EXISTING 6' ENTRY ACCESS PATH TO HC PARKING 16. DO NOT ENTER SIGN 17. ONE WAY SIGN 18. PAVMENT MARKINGS FOR "ONE WAY" 19. LANDSCAPING AND SIGNAGE WILL NOT INTERFERE WITH CLEAR SIGHT REQUIREMENTS. THEREFORE, SIGNS, WALLS, TREES, AND SHRUBBERY BETWEEN 3-8 FEET TALL (AS MEASURED FROM THE GUTTER PAN) WILL NOT BE ACCEPTABLE IN THE CLEAR SIGHT TRIANGLE. 20'-6.00" LOT B LOT B 20. CORNER DETAIL REFERENCE COA STD DRW 2441. NOTE: ALL BROKEN OR CRACKED SIDEWALK AND/OR CURB AND **GUTTER MUST BE REPLACED EQUAL** TO CITY STANDARD COA STD DWG 2430 AND 2415A EXISTING PARKING AND TRAFFIC LAYOUT PROPOSED PARKING & TRAFFIC CIRCULATION LAYOUT PROPERTY LOT A & B PROPERTY LOT A & B SCALE 1"= 20' SCALE 1"= 20' SCALE: 1" = 20' DRAWING TITLE & SCALE: ARCHITECT: LOCATION: CLIENT: PROJECT NO: KM TRAFFIC CIRCULATION LAYOUT DRAWN BY: TRAFFIC CIRCULATION LAYOUT- DIMENSIONS, Acequia Architects, LLC 907 4th Street SW EXISTING PARKING AND TRAFFIC LAYOUT, & ENCUENTRO Albuquerque, NM 87102 Acequia.architects@gmail.com CHECKED BY: PG PROPOSED LAYOUT- LOT A & B 303-883-9286

SCALE 1"= 20'

DRAWING SHEET NO:

1/21/2022

DATE:

TCL002

1 OF 1