CITY OF ALBUQUERQUE

Planning Department Brennon Williams, Director



February 18, 2020

Glenn Broughton, P.E. Bohannan Huston, Inc. 7500 Jefferson St NE Albuquerque, NM 87109

RE: Presbyterian Hospital SE Parking Garage

1300 Central SE

Grading and Drainage Plan Stamp Date: 1/28/20

Hydrology File: K15D005G

Dear Mr. Broughton:

Based on the submittal received on 1/27/20 and Payment-in-Lieu received on 2/14/20, the Grading and Drainage Plan is approved for Building Permit and SO-19 Permit.

PO Box 1293

Prior to Certificate of Occupancy (For Information):

Albuquerque

1. Engineer's Certification, per the DPM Chapter 22.7: *Engineer's Certification Checklist For Non-Subdivision* is required.

NM 87103

2. The sidewalk culverts must be inspected and approved by Storm Drain Maintenance (Augie Armijo at (505) 857-8607).

www.cabq.gov

3. City acceptance and close-out of the public Work Order will be required, unless a financial guarantee has been posted.

If you have any questions, please contact me at 924-3695 or dpeterson@cabq.gov.

Sincerely,

Dana M. Peterson

Senior Engineer, Planning Dept. Development Review Services



City of Albuquerque Treasury

J-24 Deposit
Date: 2/14/2020 Office:
Station ID Cashier:
Batch: 11100 Trans:

305

461615

Funda

Cashier: e43322 Trans: 19

TREASURY DIVISION DAILY DEPOSITING:

Activity ID7547210 Project ID24_MS4 Bus.Unit: PCDMD

Transmittals for: PROJECTS Only

Alloc Amt: \$27,280.00 Trans Amt: \$27,280.00 Check Tendered:

\$27,280.00

Payment In-Lieu for Storm Water Quality Volume Requirement

CASH COUNT	AMOUNT	ACCOUNT NUMBER	FUND NUMBER	BUSINESS	PROJECT ID	ACTIVITY ID	AMOUNT
TOTAL CHECKS	\$ 27280.00	461615	305	PCDMD	24_MS4	7547210	\$ 27280.00
TOTAL AMOUNT						TOTAL DEPOSIT	\$27,280.00

Hydrology#: K15D005G		Presbyterian Hospital SE Parking Garage, 157385 sf imp.
Payment In-Lieu For Storm Water Quality Volume Requirement		
Address/Legal Description: 1300 Central SE Tract 4-A-1, Presbyterian Ho	ospital Main	Campus
DEPARTMENT NAME: Planning Department/Develop	ment Revie	N Services, Hydrology
PREPARED BYDana Peterson	PHONE	924-3695
BUSINESS DATE1/31/20		
DUAL VERIFICATION OF DEPOSIT	ATURE	
AND BY		
EMPLOYEE SIGNATURE		
REMITTER:		
AMOUNT:		
CHECK #: DATE ON CHECK:		
The Payment-in-Lieu can be paid at the Plaza del So invoice to the Treasury and provide a copy of the re		

with the Hydrology submittal to PLNDRS@cabq.gov.



City of Albuquerque

Planning Department

Development & Building Services Division

DRAINAGE AND TRANSPORTATION INFORMATION SHEET (REV 6/2018)

Project Title: Bu	nilding Permit #:	Hydrology File #:
DRB#:EF	PC#:	Work Order#:
Legal Description:		
City Address:		
Applicant:		Contact:
Address:		
Phone#:Fa		
Other Contact:		Contact:
Address:		
Phone#:Fa		E-mail:
TYPE OF DEVELOPMENT: PLAT	RESIDENCE	DRB SITE ADMIN SITE
Check all that Apply:		
DEPARTMENT:	BUILDI CERTIF PRELIM SITE PI SITE PI FINAL SIA/ RE GRADII SO-19 A PAVING GRADII WORK G CLOMF	G PERMIT APPROVAL NG/PAD CERTIFICATION ORDER APPROVAL

FEE PAID:____

	EXB1 713 EXB2 769 EXB3 366	995 1.77 0.0% 0.0% 7.0% 689 0.84 0.0% 0.0% 45.0%	D (cfs/ac.) (CFS) (inches) (87.0% 4.5 7.4 1.99 17 93.0% 4.6 8.1 2.05 13 55.0% 4.0 3.4 1.67 5	Obyr-6hr) V(100yr-24hr) CF) (CF) 1837		GEND DRAINAGE BASIN BOUNDARY	BACKGROUND: PRESBYTERIAN HOSPI THE DOWNTOWN CAM NORTH EAST PORTION AND CENTRAL. METHODOLOGY: THE SITE IS LOCATED DEVELOPMENT PROCE PROPOSED DRAINAGE SAN MATEO AND IS WI EXISTING CONDITIONS THE SITE IS FULLY DEV
CENTRAL AVENUE-SE	EXISTING SD INLETS RECEIVED AND THE STATE OF THE STATE O	STATE OF THE PROPERTY OF THE P	SYCAMORE STREET SI				THE PARKING GARAGE (BASIN EXB1) FREE DIS ALIGNMENT. THE NORT EXISTING PRIVATE INLE THIS INLET CONNECTS INTERSECTION OF SPR THE MOST SOUTHERN RECONFIGURED TO AL THE SITE IS NOT LOCA' 35001C0334G). PROPOSED CONDITION THE SCOPE OF THE PA STRUCTURE IN PLACE UPPER DECK WILL BE RECON PATTERNS. REFER TO THE DRAINA BASINS, LAND TREATM STORM WATER POLLUTION OR RETENTION COULD BE WITH LITTLE AVAILABLE
	CIS CIS OCTS OC	TOPE (B)	7.4 cfs	SPRUCE STREET SE	S S S S S S S S S S S S S S S S S S S	EXBA SON TOMBERS OF THE PROPERTY OF THE PROPE	THESE REASONS THE MANAGEMENT. THE WAY CALCULATED STORM WAY THIS PORTION OF THE CONCLUSION: THE AREA THAT IS PROTHE PUBLIC RIGHT OF THIS SITE THE EXISTIN WILL NOT SIGNIFICANT COMPLY WITH SECTIO WILL PAY CASH IN LIEU CUBIC FEET. THIS DRAY OF HYDROLOGY APPR
			GOLD AVENUE SE	Std Current And Grant Court of the Court of	SET 1.5" WASHER	ONINTERS ON H.O. P. ONIOSINIO DINESIXE	
			(A2) EXISTING DRAINAG	SE MANAGEMENT PLAN		z	

BACKGROUND:

SPITAL IS PLANNING CONSTRUCT A NEW PARKING STRUCTURE AT CAMPUS. THE NEW PARKING STRUCTURE IS PROPOSED IN THE TION OF THE SITE AND IS BOUNDED BY SPRUCE, SYCAMORE, SILVER

ED IN THE CITY OF ALBUQUERQUE AND SECTION 22.2 OF THE OCESS MANUAL (DPM) WAS USED TO ANALYZE THE EXISTING AND AGE. THE PROJECT IS LOCATED BETWEEN THE RIO GRANDE AND WITHIN PRECIPITATION ZONE 2.

DEVELOPED WITH ASPHALT PAVING AND MINIMAL LANDSCAPING. AGE SITE IS BROKEN INTO FOUR BASINS. THE SOUTHERN BASIN DISCHARGES INTO SPRUCE AND DRAINS INTO THE GOLD AVE. IORTHERN TWO BASINS (BASINS EXB2 & EXB3) DRAIN NORTH TO AN INLET IN THE NORTHWEST CORNER OF BASIN EXB3.

CTS TO AN EXISTING PUBLIC STORM DRAIN INLET AT THE SPRUCE AND CENTRAL.

ERN BASIN LOCATED SOUTH OF SILVER (BASIN EXB4) WILL BE ALLOW RV PARKING FREE DISCHARGES INTO SPRUCE ST.

OCATED WITHIN A DESIGNATED FEMA FLOOD ZONE (FEMA FIRM #

PARKING STRUCTURE IS TO CONSTRUCT A 3-LEVEL PARKING ACE OF THE EXISTING PAVED PARKING LOT. RUNOFF FROM THE BE DIRECTED TO DRAINS AND PIPED TO THE PUBLIC RIGHT OF FOR THE SOUTHERN PORTION OF THE GARAGE WILL DISCHARGE AT ICE. THIS RUNOFF WILL CROSS SPRUCE AND DRAIN INTO THE OLD AS IT CURRENTLY DOES. DRAINAGE FOR THE NORTHERN ED AND CONNECT TO THE PRIVATE STORM DRAIN INLET AT THE NER OF THE SITE. RUNOFF FROM THIS AREA CURRENTLY DRAINS ON IS INTERCEPTED BY THE INLET. SURFACE RUNOFF THAT DRAINS L BE SIGNIFICANTLY REDUCED WITH THE PROPOSED PARKING THE TOTAL PEAK FLOW RATE TO THE PUBLIC STORM DRAIN AT THE ER OF SPRUCE AND CENTRAL IS ESSENTIALLY EQUAL TO THE ON. THE RV PARKING AREA LOCATED ON THE SOUTH SIDE OF CONFIGURED BUT IT WILL STILL MAINTAIN THE EXISTING DRAINAGE

INAGE MANAGEMENT PLAN FOR DELINEATION OF THE DRAINAGE ATMENTS AND RUNOFF PEAK FLOW RATES.

LUTION CONTROL - WATER QUALITY RUNOFF VOLUME:

LUME WILL BE PROVIDED WITH THESE SITE MODIFICATIONS. BE PROVIDED ONSITE BUT THE SITE IS EXTREMELY CONGESTED ABLE SPACE TO PROVIDE ONSITE STORM WATER RETENTION. FOR THE OWNER IS ELECTING TO MAKE PAYMENT IN LIEU OF ONSITE WATER QUALITY VOLUME AND FEES WILL BE BASED ON THE RM WATER RETENTION REQUIRED FOR THE REDEVELOPMENT OF HE HOSPITAL CAMPUS.


PROPOSED FOR REDEVELOPMENT CURRENTLY DISCHARGES TO FOF WAY OR PUBLIC STORM DRAIN. WITH THE REDEVELOPMENT OF STING DRAINAGE PATTERNS AND PEAK DISCHARGE FLOW RATES ANTLY CHANGE. PROVIDING ONSITE RETENTION VOLUME TO TION 22.9 OF THE DPM IS NOT TECHNICALLY FEASIBLE. THE OWNER LIEU BASED ON THE CALCULATED RETENTION VOLUME OF 3,388 PRAINAGE MANAGEMENT PLAN IS BEING SUBMITTED IN SUPPORT PPROVAL FOR BUILDING PERMIT.

ARCHITECTURE / DESIGN / INSPIRATION

DEKKER PERICH

7601 JEFFERSON NE, SUITE 100 ALBUQUERQUE, NM 87109

505.761.9700 / DPSDESIGN.ORG

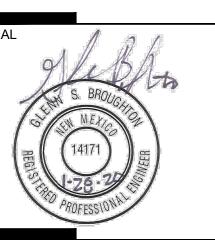

PROJECT

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PRE

BID/PERMIT DOCUMENTS

REVISIONS

DRAWN BY	ВО
REVIEWED BY	GSB
DATE	1/17/2020
PROJECT NO.	19-0010.001
DRAWING NAME	

EXISTING DRAINAGE MANAGEMENT PLAN

SHEET NO.

Bohannan A Huston www.bhinc.com

SCALE: 1"=40'

■■■■■■ DRAINAGE BASIN BOUNDARY

DEKKER
PERICH
SABATINI

ARCHITECTURE / DESIGN / INSPIRATION

7601 JEFFERSON NE, SUITE 100 ALBUQUERQUE, NM \$7109

505.761.9700 / DPSDESIGN.ORG

SEAL

S. BROUGHOUT

14171

PROFESSIONAL

SBYTERIAN HOSPITAL SE
PARKING GARAGE
1300 CENTRAL AVENUE SE

BID/PERMIT DOCUMENTS

DRAWN BY	ВС
REVIEWED BY	GSE
DATE	1/17/2020
PROJECT NO.	19-0010.00 ²
DRAWING NAME	


PROPOSED
DRAINAGE
MANAGEMENT PLAN

SHEET NO.

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Bohannan A Huston

SCALE: 1"=40'

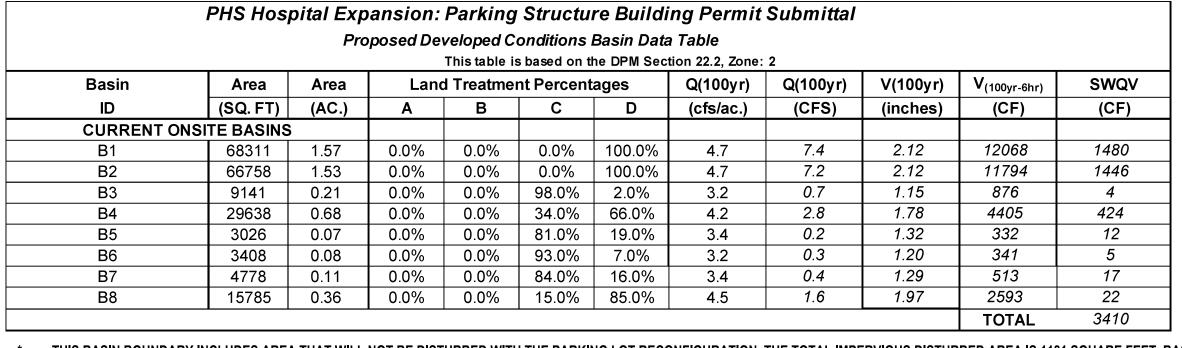


THIS BASIN BOUNDARY INCLUDES AREA THAT WILL NOT BE DISTURBED WITH THE PARKING LOT RECONFIGURATION. THE TOTAL IMPERVIOUS DISTURBED AREA IS 1181 SQUARE FEET. BASED ON THIS AREA THE CALCULATED SWQV IS 22 CUBIC FEET

	Concrete Rundown - Sidewalk Culvert									
Rundown		Rundown	Actual	Min Weir**	Proposed Weir	Weir Opening	Channel	Channel	Minimum	Capacity*
#	Basin ID	Type	Flow (Q100)	Width ft	Width ft	Height ft	Height ft	Width ft	Slope	CFS
R1	B6	Rectang	0.3	2.00	1.00	0.67	0.67	1.00	1.00%	3.33
R2	B1	Rectang	7.4	4.00	3.00	0.67	0.67	3.00	1.00%	13.75
	Weir Eq: Q=2.65L(h^1.5) - ** Capacity Based on Manning's Eq w/ N=0.01					w/ N=0.013 - *				

	INLET TABLE					
	Inlet	listed Times 2	Basin	Actual	Avail	Capacity
	#	Inlet Type ²		Flow (cfs)	Head (ft)	(cfs)
	EXIN1	EXISTING COA DOUBLE TYPE D INLET	B4	2.84	0.70	21.42
ŀ		2, (10 T 11 C O O) (D O O D E E T 11 E D 11 E E T		2.0 1	0.70	

	SIURI	I DRAIN P	IPE TABLI		
PIPE#	INLET/SD/BASIN	Size in.	Slope	Capacity*	ACTUAL FLOW cfs
SD1	B2	18	12.10%	36.54	7.20

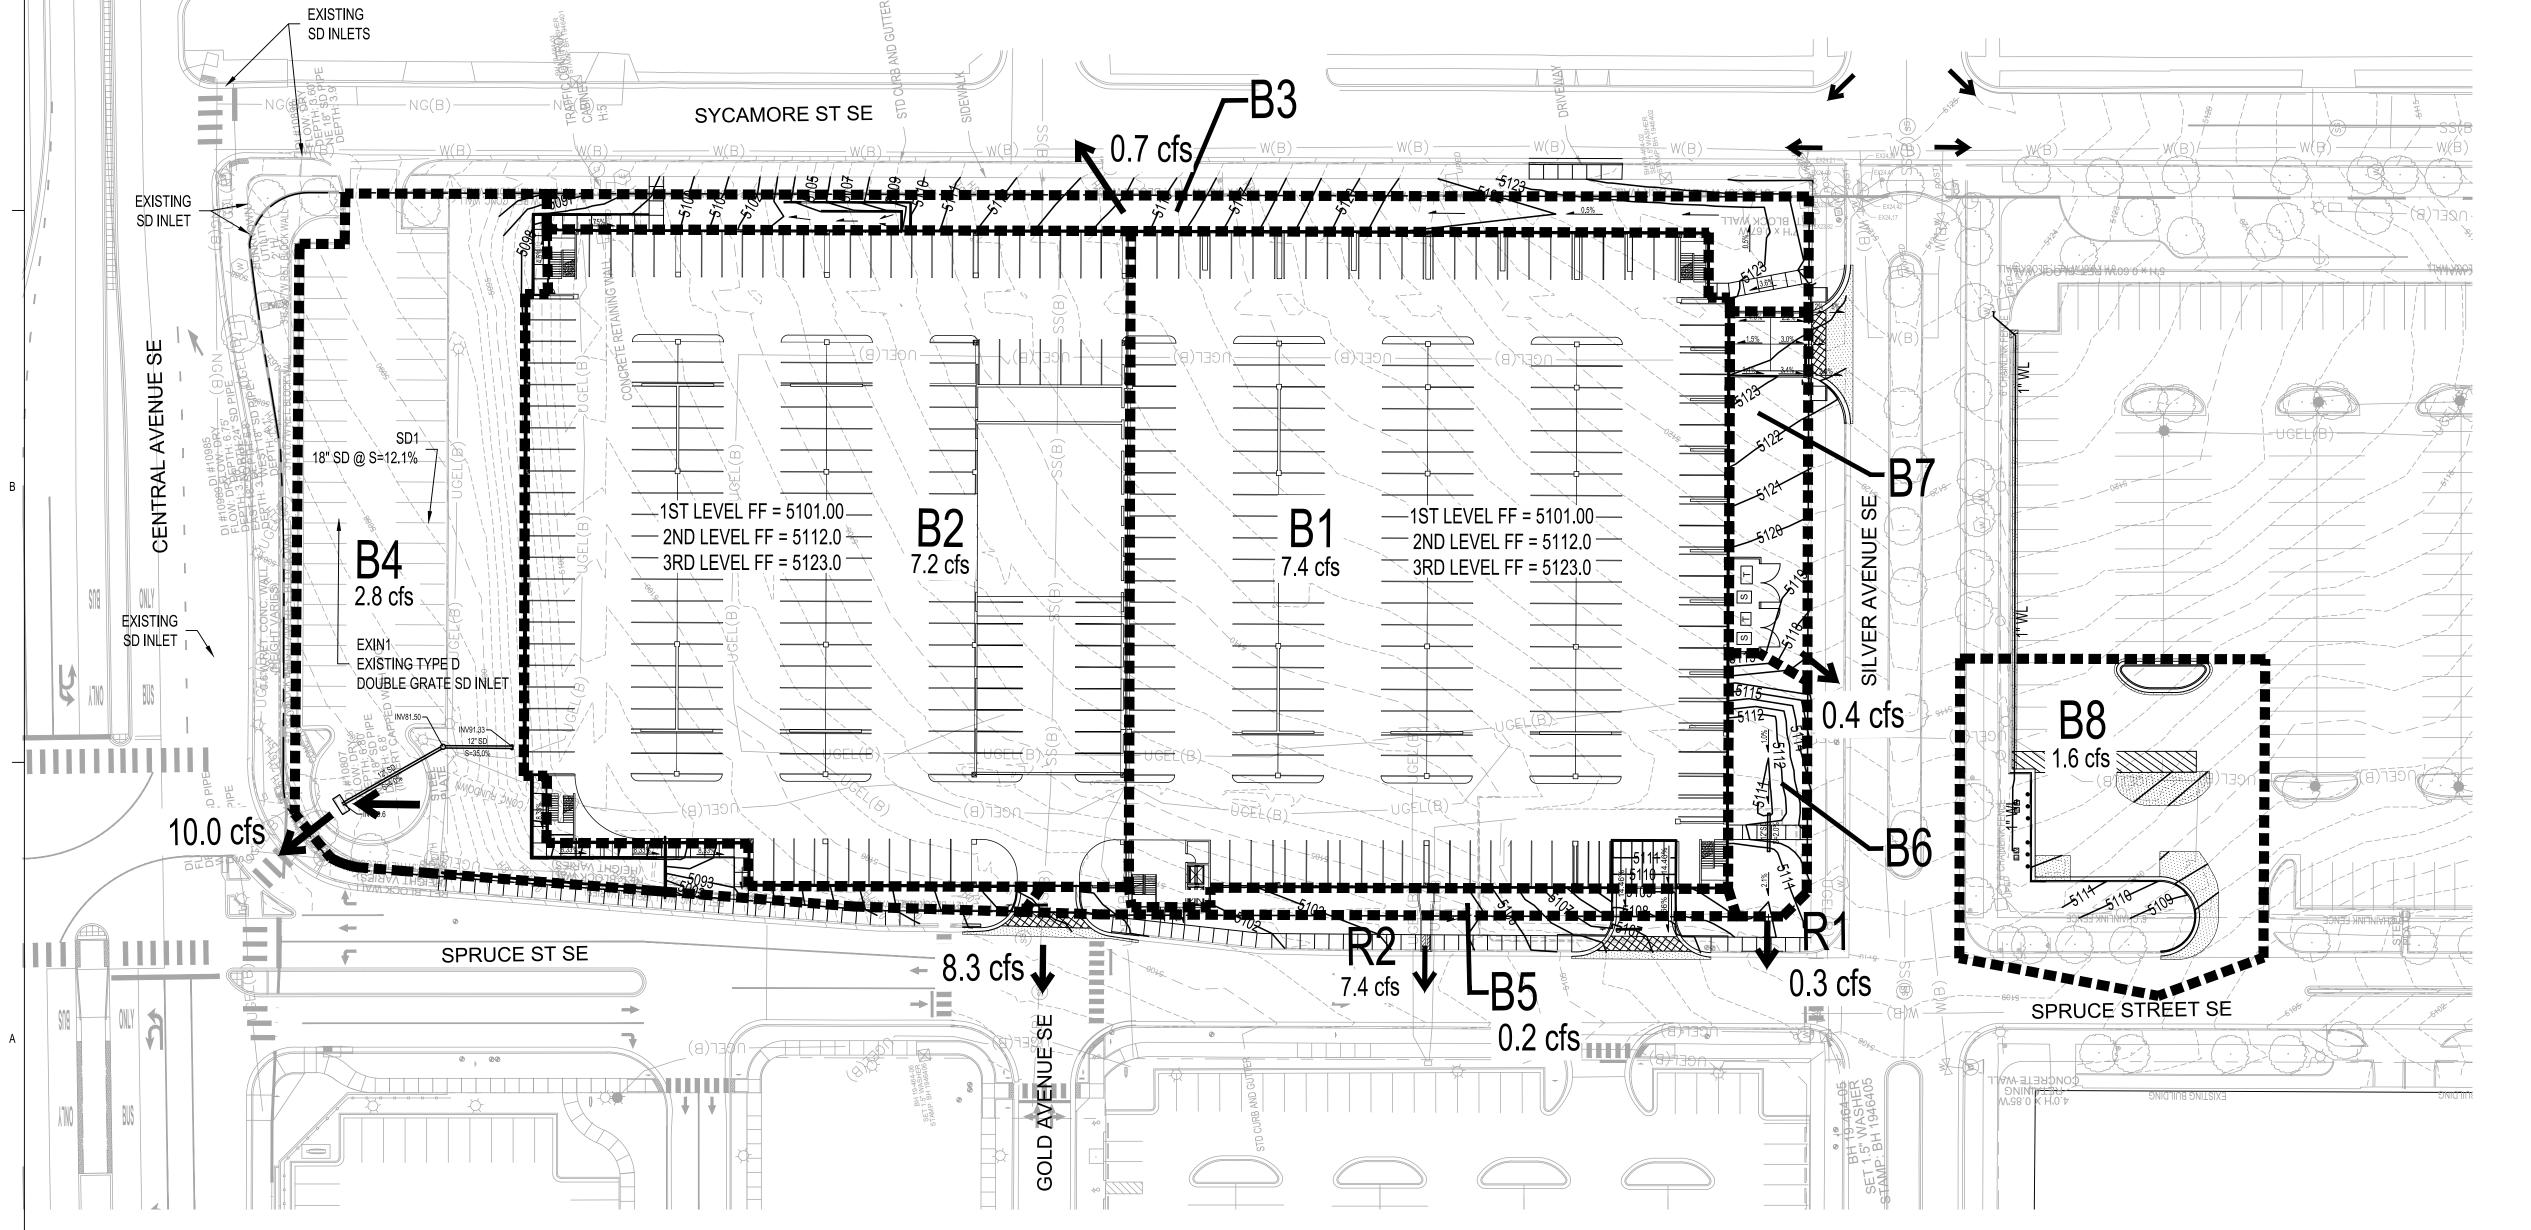

PROJECT BENCH MARK

ALBUQUERQUE GEODETIC REFERENCE STATION "5_K15BR RESET 1982" GEOGRAPHIC POSITION (NAD 1983) NM STATE PLANE COORDINATES (CENTRAL ZONE, US SURVEY FOOT) N= 1485713.773 USft E= 1523768.861 USft GROUND-TO-GRID FACTOR = 0.999679809

DELTA ALPHA = -00°13'26.78"

HHHH

—1ST LEVEL FF = 5101.00—

— 2ND LEVEL FF = 5112.0

3RD LEVEL FF = 5123.03

C-102

SYCAMORE ST STREET SE

SPRUCT STREET SE

1ST LEVEL FF = 5101.00—

— 2ND LEVEL FF = 5112.0

8.33%

The second secon

[−] 3RD LEVEL FF = 5123.0 ^{−−−}

NAVD 1988 ELEVATION= 5010.623 USft

1. ALL WORK DETAILED ON THESE PLANS AND PERFORMED UNDER THIS CONTRACT SHALL BE CONSTRUCTED IN ACCORDANCE WITH THE PROJECT SPECIFICATIONS AND THE PROJECT GEOTECHNICAL REPORT. WHERE APPLICABLE, CITY OF ALBUQUERQUE PUBLIC WORKS STANDARDS SHALL APPLY.

2. THE CONTRACTOR SHALL ABIDE BY ALL LOCAL, STATE, AND FEDERAL LAWS, RULES AND REGULATIONS WHICH APPLY TO THE CONSTRUCTION OF THESE IMPROVEMENTS, INCLUDING EPA REQUIREMENTS WITH RESPECT TO STORM WATER DISCHARGE.

3. PRIOR TO CONSTRUCTION, THE CONTRACTOR SHALL FIELD VERIFY THE HORIZONTAL AND VERTICAL LOCATIONS OF ALL POTENTIAL OBSTRUCTIONS INCLUDING ALL UNDERGROUND UTILITIES. SHOULD A CONFLICT EXIST, THE CONTRACTOR SHALL NOTIFY THE CONSTRUCTION OBSERVER OR ENGINEER SO THAT THE CONFLICT CAN BE RESOLVED WITH A MINIMUM AMOUNT OF DELAY.

4. TWO (2) WORKING DAYS PRIOR TO ANY EXCAVATION, THE CONTRACTOR SHALI CONTACT LINE LOCATING SERVICE FOR LOCATION OF EXISTING UTILITIES.

5. ALL ELECTRICAL, TELEPHONE, CABLE TV, GAS AND OTHER UTILITY LINES, CABLES, AND APPURTENANCES ENCOUNTERED DURING CONSTRUCTION THAT REQUIRE RELOCATION, SHALL BE COORDINATED WITH THAT UTILITY. THE CONTRACTOR SHALL BE RESPONSIBLE FOR COORDINATION OF ALL NECESSARY UTILITY ADJUSTMENTS. NO ADDITIONAL COMPENSATION WILL BE ALLOWED FOR DELAYS OR INCONVENIENCES CAUSED BY UTILITY COMPANY WORK CREWS. THE CONTRACTOR MAY BE REQUIRED TO RESCHEDULE HIS ACTIVITIES TO ALLOW UTILITY CREWS TO PERFORM THEIR REQUIRED WORK.

6. THE CONTRACTOR IS RESPONSIBLE FOR PROTECTING ALL EXISTING UTILITY LINES WITHIN THE CONSTRUCTION AREA. ANY DAMAGE TO EXISTING FACILITIES CAUSED BY CONSTRUCTION ACTIVITY SHALL BE REPAIRED OR REPLACED AT THE CONTRACTOR'S EXPENSE AND APPROVED BY THE CONSTRUCTION OBSERVER.

9. THE CONTRACTOR SHALL OBTAIN ALL THE NECESSARY PERMITS FOR THE

10. ALL PROPERTY CORNERS DESTROYED DURING CONSTRUCTION SHALL BE

11. THE CONTRACTOR SHALL PREPARE A CONSTRUCTION TRAFFIC CONTROL AND SIGNING PLAN AND OBTAIN APPROVAL OF SUCH PLAN FROM THE CITY OF ALBUQUERQUE, TRAFFIC ENGINEERING DEPARTMENT, PRIOR TO BEGINNING ANY CONSTRUCTION WORK ON OR ADJACENT TO EXISTING STREETS.

12. ALL BARRICADES AND CONSTRUCTION SIGNING SHALL CONFORM TO APPLICABLE SECTIONS OF THE "MANUAL ON UNIFORM TRAFFIC CONTROL DEVICES" (MUTCD), US DEPARTMENT OF TRANSPORTATION, LATEST EDITION.

13. THE CONTRACTOR SHALL MAINTAIN ALL CONSTRUCTION BARRICADES AND SIGNING AT ALL TIMES.

GRADING NOTES

1. EXCEPT AS PROVIDED HEREIN, GRADING SHALL BE PERFORMED AT THE

2. THE COST FOR REQUIRED CONSTRUCTION DUST AND EROSION CONTROL MEASURES SHALL BE INCIDENTAL TO THE PROJECT COST.

3. ALL WORK RELATIVE TO FOUNDATION CONSTRUCTION, SITE PREPARATION, AND PAVEMENT INSTALLATION, AS SHOWN ON THIS PLAN, SHALL BE CONSTRUCTED IN ACCORDANCE WITH THE "GEOTECHNICAL INVESTIGATION". ALL OTHER WORK SHALL, UNLESS OTHERWISE STATED OR PROVIDED FOR HEREON, BE CONSTRUCTED IN ACCORDANCE WITH THE PROJECT, (FIRST PRIORITY) SPECIFICATIONS, AND/OR THE CITY OF ALBUQUERQUE (COA) STANDARD SPECIFICATIONS FOR PUBLIC WORKS (SECOND PRIORITY).

SHOWN OTHERWISE.

5. IT IS THE INTENT OF THESE PLANS THAT THIS CONTRACTOR SHALL NOT PERFORM ANY WORK OUTSIDE OF THE PROPERTY BOUNDARIES EXCEPT AS REQUIRED BY THIS PLAN.

6. THE CONTRACTOR IS TO ENSURE THAT NO SOIL ERODES FROM THE SITE ONTO ADJACENT PROPERTY OR PUBLIC RIGHT-OF-WAY.

SEPARATE MEASUREMENT OR PAYMENT SHALL BE MADE.

8. PAVING AND ROADWAY GRADES SHALL BE +/- 0.1' FROM PLAN ELEVATIONS. PAD ELEVATION SHALL BE +/- 0.05' FROM BUILDING PLAN ELEVATION.



GENERAL NOTES

7. CONSTRUCTION ACTIVITY SHALL BE LIMITED TO THE PROPERTY AND/OR PROJECT LIMITS. ANY DAMAGE TO ADJACENT PROPERTIES RESULTING FROM THE CONSTRUCTION PROCESS SHALL BE REPAIRED OR REPLACED AT THE CONTRACTOR'S EXPENSE.

8. OVERNIGHT PARKING OF CONSTRUCTION EQUIPMENT SHALL NOT OBSTRUCT DRIVEWAYS OR DESIGNATED TRAFFIC LANES. THE CONTRACTOR SHALL NOT STORE ANY EQUIPMENT OR MATERIAL WITHIN THE PUBLIC RIGHT-OF-WAY.

PROJECT PRIOR TO COMMENCING CONSTRUCTION (I.E., BARRICADING, TOPSOIL DISTURBANCE, EXCAVATION PERMITS, EPA STORM WATER PERMITS, ETC.).

REPLACED AT THE CONTRACTOR'S EXPENSE. ALL PROPERTY CORNERS MUST BE RESET BY A REGISTERED LAND SURVEYOR.

14. THE CONTRACTOR SHALL TAKE ALL STEPS NECESSARY TO CONFORM WITH EPA REQUIREMENTS, INCLUDING COMPLIANCE WITH NPDES PHASE 2 REQUIREMENTS.

ELEVATIONS AND IN ACCORDANCE WITH THE DETAILS SHOWN ON THIS PLAN.

4. EARTH SLOPES SHALL NOT EXCEED 3 HORIZONTAL TO 1 VERTICAL UNLESS

7. A DISPOSAL SITE FOR ANY & ALL EXCESS EXCAVATION MATERIAL, AND UNSUITABLE MATERIAL AND/OR A BORROW SITE CONTAINING ACCEPTABLE FILL MATERIAL SHALL BE OBTAINED BY THE CONTRACTOR IN COMPLIANCE WITH APPLICABLE ENVIRONMENTAL REGULATIONS AND APPROVED BY THE OBSERVER ALL COSTS INCURRED IN OBTAINING A DISPOSAL OR BORROW SITE AND HAUL TO OR FROM SHALL BE CONSIDERED INCIDENTAL TO THE PROJECT AND NO

9. VERIFY ALL ELEVATIONS SHOWN ON PLAN FROM BASIS OF ELEVATION CONTROL STATION PRIOR TO BEGINNING CONSTRUCTION.


SCALE: 1"=40'

ARCHITECTURE / DESIGN / INSPIRATION

DEKKER PERICH SABATINI

7601 JEFFERSON NE, SUITE 100 ALBUQUERQUE, NM 87109

505.761.9700 / DPSDESIGN.ORG

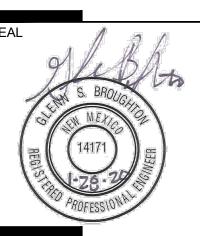

PROJECT

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BYTERIAN PARKING G S PRE

BID/PERMIT DOCUMENTS

REVISIONS	
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DRAWN BY ВО REVIEWED BY GSB DATE 1/17/2020 PROJECT NO. 19-0010.001 DRAWING NAME


OVERALL **GRADING &** DRAINAGE PLAN

SHEET NO.

C-100

C-101

AVENUE

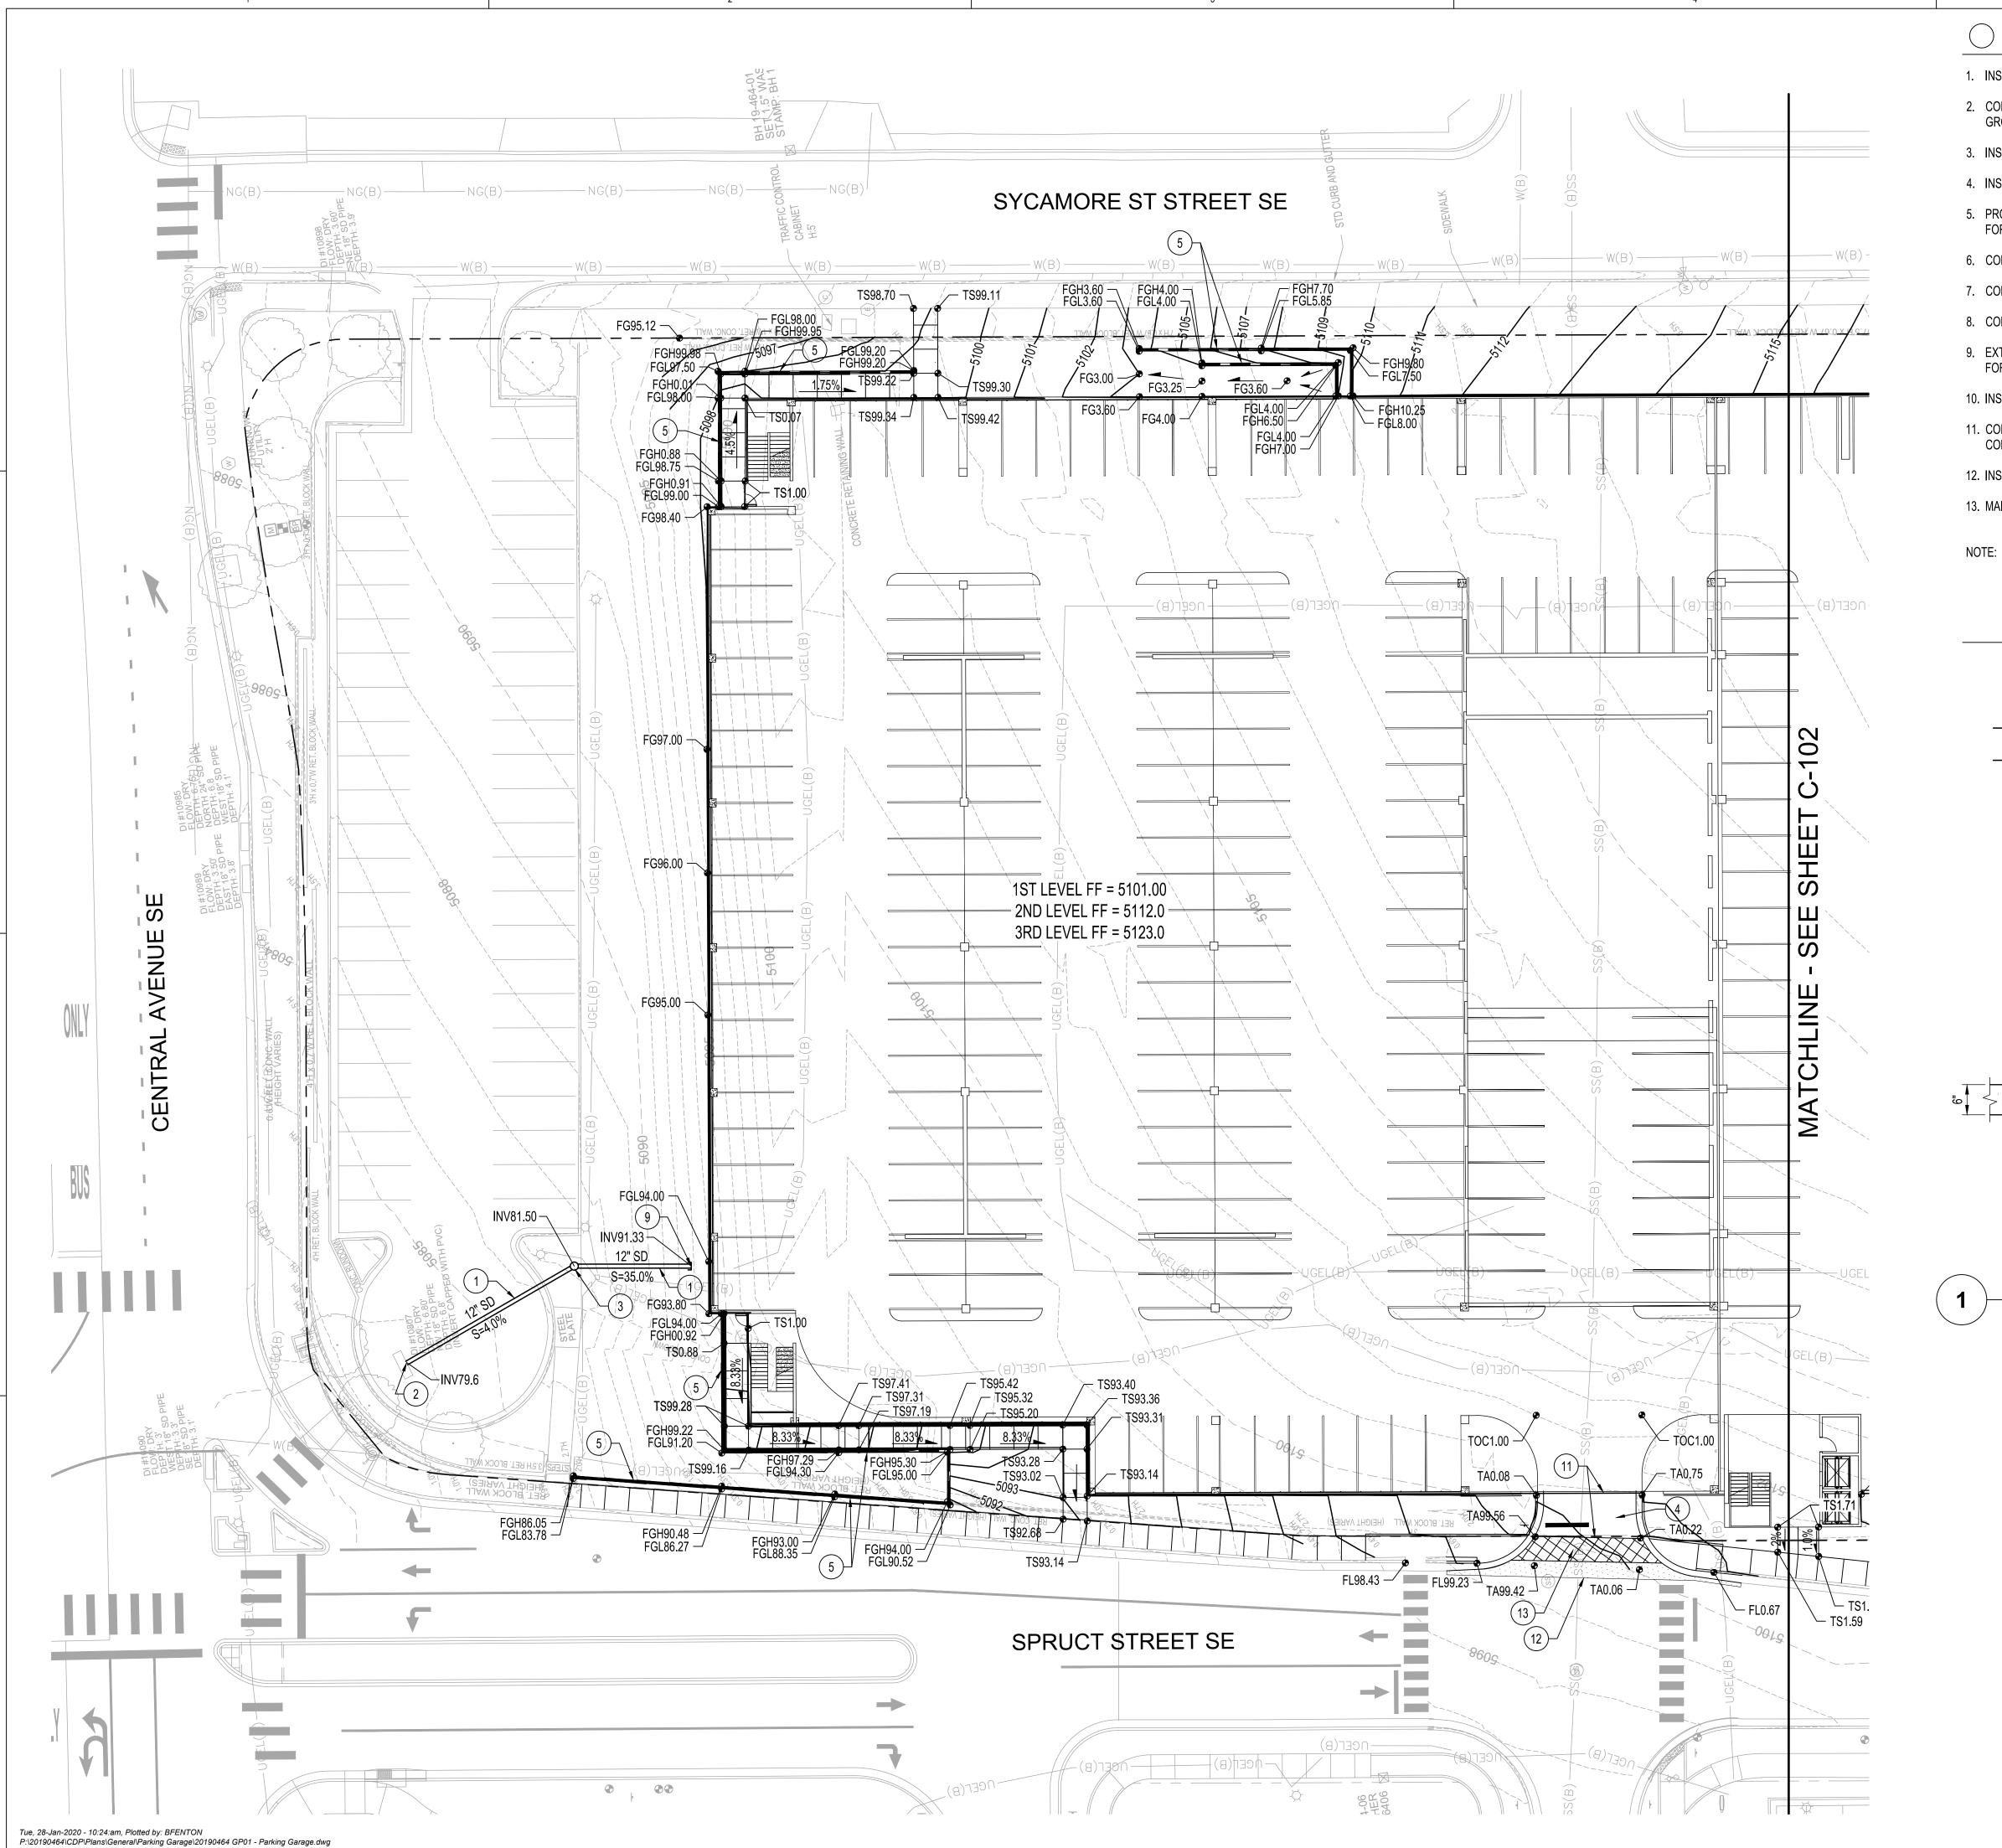


KEYED NOTES

- 1. INSTALL STORM DRAIN PIPE. SEE PLAN FOR SIZE & SLOPE.
- 2. CORE DRILL AND CONNECT TO EXISTING PRIVATE STORM DRAIN INLET. GROUT ANNULAR SPACE.
- 3. INSTALL 24" NYLOPLAST DRAIN BASIN WITH SOLID COVER.
- 4. INSTALL CONCRETE PAVEMENT SECTION PER 2/C-102.
- 5. PROPOSED RETAINING WALL. SEE ARCHITECTURAL / STRUCTURAL PLANS FOR DETAILS.
- 6. CONSTRUCT CONCRETE RIBBON CHANNEL. SEE DETAIL THIS SHEET.
- 7. CONSTRUCT 12" WIDE SIDEWALK CULVERT PER COA STD DWG 2236.
- 8. CONSTRUCT 2 18" WIDE SIDEWALK CULVERTS PER COA STD DWG 2236.
- 9. EXTEND STORM DRAIN TO WITHIN 5' OF BUILDING. SEE PLUMBING PLANS FOR CONTINUATION.
- 10. INSTALL CONCRETE CONTROL JOINTS.
- 11. CONSTRUCT THICKENED EDGE ADJACENT TO PARKING STRUCTURE AND CONCRETE CROSSWALK STREET PER 1/C-101.
- 12. INSTALL ASPHALT PAVEMENT PER 1/C-103.
- 13. MAINTAIN 2% MAXIMUM CROSS SLOPE AT ACCESSIBLE COSSWALK.

NOTE: NOT ALL KEYED NOTES MAY APPLY TO THIS SHEET.


GRADING LEGEND

_	DIRECTION OF FLOW
9 23.00	PROPOSED SPOT ELEVATION
5095	PROPOSED INDEX CONTOUR
 5094 	PROPOSED INTERMEDIATE CONTOUR

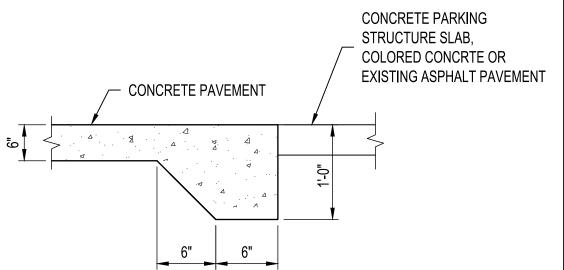



NTS

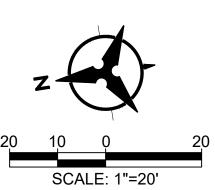




ARCHITECTURE / DESIGN / INSPIRATION

DEKKER
PERICH
SABATINI

7601 JEFFERSON NE, SUITE 100 ALBUQUERQUE, NM 87109

505.761.9700 / DPSDESIGN.ORG

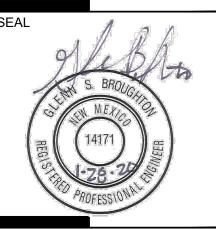

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PRESBYTERIAN HOSPITAL S
PARKING GARAGE
1300 CENTRAL AVENUE SE


BID/PERMIT DOCUMENTS

DRAWN BY	В
REVIEWED BY	GS
DATE	1/17/202
PROJECT NO.	19-0010.00
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GRADING &

GRADING & DRAINAGE PLAN

SHEET NO.

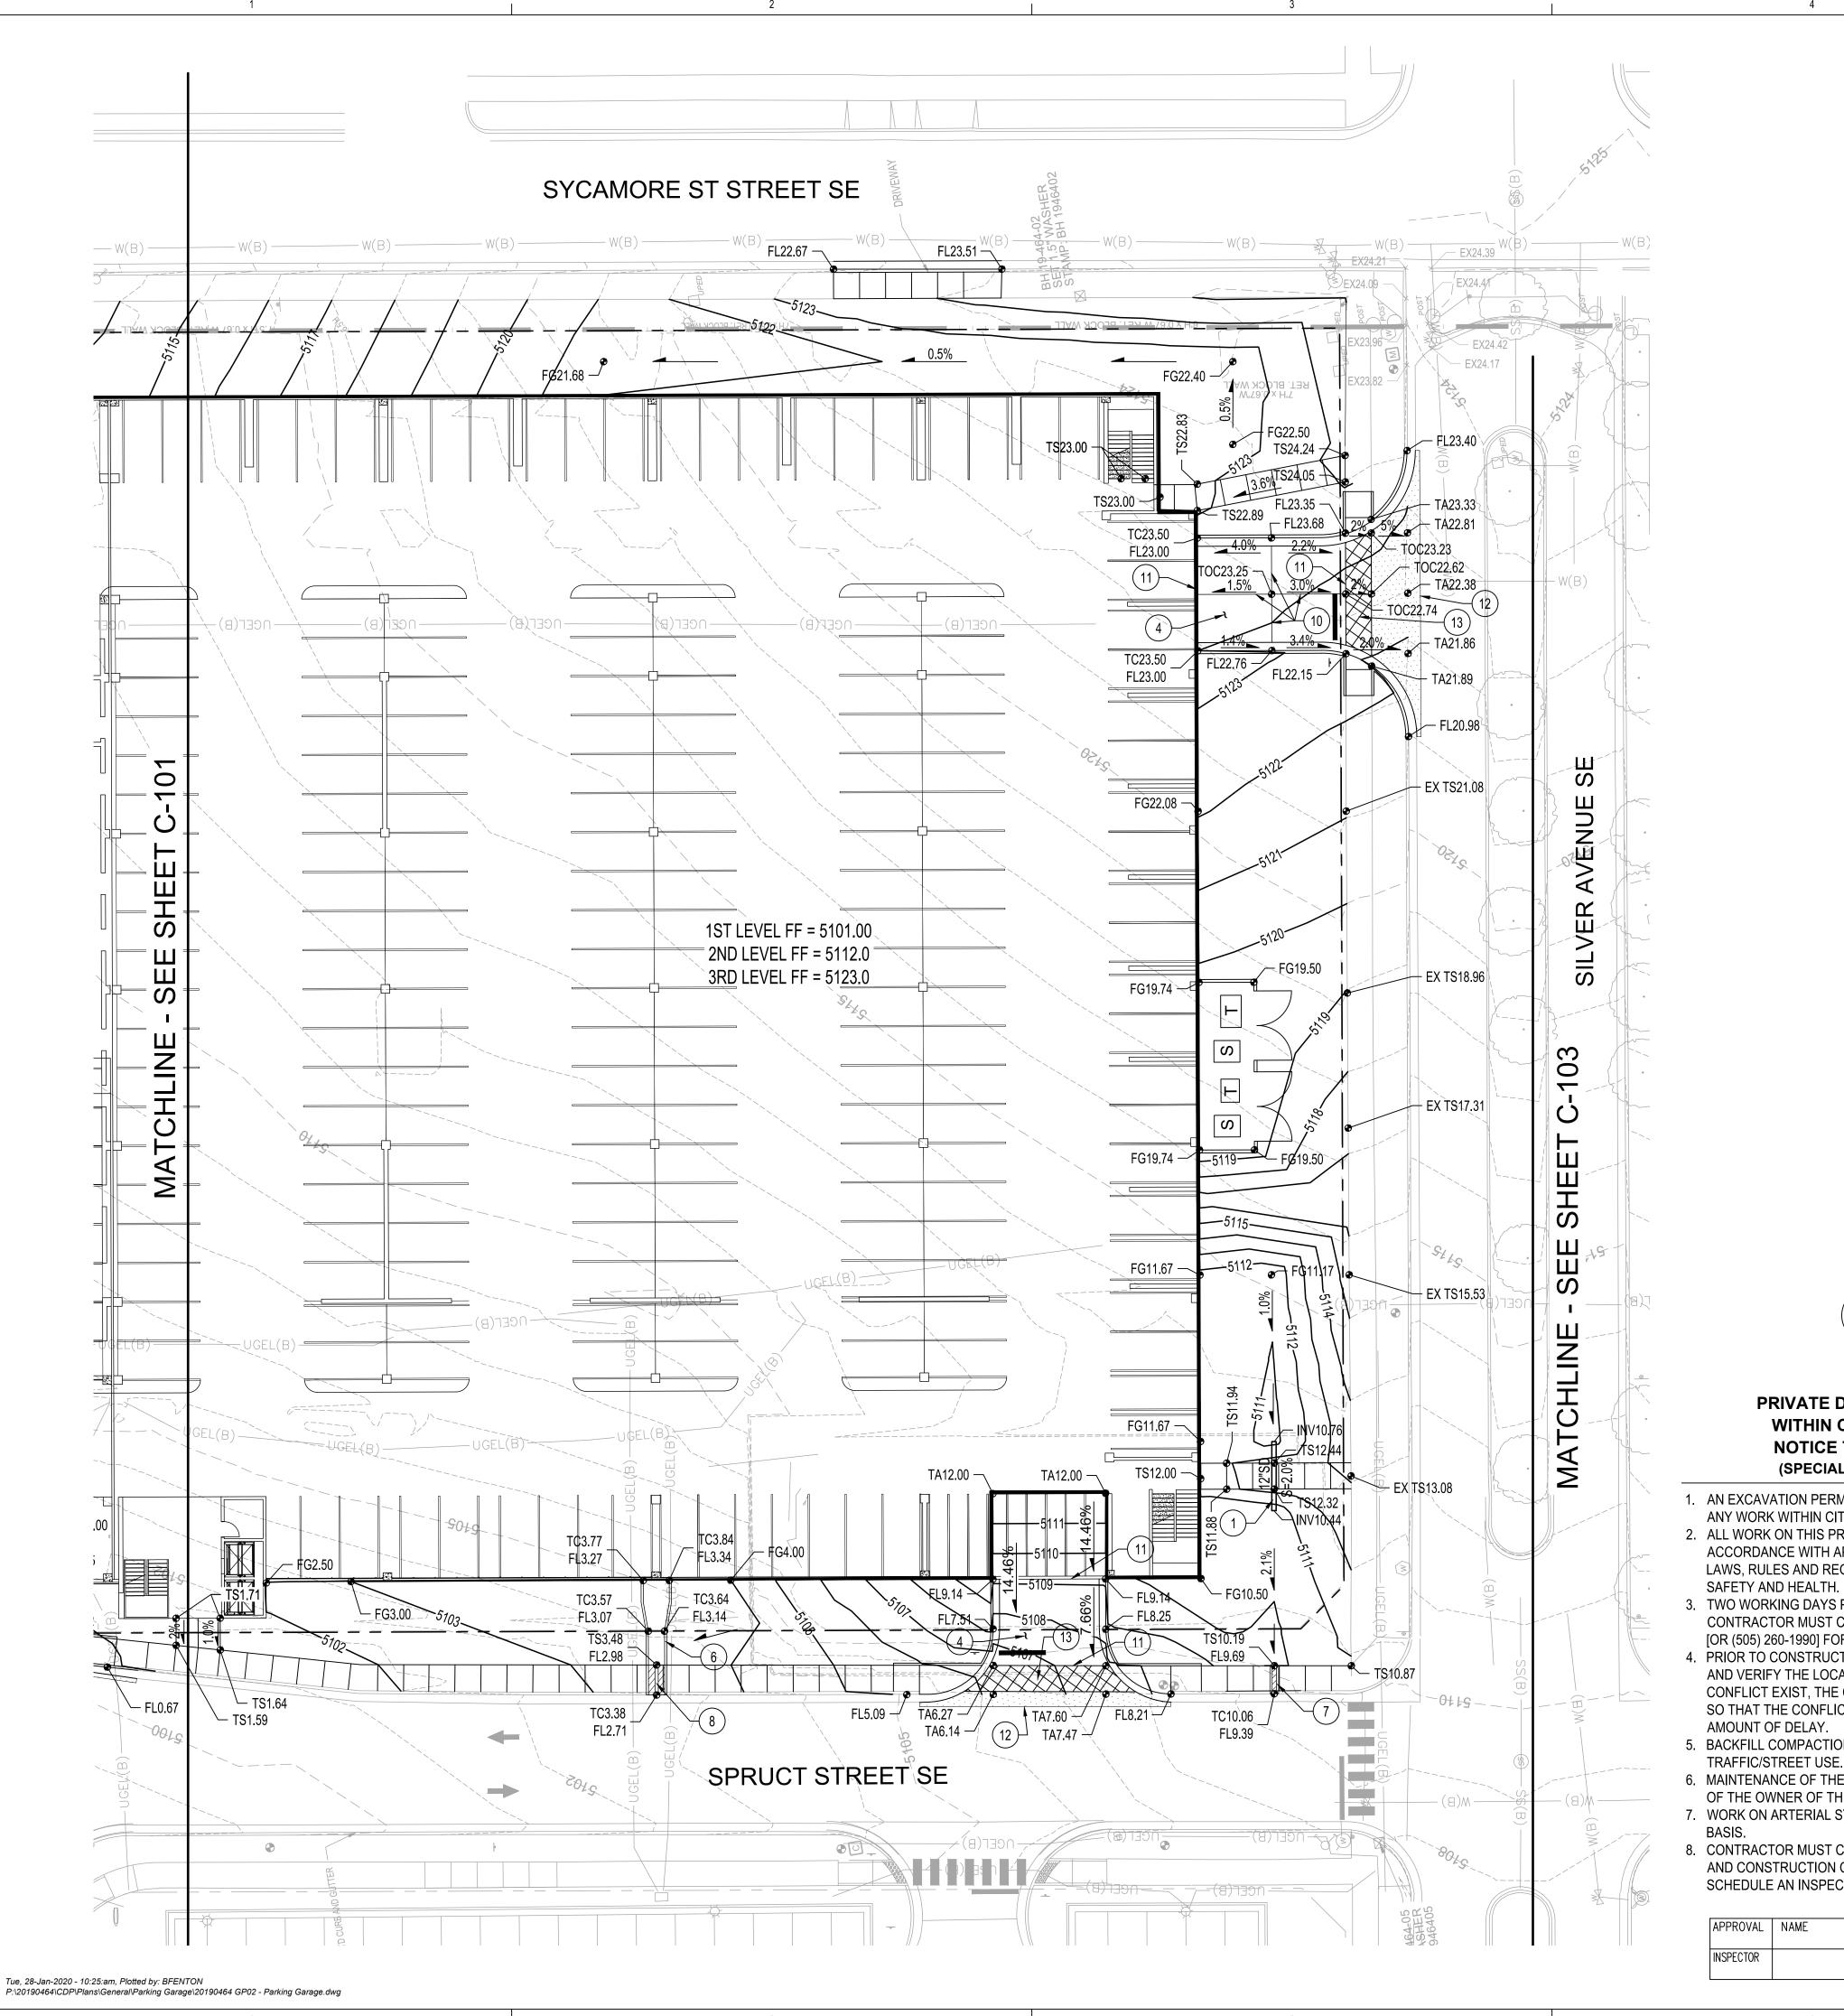


KEYED NOTES


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- 4. INSTALL CONCRETE PAVEMENT SECTION PER 2/C-102.
- 5. PROPOSED RETAINING WALL. SEE ARCHITECTURAL / STRUCTURAL PLANS FOR DETAILS.
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- 12. INSTALL ASPHALT PAVEMENT PER 1/C-103.
- 13. MAINTAIN 2% MAXIMUM CROSS SLOPE AT ACCESSIBLE COSSWALK.

NOTE: NOT ALL KEYED NOTES MAY APPLY TO THIS SHEET.

GRADING LEGEND

	DIRECTION OF FLOW
2 3.00	PROPOSED SPOT ELEVATION
5095	PROPOSED INDEX CONTOUR
 5094 	PROPOSED INTERMEDIATE CONTOUR

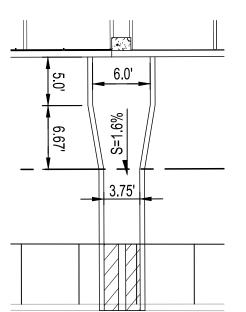

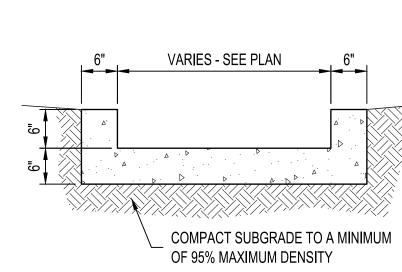

PLAN

SECTION




CONCRETE RIBBON CHANNEL

PRIVATE DRAINAGE FACILITIES WITHIN CITY RIGHT-OF-WAY NOTICE TO CONTROACTOR (SPECIAL ORDER 19 ~ "SO-19")


- 1. AN EXCAVATION PERMIT WILL BE REQUIRED BEFORE BEGINNING ANY WORK WITHIN CITY RIGHT-OF-WAY.
- 2. ALL WORK ON THIS PROJECT SHALL BE PERFORMED IN ACCORDANCE WITH APPLICABLE FEDERAL, STATE AND LOCAL LAWS, RULES AND REGULATIONS CONCERNING CONSTRUCTION
- B. TWO WORKING DAYS PRIOR TO ANY EXCAVATION, THE CONTRACTOR MUST CONTACT NEW MEXICO ONE CALL, DIAL "811" [OR (505) 260-1990] FOR THE LOCATION OF EXISTING UTILITIES.
- 4. PRIOR TO CONSTRUCTION, THE CONTRACTOR SHALL EXCAVATE AND VERIFY THE LOCATIONS OF ALL OBSTRUCTIONS. SHOULD A CONFLICT EXIST, THE CONTRACTOR SHALL NOTIFY THE ENGINEER SO THAT THE CONFLICT CAN BE RESOLVED WITH A MINIMUM
- 5. BACKFILL COMPACTION SHALL BE ACCORDING TO
- TRAFFIC/STREET USE.
- 6. MAINTENANCE OF THE FACILITY SHALL BE THE RESPONSIBILITY OF THE OWNER OF THE PROPERTY BEING SERVED.
- 7. WORK ON ARTERIAL STREETS MAY BE REQUIRED ON A 24-HOUR
- B. CONTRACTOR MUST CONTACT AUGIE ARMIJO AT (505) 857-8607 AND CONSTRUCTION COORDINATION AT (505) 924-3416 TO SCHEDULE AN INSPECTION.

APPROVAL	NAME	DATE
INSPECTOR		

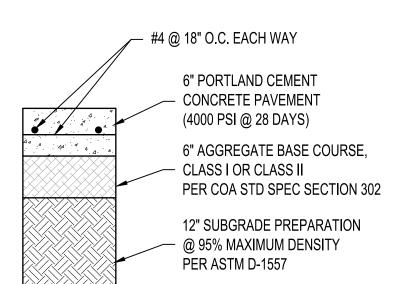

NTS



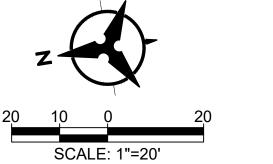


Bohannan A Huston

ARCHITECTURE / DESIGN / INSPIRATION

PERICH SABATINI

7601 JEFFERSON NE, SUITE 100 ALBUQUERQUE, NM 87109

505.761.9700 / DPSDESIGN.ORG

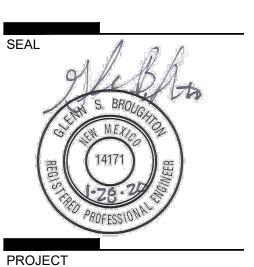

PRE

BID/PERMIT DOCUMENTS


REVISIONS

DRAWN BY ВО **REVIEWED BY** GSB DATE 1/17/2020 PROJECT NO. 19-0010.001 DRAWING NAME

GRADING &

DRAINAGE PLAN


SHEET NO.

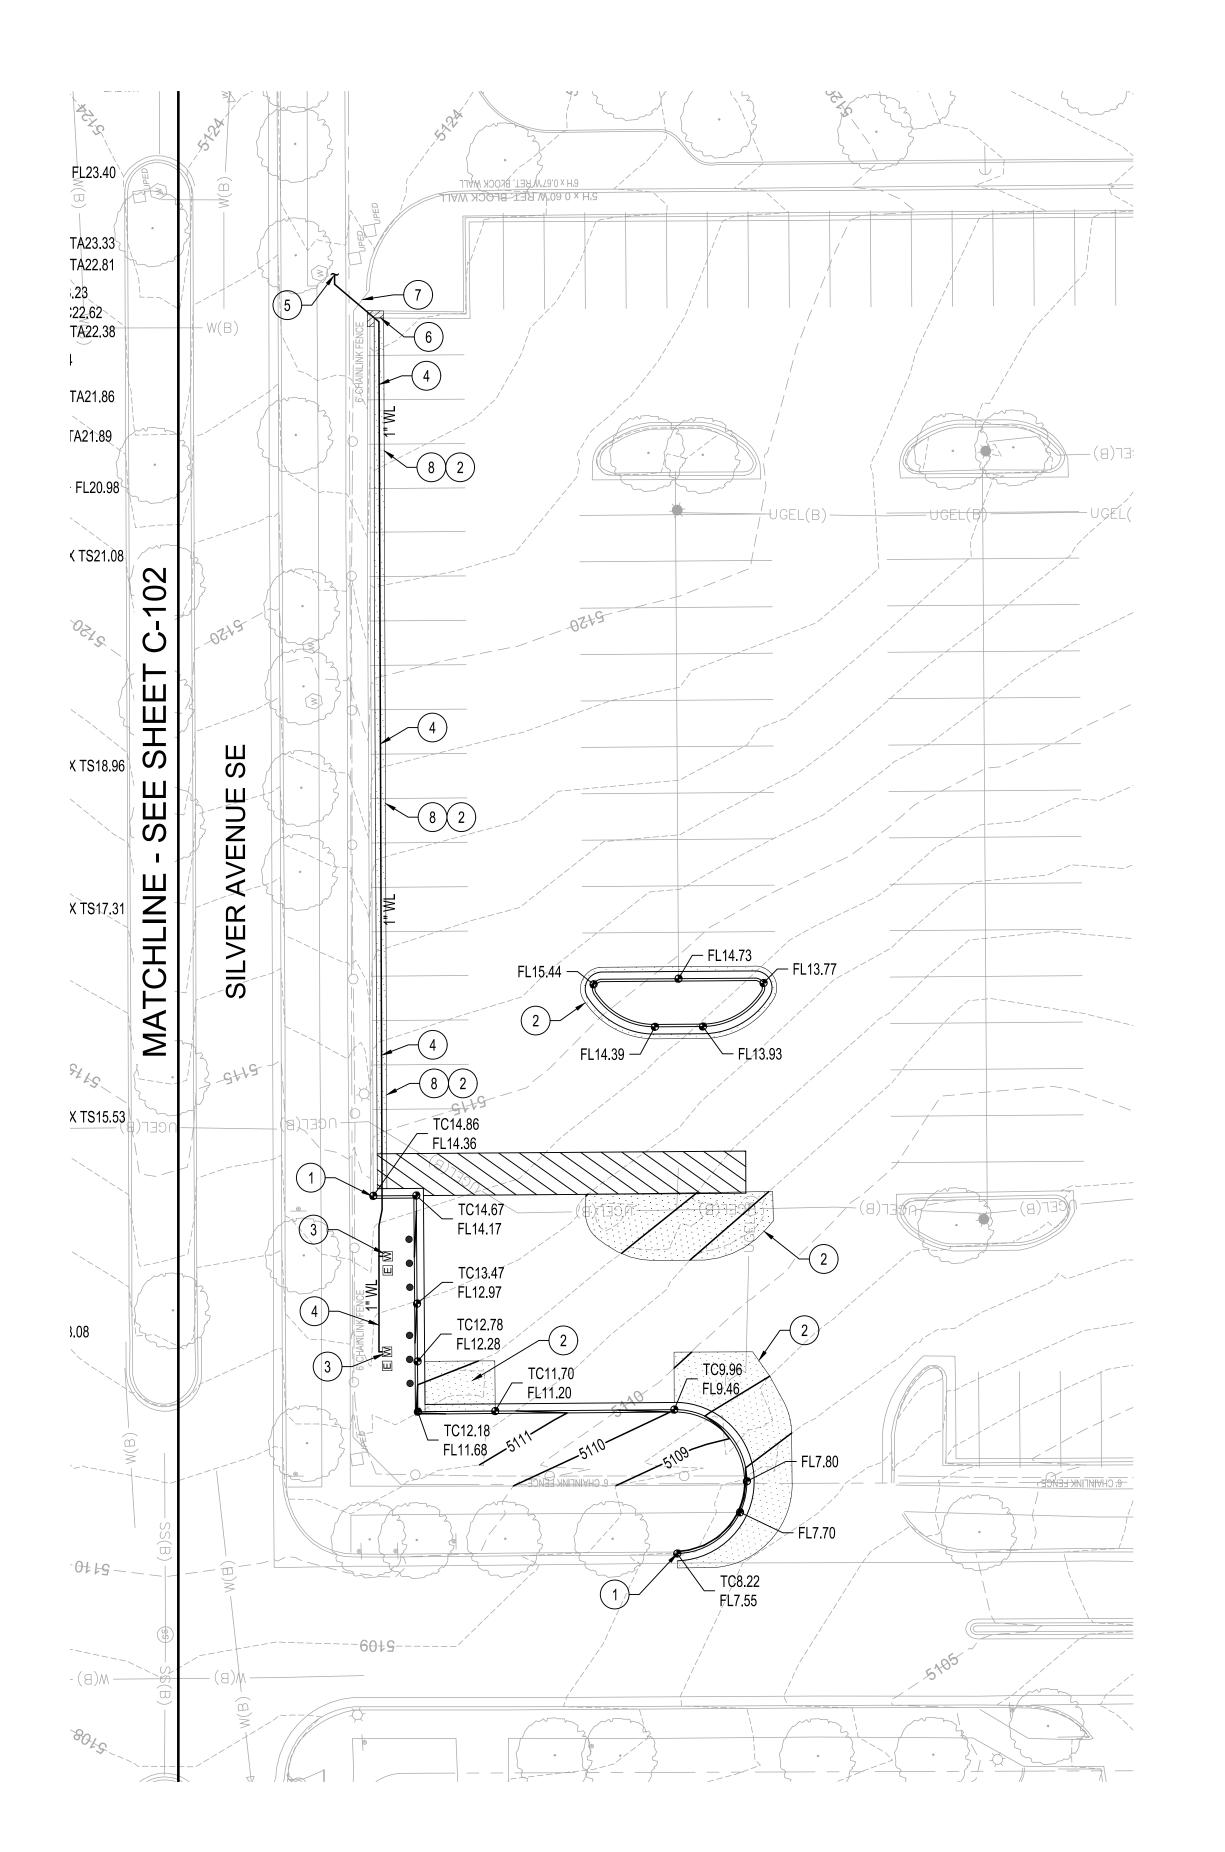

KEYED NOTES

- 1. MATCH EXISTING CURB AND GUTTER HORIZONTALLY AND VERTICALLY.
- 2. INSTALL NEW ASPHALT PAVEMENT PER DETAIL THIS SHEET.
- 3. INSTALL 1" FROST FREE YARD HYDRANT WITH AUTO DRIP BALL, ZURN MODEL 21396 OR APPROVED EQUAL.
- 4. INSTALL 1" WATER SERVICE LINE.
- 5. CONNECT TO EXISTING WATER SERVICE LINE BETWEEN EXISTING WATER METER & EXISTING BACKFLOW PREVENTOR.
- 6. REMOVE & REPLACE EXISTING CONCRETE CURB & GUTTER AS NEEDED FOR UTILITY TRENCH.
- 7. REMOVE & REPLACE EXISTING CHAIN LINK FENCE AS NEEDED FOR UTILITY TRENCH.
- 8. SAW-CUT, REMOVE & REPLACE EXISTING ASPHALT PAVEMENT FOR UTILITY TRENCH. EXISTING CONCRETE CURB & GUTTER TO REMAIN.


GRADING LEGEND

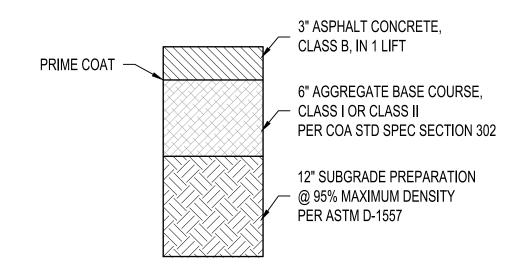



ASPHALT PAVEMENT SECTION

NTS

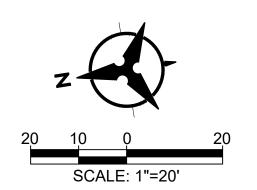




ARCHITECTURE / DESIGN / INSPIRATION

DEKKER
PERICH
SABATINI

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PRESBYTERIAN HOSPITAL S
PARKING GARAGE
1300 CENTRAL AVENUE SE
ALBIQUEROUE NIM 87106

BID/PERMIT DOCUMENTS

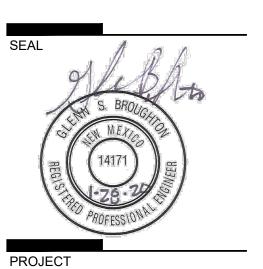DRAWN BY	ВС
REVIEWED BY	GSE
DATE	1/17/202
PROJECT NO.	19-0010.00

DRAWING NAME

GRADING & DRAINAGE PLAN

SHEET NO.

C-103

Tue, 28-Jan-2020 - 10:26:am, Plotted by: BFENTON P:\20190464\CDP\Plans\General\Parking Garage\20190464 GP03 - Parking Garage.dwg