



architecture interior: planning engineering

Dekker Perich Sabatin

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ARCHITECT



DO FOT

Presbyterian Hospital Parking Garage Albuquerque, NM EPC Submittal

DRAWN BY CP
REVIEWED BY GB


DATE 9/3/2007
PROJECT NO. 01045.035
DRAWING NAME


DRAWING N

GRADING & DRAINAGE PLAN

SHEET NO.

SKC-002

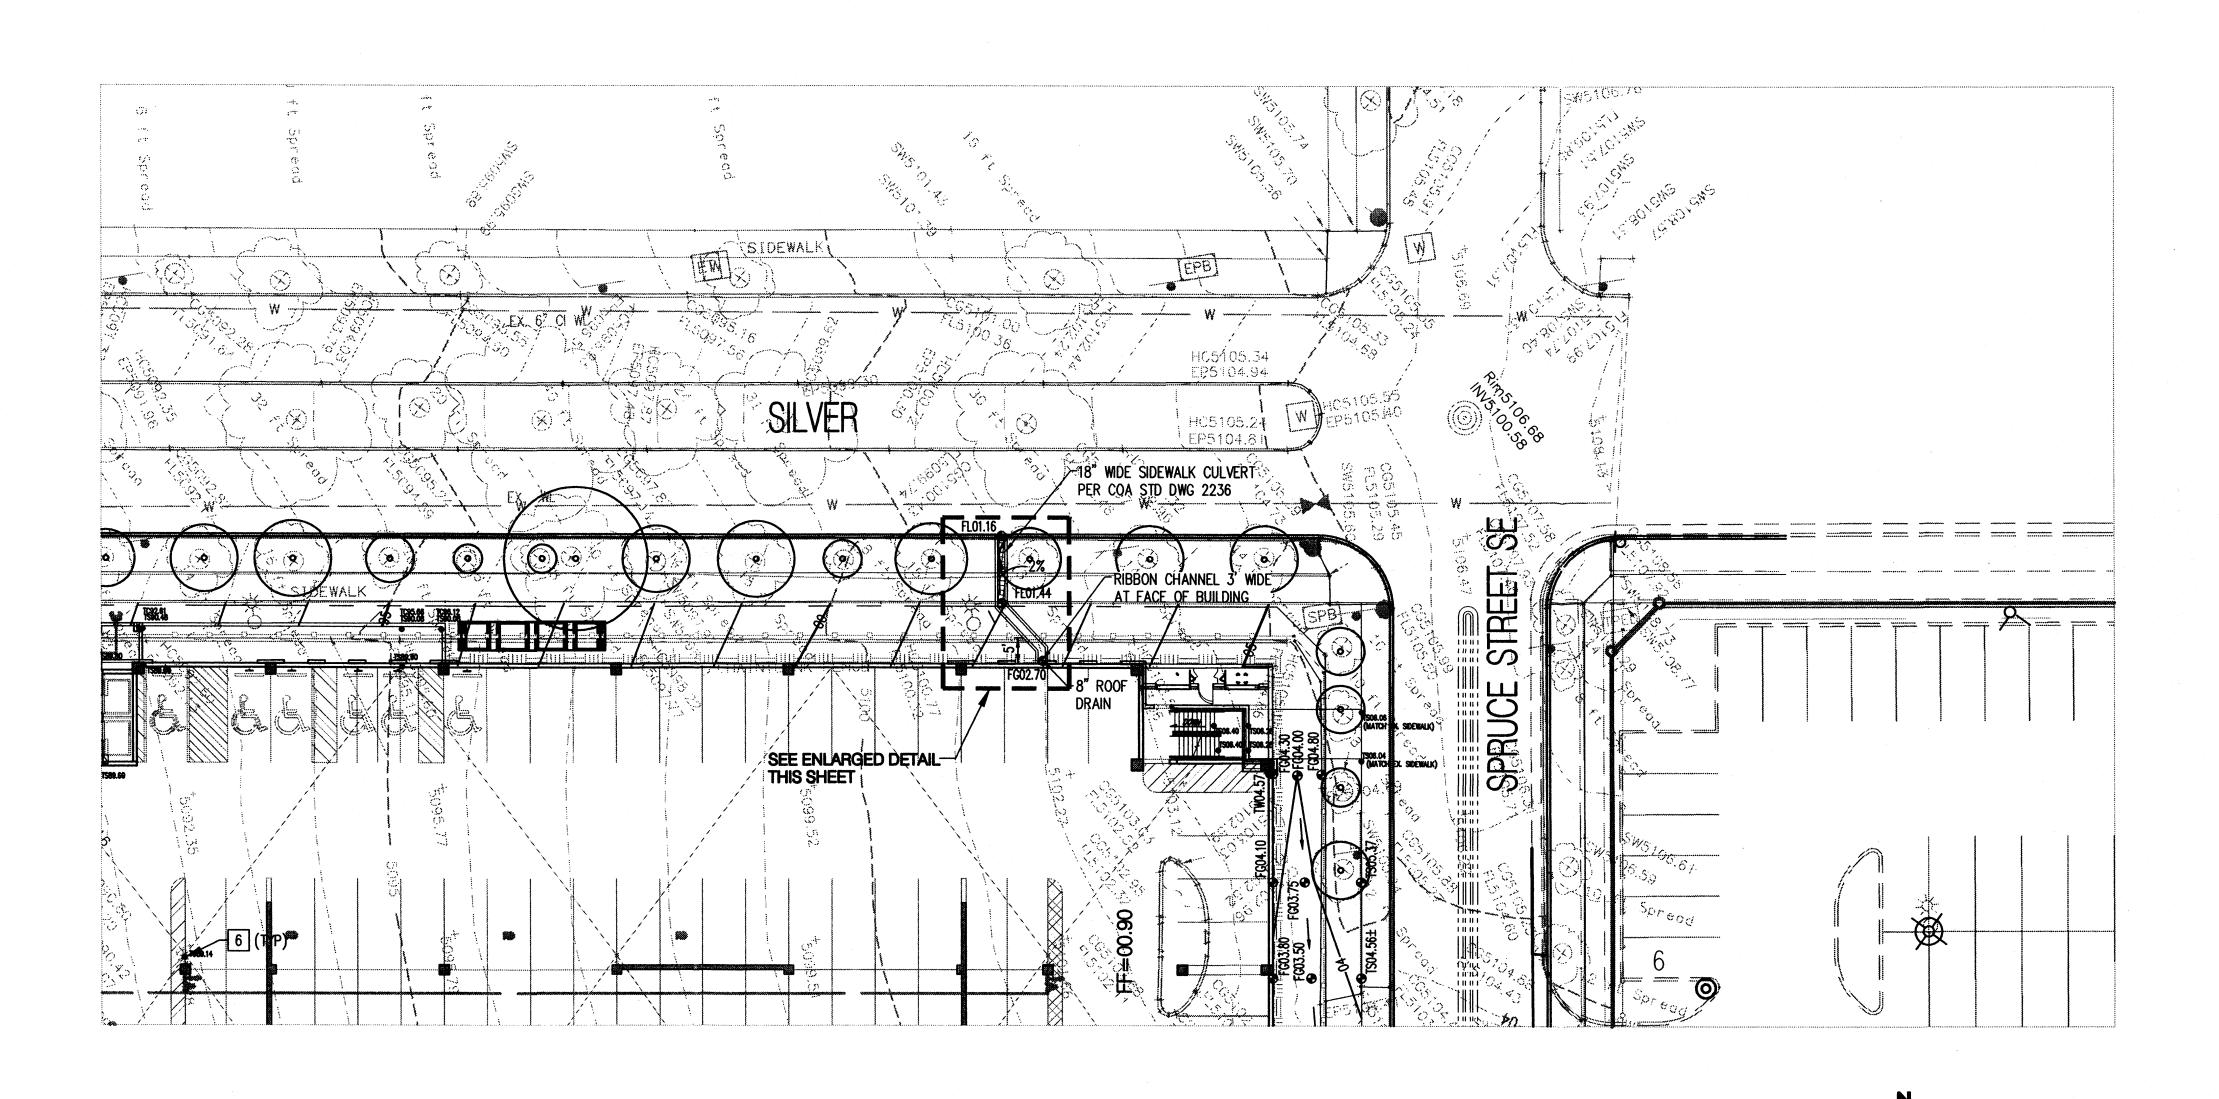

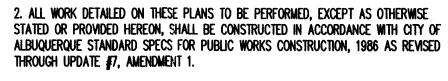

NOTICE TO CONTRACTORS (SO 19)

3. TWO WORKING DAYS PRIOR TO ANY EXCAVATION, CONTRACTOR MUST CONTACT NEW MEXICO ONE CALL AT 260–1990, FOR LOCATION OF EXISTING UTILITIES.

1. AN EXCAVATION/CONSTRUCTION PERMIT WILL BE REQUIRED BEFORE BEGINNING ANY WORK WITHIN THE CITY RIGHT-OF-WAY. AN APPROVED COPY OF THESE PLANS MUST BE SUBMITTED AT THE TIME OF APPLICATION FOR THIS PERMIT.

4. PRIOR TO CONSTRUCTION, THE CONTRACTOR SHALL EXCAVATE AND VERIFY THE HORIZONTAL AND VERTICAL LOCATIONS OF ALL OBSTRUCTIONS. SHOULD A CONFLICT EXIST, THE CONTRACTOR SHALL NOTIFY THE ENGINEER SO THAT THE CONFLICT CAN BE RESOLVED WITH A MINIMUM AMOUNT OF DELAY.

5. BACKFILL COMPACTION SHALL BE TO ARTERIAL STREET USE.

6. MAINTENANCE OF THESE FACILITIES SHALL BE THE RESPONSIBILITY OF THE OWNER OF THE PROPERTY SERVED.

7. WORK ON ARTERIAL STREETS SHALL BE PERFORMED ON A 24-HOUR BASIS.

PRIVATE DRAINAGE FACILITIES WITHIN CITY RIGHT-OF-WAY

DESIGN APPROVAL:

HYDROLOGY SECTION DATE

INSPECTION APPROVAL:

TRANS/STREET MAINT. DATE

ACCEPTANCE:

SCALE: 1"=20'

CONSTRUCTION MGT. DIV. DATE

CE CE TY E DE SEP N 6 2007

HYUHULUGY DEUTION

REF SHEET C-101
GRADING REVISION

DATE ISSUED 9/5/07
PROJECT NO. 01045.035

Courtyard I 7500 Jefferson St. NE Albuquerque, NM 87109-4335
ENGINEERING * SPATIAL DATA * ADVANCED TECHNOLOGIES

SCALE: 1"=10"

5. INSTALL 4' WIDE PUBLIC SIDEWALK PER COA STD. DETAIL 2430.

6. AREA DRAIN, SEE PLUMBING PLANS FOR DRAIN & PIPING DETAILS.

MATCH EXISTING SIDEWALK.

GRADING NOTES

1. EXCEPT AS PROVIDED HEREIN, GRADING SHALL BE PERFORMED AT THE ELEVATIONS AND IN ACCORDANCE WITH THE DETAILS SHOWN ON THIS PLAN.

2. THE COST FOR REQUIRED CONSTRUCTION DUST AND EROSION CONTROL MEASURES SHALL BE INCIDENTAL TO THE PROJECT COST.

3. ALL WORK RELATIVE TO FOUNDATION CONSTRUCTION, SITE PREPARATION, AND PAVEMENT INSTALLATION, AS SHOWN ON THIS PLAN, SHALL BE CONSTRUCTED IN ACCORDANCE WITH THE "GEOTECHNICAL INVESTIGATION," AS PROVIDED BY THE ARCHITECT OR OWNER. ALL OTHER WORK SHALL, UNLESS OTHERWISE STATED OR PROVIDED FOR HEREON, BE CONSTRUCTED IN ACCORDANCE WITH THE PROJECT, (FIRST PRIORITY) SPECIFICATIONS, AND/OR THE CITY OF ALBUQUERQUE (COA) STANDARD SPECIFICATIONS FOR PUBLIC WORKS (SECOND PRIORITY).

4. EARTH SLOPES SHALL NOT EXCEED 3 HORIZONTAL TO 1 VERTICAL UNLESS SHOWN OTHERWISE.

5. IT IS THE INTENT OF THESE PLANS THAT THIS CONTRACTOR SHALL NOT PERFORM ANY WORK OUTSIDE OF THE PROPERTY BOUNDARIES EXCEPT AS REQUIRED BY THIS PLAN.

6. THE CONTRACTOR IS TO ENSURE THAT NO SOIL ERODES FROM THE SITE ONTO ADJACENT PROPERTY OR PUBLIC RIGHT-OF-WAY. THIS SHOULD BE ACHIEVED BY CONSTRUCTING TEMPORARY BERMS OR SILT FENCE AT THE PROPERTY LINES AND WETTING THE SOIL TO PROTECT IT FROM WIND EROSION.

7. A DISPOSAL SITE FOR ANY & ALL EXCESS EXCAVATION MATERIAL, AND UNSUITABLE MATERIAL AND/OR A BORROW SITE CONTAINING ACCEPTABLE FILL MATERIAL SHALL BE OBTAINED BY THE CONTRACTOR IN COMPLIANCE WITH APPLICABLE ENVIRONMENTAL REGULATIONS AND APPROVED BY THE OBSERVER. ALL COSTS INCURRED IN OBTAINING A DISPOSAL OR BORROW SITE AND HAUL TO OR FROM SHALL BE CONSIDERED INCIDENTAL TO THE PROJECT AND NO SEPARATE MEASUREMENT OR PAYMENT SHALL BE MADE.

8. PAVING AND ROADWAY GRADES SHALL BE +/- 0.1' FROM PLAN ELEVATIONS. PAD ELEVATION SHALL BE +/- 0.05' FROM BUILDING PLAN ELEVATION.

9. ALL PROPOSED CONTOURS REFLECT TOP OF PAVEMENT ELEVATIONS IN THE PARKING AREA AND MUST BE ADJUSTED FOR MEDIANS AND ISLANDS.

10. VERIFY ALL ELEVATIONS SHOWN ON PLAN FROM BASIS OF ELEVATION CONTROL STATION PRIOR TO BEGINNING CONSTRUCTION.

UTILITY NOTES

1. THIS CONTRACTOR SHALL BE RESPONSIBLE FOR THE COMPLETE INSTALLATION OF ALL WORK RELATED TO MECHANICAL UTILITIES AS SHOWN ON THIS PLAN INCLUDING: TRENCHING, BACKFILL, SUPPORTS, CLEANOUT PADS, SERVICE STOPS AND BOXES, SERVICE LINES, TESTING, CLEANING, AND STERILIZING. ANY WORK NOT ACCEPTED BY THE ARCHITECT OR ENGINEER DUE TO IMPROPER WORKMANSHIP OR LACK OF PROPER COORDINATION SHALL BE REMOVED AND CORRECTLY INSTALLED AT THE CONTRACTOR'S EXPENSE, AS DIRECTED.

2. UTILITY LINES SHALL BE INSTALLED PRIOR TO PAVEMENT, CURB AND GUTTER, AND/OR SIDEWALK, AS APPLICABLE.

3. ROUGH GRADING OF SITE (±0.5') SHALL BE COMPLETED PRIOR TO INSTALLATION OF UTILITY LINES.

4. CONTRACTOR WILL BE RESPONSIBLE FOR CONNECTIONS TO BUILDING DRAIN LINES AND ALL NECESSARY FITTINGS.

5. ALL VALVES SHALL BE ANCHORED PER COA STANDARD DWG. 2333.

6. FIRE LINES SHALL USE PIPE MATERIALS UNDERWRITERS LABORATORIES LISTED AND APPROVED FOR FIRE SERVICE.

7. CONTRACTOR SHALL BE RESPONSIBLE FOR ALL WATER METER, FIRE LINE, AND SEWER HOOKUP FEES FOR INSTALLATIONS. OWNER SHALL BE RESPONSIBLE FOR UTILITY EXPANSION CHARGES, PRORATA AND OTHER SPECIAL ASSESSMENTS.

8. CONTRACTOR SHALL VERIFY INVERTS AND LOCATIONS OF EXISTING WATER/SAS LINES PRIOR TO BEGINNING WORK. ALL CONFLICTS SHALL BE BROUGHT TO ATTENTION OF THE ENGINEER AND RESOLVED PRIOR TO BEGINNING WORK.

9. CONTRACTOR SHALL NOTIFY THE AUTHORITY HAVING JURISDICTION PRIOR TO INSTALLATION OF FIRE SERVICE LINES, AND PRIOR TO TESTING OF ALL WATERLINES. CONTRACTOR SHALL COMPLETE, SIGN, AND SUBMIT THE "CONTRACTOR'S MATERIAL & TEST CERTIFICATE FOR UNDERGROUND PIPING" IN ACCORDANCE WITH NFPA 24.

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2. ALL WORK DETAILED ON THESE PLANS TO BE PERFORMED, EXCEPT AS OTHERWISE STATED OR PROVIDED HEREON, SHALL BE CONSTRUCTED IN ACCORDANCE WITH CITY OF ALBUQUERQUE STANDARD SPECS FOR PUBLIC WORKS CONSTRUCTION, 1986.

3. TWO WORKING DAYS PRIOR TO ANY EXCAVATION, CONTRACTOR MUST CONTACT NEW MEXICO ONE CALL AT 260-1990, FOR LOCATION OF EXISTING UTILITIES.

4. PRIOR TO CONSTRUCTION, THE CONTRACTOR SHALL EXCAVATE AND VERIFY THE HORIZONTAL AND VERTICAL LOCATIONS OF ALL OBSTRUCTIONS. SHOULD A CONFLICT EXIST, THE CONTRACTOR SHALL NOTIFY THE ENGINEER SO THAT THE CONFLICT CAN BE RESOLVED WITH A MINIMUM AMOUNT OF DELAY.

5. BACKFILL COMPACTION SHALL BE TO ARTERIAL STREET USE.

6. MAINTENANCE OF THESE FACILITIES SHALL BE THE RESPONSIBILITY OF THE OWNER OF THE PROPERTY SERVED.

PRIVATE DRAINAGE FACILITIES WITHIN CITY RIGHT-OF-WAY

DESIGN APPROVAL:

HYDROLOGY SECTION DATE

INSPECTION APPROVAL:

TRANS/STREET MAINT. DATE

ACCEPTANCE:

CONSTRUCTION MGT. DIV. DATE

DRAINAGE CERTIFICATION

I, GLENN BROUGHTON, NMPE 14171, OF THE FIRM BOHANNAN HUSTON INC., HEREBY CERTIFY THAT THIS PROJECT HAS BEEN GRADED AND WILL DRAIN IN SUBSTANTIAL COMPLIANCE WITH AND IN ACCORDANCE WITH THE DESIGN INTENT OF THE APPROVED PLAN DATED 9-14-06. THE RECORD INFORMATION EDITED ONTO THE ORIGINAL DESIGN DOCUMENT HAS BEEN OBTAINED BY ROBERT GROMATZKY, NMPS 16469, OF THE FIRM BOHANNAN HUSTON. I FURTHER CERTIFY THAT I HAVE PERSONALLY VISITED THE PROJECT SITE ON 10/24/07 AND HAVE DETERMINED BY VISUAL INSPECTION THAT THE SURVEY DATA PROVIDED IS REPRESENTATIVE OF ACTUAL SITE CONDITIONS AND IS TRUE AND CORRECT TO THE BEST OF MY KNOWLEDGE AND BELIEF. THIS CERTIFICATION IS SUBMITTED IN SUPPORT OF A REQUEST FOR PERMANENT CERTIFICATE OF OCCUPANCY..

THE RECORD INFORMATION PRESENTED HEREON IS NOT NECESSARILY COMPLETE AND INTENDED ONLY TO VERIFY SUBSTANTIAL COMPLIANCE OF THE GRADING AND DRAINAGE ASPECTS OF THIS PROJECT. THOSE RELYING ON THIS RECORD DOCUMENT ARE ADVISED TO OBTAIN INDEPENDENT VERIFICATION OF ITS ACCURACY BEFORE USING IT FOR ANY OTHER PURPOSE.

Slen B 16-27.07 GLENN BROUGHTON, NMPE 14171

OCTOBER 24, 2007

EXISTING STORM DRAIN MANHOLE

EXISTING LIGHT POLE TO REMAIN

PROPOSED NEW SIDEWALK CULVERT

REMOVE AND REPLACE EXISTING 4' PUBLIC

EX=EXISTING.

WATER BLOCK

PROPOSED DIRECTION OF FLOW

TS=TOP OF SIDEWALK OR CONC PAVEMENT




Bohannan 🔺 Huston

Courtyard I 7500 Jefferson St. NE Albuquerque, NM 87109-4335
ENGINEERING & SPATIAL DATA & ADVANCED TECHNOLOGIES


Dekker Perich Sabatini

> 6801 Jefferson NE Suite 100 Albuquerque, NM 87109 505 761-9700 fax 761-4222 dps 4 dpsabq.com

ADGUITTAT

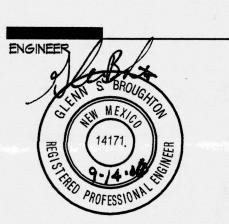

respyterian Hospita
Parking Garage
Albuquerque, NM

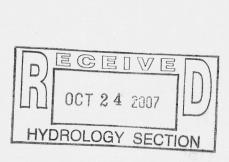

 DRAWN BY
 CM

 REVIEWED BY
 GB

 DATE
 3/01/2006

 PROJECT NO.
 01045.035

GRADING & UTILITY

PLAN
SHEET NO.
C_101

DRAWING NAME

6801 Jefferson NE Suite 100 Albuquerque, NM 87109 505 761-9700 fax 761-4222

dps 👁 dpsabq.com

PROPOSED RETAINING WALL ----5301--- EXISTING CONTOURS χ 5301.15 Existing ground spot elevation PROPOSED INTER CONTOURS PROPOSED SPOT ELEVATION TC=TOP OF CURB, FL=FLOW LINE FGH=FINISHED GRADE AT HIGH SIDE OF WALL

EX=EXISTING, TG=TOP OF GRATE TS=TOP OF SIDEWALK OR CONC PAVEMENT PROPOSED DIRECTION OF FLOW

LEGEND


FGL=FINISHED GRADE AT LOW SIDE OF WALL

PROPOSED CURB & GUTTER EXISTING STORM DRAIN MANHOLE EXISTING STREET LIGHT TO REMAIN

(B) STAIR 2 GRADING DETAIL

1 11 11 1

06.22 TS06:04 (MATCH EX. SIDEWALK)

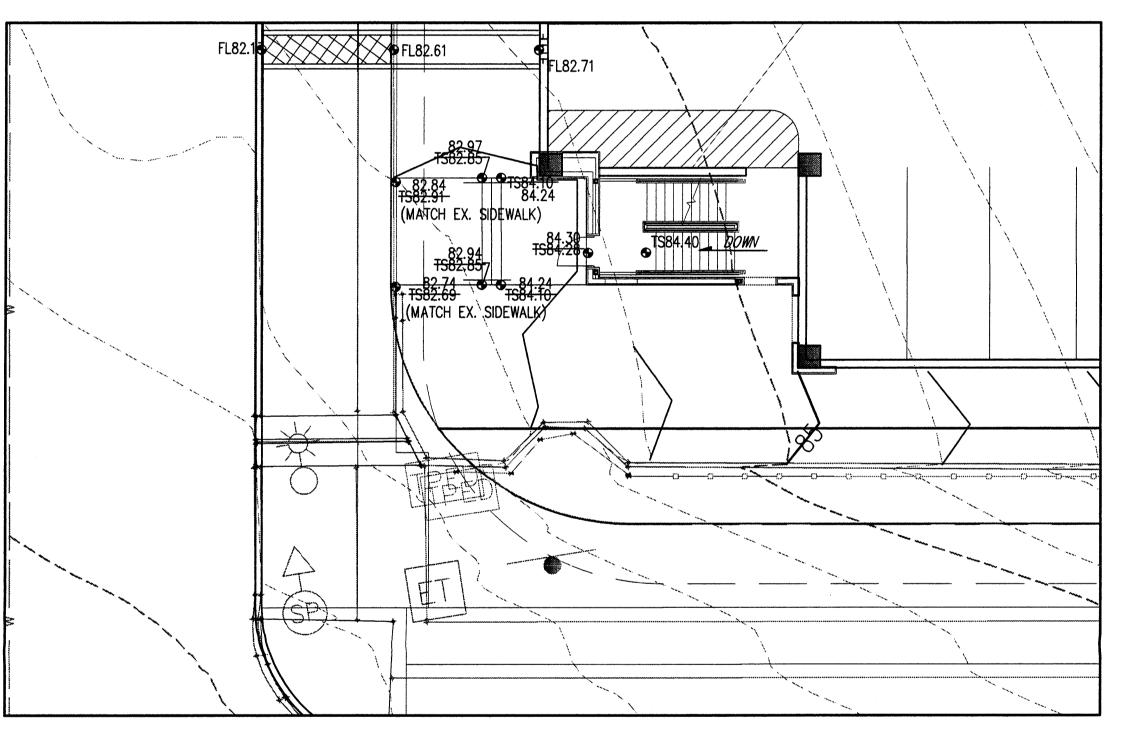

DRAINAGE CERTIFICATION I, GLENN BROUGHTON, NMPE 14171, OF THE FIRM BOHANNAN HUSTON INC., HEREBY CERTIFY THAT THIS PROJECT HAS BEEN GRADED AND WILL DRAIN IN SUBSTANTIAL COMPLIANCE WITH AND IN ACCORDANCE WITH THE DESIGN INTENT OF THE APPROVED PLAN DATED 9-14-06. THE RECORD INFORMATION EDITED ONTO THE ORIGINAL DESIGN DOCUMENT HAS BEEN OBTAINED BY ROBERT GROMATZKY, NMPS 16469, OF THE FIRM BOHANNAN HUSTON. I FURTHER CERTIFY THAT I HAVE PERSONALLY VISITED THE PROJECT SITE ON 10/24/07 AND HAVE DETERMINED BY VISUAL INSPECTION THAT THE SURVEY DATA PROVIDED IS REPRESENTATIVE OF ACTUAL SITE CONDITIONS AND IS TRUE AND CORRECT TO THE BEST OF MY KNOWLEDGE AND BELIEF. THIS CERTIFICATION IS SUBMITTED IN SUPPORT OF A REQUEST FOR PERMANENT CERTIFICATE OF OCCUPANCY... THE RECORD INFORMATION PRESENTED HEREON IS NOT NECESSARILY COMPLETE AND INTENDED ONLY TO VERIFY SUBSTANTIAL COMPLIANCE OF

THE GRADING AND DRAINAGE ASPECTS OF THIS PROJECT. THOSE RELYING ON THIS RECORD DOCUMENT ARE ADVISED TO OBTAIN INDEPENDENT VERIFICATION OF ITS ACCURACY BEFORE USING IT FOR ANY OTHER PURPOSE. S. BROUGHTON, NMPE 14171

Hospital arage


RETAINING WALL NOTES:

- 1. RETAINING WALL SHALL NOT BE BACK-FILLED UNTIL AT LEAST 7 DAYS AFTER CASTING THE WALL.
- 2. VERTICAL CONTROL JOINTS IN THE WALL SHALL BE PLACED AT 8'-0" O.C. MAX.

CONTRACTOR SHALL NOTIFY OWNER PRIOR TO CONCRETE FOOTING POUR FOR INSPECTION OF COMPACTION UNDER FOOTING, FOOTING DEPTH AND WIDTH AND WALL STEEL AND SPACING. FINAL INSPECTION OF FOOTING AND WALL WILL BE REQUIRED.

A STAIR 1 GRADING DETAIL


- 4. THE CONTRACTOR SHALL BE RESPONSIBLE TO SEE THAT ALL REBAR IS PROPERLY ALIGNED AND TIED IN PLACE BEFORE PLACING CONCRETE. ALL STEEL SHALL BE ACCURATELY LOCATED AND SECURED IN PLACE SO THAT IT REMAINS IN POSITION DURING THE PLACEMENT OF THE CONCRETE. ANY REBAR IMPROPERLY INSTALLED SHALL BE REMOVED AT NO ADDITIONAL COST TO THE OWNER.
- 5. WEEP HOLES: PLACE A 2" DIA. WEEP HOLE @ 8'-0" O.C.
- 6. BACK FILL AND COMPACTION OF RETAINING WALL IS INCIDENTAL TO INSTALLATION OF RETAINING WALL.

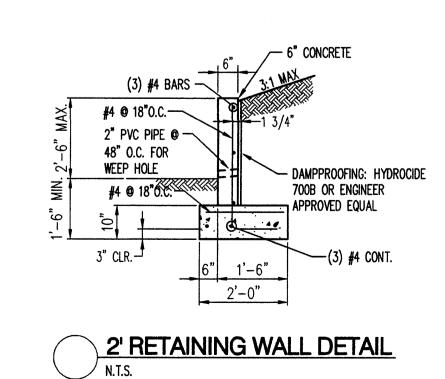


__RETAINING WALL -SEE DET THIS SHEET-MATCH EXISTING_ SIDEWALK

BUS SHELTER GRADING DETAIL

C STAIR 3 GRADING DETAIL

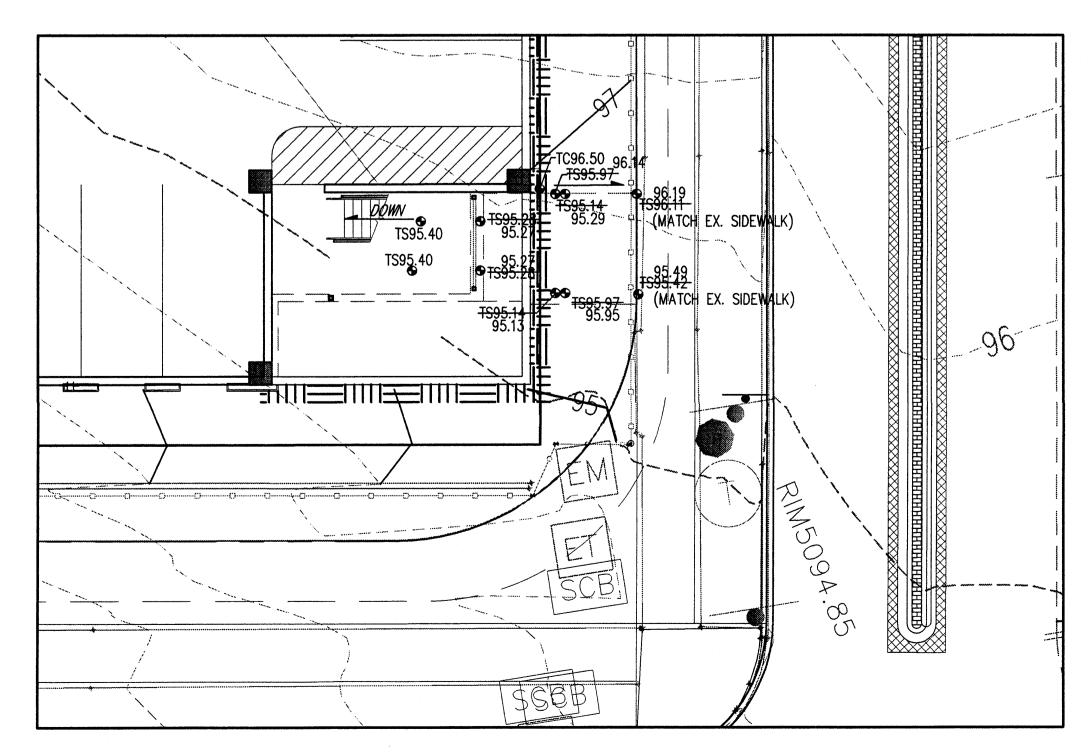

STAIR 4 GRADING DETAIL

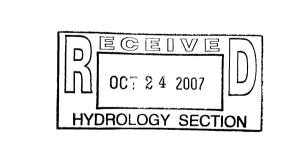

REVISIONS A A A A		
DRAWN BY	CM	
REVIEWED BY	6B	

DATE 3/01/2006 01045.035 PROJECT NO. DRAWING NAME

GRADING DETAILS

Bohannan ▲ Huston⊌

Courtyard I 7500 Jefferson St. NE Albuquerque, NM 87109-4335

ENGINEERING A SPATIAL DATA A ADVANCED TECHNOLOGIES

SHEET NO.