


6801 Jefferson NE Suite 100 Albuquerque, NM 87109 5 0 5 7 6 1 − 9 7 0 0 fax 7 6 1 − 4 2 2 2 dps @dpsabq.com

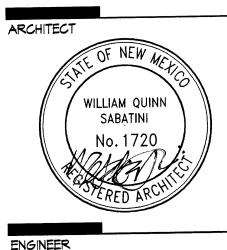

DRAWN BY REVIEWED BY 3-17-05 DATE 01045.026

DRAWING NAME SITE PLAN

DRAINAGE MANAGEMENT PLAN

The purpose of this submittal is to present a final grading and drainage plan for the Presbyterian parking lot on the corner of Lead and Sycamore. This submittal is made in order to support paving approval.

The project site is located on the northwest corner of Lead and Sycamore. Prior to proposed work, the total existing area includes landscaped land (42% Treatment B), and parking lot (58% Treatment D). The site currently drains to the southwest corner of the parking lot through a sidewalk culvert into Spruce Street. According to the DPM chapter 22.2—A.6, the total peak discharge from the site in the 100 year storm is approximately 7.10cfs. Site slopes are 8% to 10%. The site is located within zone atlas map # K-15-Z, and hydrologic zone 2.

III. PROPOSED HYDROLOGIC CONDITIONS The proposed project consists of the addition of 74 new parking spaces to the south side of the existing parking lot. A new sidewalk culvert will be installed in the southwest corner of the parking lot to aid in properly draining the site. The site will still drain into Spruce Street. After completion of the proposed construction, 78.6% will be impervious and 21.4% will consist of land treatment B which will generate a peak discharge of 8.06cfs in the 100 year storm (DPM chapter 22-A.6).

The total discharge to adjacent public streets under proposed conditions is 0.96cfs more than existing peak flows.


IV. OFFSITE CONSIDERATIONS

There are no upstream offsite flows which will impact this site. In addition, the site will not have any detrimental impact on downstream drainage infrastructure since proposed conditions discharge is slightly more than existing.

The improvements proposed with this final grading and drainage plan are capable of safely passing the 100 year storm and meet city requirements. With this submittal, we are seeking city hydrology approval for paving permit.

TREATMENT -> 78.6% = D, 21.4% = B (0.786)(1.93AC)(4.70)+(0.214)(1.93AC)(2.28) = 8.06cfs

NET DIFFERENCE = 8.06 - 7.10 = .96cfs

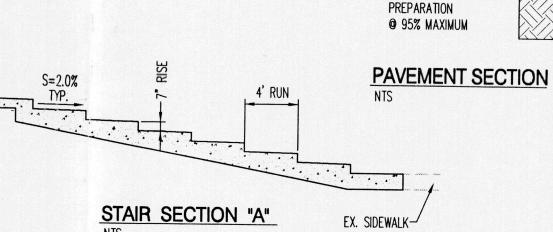

BASE COURSE

8" SUBGRADE -

2. LAP SPLICE ON REINFORCING BARS IS NOT ALLOWED

3. CONSTRUCTION OF RETAINING WALLS SHALL CONFORM TO REQUIREMENTS OF THE 1997 UNIFORM BUILDING CODE.

4. DESIGN DATA EFP (ACTIVE) = 36 PCFSOIL BEARING PRESSURE = 2000 PCF (1/3 INCREASE FOR WIND/ SEISMIC) COEFFICIENT OF FRICTION = 0.35EFP (PASSIVE) = 300 PCFCONCRETE F' C (28 DAYS) = 3000 PSIREINFORCEMENT = 60 ASTM A-615

5. CONTRACTOR SHALL NOTIFY OWNER PRIOR TO CONCRETE FOOTING POUR FOR INSPECTION OF COMPACTION UNDER FOOTING, FOOTING DEPTH AND WIDTH AND WALL 8. STEEL AND SPACING. FINAL INSPECTION OF FOOTING AND WALL WILL BE REQUIRED.

6. CONTRACTOR SHALL BE RESPONSIBLE FOR CODE ADMINISTRATION APPROVAL AND FEES ASSOCIATED WITH IT.

GENERAL NOTES

1. ALL WORK DETAILED ON THESE PLANS AND PERFORMED UNDER THIS CONTRACT SHALL BE CONSTRUCTED IN ACCORDANCE WITH THE PROJECT SPECIFICATIONS AND THE PROJECT GEOTECHNICAL REPORT. WHERE APPLICABLE, CITY OF ALBUQUERQUE

2. THE CONTRACTOR SHALL ABIDE BY ALL LOCAL, STATE, AND FEDERAL LAWS, RULES AND REGULATIONS WHICH APPLY TO THE CONSTRUCTION OF THESE IMPROVEMENTS, INCLUDING EPA REQUIREMENTS WITH RESPECT TO STORM WATER DISCHARGE. 3. PRIOR TO CONSTRUCTION, THE CONTRACTOR SHALL FIELD VERIFY THE HORIZONTAL AND VERTICAL LOCATIONS OF ALL POTENTIAL OBSTRUCTIONS INCLUDING ALL UNDERGROUND UTILITIES. SHOULD A CONFLICT EXIST, THE CONTRACTOR SHALL NOTIFY THE CONSTRUCTION OBSERVER OR ENGINEER SO THAT THE CONFLICT CAN BE RESOLVED WITH A MINIMUM AMOUNT OF

4. TWO (2) WORKING DAYS PRIOR TO ANY EXCAVATION, THE CONTRACTOR SHALL CONTACT LINE LOCATING SERVICE FOR

5. ALL ELECTRICAL, TELEPHONE, CABLE TV, GAS AND OTHER UTILITY LINES, CABLES, AND APPURTENANCES ENCOUNTERED DURING CONSTRUCTION THAT REQUIRE RELOCATION, SHALL BE COORDINATED WITH THAT UTILITY. THE CONTRACTOR SHALL BE RESPONSIBLE FOR COORDINATION OF ALL NECESSARY UTILITY ADJUSTMENTS. NO ADDITIONAL COMPENSATION WILL BE ALLOWED FOR DELAYS OR INCONVENIENCES CAUSED BY UTILITY COMPANY WORK CREWS. THE CONTRACTOR MAY BE REQUIRED TO RESCHEDULE HIS ACTIVITIES TO ALLOW UTILITY CREWS TO PERFORM THEIR REQUIRED WORK.

6. THE CONTRACTOR IS RESPONSIBLE FOR PROTECTING ALL EXISTING UTILITY LINES WITHIN THE CONSTRUCTION AREA. ANY DAMAGE TO EXISTING FACILITIES CAUSED BY CONSTRUCTION ACTIVITY SHALL BE REPAIRED OR REPLACED AT THE CONTRACTOR'S EXPENSE AND APPROVED BY THE CONSTRUCTION OBSERVER.

7. CONSTRUCTION ACTIVITY SHALL BE LIMITED TO THE PROPERTY AND/OR PROJECT LIMITS. ANY DAMAGE TO ADJACENT PROPERTIES RESULTING FROM THE CONSTRUCTION PROCESS SHALL BE REPAIRED OR REPLACED AT THE CONTRACTOR'S

8. OVERNIGHT PARKING OF CONSTRUCTION EQUIPMENT SHALL NOT OBSTRUCT DRIVEWAYS OR DESIGNATED TRAFFIC LANES. THE CONTRACTOR SHALL NOT STORE ANY EQUIPMENT OR MATERIAL WITHIN THE PUBLIC RIGHT-OF-WAY.

9. THE CONTRACTOR SHALL OBTAIN ALL THE NECESSARY PERMITS FOR THE PROJECT PRIOR TO COMMENCING CONSTRUCTION (I.E., BARRICADING, TOPSOIL DISTURBANCE, EXCAVATION PERMITS, EPA STORM WATER PERMITS, ETC.).

10. ALL PROPERTY CORNERS DESTROYED DURING CONSTRUCTION SHALL BE REPLACED AT THE CONTRACTOR'S EXPENSE. ALL PROPERTY CORNERS MUST BE RESET BY A REGISTERED LAND SURVEYOR. 11. THE CONTRACTOR SHALL PREPARE A CONSTRUCTION TRAFFIC CONTROL AND SIGNING PLAN AND OBTAIN APPROVAL OF SUCH PLAN FROM THE CITY OF ALBUQUERQUE, TRAFFIC ENGINEERING DEPARTMENT, PRIOR TO BEGINNING ANY CONSTRUCTION

WORK ON OR ADJACENT TO EXISTING STREETS. 12. ALL BARRICADES AND CONSTRUCTION SIGNING SHALL CONFORM TO APPLICABLE SECTIONS OF THE "MANUAL ON UNIFORM TRAFFIC CONTROL DEVICES" (MUTCD), US DEPARTMENT OF TRANSPORTATION, LATEST EDITION.

13. THE CONTRACTOR SHALL MAINTAIN ALL CONSTRUCTION BARRICADES AND SIGNING AT ALL TIMES. THE CONTRACTOR SHALL VERIFY THE PROPER LOCATION OF ALL BARRICADING AT THE END AND BEGINNING OF EACH DAY.

14. THE CONTRACTOR SHALL TAKE ALL STEPS NECESSARY TO CONFORM WITH EPA REQUIREMENTS, INCLUDING COMPLIANCE WITH NPDES PHASE 2 REQUIREMENTS.

GRADING NOTES

BEGINNING CONSTRUCTION.

1. EXCEPT AS PROVIDED HEREIN, GRADING SHALL BE PERFORMED AT THE ELEVATIONS AND IN ACCORDANCE WITH THE DETAILS SHOWN ON THIS PLAN.

2. THE COST FOR REQUIRED CONSTRUCTION DUST AND EROSION CONTROL MEASURES SHALL BE INCIDENTAL TO THE PROJECT COST.

3. ALL WORK RELATIVE TO FOUNDATION CONSTRUCTION, SITE PREPARATION, AND PAVEMENT INSTALLATION, AS SHOWN ON THIS PLAN, SHALL BE CONSTRUCTED IN ACCORDANCE WITH THE "GEOTECHNICAL INVESTIGATION," AS PROVIDED BY THE ARCHITECT OR OWNER. ALL OTHER WORK SHALL, UNLESS OTHERWISE STATED OR PROVIDED FOR HEREON, BE CONSTRUCTED IN ACCORDANCE WITH THE PROJECT, (FIRST PRIORITY) SPECIFICATIONS, AND/OR THE CITY OF ALBUQUERQUE (COA) STANDARD SPECIFICATIONS FOR PUBLIC WORKS (SECOND PRIORITY).

4. EARTH SLOPES SHALL NOT EXCEED 3 HORIZONTAL TO 1 VERTICAL UNLESS SHOWN OTHERWISE.

5. IT IS THE INTENT OF THESE PLANS THAT THIS CONTRACTOR SHALL NOT PERFORM ANY WORK OUTSIDE OF THE PROPERTY BOUNDARIES EXCEPT AS REQUIRED BY THIS PLAN.

6. THE CONTRACTOR IS TO ENSURE THAT NO SOIL ERODES FROM THE SITE ONTO ADJACENT PROPERTY OR PUBLIC RIGHT-OF-WAY. THIS SHOULD BE ACHIEVED BY CONSTRUCTING SILT FENCE S OR TEMPORARY BERMS AT THE PROPERTY LINES.

7. A DISPOSAL SITE FOR ANY & ALL EXCESS EXCAVATION MATERIAL, AND UNSUITABLE MATERIAL AND/OR A BORROW SITE CONTAINING ACCEPTABLE FILL MATERIAL SHALL BE OBTAINED BY THE CONTRACTOR IN COMPLIANCE WITH APPLICABLE ENVIRONMENTAL REGULATIONS AND APPROVED BY THE OBSERVER. ALL COSTS INCURRED IN OBTAINING A DISPOSAL OR BORROW SITE AND HAUL TO OR FROM SHALL BE CONSIDERED INCIDENTAL TO THE PROJECT AND NO SEPARATE MEASUREMENT OR PAYMENT SHALL BE MADE.

8. PAVING AND ROADWAY GRADES SHALL BE +/- 0.1' FROM PLAN ELEVATIONS. PAD ELEVATION SHALL BE +/- 0.05' FROM BUILDING PLAN ELEVATION.

10. VERIFY ALL ELEVATIONS SHOWN ON PLAN FROM BASIS OF ELEVATION CONTROL STATION PRIOR TO

9. ALL PROPOSED CONTOURS REFLECT TOP OF PAVEMENT ELEVATIONS IN THE PARKING AREA AND MUST BE ADJUSTED FOR MEDIANS AND ISLANDS.

-4" CMU CAP - 8" CMU WALL, GROUT -LOCATION OF VERTICAL LONGIT. WALL SOLID EXPANSION OR BARS CONTRACTION JOINT #9 TRUSS TYPE DUROWALL EVERY BARS Z BARS TO MATCH -OTHER COURSE -2" WEEP HOLE SIZE AND SPACING • 1 • 3/4"ø GRAVEL FILL OF LONGIT. BARS ----1 C.F./FT CONT. -STEP FOOTING DETAIL CONCRETE: f'c = 3000 psi @ 28 DAY

REINFORCING STEEL: fy = 60,000 psiCHAINLINK FENCE POST 3/16" **RETAINING WALL DETAIL** - ADDITIONAL #4, CONT. SCALE: NTS


CHAINLINK FENCE POST SLEEVE

7. THE CONTRACTOR SHALL BE RESPONSIBLE TO SEE THAT ALL REBAR IS PROPERLY ALIGNED AND TIED IN PLACE BEFORE PLACING CONCRETE. ALL STEEL SHALL BE REINFORCEMENT ACCURATELY LOCATED AND SECURED IN PLACE SO THAT IT REMAINS IN POSITION DURING THE PLACEMENT OF THE CONCRETE. ANY REBAR IMPROPERLY INSTALLED SHALL BE REMOVED AT NO ADDITIONAL COST TO THE OWNER.

WEEP HOLES: PLACE A 2'x1' PIECE OF MIRAFI 140N FILTER FABRIC ON THE BACK OF WALL AT EACH WEEP LOCATION. OMIT HEAD JOINT ON BOTTOM TWO COURSES AT 48" O.C.


THE FIRST COURSE OF CMU BLOCK MAY BE PLACED IN FRESH FOOTING CONCRETE. SUBSEQUENT COURSES OF CMU BLOCK SHALL NOT BE PLACED UNTIL 7 DAYS AFTER THE FOOTING IS CAST.

10. ALL CMU BLOCK JOINTS SHALL BE TOOLED.

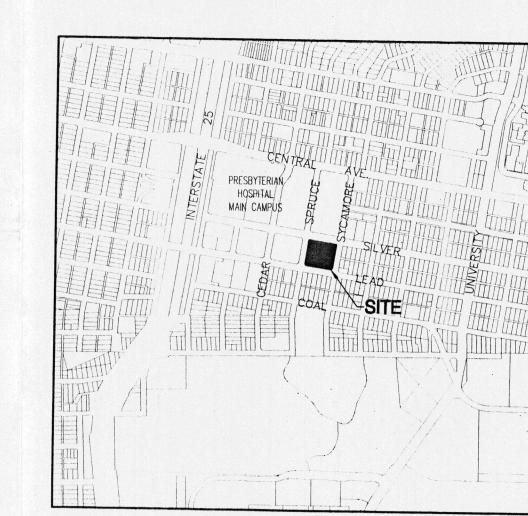

ARCHITECT

VICINITY MAP ZONE ATLAS PAGE K-15-Z

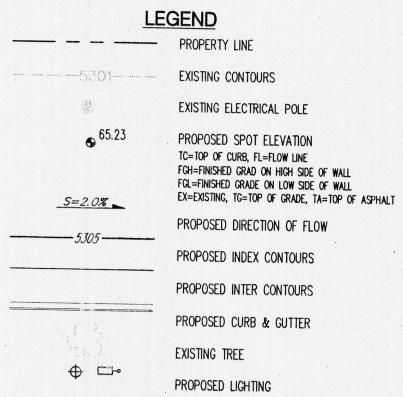

NOTICE TO CONTRACTORS (SO 19)

1. AN EXCAVATION/CONSTRUCTION PERMIT WILL BE REQUIRED BEFORE BEGINNING ANY WORK WITHIN THE CITY RIGHT-OF-WAY. AN APPROVED COPY OF THESE PLANS MUST BE SUBMITTED AT THE TIME OF APPLICATION FOR THIS PERMIT.

PAVEMENT SECTION THIS SHEET

2. FIL WORK DETAILED ON THESE PLANS TO BE PERFORMED, EXCEPT AS OTHERWISE STATED OR PROVIDED HEREON, SHALL BE CONSTRUCTED IN ACCORDANCE WITH CITY OF ALBUQUERQUE STANDARD SPECS FOR PUBLIC WORKS CONSTRUCTION, 1986.

NEW ASPHALT CONCRETE PAVEMENT. SEE


3. TWO WORKING DAYS PRIOR TO ANY EXCAVATION, CONTRACTOR MUST CONTACT LINE LOCATION SERVICE, 765-1234, FOR LOCATION OF EXISTING UTILITIES.

HORIZONTAL AND VERTICAL LOCATIONS OF ALL OBSTRUCTIONS. SHOULD A CONFLICT EXIST, THE CONTRACTOR SHALL NOTIFY THE ENGINEER SO THAT THE CONFLICT CAN BE RESOLVED WITH A MINIMUM AMOUNT OF DELAY.

5. BACKFILL COMPACTION SHALL BE TO ARTERIAL STREET USE.

6. MAINTENANCE OF THESE FACILITIES SHALL BE THE RESPONSIBILITY OF THE OWNER OF THE PROPERTY SERVED.

PRIVATE DRAINAGE FACILITIES WITHIN CITY RIGHT-OF-WAY

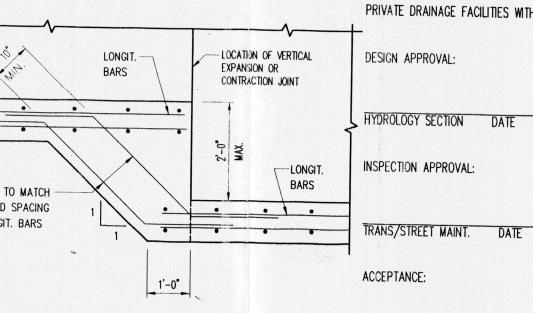

GRADING & DRAINAGE KEYED NOTES 1. INSTALL 24" WIDE SIDEWALK CULVERT/CONCRETE RIBBON CHANNEL AS PER CITY OF ALBUQUERQUE STD DWG. 2236. SPECIAL SO-19 PERMIT AND INSPECTION REQUIRED, SEE NOTICE TO CONTRACTOR, THIS SHEET

3. SAW CUT AND MATCH EXISTING PAVEMENT, SEE DETAIL THIS

4. INSTALL SLEEVE FOR CHAIN LINK FENCE PER DETAIL ON THIS

Bohannan A Huston :

Courtyard I 7500 Jefferson St. NE Albuquerque, NM 87109-4335 ENGINEERING . SPATIAL DATA . ADVANCED TECHNOLOGIES



architecture interiors

planning

6801 Jefferson NE Suite 100 Albuquerque, NM 87109 505 761-9700 fax 761-4222 dps@dpsabq.com

PROJECT

an

•

Sb E

re

REVISIONS

xpans t Parki

rque,

4. PRIOR TO CONSTRUCTION, THE CONTRACTOR SHALL EXCAVATE AND VERIFY THE

CONSTRUCTION MGT. DIV. DATE

DRAWN BY REVIEWED BY

MATCH EXISTING CURB AND GUTTER HORIZONTAL AND




SHEET NO.

P: \040150\cdp\general\040150gp02.dwg July 27, 2004 - 9: 34am

MJB GSB DATE 11-21-03

PROJECT NO. DRAWING NAME

GRADING &

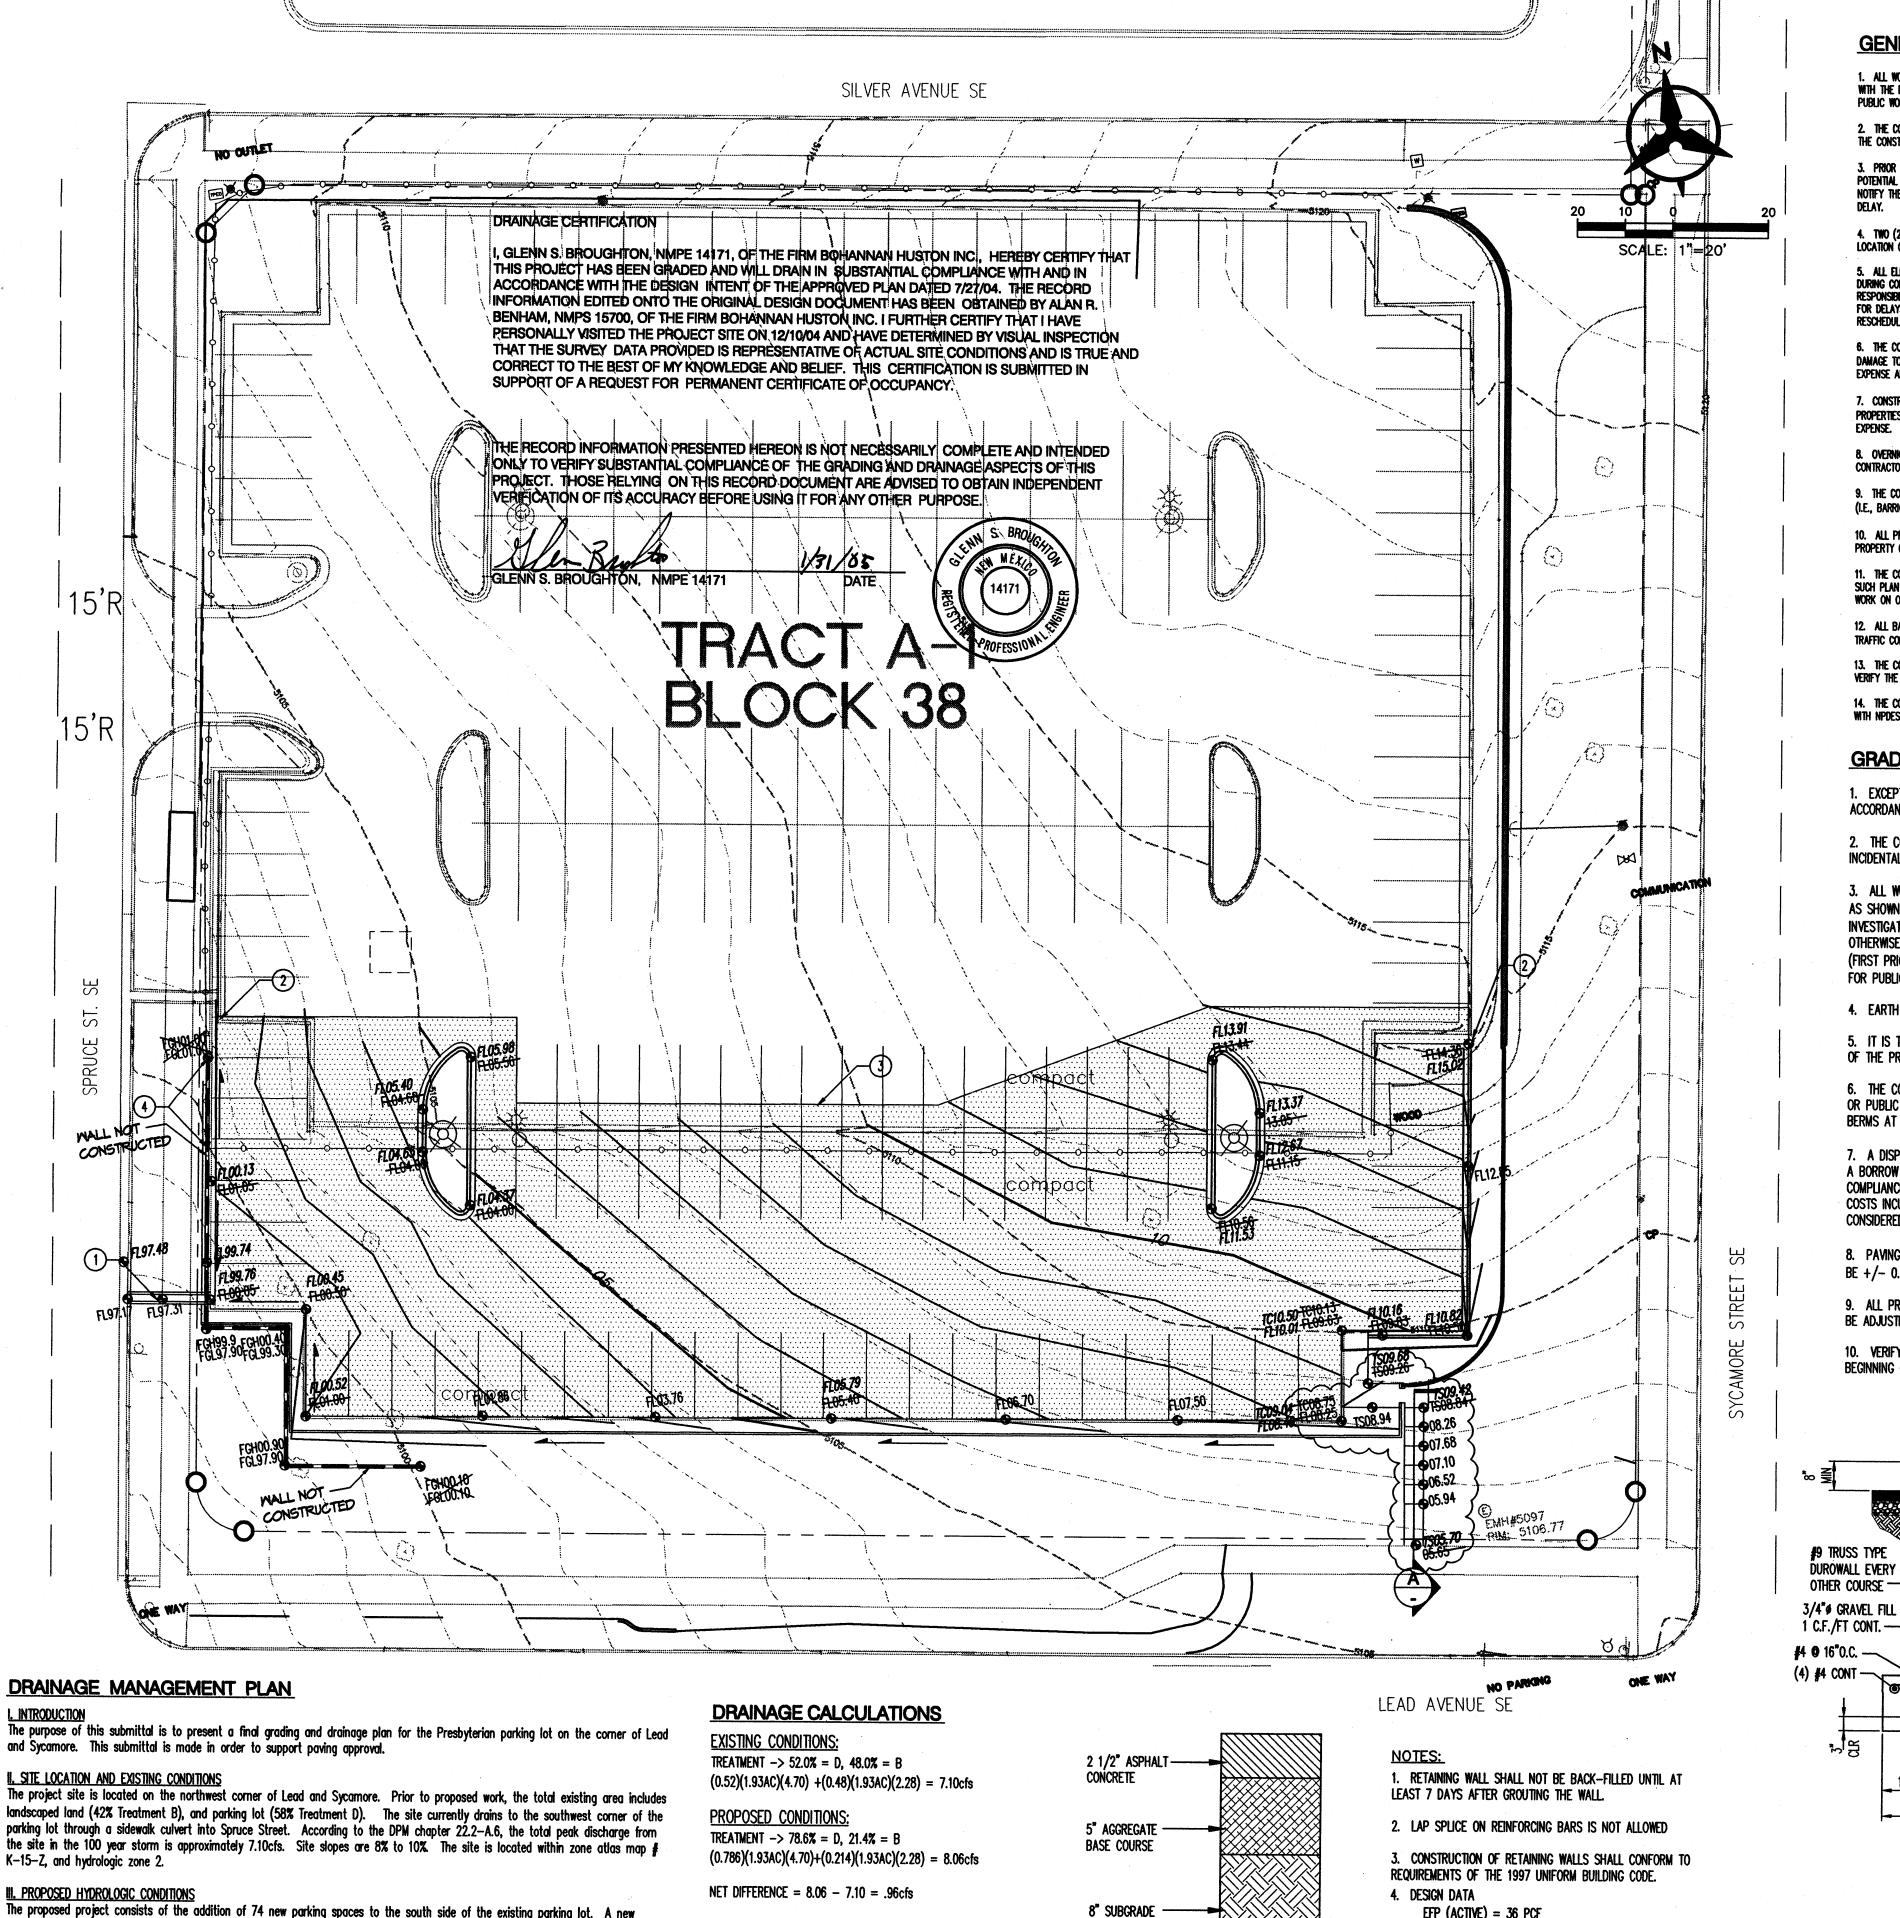

GENERAL NOTES

1. ALL WORK DETAILED ON THESE PLANS AND PERFORMED UNDER THIS CONTRACT SHALL BE CONSTRUCTED IN ACCORDANCE WITH THE PROJECT SPECIFICATIONS AND THE PROJECT GEOTECHNICAL REPORT. WHERE APPLICABLE, CITY OF ALBUQUERQUE

2. THE CONTRACTOR SHALL ABIDE BY ALL LOCAL, STATE, AND FEDERAL LAWS, RULES AND REGULATIONS WHICH APPLY TO THE CONSTRUCTION OF THESE IMPROVEMENTS, INCLUDING EPA REQUIREMENTS WITH RESPECT TO STORM WATER DISCHARGE.

3. PRIOR TO CONSTRUCTION, THE CONTRACTOR SHALL FIELD VERIFY THE HORIZONTAL AND VERTICAL LOCATIONS OF ALL POTENTIAL OBSTRUCTIONS INCLUDING ALL UNDERGROUND UTILITIES. SHOULD A CONFLICT EXIST, THE CONTRACTOR SHALL NOTIFY THE CONSTRUCTION OBSERVER OR ENGINEER SO THAT THE CONFLICT CAN BE RESOLVED WITH A MINIMUM AMOUNT OF

4. TWO (2) WORKING DAYS PRIOR TO ANY EXCAVATION, THE CONTRACTOR SHALL CONTACT LINE LOCATING SERVICE FOR

5. ALL ELECTRICAL, TELEPHONE, CABLE TV, GAS AND OTHER UTILITY LINES, CABLES, AND APPURTENANCES ENCOUNTERED DURING CONSTRUCTION THAT REQUIRE RELOCATION, SHALL BE COORDINATED WITH THAT UTILITY. THE CONTRACTOR SHALL BE RESPONSIBLE FOR COORDINATION OF ALL NECESSARY UTILITY ADJUSTMENTS. NO ADDITIONAL COMPENSATION WILL BE ALLOWED FOR DELAYS OR INCONVENIENCES CAUSED BY UTILITY COMPANY WORK CREWS. THE CONTRACTOR MAY BE REQUIRED TO RESCHEDULE HIS ACTIVITIES TO ALLOW UTILITY CREWS TO PERFORM THEIR REQUIRED WORK,

6. THE CONTRACTOR IS RESPONSIBLE FOR PROTECTING ALL EXISTING UTILITY LINES WITHIN THE CONSTRUCTION AREA. ANY DAMAGE TO EXISTING FACILITIES CAUSED BY CONSTRUCTION ACTIVITY SHALL BE REPAIRED OR REPLACED AT THE CONTRACTOR'S EXPENSE AND APPROVED BY THE CONSTRUCTION OBSERVER.

7. CONSTRUCTION ACTIVITY SHALL BE LIMITED TO THE PROPERTY AND/OR PROJECT LIMITS. ANY DAMAGE TO ADJACENT PROPERTIES RESUlting from the construction process shall be repaired or replaced at the contractor's

8. OVERNICHT PARKING OF CONSTRUCTION EQUIPMENT SHALL NOT OBSTRUCT DRIVEWAYS OR DESIGNATED TRAFFIC LANES. THE CONTRACTOR SHALL NOT STORE ANY EQUIPMENT OR MATERIAL WITHIN THE PUBLIC RIGHT-OF-WAY.

9. THE CONTRACTOR SHALL OBTAIN ALL THE NECESSARY PERMITS FOR THE PROJECT PRIOR TO COMMENCING CONSTRUCTION (I.E., BARRICADING, TOPSOIL DISTURBANCE, EXCAVATION PERMITS, EPA STORM WATER PERMITS, ETC.).

10. ALL PROPERTY CORNERS DESTROYED DURING CONSTRUCTION SHALL BE REPLACED AT THE CONTRACTOR'S EXPENSE. ALL PROPERTY CORNERS MUST BE RESET BY A REGISTERED LAND SURVEYOR. 11. THE CONTRACTOR SHALL PREPARE A CONSTRUCTION TRAFFIC CONTROL AND SIGNING PLAN AND OBTAIN APPROVAL OF

SUCH PLAN FROM THE CITY OF ALBUQUERQUE, TRAFFIC ENGINEERING DEPARTMENT, PRIOR TO BEGINNING ANY CONSTRUCTION WORK ON OR ADJACENT TO EXISTING STREETS.

12. ALL BARRICADES AND CONSTRUCTION SIGNING SHALL CONFORM TO APPLICABLE SECTIONS OF THE "MANUAL ON UNIFORM TRAFFIC CONTROL DEVICES" (MUTCD), US DEPARTMENT OF TRANSPORTATION, LATEST EDITION.

13. THE CONTRACTOR SHALL MAINTAIN ALL CONSTRUCTION BARRICADES AND SIGNING AT ALL TIMES. THE CONTRACTOR SHALL VERIFY THE PROPER LOCATION OF ALL BARRICADING AT THE END AND BEGINNING OF EACH DAY. 14. THE CONTRACTOR SHALL TAKE ALL STEPS NECESSARY TO CONFORM WITH EPA REQUIREMENTS, INCLUDING COMPLIANCE

GRADING NOTES

WITH NPDES PHASE 2 REQUIREMENTS.

1. EXCEPT AS PROVIDED HEREIN, GRADING SHALL BE PERFORMED AT THE ELEVATIONS AND IN ACCORDANCE WITH THE DETAILS SHOWN ON THIS PLAN.

2. THE COST FOR REQUIRED CONSTRUCTION DUST AND EROSION CONTROL MEASURES SHALL BE INCIDENTAL TO THE PROJECT COST.

3. ALL WORK RELATIVE TO FOUNDATION CONSTRUCTION, SITE PREPARATION, AND PAVEMENT INSTALLATION, AS SHOWN ON THIS PLAN, SHALL BE CONSTRUCTED IN ACCORDANCE WITH THE "GEOTECHNICAL INVESTIGATION," AS PROVIDED BY THE ARCHITECT OR OWNER. ALL OTHER WORK SHALL, UNLESS OTHERWISE STATED OR PROVIDED FOR HEREON, BE CONSTRUCTED IN ACCORDANCE WITH THE PROJECT, (FIRST PRIORITY) SPECIFICATIONS, AND/OR THE CITY OF ALBUQUERQUE (COA) STANDARD SPECIFICATIONS FOR PUBLIC WORKS (SECOND PRIORITY).

4. EARTH SLOPES SHALL NOT EXCEED 3 HORIZONTAL TO 1 VERTICAL UNLESS SHOWN OTHERWISE.

5. IT IS THE INTENT OF THESE PLANS THAT THIS CONTRACTOR SHALL NOT PERFORM ANY WORK OUTSIDE OF THE PROPERTY BOUNDARIES EXCEPT AS REQUIRED BY THIS PLAN.


6. THE CONTRACTOR IS TO ENSURE THAT NO SOIL ERODES FROM THE SITE ONTO ADJACENT PROPERTY OR PUBLIC RIGHT-OF-WAY. THIS SHOULD BE ACHIEVED BY CONSTRUCTING SILT FENCE S OR TEMPORARY BERMS AT THE PROPERTY LINES.

7. A DISPOSAL SITE FOR ANY & ALL EXCESS EXCAVATION MATERIAL, AND UNSUITABLE MATERIAL AND/OR A BORROW SITE CONTAINING ACCEPTABLE FILL MATERIAL SHALL BE OBTAINED BY THE CONTRACTOR IN COMPLIANCE WITH APPLICABLE ENVIRONMENTAL REGULATIONS AND APPROVED BY THE OBSERVER. ALL COSTS INCURRED IN OBTAINING A DISPOSAL OR BORROW SITE AND HAUL TO OR FROM SHALL BE CONSIDERED INCIDENTAL TO THE PROJECT AND NO SEPARATE MEASUREMENT OR PAYMENT SHALL BE MADE.


8. PAVING AND ROADWAY GRADES SHALL BE +/- 0.1' FROM PLAN ELEVATIONS. PAD ELEVATION SHALL BE +/- 0.05' FROM BUILDING PLAN ELEVATION.

9. ALL PROPOSED CONTOURS REFLECT TOP OF PAVEMENT ELEVATIONS IN THE PARKING AREA AND MUST BE ADJUSTED FOR MEDIANS AND ISLANDS.

10. VERIFY ALL ELEVATIONS SHOWN ON PLAN FROM BASIS OF ELEVATION CONTROL STATION PRIOR TO BEGINNING CONSTRUCTION.

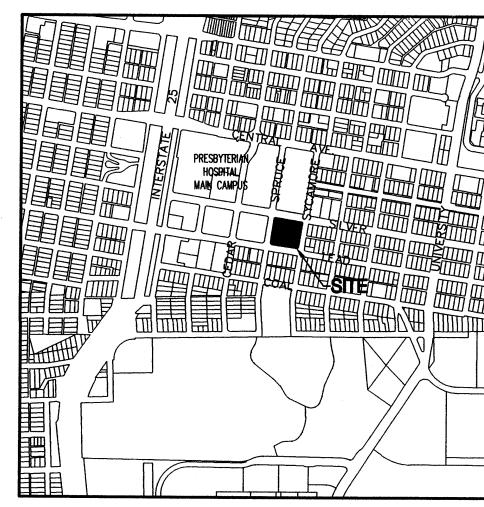

VICINITY MAP ZONE ATLAS PAGE K-15-Z

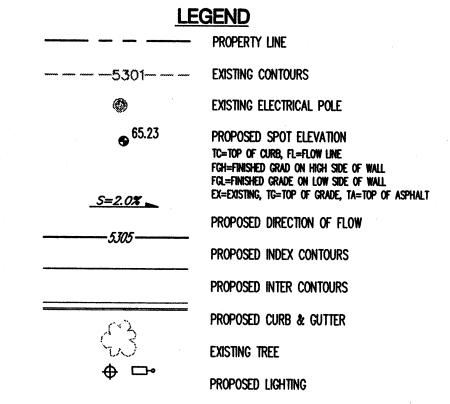

NOTICE TO CONTRACTORS (SO 19)

1. AN EXCAVATION/CONSTRUCTION PERMIT WILL BE REQUIRED BEFORE BEGINNING ANY WORK WITHIN THE CITY RIGHT-OF-WAY. AN APPROVED COPY OF THESE PLANS MUST BE SUBMITTED AT THE TIME OF APPLICATION FOR THIS PERMIT.

PAVEMENT SECTION THIS SHEET

2. ALL WORK DETAILED ON THESE PLANS TO BE PERFORMED, EXCEPT AS OTHERWISE STATED OR PROVIDED HEREON, SHALL BE CONSTRUCTED IN ACCORDANCE WITH CITY O ALBUQUERQUE STANDARD SPECS FOR PUBLIC WORKS CONSTRUCTION, 1986.

NEW ASPHALT CONCRETE PAVEMENT. SEE


3. TWO WORKING DAYS PRIOR TO ANY EXCAVATION, CONTRACTOR MUST CONTACT LINE LOCATION SERVICE, 765–1234, FOR LOCATION OF EXISTING UTILITIES.

4. PRIOR TO CONSTRUCTION, THE CONTRACTOR SHALL EXCAVATE AND VERIFY THE HORIZONTAL AND VERTICAL LOCATIONS OF ALL OBSTRUCTIONS. SHOULD A CONFLICT EXIST, THE CONTRACTOR SHALL NOTIFY THE ENGINEER SO THAT THE CONFLICT CAN BE RESOLVED WITH A MINIMUM AMOUNT OF DELAY.

5. BACKFILL COMPACTION SHALL BE TO ARTERIAL STREET USE.

6. MAINTENANCE OF THESE FACILITIES SHALL BE THE RESPONSIBILITY OF THE OWNER OF THE PROPERTY SERVED.

PRIVATE DRAINAGE FACILITIES WITHIN CITY RIGHT-OF-WAY

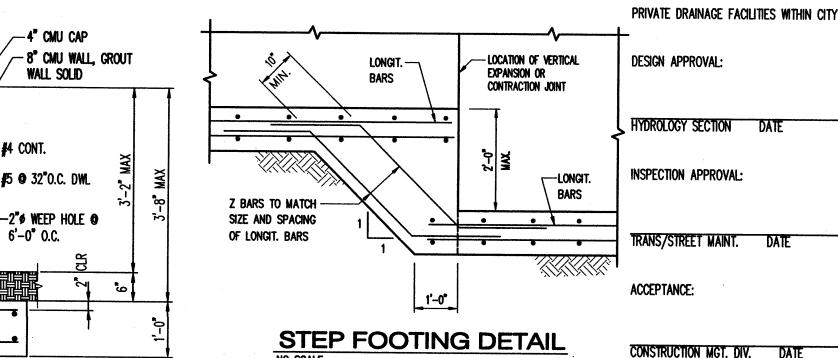

O GRADING & DRAINAGE KEYED NOTES 1. INSTALL 24" WIDE SIDEWALK CULVERT/CONCRETE RIBBON CHANNEL AS PER CITY OF ALBUQUERQUE STD DWG. 2236.

SPECIAL SO-19 PERMIT AND INSPECTION REQUIRED, SEE NOTICE TO CONTRACTOR, THIS SHEET

2. MATCH EXISTING CURB AND GUTTER HORIZONTAL AND

3. SAW CUT AND MATCH EXISTING PAVEMENT, SEE DETAIL THIS

4. INSTALL SLEEVE FOR CHAIN LINK FENCE PER DETAIL ON THIS

- CAP PLATE, 5 mm X 85 mm X 85 mm CHAINLINK FENCE POST SLEEVE

7. THE CONTRACTOR SHALL BE RESPONSIBLE TO SEE THAT ALL REBAR IS PROPERLY ALIGNED AND TIED IN PLACE BEFORE PLACING CONCRETE. ALL STEEL SHALL BE REINFORCEMENT ACCURATELY LOCATED AND SECURED IN PLACE SO THAT IT REMAINS IN POSITION DURING THE PLACEMENT OF THE CONCRETE. ANY REBAR IMPROPERLY INSTALLED SHALL BE REMOVED AT NO ADDITIONAL COST TO THE OWNER.

f'c = 3000 psi **9** 28 DAY

REINFORCING STEEL:

fy = 60,000 psi

WEEP HOLES: PLACE A 2'x1' PIECE OF MIRAFI 140N FILTER FABRIC ON THE BACK OF WALL AT EACH WEEP LOCATION. OMIT HEAD JOINT ON BOTTOM TWO COURSES AT 48" O.C.

THE FIRST COURSE OF CMU BLOCK MAY BE PLACED IN FRESH

FOOTING CONCRETE. SUBSEQUENT COURSES OF CMU BLOCK

RETAINING WALL DETAIL


SCALE: NTS

SHALL NOT BE PLACED UNTIL 7 DAYS AFTER THE FOOTING IS CAST. 10. ALL CMU BLOCK JOINTS SHALL BE TOOLED.

1'-0"

2'-10"



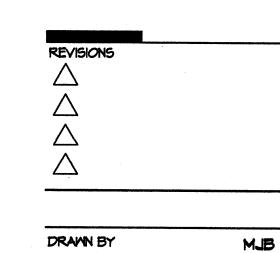

6801 Jefferson NE

Albuquerque, NM 87109

Suite 100

ARCHITECT

PROJECT

an

S 田 田

re

4

0


505 761-9700

fax 761-4222

dps @ dpsabq.com

REVIEWED BY GSB DATE 11-21-03 PROJECT NO.

DRAWING NAME

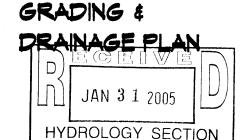

SHEET NO.

K-15-Z, and hydrologic zone 2. III. PROPOSED HYDROLOGIC CONDITIONS The proposed project consists of the addition of 74 new parking spaces to the south side of the existing parking lot. A new sidewalk culvert will be installed in the southwest corner of the parking lot to aid in properly draining the site. The site will still drain into Spruce Street. After completion of the proposed construction, 78.6% will be impervious and 21.4% will consist of land treatment B which will generate a peak discharge of 8.06cfs in the 100 year storm (DPM chapter 22-A.6). The total discharge to adjacent public streets under proposed conditions is 0.96cfs more than existing peak flows. There are no upstream offsite flows which will impact this site. In addition, the site will not have any detrimental impact on downstream drainage infrastructure since proposed conditions discharge is slightly more than existing.

The improvements proposed with this final grading and drainage plan are capable of safely passing the 100 year storm and meet city

requirements. With this submittal, we are seeking city hydrology approval for paving permit.

PREPARATION **95% MAXIMUM**

PAVEMENT SECTION

EX. SIDEWALK-

STAIR SECTION 'A'


EFP (ACTIVE) = 36 PCFsoil`bearing pressure = 2000 pcf (1/3 INCREASE FOR WIND/ SEISMIC) $\dot{C}OEFFICIENT$ of Friction = 0.35 EFP (PASSIVE) = 300 PCFCONCRETE F C (28 DAYS) = 3000 PSIREINFORCEMENT = 60 ASTM A-615

> 5. CONTRACTOR SHALL NOTIFY OWNER PRIOR TO CONCRETE FOOTING POUR FOR INSPECTION OF COMPACTION UNDER FOOTING, FOOTING DEPTH AND WIDTH AND WALL 8.

STEEL AND SPACING. FINAL INSPECTION OF FOOTING AND WALL WILL BE REQUIRED. 6. CONTRACTOR SHALL BE RESPONSIBLE FOR CODE ADMINISTRATION APPROVAL AND

FEES ASSOCIATED WITH IT.

P: \040150\cdp\general\040150gp02.dwg January 31, 2005 — 10:01am

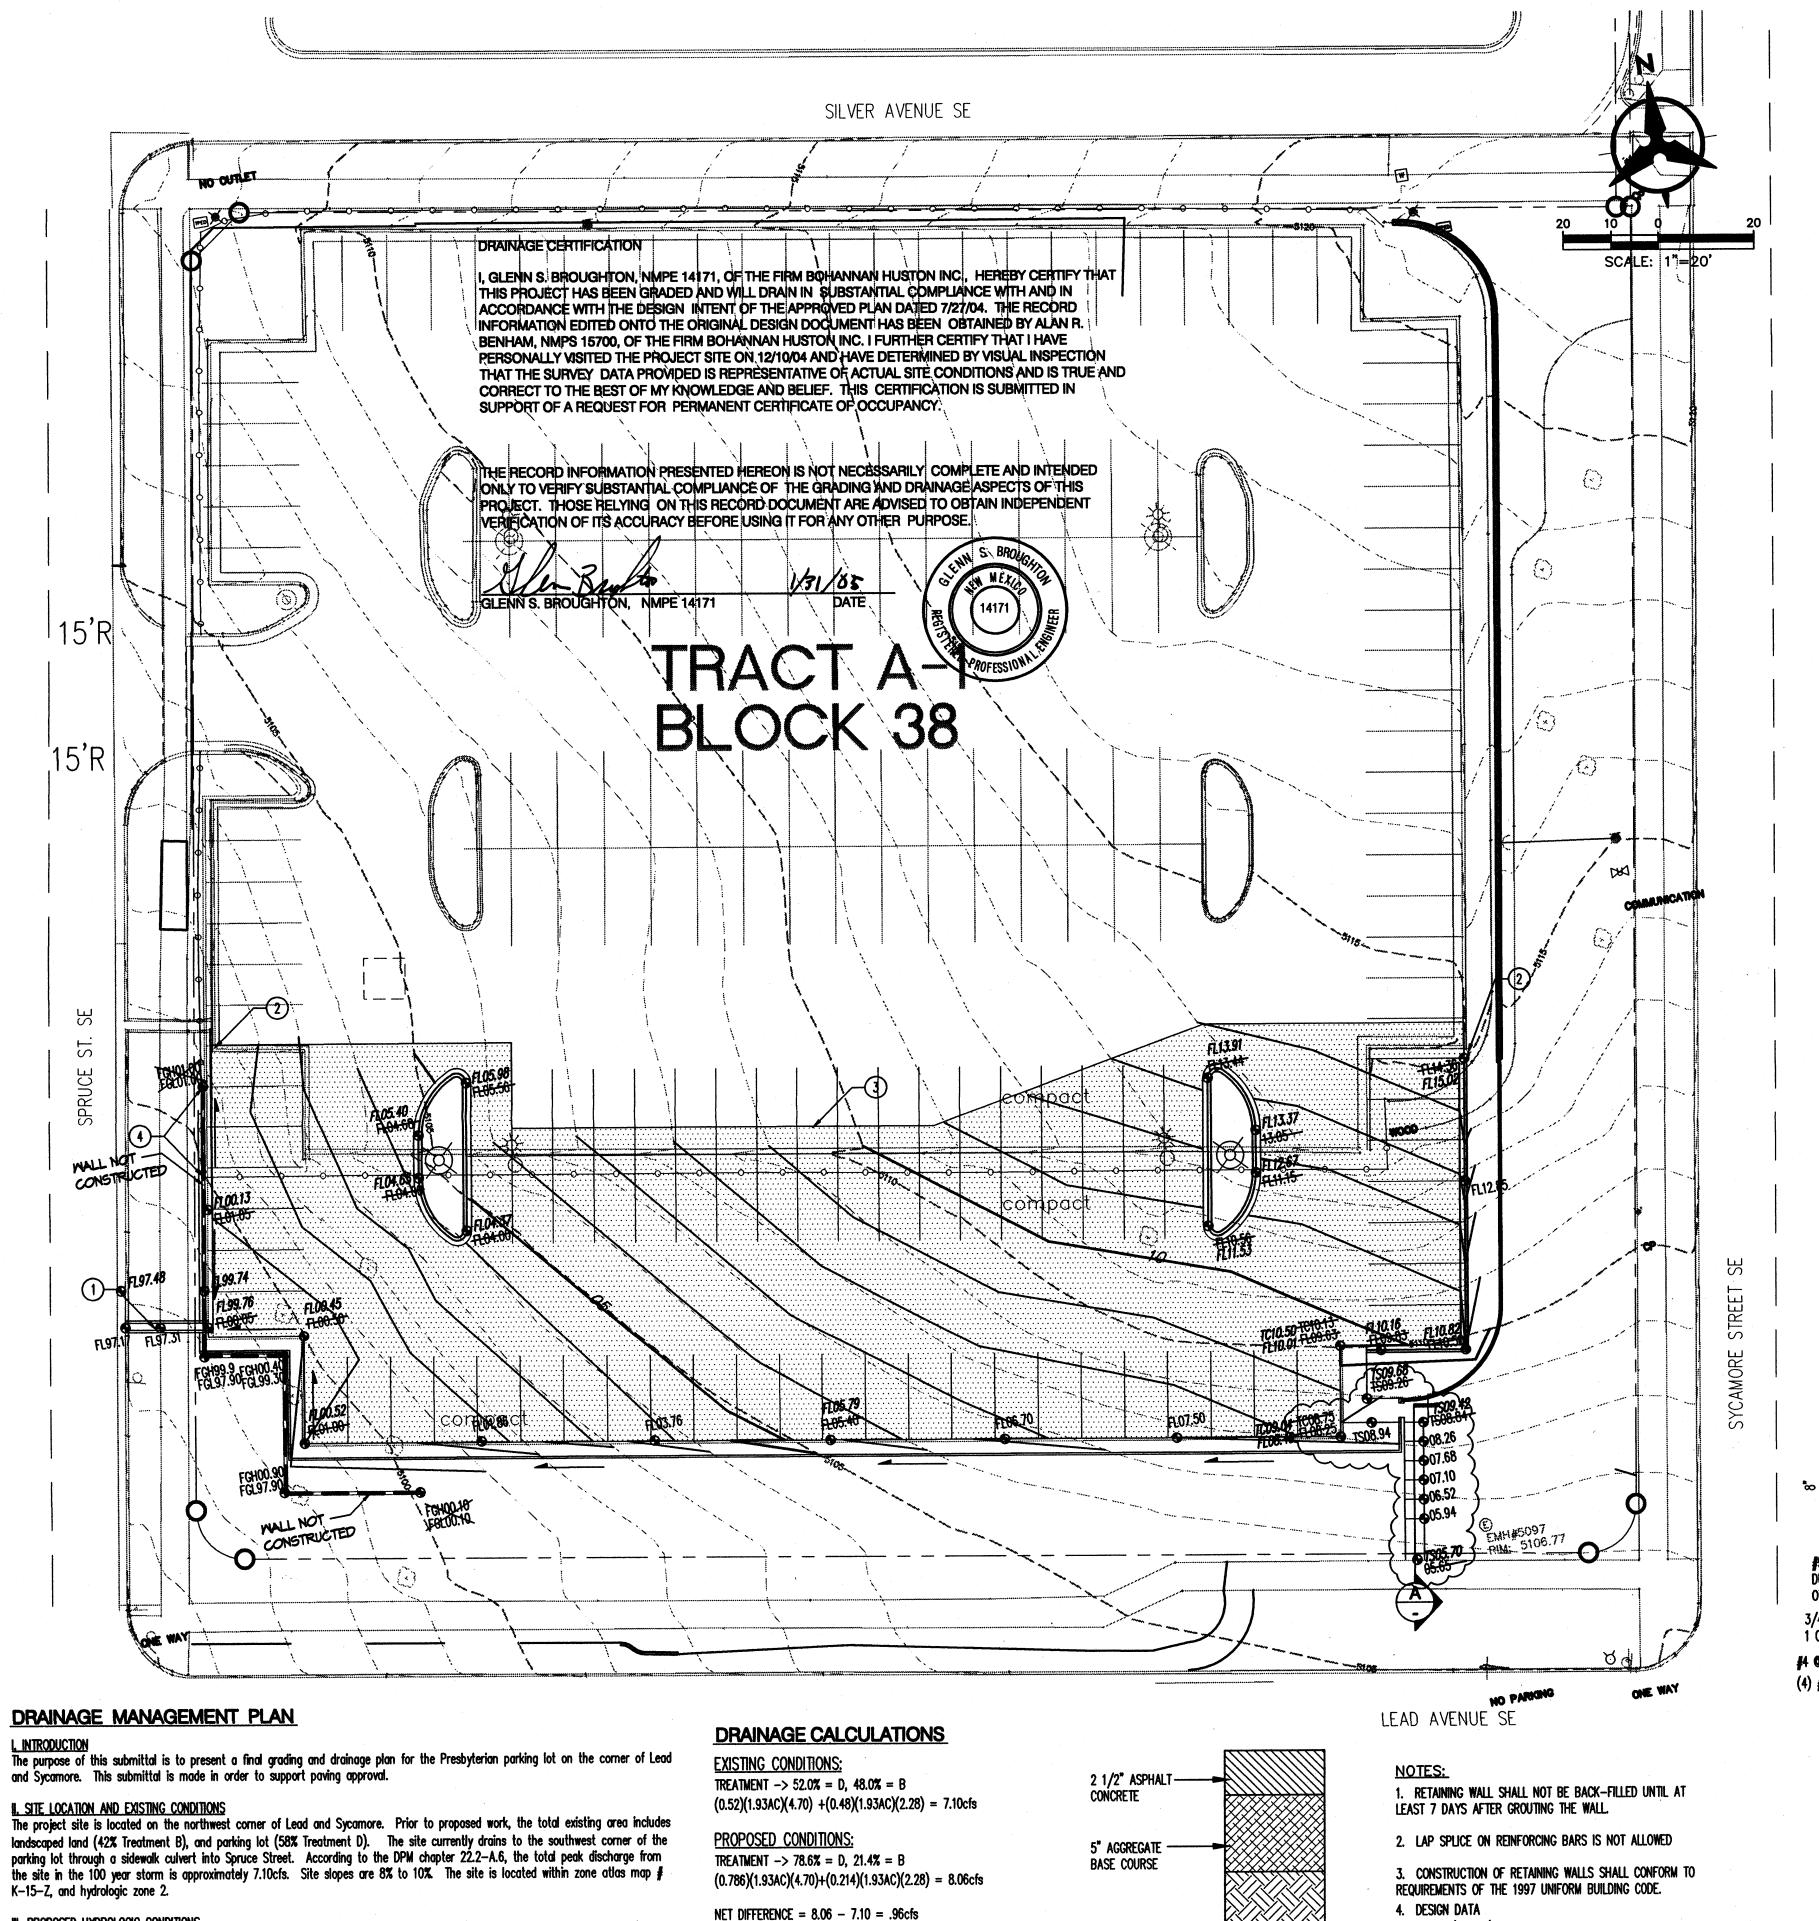

GENERAL NOTES

1. ALL WORK DETAILED ON THESE PLANS AND PERFORMED UNDER THIS CONTRACT SHALL BE CONSTRUCTED IN ACCORDANCE WITH THE PROJECT SPECIFICATIONS AND THE PROJECT GEOTECHNICAL REPORT. WHERE APPLICABLE, CITY OF ALBUQUERQUE

. The contractor shall abide by all local, state, and federal laws, rules and regulations which apply to THE CONSTRUCTION OF THESE IMPROVEMENTS, INCLUDING EPA REQUIREMENTS WITH RESPECT TO STORM WATER DISCHARGE.

3. PRIOR TO CONSTRUCTION, THE CONTRACTOR SHALL FIELD VERIFY THE HORIZONTAL AND VERTICAL LOCATIONS OF ALL POTENTIAL OBSTRUCTIONS INCLUDING ALL UNDERGROUND UTILITIES. SHOULD A CONFLICT EXIST, THE CONTRACTOR SHALL NOTIFY THE CONSTRUCTION OBSERVER OR ENGINEER SO THAT THE CONFLICT CAN BE RESOLVED WITH A MINIMUM AMOUNT OF

4. TWO (2) WORKING DAYS PRIOR TO ANY EXCAVATION, THE CONTRACTOR SHALL CONTACT LINE LOCATING SERVICE FOR LOCATION OF EXISTING UTILITIES.

5. ALL ELECTRICAL, TELEPHONE, CABLE TV, GAS AND OTHER UTILITY LINES, CABLES, AND APPURTENANCES ENCOUNTERED DURING CONSTRUCTION THAT REQUIRE RELOCATION, SHALL BE COORDINATED WITH THAT UTILITY. THE CONTRACTOR SHALL BE responsible for coordination of all necessary utility adjustments. No additional compensation will be allowed FOR DELAYS OR INCONVENIENCES CAUSED BY UTILITY COMPANY WORK CREWS. THE CONTRACTOR MAY BE REQUIRED TO reschedule his activities to allow utility crews to perform their required work.

6. THE CONTRACTOR IS RESPONSIBLE FOR PROTECTING ALL EXISTING UTILITY LINES WITHIN THE CONSTRUCTION AREA. ANY damage to existing facilities caused by construction activity shall be repaired or replaced at the contractor's EXPENSE AND APPROVED BY THE CONSTRUCTION OBSERVER.

7. CONSTRUCTION ACTIVITY SHALL BE LIMITED TO THE PROPERTY AND/OR PROJECT LIMITS. ANY DAMAGE TO ADJACENT Properties resulting from the construction process shall be repaired or replaced at the contractor's

8. OVERNIGHT PARKING OF CONSTRUCTION EQUIPMENT SHALL NOT OBSTRUCT DRIVEWAYS OR DESIGNATED TRAFFIC LANES. THE CONTRACTOR SHALL NOT STORE ANY EQUIPMENT OR MATERIAL WITHIN THE PUBLIC RIGHT-OF-WAY.

9. THE CONTRACTOR SHALL OBTAIN ALL THE NECESSARY PERMITS FOR THE PROJECT PRIOR TO COMMENCING CONSTRUCTION (I.E., BARRICADING, TOPSOIL DISTURBANCE, EXCAVATION PERMITS, EPA STORM WATER PERMITS, ETC.).

10. ALL PROPERTY CORNERS DESTROYED DURING CONSTRUCTION SHALL BE REPLACED AT THE CONTRACTOR'S EXPENSE. ALL Property Corners must be reset by a registered land surveyor. 11. THE CONTRACTOR SHALL PREPARE A CONSTRUCTION TRAFFIC CONTROL AND SIGNING PLAN AND OBTAIN APPROVAL OF

WORK ON OR ADJACENT TO EXISTING STREETS. 12. ALL BARRICADES AND CONSTRUCTION SIGNING SHALL CONFORM TO APPLICABLE SECTIONS OF THE "MANUAL ON UNIFORM"

TRAFFIC CONTROL DEVICES" (MUTCD), US DEPARTMENT OF TRANSPORTATION, LATEST EDITION.

SUCH PLAN FROM THE CITY OF ALBUQUERQUE, TRAFFIC ENGINEERING DEPARTMENT, PRIOR TO BEGINNING ANY CONSTRUCTION

13. THE CONTRACTOR SHALL MAINTAIN ALL CONSTRUCTION BARRICADES AND SIGNING AT ALL TIMES. THE CONTRACTOR SHALL VERIFY THE PROPER LOCATION OF ALL BARRICADING AT THE END AND BEGINNING OF EACH DAY.

14. THE CONTRACTOR SHALL TAKE ALL STEPS NECESSARY TO CONFORM WITH EPA REQUIREMENTS, INCLUDING COMPLIANCE WITH NPDES PHASE 2 REQUIREMENTS.

GRADING NOTES

1. EXCEPT AS PROVIDED HEREIN, GRADING SHALL BE PERFORMED AT THE ELEVATIONS AND IN ACCORDANCE WITH THE DETAILS SHOWN ON THIS PLAN.

2. THE COST FOR REQUIRED CONSTRUCTION DUST AND EROSION CONTROL MEASURES SHALL BE INCIDENTAL TO THE PROJECT COST.

3. ALL WORK RELATIVE TO FOUNDATION CONSTRUCTION, SITE PREPARATION, AND PAVEMENT INSTALLATION, AS SHOWN ON THIS PLAN, SHALL BE CONSTRUCTED IN ACCORDANCE WITH THE "GEOTECHNICAL INVESTIGATION," AS PROVIDED BY THE ARCHITECT OR OWNER. ALL OTHER WORK SHALL, UNLESS OTHERWISE STATED OR PROVIDED FOR HEREON, BE CONSTRUCTED IN ACCORDANCE WITH THE PROJECT, (FIRST PRIORITY) SPECIFICATIONS, AND/OR THE CITY OF ALBUQUERQUE (COA) STANDARD SPECIFICATIONS FOR PUBLIC WORKS (SECOND PRIORITY).

4. EARTH SLOPES SHALL NOT EXCEED 3 HORIZONTAL TO 1 VERTICAL UNLESS SHOWN OTHERWISE.

5. IT IS THE INTENT OF THESE PLANS THAT THIS CONTRACTOR SHALL NOT PERFORM ANY WORK OUTSIDE OF THE PROPERTY BOUNDARIES EXCEPT AS REQUIRED BY THIS PLAN.


6. THE CONTRACTOR IS TO ENSURE THAT NO SOIL ERODES FROM THE SITE ONTO ADJACENT PROPERTY OR PUBLIC RIGHT-OF-WAY. THIS SHOULD BE ACHIEVED BY CONSTRUCTING SILT FENCE S OR TEMPORARY BERMS AT THE PROPERTY LINES.

7. A DISPOSAL SITE FOR ANY & ALL EXCESS EXCAVATION MATERIAL, AND UNSUITABLE MATERIAL AND/OR A BORROW SITE CONTAINING ACCEPTABLE FILL MATERIAL SHALL BE OBTAINED BY THE CONTRACTOR IN COMPLIANCE WITH APPLICABLE ENVIRONMENTAL REGULATIONS AND APPROVED BY THE OBSERVER. ALL COSTS INCURRED IN OBTAINING A DISPOSAL OR BORROW SITE AND HAUL TO OR FROM SHALL BE CONSIDERED INCIDENTAL TO THE PROJECT AND NO SEPARATE MEASUREMENT OR PAYMENT SHALL BE MADE.


8. PAVING AND ROADWAY GRADES SHALL BE +/- 0.1' FROM PLAN ELEVATIONS. PAD ELEVATION SHALL BE +/- 0.05' FROM BUILDING PLAN ELEVATION.

9. ALL PROPOSED CONTOURS REFLECT TOP OF PAVEMENT ELEVATIONS IN THE PARKING AREA AND MUST BE ADJUSTED FOR MEDIANS AND ISLANDS.

10. VERIFY ALL ELEVATIONS SHOWN ON PLAN FROM BASIS OF ELEVATION CONTROL STATION PRIOR TO BEGINNING CONSTRUCTION.

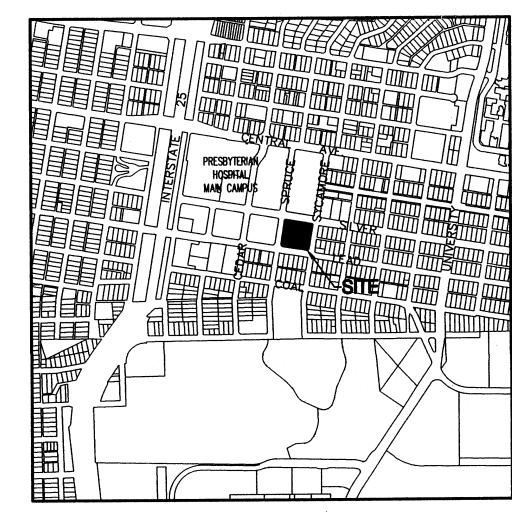

VICINITY MAP ZONE ATLAS PAGE K-15-Z

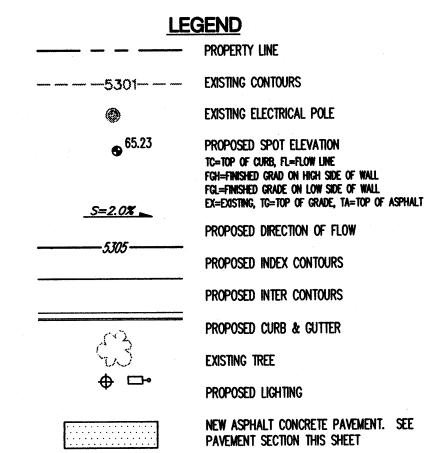

NOTICE TO CONTRACTORS (SO 19)

1. AN EXCAVATION/CONSTRUCTION PERMIT WILL BE REQUIRED BEFORE BEGINNING ANY WORK WITHIN THE CITY RIGHT-OF-WAY. AN APPROVED COPY OF THESE PLANS MUST BE SUBMITTED AT THE TIME OF APPLICATION FOR THIS PERMIT.

2. ALL WORK DETAILED ON THESE PLANS TO BE PERFORMED, EXCEPT AS OTHERWISE STATED OR PROVIDED HEREON, SHALL BE CONSTRUCTED IN ACCORDANCE WITH CITY OF ALBUQUERQUE STANDARD SPECS FOR PUBLIC WORKS CONSTRUCTION, 1986.


3. TWO WORKING DAYS PRIOR TO ANY EXCAVATION, CONTRACTOR MUST CONTACT LINE LOCATION SERVICE, 765-1234, FOR LOCATION OF EXISTING UTILITIES.

4. PRIOR TO CONSTRUCTION, THE CONTRACTOR SHALL EXCAVATE AND VERIFY THE HORIZONTAL AND VERTICAL LOCATIONS OF ALL OBSTRUCTIONS. SHOULD A CONFLICT EXIST, THE CONTRACTOR SHALL NOTIFY THE ENGINEER SO THAT THE CONFLICT CAN BE RESOLVED WITH A MINIMUM AMOUNT OF DELAY.

5. BACKFILL COMPACTION SHALL BE TO ARTERIAL STREET USE. 6. MAINTENANCE OF THESE FACILITIES SHALL BE THE RESPONSIBILITY OF THE OWNER

OF THE PROPERTY SERVED.

PRIVATE DRAINAGE FACILITIES WITHIN CITY RIGHT-OF-WAY

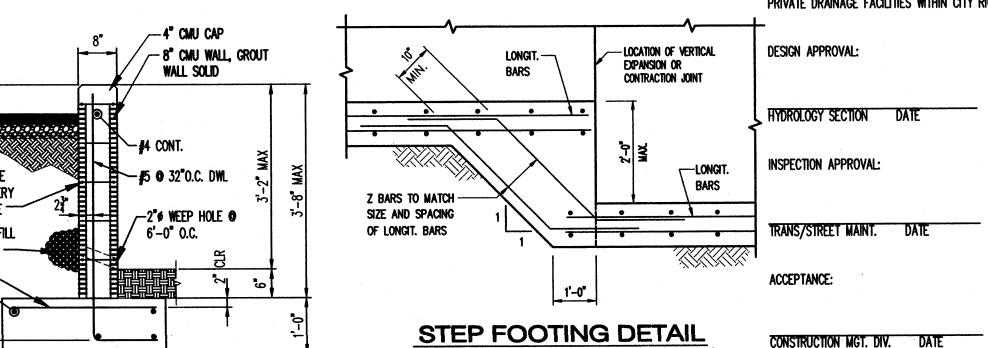

CHAINLINK FENCE POST SLEEVE

GRADING & DRAINAGE KEYED NOTES

1. INSTALL 24" WIDE SIDEWALK CULVERT/CONCRETE RIBBON CHANNEL AS PER CITY OF ALBUQUERQUE STD DWG. 2236. SPECIAL SO-19 PERMIT AND INSPECTION REQUIRED, SEE NOTICE TO CONTRACTOR, THIS SHEET

2. MATCH EXISTING CURB AND GUTTER HORIZONTAL AND VERTICAL

3. SAW CUT AND MATCH EXISTING PAVEMENT, SEE DETAIL THIS

4. INSTALL SLEEVE FOR CHAIN LINK FENCE PER DETAIL ON THIS

- CAP PLATE, 5 mm X 85 mm X 85 mm

Courtyard I 7500 Jefferson St. NE Albuquerque, NM 87109-4335 ENGINEERING . SPATIAL DATA . ADVANCED TECHNOLOGIES 2

architecture

6801 Jefferson NE

505 761-9700

fax 761-4222

dps @ dpsabq.com

Albuquerque, NM 87109

Suite 100

ARCHITECT

PROJECT

Sp

an

On

xpan

St

as Z

9

S

re

Park

ast

田

S

outh East Albuque

erque,


interiors

DRAWN BY MJB GSB REVIEWED BY DATE 11-21-05 PROJECT NO.

DRAWING NAME GRADING &

DRAINAGE PLAN JAN 3 1 2005

HYDROLOGY SECTION

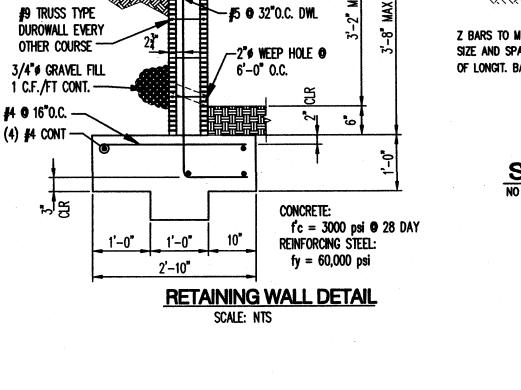

THE CONTRACTOR SHALL BE RESPONSIBLE TO SEE THAT ALL REBAR IS PROPERLY ALIGNED AND TIED IN PLACE BEFORE PLACING CONCRETE. ALL STEEL SHALL BE REINFORCEMENT ACCURATELY LOCATED AND SECURED IN PLACE SO THAT IT REMAINS IN POSITION DURING THE PLACEMENT OF THE CONCRETE. ANY REBAR IMPROPERLY INSTALLED SHALL BE REMOVED AT NO ADDITIONAL COST TO THE OWNER.

WEEP HOLES: PLACE A 2'x1' PIECE OF MIRAFI 140N FILTER FABRIC ON THE BACK OF WALL AT EACH WEEP LOCATION. OMIT HEAD JOINT ON BOTTOM TWO COURSES AT 48" O.C.

THE FIRST COURSE OF CMU BLOCK MAY BE PLACED IN FRESH FOOTING CONCRETE. SUBSEQUENT COURSES OF CMU BLOCK SHALL NOT BE PLACED UNTIL 7 DAYS AFTER THE FOOTING IS CAST.

10. ALL CMU BLOCK JOINTS SHALL BE TOOLED.

EFP (ACTIVE) = 36 PCF

EFP (PASSIVE) = 300 PCF

FEES ASSOCIATED WITH IT.

SOIL BEARING PRESSURE = 2000 PCF

CONCRETE F C (28 DAYS) = 3000 PSI

5. CONTRACTOR SHALL NOTIFY OWNER PRIOR TO CONCRETE FOOTING POUR FOR

INSPECTION OF COMPACTION UNDER FOOTING, FOOTING DEPTH AND WIDTH AND WALL

STEEL AND SPACING. FINAL INSPECTION OF FOOTING AND WALL WILL BE REQUIRED.

6. CONTRACTOR SHALL BE RESPONSIBLE FOR CODE ADMINISTRATION APPROVAL AND

REINFORCEMENT = 60 ASTM A-615

(1/3 INCREASE FOR WIND/ SEISMIC)

COEFFICIENT OF FRICTION = 0.35

8" SUBGRADE

PREPARATION

EX. SIDEWALK-

STAIR SECTION "A"

@ 95% MAXIMUM

PAVEMENT SECTION

III. PROPOSED HYDROLOGIC CONDITIONS

The proposed project consists of the addition of 74 new parking spaces to the south side of the existing parking lot. A new

There are no upstream offsite flows which will impact this site. In addition, the site will not have any detrimental impact on

The improvements proposed with this final grading and drainage plan are capable of safely passing the 100 year storm and meet city

treatment B which will generate a peak discharge of 8.06cfs in the 100 year storm (DPM chapter 22-A.6).

downstream drainage infrastructure since proposed conditions discharge is slightly more than existing.

The total discharge to adjacent public streets under proposed conditions is 0.96cfs more than existing peak flows.

sidewalk culvert will be installed in the southwest corner of the parking lot to aid in properly draining the site. The site will still drain into Spruce Street. After completion of the proposed construction, 78.6% will be impervious and 21.4% will consist of land

requirements. With this submittal, we are seeking city hydrology approval for paving permit.