CITY OF ALBUQUERQUE

Planning Department Alan Varela, Director



Mayor Timothy M. Keller

March 22, 2024

Dave Aube Thompson Engineering Consultants,Inc P.O Box 65760 Albuquerque, NM 87193

Re: 2900 Central Project 2900 Central Ave. SE

Traffic Circulation Layout

Architect's Stamp 02-01-24 (K16-D009A)

Dear Mr. Aube,

The TCL submittal received 02-05-2024 is approved for Building Permit by Transportation. A copy of the stamped and signed plan will be needed for each of the building permit plans. Please keep the original to be used for certification of the site for final C.O. for Transportation.

PO Box 1293

When the site construction is completed and an inspection for Certificate of Occupancy (C.O.) is requested, use the original City stamped approved TCL for certification. Redline any minor changes and adjustments that were made in the field. A NM registered architect or engineer must stamp, sign, and date the certification TCL along with indicating that the development was built in "substantial compliance" with the TCL. Submit this certification, the TCL, and a completed <u>Drainage and Transportation Information Sheet</u> to front counter personnel for log in and evaluation by Transportation. **CONDITION FOR RELEASING THE FINAL CO: AN APPROVED REVOCABLE PERMIT FOR THE EXISTING SIGN (KEYNOTE 35).**

Albuquerque

NM 87103

Once verification of certification is completed and approved, notification will be made to Building Safety to issue Final C.O. To confirm that a final C.O. has been issued, call Building Safety at 924-3690.

www.cabq.gov

Sincerely,

Ernest Armijo, P.E.

Principal Engineer, Planning Dept. Development Review Services

C: CO Clerk, File

TRAFFIC CIRCULATION

LAYOUT APPROVED

Ernest armijo 3/22/2024

PERMENANT SIDEWALK EASEMENT

FILED: MAY 31, 1994 VOLUME 94C, FOLIO 177

WALL CORNER AT PROPERTY LINE

50.19'

-CONCRETE



CONSULTANT

STAMP

TCL GENERAL NOTES

I. SEE SHEET CG01 FOR COMPLETE LIST OF GENERAL NOTES AND SYMBOL/LINETYPE LEGEND THAT APPLY TO ALL SHEETS.

TCL KEYED NOTES

- 1. CONCRETE VALLEY GUTTER PER DETAIL C4C501
- 2. CONCRETE CUT OFF WALL PER DETAIL A5/C501. CONCRETE HEADER CURB, 6" TALL, PER DETAIL A5/C501.
- 4. CONCRETE CURB ACCESS RAMP PER DETAIL A1/C501. 5. CONCRETE SIDEWALK PER DETAIL C1/C501
- 6. CONCRETE SIDEWALK PER COA STD DWG 2430. 7. STANDARD CONCRETE CURB AND GUTTER PER COA STD DWG
- 8. STANDARD 6" CONCRETE CURB AND GUTTER PER DETAIL
- 9. 6" DEPRESSED CURB AND GUTTER PER DETAIL A5/C501.
- 10. TURN DOWN EDGE SIDEWALK PER DETAIL C2/C501.
- 11. ASPHALT PAVEMENT PER DETAIL D2/C501. 12. GRAVEL PAVE 2 PAVEMENT PER DETAIL C1/C502.
- 13. LANDSCAPED AREA. REFER TO LANDSCAPING PLANS 14. PAINT CURB RED WITH 6" TALL LETTERS READING "NO PARKING
- FIRE LANE". 15. CURB ACCESS RAMP PER COA STD DETAIL 2443.
- 16. PAINT CURB YELLOW WHERE HEIGHT IS BETWEEN $\frac{1}{4}$ " AND 6"
- 17. ADA RESERVED PARKING STALL, PER DETAIL A1/C502.
- 18. RESERVED PARKING SYMBOL PER DETAIL A3/C502. 19. ADA RESERVED PARKING SIGN MOUNTED PER DETAIL A4/C502M
- B4/C502, AND C3/C502. 20. ADA VAN ACCESSIBLE RESERVED SIGN MOUNTED PER DETAIL C3/C502, A4/C502 AND B4/C502.
- 21. 12"X18" "MOTORCYCLE PARKING ONLY" MOUNTED PER DETAIL
- 22. CONCRETE PARKING BLOCK PER DETAIL B3/C502.
- 23. STRIPED UNLOADING ZONE PER DETAIL A1/C502. 24. 5' WIDE CONCRETE SIDEWALK CULVERT PER DETAIL B3/C501.
- 25. 4'-4" BY 4'-4" SPLASH BLOCK, 3" TO 6" COBBLES WIRE TIED PER DETAIL B4/C501 AND COA STD DWG 2270.
- 26. 6' TALL CAST IN PLACE CONCRETE WALL PER ARCHITECTURAL
- ELEVATION AND STRUCTURAL DETAILS. 27. FIRE DEPARTMENT KNOX BOX.
- 28. STORM WATER RETENTION POND, SEE GRADING PLANS.
- 29. NATURAL GAS METER OR REGULATOR SEE UTILITY PLANS.
- 30. CONCRETE DRIVEPAD PER COA STANDARD DRAWING 2425A. 31. EXISTING CONCRETE SIDEWALK TO REMAIN.
- 32. EXISTING CURB ACCESS RAMP TO REMAIN. 33. BIKE RACK PER DETAIL C4/C502.
- 34. EXISTING CURB AND GUTTER TO REMAIN.
- 35. EXISTING PYLON SIGN TO REMAIN.
- 36. EXISTING NOB HILL GATEWAY SIGN BASE TO REMAIN.
- 37. EXISTING REFUSE ENCLOSURE, GATES AND CONCRETE APRON TO REMAIN. PROTECT DURING CONSTRUCTION.
- 38. PROVIDE 1' WIDE LANDSCAPING STRIP ALONG PATIO SCREEN WALL. (NOT USED)
- 39. 12" TALL PAINTED LETTERS ON CONCRETE "MC". 40. 6" THICK CONCRETE PAVEMENT PER DETAIL D4/C501.
- 41. BRASS CAPS TO BE INSTALLED INTO TOP OF CONCRETE CUT OFF WALL, TOP OF TURNDOWN SIDEWALK, OR FACE OF THE
- HEADER CURB TO IDENTIFY PARKING STALL 42. CONCRETE CURB ACCESS RAMP PER COA STD DWG 2441 AND

Parkland Hills Inc.


2900 Central Ave SE

Albuquerque, New Mexico

PERMIT SET

PROJECT NAME

2900 Central Project

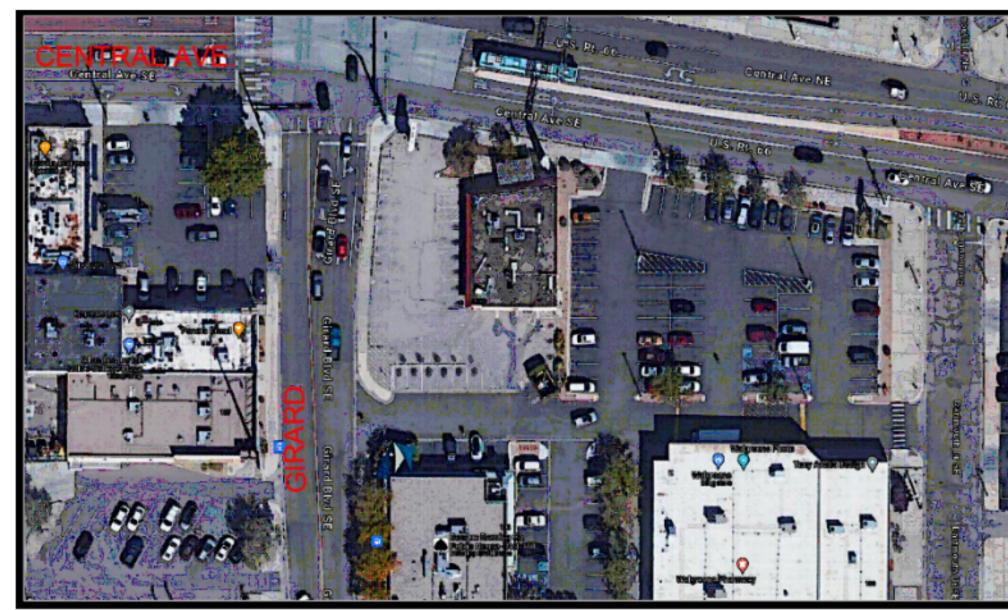

AERIAL OF ACCESS ROUTES SCALE: NOT TO SCALE



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onsultants, Inc.

PHONE: (505) 271-2199

tecnm@yahoo.com

DESCRIPTION Copyright: Design Group

12-1-2023 Project number

2594

SHEET TITLE

REVISIONS

Traffic Circulation Layout

SHEET NUMBER

P.O. BOX 65760 ALBUQUERQUE, NM 87 193 FAX: (505) 830-9248

-FOUND PK NAIL

WITH DISC

- DUMPSTER WALL

ENCROACHES BY ±0.23'

WALGREENS AREA 17,544 SF. STANDARD 3.5 spaces / 1000 GSF (General Retail) UC-MS-PT 1.75 spaces / 1000 GSF (General Retail)

SHARED PARKING WITH ADJACENT DEVELOPMENT

Table 5-5-1, IDO July, 2023 Required spaces: 17,544 GSF/1000=5.12 x 3.5 = 61.4; per 5-5(C)(1)(c) round down to 61 spaces

Only 31 required utilizing UC-MS-PT.

AVAILABLE PARKING 81 STALLS. (65 in front of building and 16 spaces behind building for employees and overflow).

TRAFFIC CIRCULATION LAYOUT

24' PRIVATE EASEMENT FOR PUBLIC ACCESS

FILED: MAY 31, 1994

VOLUME 94C, FOLIO 177

(100.95')

(N 89°46'53" W)

TRACT C-1

LANDS OF PARKLAND HILLS INC.

100.95

drainage, waterline and sanitary sewer ——

PROPOSED

0.3981 ACRES

FF=5195.17

DISTANCE TO PL

ZERO LOT LINE

VARIES. TREATED AS

SIGN ENCROACHES -

INTO RIGHT-OF-WAY

TRAFFIC LIGHT-

RAMP —___

VAULT

SET NAIL & DISC-

STAMPED PS 11463

Landscaping and signage will not interfere with

measured from the gutter pan) will not be acceptable in the clear sight triangle

AREA CALCULATIONS IN GROSS SF

SUITE A

SUITE B

Patio

Heated 1650 GSF

Heated 1965 GSF

Patio 0333 GSF

TOTAL 4,851 GSF

PARKING CALCULATIONS

Table 5-5-1, IDO July 2023

5-5(C)(1)(c) round down to 16 spaces

16 spaces - 5 = 11 spaces required.

11 spaces - 2 = 9 spaces required.

SPACES REQUIRED: 16 - 5 - 2 = 9

SPACES PROVIDED: 12 + 2 + 3 = 17

1. 900 feet from A.R.T. Stop (qualifies for PT).

electric vehicle charging station.

UC-MS-PT 5 spaces / 1000 GSF (Restaurant)

0.3x16=4.8. Per 5-5(C)(1)(d)(1) round up to 5.

0.1x16=1.6. Per 5-5(C)(1)(d)(1) round up to 2.

Required spaces: 4,851 GSF/1000=4.85 x 5 = 16.97; per

LESS 30% Reduction for proximity to transit per 5-5(C)(5)(c)(1):

LESS 10% Reduction for proximity to transit per 5-5(C)(5)(c)(2):

ELECTRIC VEHICLE CHARGING STATION CREDIT per 5-5(C)(6)(a): Four (4) extra spaces as credit for two 2-car

One (1) = MOTORCYCLE SPACE REQUIRED per 5-5(D) & PROVIDED

ON-STREET PARKING CREDIT per 5-5(C)(6)(d): 3

Three (3) = BICYCLE SPACES REQUIRED per 5-5(E)

0903 GSF

2,553 GSF

2,298 GSF


clear sight requirements. Therefore, signs, walls, trees, and shrubbery between 3 and 8 feet tall (as

CLEAR SIGTH TRIANGE

TRAFFIC CIRCULATION LAYOUT APPROVED



CONSULTANT

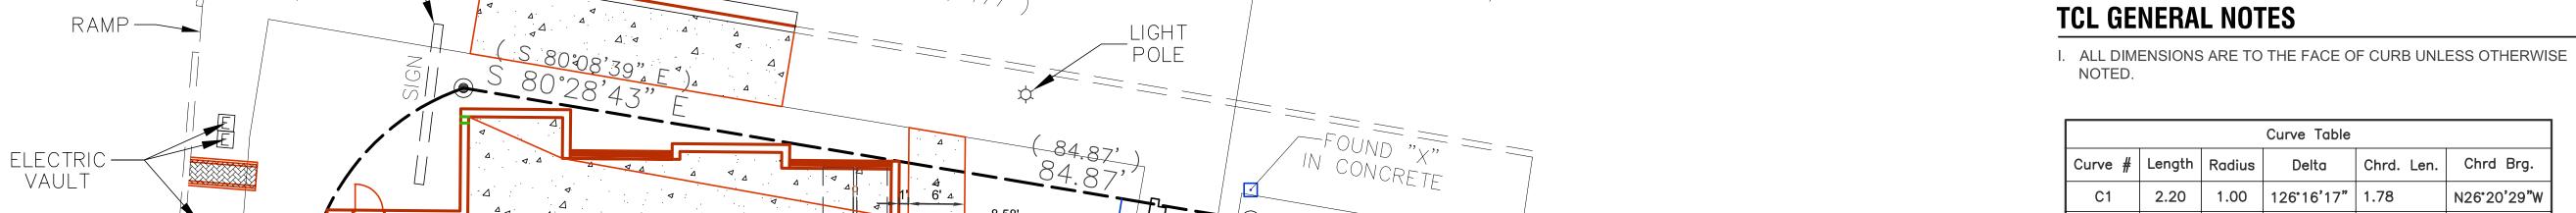

PERMENANT SIDEWALK EASEMENT FILED: MAY 31, 1994 VOLUME 94C, FOLIO 177

DUMPSTER WALL ENCROACHES BY ±0.23'

FOUND PK NAIL

WITH DISC

Curve Table C1 2.20 1.00 126'16'17" 1.78 N26'20'29"W C2 9.34 10.00 53°30′59" 9.00 N63'33'08"E C3 3.14 2.00 90°00'00" 2.83 S16'56'29"W C4 4.71 3.00 89°57'14" 4.24 N44°59'14"W C5 3.30 2.00 94°29'26" 2.94 S47°14'06"W C6 | 13.22 | 10.00 | 75°46'18" | 12.28 N47°38'02"W C7 2.22 26.00 4°53'41" 2.22 N12°11'43"W N37°40'25"E C9 | 10.72 | 10.00 | 61°25'03" | 10.21 S31°13'58"W C10 | 15.71 | 10.00 | 89°59'56" | 14.14 S45°31'24"W C11 9.42 3.00 180°00'00" 6.00 N0'31'22"E C12 9.42 3.00 180°00'00" 6.00 C13 | 15.71 | 10.00 | 90°00'04" | 14.14 C14 | 10.48 | 10.00 | 60°01'35" | 10.00 C15 2.09 1.00 119°58'23" 1.73 N29'29'22"W

Line Table		
Line #	Length	Direction
L1	33.58	S80° 21' 51"E
L2	33.20	N4° 15' 59"E
L3	17.96	N0° 20' 36"E
L4	24.65	NO° 04' 17"E
L5	42.00	S89° 59' 23"W
L6	15.98	S0° 00' 37"E
L7	22.00	S89° 41' 22"E
L8	0.97	S35° 01' 30"E
L10	9.74	N89° 28' 38"W
L11	34.22	N0° 33' 39"E
L12	8.58	N89° 29' 55"W
L13	6.01	S0° 31' 26"W
L14	8.58	N89° 28' 24"W
L15	9.42	N89° 28' 43"W
L16	34.00	S0° 31' 26"W
L17	25.00	N0° 31' 26"E
L18	16.08	S0° 31' 26"W
L19	16.40	N89° 28' 34"W
L20	76.00	N0° 31' 26"E
L21	1.98	N89° 57' 50"W
L23	14.98	NO° 00' 37"W
L25	46.64	N89° 57' 50"W
L29	52.52	N89° 59' 24"E
L30	14.41	S61° 56′ 29"W
L32	19.06	S0° 31' 26"W
L34	9.72	N89° 28' 38"W
L36	15.06	S89° 28' 38"E
L37	15.01	S89° 28' 38"E
L40	32.66	N0° 31' 26"E
L41	24.00	N89° 29' 55"W
L42	59.55	N89° 29' 57"W

L43 8.67 S89° 28' 34"E

L46 6.00 NO° 30' 05"E

L47 26.75 N89° 53' 03"E

STAMP



PERMIT SET PROJECT NAME 2900 Central Project

2900 Central Ave SE Albuquerque, New Mexico

Parkland Hills Inc.

REVI	SIONS	
NO.	DATE	DESCRIPTI
Copyrigh	nt: Design Grou	p
Drawn b	у	
Checked	by	
Date		12-1-
Project n	umber	

SHEET TITLE

SHEET NUMBER

Circulation

Layout

TCL2

 $T_{ ext{hompson}}$ $E_{ ext{ngineering}}$ tecnm@yahoo.com PHONE: (505) 271-2199 P.O. BOX 65760 ALBUQUERQUE, NM 87 193 FAX: (505) 830-9248



TRAFFIC CIRCULATION LAYOUT

<u>L23</u>

PROPOSED

FF=5195.17

TRACT B-1

0.3981 ACRES

24' PRIVATE EASEMENT FOR PUBLIC ACCESS

FILED: MAY 31, 1994 VOLUME 94C, FOLIO 177

(100.95') 100.95'

N 89°53'03" W (N 89°46'53" W)

TRACT C-1 LANDS OF PARKLAND HILLS INC.

DRAINAGE, WATERLINE AND SANITARY SEWER —

SIGN ENCROACHES — INTO RIGHT—OF—WAY

TRAFFIC LIGHT-

SET NAIL & DISC — STAMPED PS 11463

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CONSULTANT

STAMP

PERMIT SET


PROJECT NAME

2900 Central Ave SE

Parkland Hills Inc.

Albuquerque, New Mexico

2900 Central Project

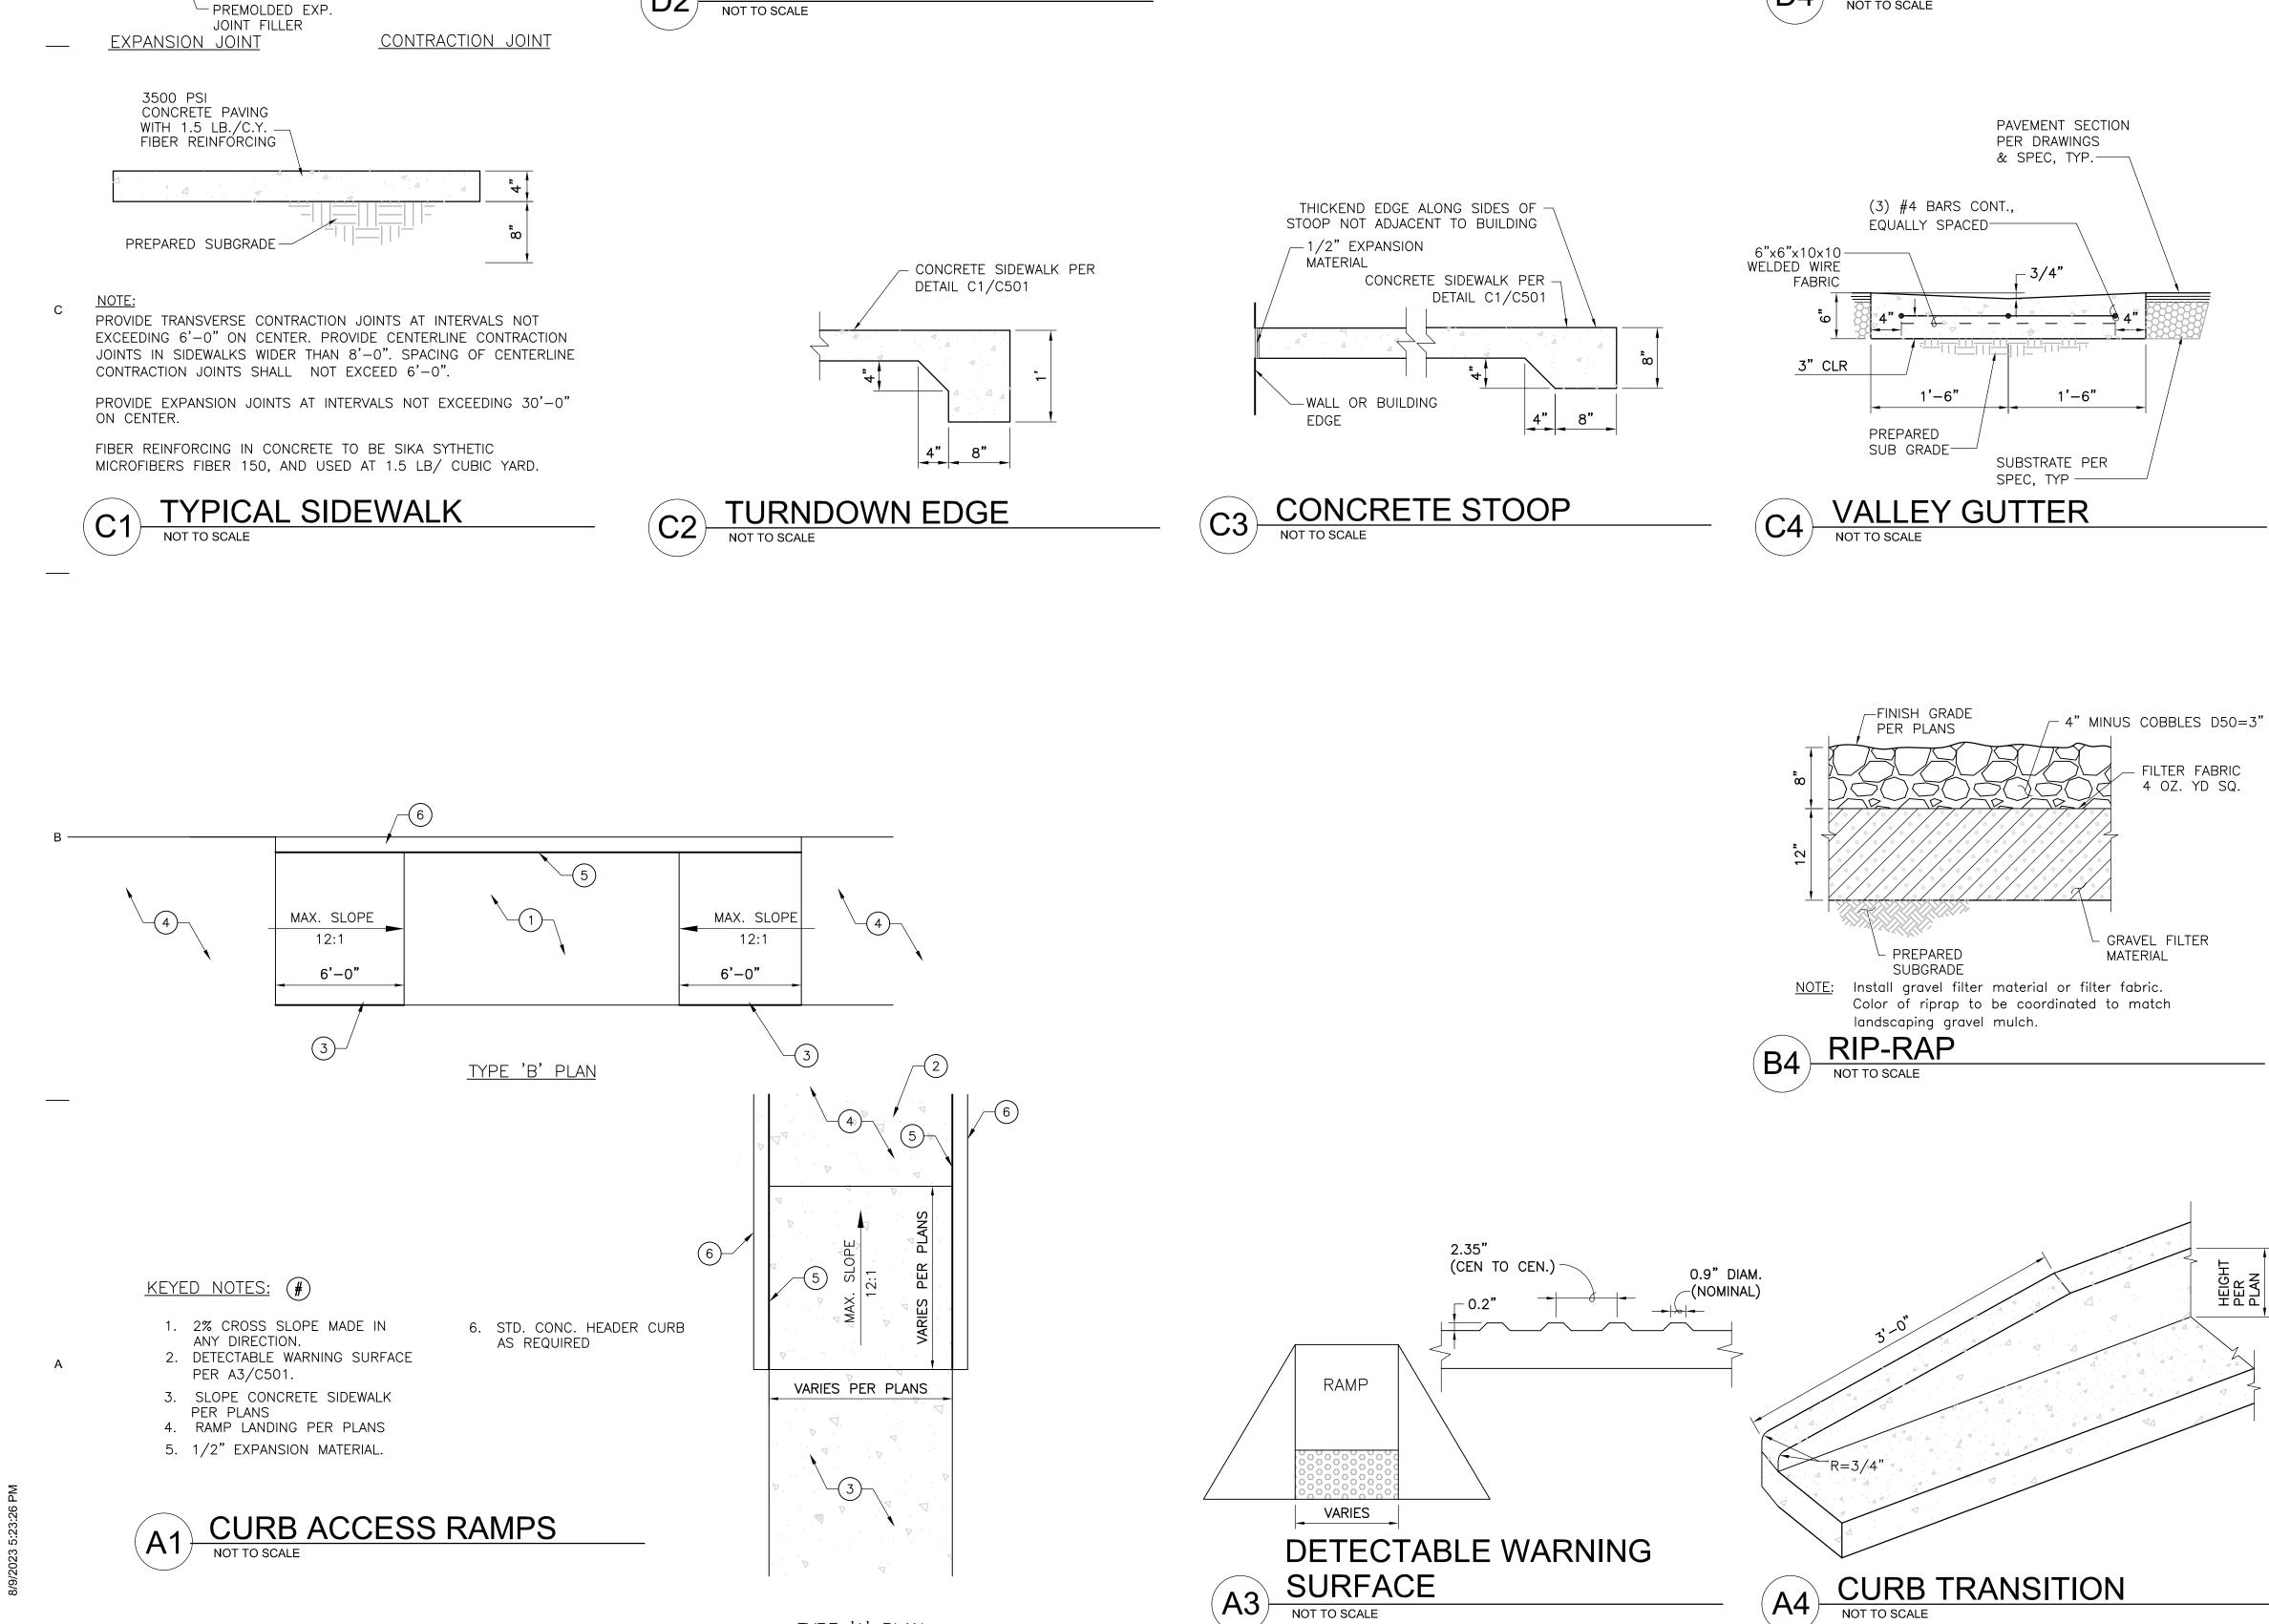

SURFACE

A3 SUKFA NOT TO SCALE

3" ASPHALT SURFACE COURSE COA SUPERPAVE TYPE C.

6" BASE COURSE

PER COA STANDARDS


- 12" COMPACTED SUB

MAIN ASPHALT

TYPE 'A' PLAN

GRADE (95% COMPACTION).

_ 6" COMPACTED SUB GRADE (90% COMPACTION).

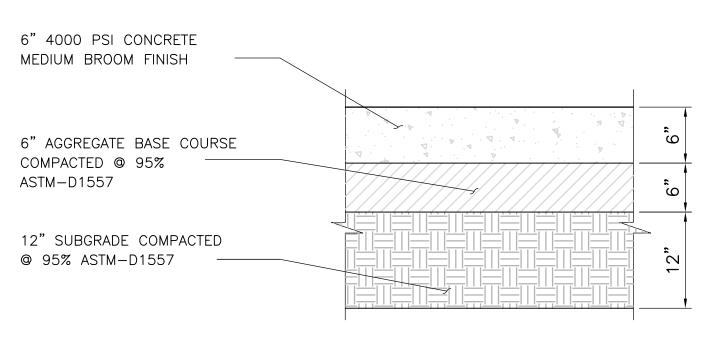


FILTER FABRIC 4 OZ. YD SQ.


HEIG PER PLAN


CONCRETE PAVEMENT NOT TO SCALE


TRAFFIC CIRCULATION LAYOUT APPROVED Ernest Ormijo 3/22/2024
Signed Date



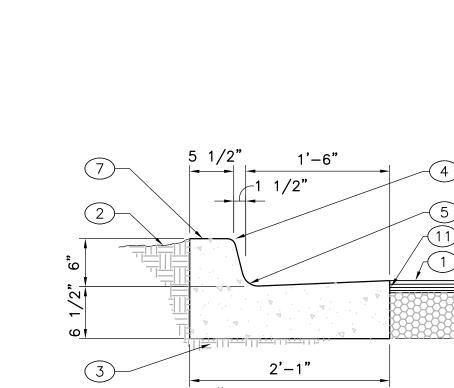

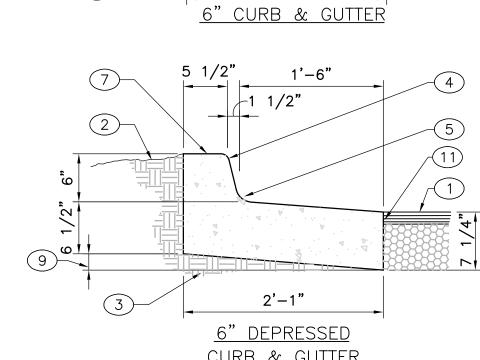

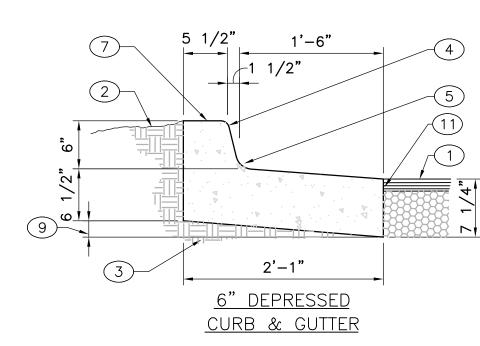

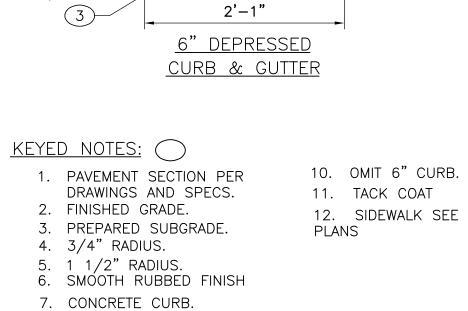



8. EXPANSION JOINT.


NEEDED.

9. VARIES, DEPRESS AS


- A. CURBS, GUTTERS & CUT-OFF WALLS TO BE CONSTRUCTED OF 3500 PSI P.C.C. UNLESS OTHERWISE NOTED. B. EDGES NOT SPECIFICALLY DIMENSIONED SHALL BE EDGED WITH A 3/8" EDGING TOOL. C. REMOVE & REPLACE 12" WIDE STRIP OF PAVEMENT BEYOND
- LIP OF GUTTER WHEN CONSTRUCTING CURB & GUTTER ADJACENT TO EXISTING A.C. PAVEMENT. D. DIMENSIONS AT ROUNDED CORNERS MEASURED TO
- INTERSECTION OF STRAIGHT LINES. E. FOR 6" CURB & GUTTER PROVIDE CONTROL JTS. @ 6' O.C. MAX, ALSO PROVIDE 1/2" EXPANSION JTS. AT 30' O.C. MAX, AT CURB RETURNS, & AT EACH SIDE OF DRIVEWAYS. F. FOR ALL OTHER CURBING PROVIDE CONTROL JOINTS @ 10' O.C., PROVIDE EXPANSION JOINTS @ 50' O.C. & ADJACENT TO



BUILDINGS AND WALLS.

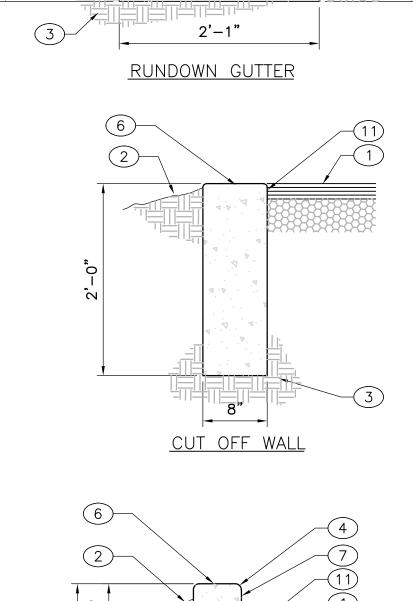

12

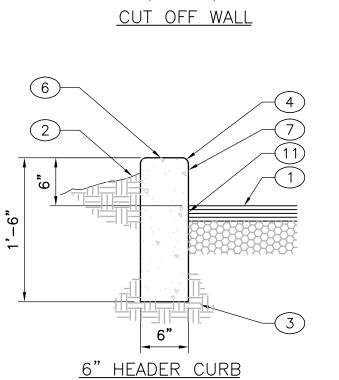

P.O. BOX 65760


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ALBUQUERQUE, NM 87 193 FAX: (505) 830-9248

Consultants, Inc.

PHONE: (505) 271-2199

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NO. DATE DESCRIPTION

12-1-2023

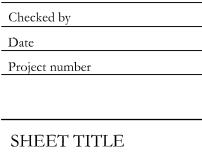2594


REVISIONS

Civil Details

SHEET NUMBER

CONSULTANT

STAMP

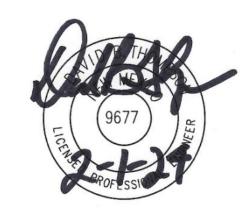

PERMIT SET PROJECT NAME

2900 Central Project

2900 Central Ave SE Albuquerque, New Mexico

Parkland Hills Inc.

LAYOUT APPROVED

BIKE RACK DETAIL SIGN TYPE R7-8 (12"×18") - sign field is white - sign lettering and border are green **ACCESSIBLE** - International Symbol of Accessibility BIKE RACK TO BE MOUNTED TO 8" FOOTING 18" DEEP is white on a blue background **PARKING** MINIMUM. SECURE RACK TO FOOTING WITH TAMPER PROOF ANCHORS. (5 -Optional Language Bottom of lowest sign 60" min. PLATE or PLACARD above the ground in parking lot REQUIRED Required language per ANSI 502.7 NMSA 197866-7-352.4C VIOLATORS ARE 84" min. for on-street parking SUBJECT TO A FINE and in the pedestrian path of AND/OR TOWING SIGN TYPE R7-8A (6"x12") -RESERVED PARKING SIGN travel per MUTCD Sec 2A.18 1/4" ACORN HEAD NUT — - sign field is white WITH 1" SPACER BETWEEN PLATE AND SIGN - sign lettering and border are green -4"x2"x1/8" HSS CAP TOP OF HSS VAN SPOT WELDED TO PLATE-Required language (Van Accessible Spaces) **ACCESSIBLE** ANSI 502.7 1/8" THICK PLATE-· 6 4"x2"x1/8" HSS RESERVED PARKING SIGNS PARKING VAN ACCESSIBLE WELD INSERTED -PLATE IN PLACE SIGN POST FOUNDATIONS 7' PARKING BUMPER W/SLOTTED BOTTOM PARKING SIGNS SIGNS SHOWN HERE ARE FOR ILLUSTRATION ONLY. PARKING BLOCK RESERVED PARKING SIGNS PER DETAIL A4/C-502. FINISHED GRADE

ADA COMPLIANT BLUE BACKGROUND

-WHITE TRAFFIC

PAINT ON ASPHALT

3'-9"

(A3) RESERVED SYMBOL NOT TO SCALE

CONCRETE 8"-**GENERAL NOTES:**

-DERO 'ROUND RACK' IN

SURFACE MOUNTED

SCHED. 10 PIPE, GALVANIZED,

1. SET POSTS IN CONCRETE TO A MINIMUM DEPTH OF 3'-0". USE 4"X 2" HSS FOR SIGN POSTS. FABRICATE SIGN PANELS OF .063 ALUMINUM. PAINT POST POSTAL BLUE, (MATTE FINISH). 2. LOCATE POSTS 1'-0" BACK FROM ADJACENT CURBS, UNLESS NOTED OTHERWISE.

A4 PARKING SIGN POST NOT TO SCALE

NO. DATE DESCRIPTION Copyright: Design Group Drawn by Checked by 12-1-2023 2594 Project number

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P.O. BOX 65760 PHONE: (505) 271-2199

ALBUQUERQUE, NM 87 193 FAX: (505) 830-9248

Consultants, Inc.

tecnm@yahoo.com

SHEET TITLE

REVISIONS

SHEET NUMBER

Civil Details



STANDARD

KEYED NOTES:

2. TYPICAL STANDARD ACCESSIBLE SPACE.

A 3. RESERVED PARKING SYMBOL PER DETAIL A3/C502.

DETAIL C3/C502.

C3/C502.

PER DETAIL A5/C501. 6. RESERVED PARKING SIGN PER

VAN ACCESSIBLE RESERVED PARKING SIGN PER DETAIL

PARKING STALL PARKI

ACCESSIBLE VAN

PARKING STALL

PER DETAIL A1/C501.

10. STANDARD PARKING STALL.

DETAIL B3/C502.

9. CONCRETE PARKING BLOCK PER

1. TYPICAL VAN ACCESSIBLE SPACE. 8. TYPICAL TYPE 'B' CURB RAMP,

4. 4" WIDE WHITE STRIPING (TYP.). 11. CONC. SIDEWALK, SEE PLANS
5. CONCRETE HEADER CURB AND DETAIL C1/C501.

SPECIFICATIONS

(20" X 20" X 1")

UNIT SIZE - 50 CM X 50 CM X 2.5 CM

STRENGTH - 402 KG/CM² (5720 PSI)

RECYCLED HDPE/LDPE

COLOR - GRANITE RESIN - 100% POST-CONSUMER

TENSILE - 120 LB/FT²(585 KG/M²)

— ADJACENT GRAVELPAVE2

BOTTOM OF GRAVELPAVE2

SNAP FIT FASTENERS

FILL RING SECTION WITH

-COMPACTED 3/16" TO 3/8"

GRAVEL PAVEMENT (GRAVEL PAVE 2)

COMPACTED SUBGRADE

- COMPACTED 3/16" TO 3/8"

GRAVELPAVE2 FILLED WITH 3/16" TO 3/8"

ANGULAR GRAVEL, UNIFORM SIZE, WASHED

ANGULAR GRAVEL, UNIFORM SIZE, WASHED

3/16" TO 3/8" ANGULAR GRAVEL, UNIFORM SIZE, WASHED

COLOR TO BE GRANITE

-8 6 -

I MAX___

ANGULAR GRAVEL, UNIFORM SIZE, WASHED

OPTIONS - CUSTOM FABRIC TO 6 OZ AVAILABLE.

AVAILABLE IN 9 STANDARD ROLL SIZES

50 CM (19.7")

8.3 CM (3.3")

2.3 CM (0.9")

6 CM (2.4")

ENLARGEMENT

16.7 CM (6.6") 25 CM (9.8")

OPTIONS - CUST AVAILAB GRAVELPAVE2 ADJACENT GRAV

Figure 23.6.3

RECIPROCAL EASEMENTS FOR COMMON ACCESS

This Easement Agreement is entered into between <u>PARKLAND HILLS, INC.</u>, owner of Tract A-1 Plat of Tracks A-1, B-1, & C-1 Lands of Parkland Hills Inc., being a replat of Tracks A, B, & C Lands of Parkland Hills Inc. containing 1.3742 acres M/L or 59,860 square feet M/L, City of Albuquerque, County of Bernalillo, State of New Mexico, and <u>PARKLAND HILLS, INC.</u>, owner of Tract B-1 Plat of Tracks A-1, B-1, & C-1 Lands of Parkland Hills Inc., being a Replat of Tracks A, B, & C Lands of Parkland Hills Inc. containing 0.3981 acres M/L or 17,341 square feet M/L, City of Albuquerque, County of Bernalillo, State of New Mexico.

The parties have an interest in adjoining real estate situated in the City of Albuquerque, County of Bernalillo, State of New Mexico and described as follows:

Track A-1 (2950 Central Avenue SE), and Track B-1 (2900 Central Avenue SE)

The parties desire to create a common access easement between the above-described adjoining tracks providing access, from a single access point on the abutting street, to said tracks owned by them for the benefit of each of them; therefore, agree as follows.

An easement for a common access in favor of Track B-1, owned by Parkland Hills, Inc., is created over the strip of land 50' (fifty feet) wide on the east side of the <u>west boundary line of Track A-1</u> from the Central Avenue Right of Way to the south boundary of Track B-1 (see attached Exhibit A), owned by Parkland Hills, Inc., for the purpose of creating a common access easement for the benefit of both of the above-described tracks.

This easement is superior and paramount to the rights of any of the parties hereto in the respective servient estates so created, and the parties further agree that it is a covenant that shall run with the land.

The maintenance of the easement areas are the responsibility of the respective property owners.

In witness whereof, the parties hereto have executed this agreement as follows:

swhorm arella.

ACKNOWLEDGED:

Date 22 March 2024

Anthony Anella, President

PARKLAND HILLS, INC.

November 09, 2025

