

Legal Description

LOTS NUMBERED FOUR (4), FIVE (5), SIX (6), SEVEN (7) AND EIGHT (8), IN BLOCK NUMBERED TWO (2) OF MANKATO PLACE, AN ADDITION TO THE CITY OF ALBUQUERQUE, NEW MEXICO.

1017-057-049-230-335-04

Drainage Calculations

Nob Hill Hotel

Hydrology Calculations DPM - Section 22.2 Volume 2, January 1993

Precipitation Zone 100 Year Storm Depth, P (360) 2.35

Treatment Area	A	В	С	D
Excess Precipitation Factors	0.53	0.78	1.13	2.12
Peak Discharge Factors	1.56	2.28	3.14	4.70
Land Treatment Area	Acres	Existing		Proposed
Type "D" (Roof)		0.34		0.34
Type "C" (Unpaved Roadway)		0.00		0.00
Type "B" (Irrigated Lawns)		0.02		0.02
Type "A" (Undeveloped)		0.00		0.00
Total (Acres)		0.36		0.36
Excess Precipitation(in)		2.05		2.05
Volume (100), cf		2673.13		2673.13
Volume (10),cf		1791.00		1791.00
Q (100), cfs		1.64		1.64
Q (10), cfs		1.10		1.10

#### Legend

5030	EXISTING CONTOUR
5030	NEW CONTOUR
30.11	NEW SPOT ELEVATION
(30.11)	EXISTING SPOT ELEVATION
TW	TOP OF WALL
BW	BOTTOM OF WALL
тс	TOP OF CURB
FL	FLOW LINE
FP	FINISH PAD ELEVATION
	DIRECTION OF FLOW

### Engineer's Statement

I, THE ENGINEER OF RECORD CERTIFY THAT I HAVE PERSONALLY VISITED THE SITE AND THE EXISTING GRADES AND CONTOURS DEPICTED ON THIS PLAN MATCH WHAT PRESENTLY EXISTS AT THIS LOCATION

MARTIN J, GARCIA, NMPE #11767

#### Drainage Narrative

THE SITE FOR THIS GRADING PLAN IS LOTS 4 THROUGH 8 BLOCK 2 OF THE MANKATO PLACE SUBDIVISION. THE SITE IS LOCATED ON THE SOUTH SIDE OF CENTRAL BOULEVARD JUST EAST OF CARLISLE BOULEVARD. THE SITE CONTAINS APPROXIMATELY 0.26 ACRES AND IS CURRENTLY OCCUPIED BY BUILDINGS AND PARKING LOTS. THE SITE IS THE FORMER SITE OF THE NOB HILL MOTEL.

WITH THIS DEVELOPMENT THE PARKING AREAS WILL UNDERGO SOME MINOR RE-GRADING IN ORDER TO COMPLY WITH CURRENT ADA AS SUCH WILL NOT SUBSTANTIALLY ALTERED. THE SITE CURRENTLY DRAINS INTO CENTRAL BOULEVARD. WITH THE ADDITION OF THE PLANTERS AS SHOWN HEREIN THE DEVELOPED FLOWS WILL SLIGHTLY DECREASE. THE SITE DOES NOT ACCEPT OFF-SITE FLOWS AND IS NOT WITHIN A 100-YEAR FLOODPLAIN.

2' CONCRETE VALLEY GUTTER PER COA STD -ASPHALT PAVING SEE THIS SHEET, DETAIL 2 DWG 2415A -

## VALLEY GUTTER DETAIL

SCALE: 3/8" = 1'-0"

- ASPHALTIC CONCRETE SURFACE COURSE 1800# STABILITY AGGREGATE BASE COURSE WITH PRIME COAT - COMPACTED SUBGRADE


# PAVING DETAIL

SCALE: 1 1/2" = 1'-0"

SCALE: 1" = 10"



GRADING AND DRAINAGE PLAN

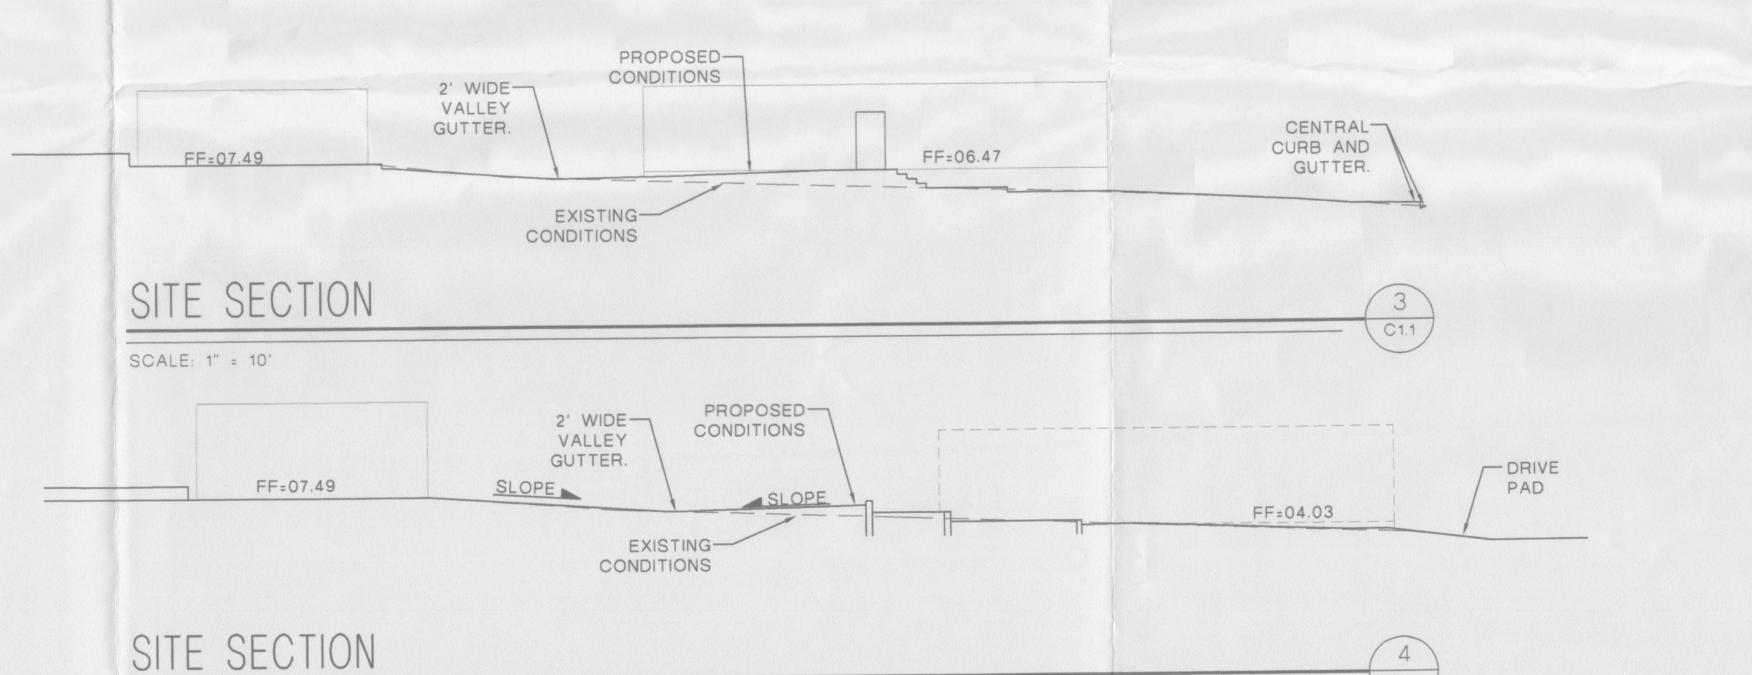

SCALE: 1" = 10'



MARTIN FM GRUMMER

ARCHITECT

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REVISIONS

DATE:

09/01/2008 DRAWN BY:

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