


06-16-2016

ABQ Engineering SHEET NUMBER

C-1

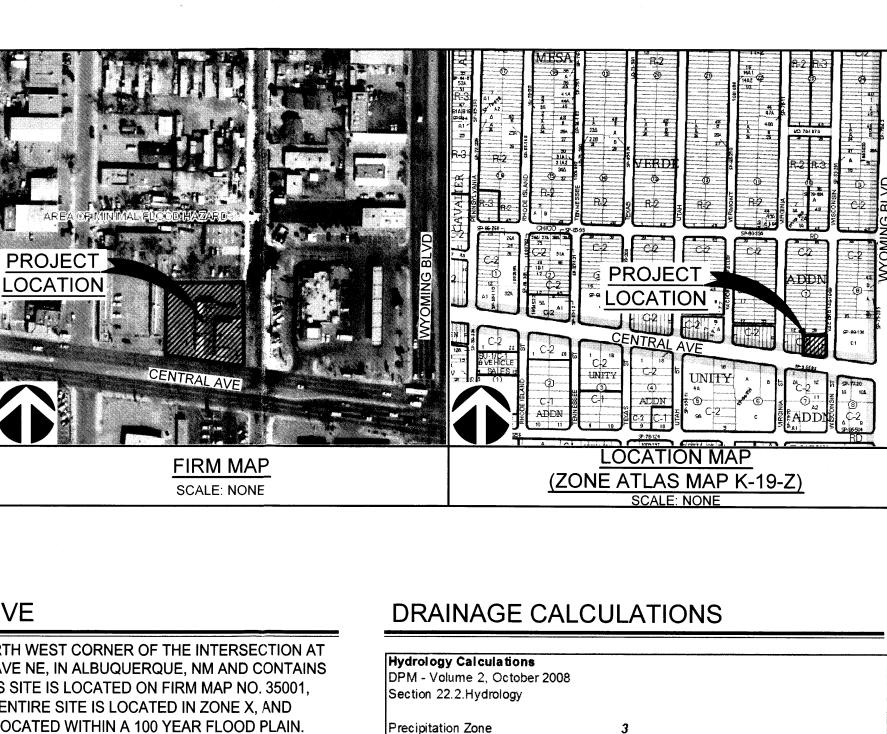

100 Year Storm Depth, P (360)

100 Year Storm Depth, P (1440)

Type "D" (Impervious, Roof, Drive way, Ect.)

Type "C" (Compacted Soil, Unpaved Parking)

ONSITE DRAINAGE RETENTION

FIRST FLUSH STORAGE REQUIRED BY COA HYDROLOGY:

FIRST FLUSH (IN) APPLIED OVER IMPERVIOUS AREAS (ACRES)

FIRST FLUSH PONDING AREA REQD. = 494 CF < 515 CF PROVIDED

JUN 17 2015

LAND DEVELOPMENT SECTION

Engineers • Planners • Construction Services

8102 Menaul Blvd. NE, Suite D, Albuquerque, NM 87110 tele: 505.255.7802 Proj. No.: 16-042 www.abgeng.com

Excess Precipitation Factors

Type "B" (Landscape Areas)

Peak Discharge Factors

Land Treatment Area

Type "A" (Undeveloped)

Excess Precipitation E (in)

Volume (360), acre-ft

Volume (1440), acre-ft

TABLE A-6 USE 0.1 - 0.44 = 0.34 IN

THEREFORE 0.34/12 x 0.40 x 43560 = 494 CF

Total (Acres)

Q (360), cfs

Q (1440), cfs

(SEE NOTE 5)

NO ESC

Treatment Area

2.60

3.10

1.87

0.92

2.60

0.000

0.000

0.405

0.079

0.096

2.027

1.885

1.29

3.45

DRAINAGE NARRATIVE

MATCH EXT

▼ FLOW LINE

MATCH EXT.

FLOW LINE

TC 89.0

FL 88.5

TC 89.0

FL 88.5

TC 89.15 FL 88.65

FL 88.65

The same and the s

 $\langle 10 \rangle \rightarrow$

88.65

TC 89.0

FL 88.5

FL 88.0

1

THIS SITE IS LOCATED ON THE NORTH WEST CORNER OF THE INTERSECTION AT WISCONSIN ST NE, AND CENTRAL AVE NE, IN ALBUQUERQUE, NM AND CONTAINS APPROXIMATELY 0.405 ACRES. THIS SITE IS LOCATED ON FIRM MAP NO. 35001, PANEL 0358 WHICH INDICATES THE ENTIRE SITE IS LOCATED IN ZONE X, AND THAT NO PORTION OF THE SITE IS LOCATED WITHIN A 100 YEAR FLOOD PLAIN.

THE PRE DEVELOPED SITE HAS A BUILDING, SIDEWALKS AND PAVED PARKING LOT, WITH DRIVE WAY ACCESS TO BOTH WISCONSIN ST AND CENTRAL AVE. THE MAJORITY OF THE SITE IS COVERED WITH IMPERVIOUS AREA. THE HISTORIC DRAINAGE PATTERN HAS ROOF DRAINAGE AND PARKING LOT DRAINAGE SURFACE FLOWING TO THE ADJACENT STREETS AND THEN DIRECTED INTO THE LOCAL STORM DRAIN SYSTEM ALONG BOTH STREETS.

WITH THIS DEVELOPMENT, THE PARKING LOT WILL BE RESURFACED, AND THE PROPOSED BUILDING FOOT PRINT AND SIDEWALKS WILL CLOSELY MATCH THE PRE DEVELOPED POSITIONS, SIZE AND LAYOUT. THE HISTORIC DRAINAGE PATTERNS WILL BE PRESERVED. THE ADDITION OF AN ONSITE RETENTION PONDING AREA TO CAPTURE AND RETAIN THE "FIRST FLUSH" RUNOFF PER COA DRAINAGE ORDINANCE WILL BE LOCATED IN THE DEPRESSED LANDSCAPE AREAS ON THE WEST OF THE PARKING LOT, THE REMAINING VOLUME FROM THE 90TH PERCENTILE STORM EVENT (100 YEAR, 10 DAY) WILL MAINTAIN HISTORIC DRAINAGE PATTERNS AS DESCRIBED ABOVE IN THE PRE DEVELOPED CONDITIONS. (SEE CALCULATIONS)

KEYED NOTES

- $\langle x \rangle$
- 1. CONSTRUCT 6" CONCRETE CURB. SEE DETAIL 6/C-3.
- 2. CONSTRUCT CONCRETE SIDEWALK PER DETAILS 4 &
- 3. INSTALL ASPHALT PAVEMENT. SEE DETAIL 7/C-3.
- 4. CONSTRUCT CONCRETE DRIVEPAD PER COA STD. DWG. 2425. SEE DETAIL 8/C-3.
- 5. CONSTRUCT RETENTION PONDING AREA. TOP POND = 5387.0, BOTTOM POND = 5385.0. VOLUME PROVIDED FOR FIRST FLUSH = 515 CF STORAGE.
- 6. CONSTRUCT ACCESSIBLE SIDEWALK RAMP. SEE DETAIL 3/C-3.
- 7. REMOVE EXISTING DRIVE ENTRANCES AND SIDEWALKS AND CONSTRUCT NEW CONCRETE SIDEWALKS. MATCH NEW SIDEWALKS GRADES TO EXISTING BACK OF CURB GRADES ALONG WISCONSIN STREET AND CENTRAL AVENUE. ADD NEW CURB AND GUTTER WHERE NEEDED.
- 8. PROVIDE 2' CURB CUT WITH 3' x 3' RIPRAP PAD FOR DRAINAGE TO PONDING AREA.
- 9. ROOF LINE AND ROOF PARAPETS.
- 10. ROOF DRAINS ARE INTERNAL TO WALLS AND SCOOPER OUT OF WALL AT GRADE LEVEL, DRAINS SHOWN AT ROOF LEVEL ARE FOR OVERFLOW.
- 12. FIRST FLOOR EDGE OF BUILDING AT GRADE.

Can't drain directhy onto sidewalk.

ENGINEER'S STATEMENT

I, THE ENGINEER OF RECORD CERTIFY THAT I HAVE PERSONALLY VISITED THE SITE AND THE EXISTING GRADES AND CONTOURS DEPICTED ON THIS PLAN MATCH WHAT PRESENTLY EXISTS AT THIS LOCATION.

JAMES CRAIG HAGELGANTZ, NMPE #15559

GRADING & DRAINAGE PLAN

87.7 TC 88.5 FL 88.0

MATCH EXT. FLOW LINE

FL 87.8

TC 87.70 FL 87.20

87.4C 87.9

|| FL 87.4

TC 88.0

TC 88.8

FL 88.3

TC 88.6 TC 89.24

FL 88.1 FL 88.74

/ TC 89.2**4**

FL 88.74

CENTRAL AVENUE N.E.

FL 87.5

TC 88.9

₹88.38

88.38

FL 87.0

FL 87.3

TC 88.5

FL 88.0


5

FL 87.0 94

MATCH EXT.

FLOW LINE 4

REVISION DATE

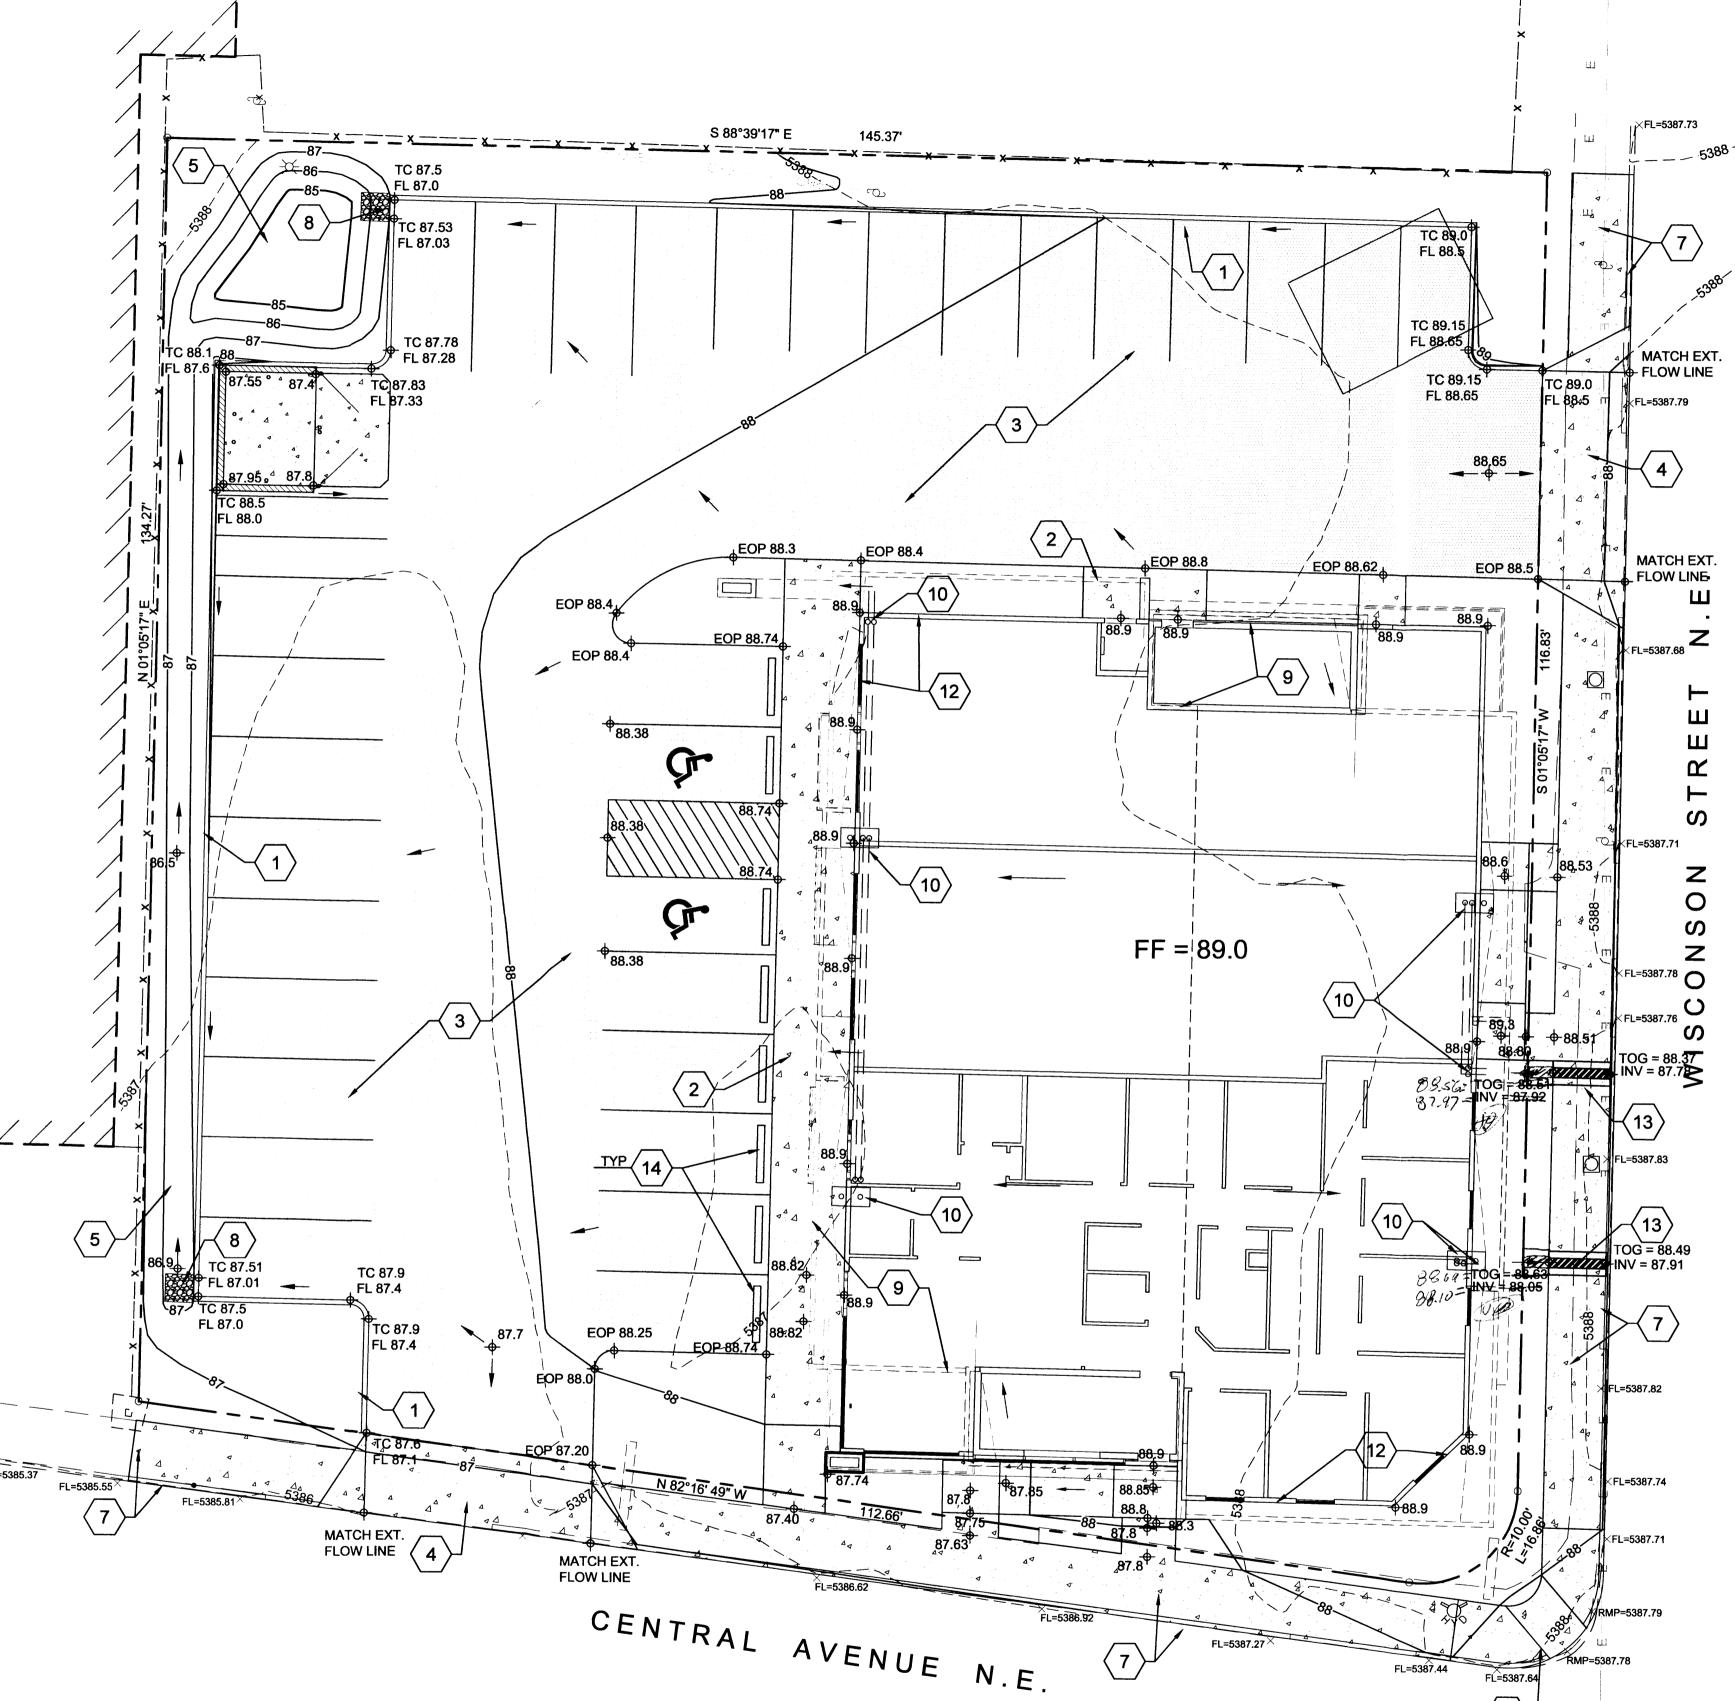

ENGINEER'S STATEMENT

FL=5387.44

I, THE ENGINEER OF RECORD CERTIFY THAT I HAVE PERSONALLY VISITED THE SITE AND THE EXISTING GRADES AND CONTOURS DEPICTED ON THIS PLAN MATCH WHAT PRESENTLY EXISTS AT THIS LOCATION.

FĹ=5387.64

JAMES CRAIG HAGELGANTZ, NMPE #15559

DRAINAGE NARRATIVE

THIS SITE IS LOCATED ON THE NORTH WEST CORNER OF THE INTERSECTION AT WISCONSIN ST NE, AND CENTRAL AVE NE, IN ALBUQUERQUE, NM AND CONTAINS APPROXIMATELY 0.405 ACRES. THIS SITE IS LOCATED ON FIRM MAP NO. 35001, PANEL 0358 WHICH INDICATES THE ENTIRE SITE IS LOCATED IN ZONE X, AND THAT NO PORTION OF THE SITE IS LOCATED WITHIN A 100 YEAR FLOOD PLAIN.

THE PRE DEVELOPED SITE HAS A BUILDING, SIDEWALKS AND PAVED PARKING LOT, WITH DRIVE WAY ACCESS TO BOTH WISCONSIN ST AND CENTRAL AVE. THE MAJORITY OF THE SITE IS COVERED WITH IMPERVIOUS AREA. THE HISTORIC DRAINAGE PATTERN HAS ROOF DRAINAGE AND PARKING LOT DRAINAGE SURFACE FLOWING TO THE ADJACENT STREETS AND THEN DIRECTED INTO THE LOCAL STORM DRAIN SYSTEM ALONG BOTH STREETS.

WITH THIS DEVELOPMENT, THE PARKING LOT WILL BE RESURFACED, AND THE PROPOSED BUILDING FOOT PRINT AND SIDEWALKS WILL CLOSELY MATCH THE PRE DEVELOPED POSITIONS, SIZE AND LAYOUT. THE HISTORIC DRAINAGE PATTERNS WILL BE PRESERVED. THE ADDITION OF AN ONSITE RETENTION PONDING AREA TO CAPTURE AND RETAIN THE "FIRST FLUSH" RUNOFF PER COA DRAINAGE ORDINANCE WILL BE LOCATED IN THE DEPRESSED LANDSCAPE AREAS ON THE WEST OF THE PARKING LOT, THE REMAINING VOLUME FROM THE 90TH PERCENTILE STORM EVENT (100 YEAR, 10 DAY) WILL MAINTAIN HISTORIC DRAINAGE PATTERNS AS DESCRIBED ABOVE IN THE PRE DEVELOPED CONDITIONS. (SEE CALCULATIONS)

KEYED NOTES

- CONSTRUCT 6" CONCRETE CURB. SEE DETAIL 6/C-4.
- 2. CONSTRUCT CONCRETE SIDEWALK PER DETAILS 4 & 6/C-4.
- INSTALL ASPHALT PAVEMENT. SEE DETAIL 7/C-4.
- CONSTRUCT CONCRETE DRIVEPAD PER COA STD. DWG. 2425. SEE DETAIL
- CONSTRUCT RETENTION PONDING AREA. TOP POND = 5387.0, BOTTOM POND = 5385.0. VOLUME PROVIDED FOR FIRST FLUSH = 515 CF STORAGE.
- REMOVE EXISTING RAMP AND CONSTRUCT NEW ACCESSIBLE RAMP WITH DETECTABLE WARNING STRIP PER COA STD DETAIL 2440 & 2441. SEE DETAILS 3 & 5/C-4.
- REMOVE EXISTING DRIVE ENTRANCES AND SIDEWALKS AND CONSTRUCT NEW CONCRETE SIDEWALKS. MATCH NEW SIDEWALKS GRADES TO EXISTING BACK OF CURB GRADES ALONG WISCONSIN STREET AND CENTRAL AVENUE. ADD NEW CURB AND GUTTER WHERE NEEDED.
- 8. PROVIDE 2' CURB CUT WITH 3' x 3' RIPRAP PAD FOR DRAINAGE TO PONDING
- 9. ROOF LINE AND ROOF PARAPETS.
- 10. ROOF DRAINS ARE INTERNAL TO WALLS AND SCOOPER OUT OF WALL 18" ABOVE FINISHED GRADE. SPLASH BLOCKS BELOW.
- 12. FIRST FLOOR EDGE OF BUILDING AT GRADE.
- 13. CONSTRUCT SIDEWALK CULVERT PER COA STD. DWG. 2236. SEE COA REQUIREMENTS FOR "SO-19" THIS SHEET. Extend to PL
- 14. INSTALL CONCRETE WHEEL STOPS. SEE DETAIL 9/C-4.

100 Year Storm Depth, P (360) 100 Year Storm Depth, P (1440) Treatment Area **Excess Precipitation Factors** eak Discharge Factors 1.87 2.60 3.45 Acres Existing Allowable% Proposed Land Treatment Area Type "D" (Impervious, Roof, Drive way, Ect.) Type "C" (Compacted Soil, Unpaved Parking) 0.004 0.000 Type "B" (Landscape Areas) 0.000 0.005 Type "A" (Undeveloped) 0.000 0.000 Total (Acres) 0.405 Excess Precipitation E (in) 2.35 2.34 Volume (360), acre-ft 0.079 0.079 Volume (1440), acre-ft 0.096 0.096 Q (360), cfs 2.027 2.021 Q (1440), cfs 1.880

ONSITE DRAINAGE RETENTION

FIRST FLUSH STORAGE REQUIRED BY COA HYDROLOGY:

PROVIDE STORAGE FOR FIRST FLUSH RUNOFF PER SECTION 22 OF DPM TABLE A-6 USE 0.1 - 0.44 = 0.34 IN

FIRST FLUSH (IN) APPLIED OVER IMPERVIOUS AREAS (ACRES) THEREFORE $0.34/12 \times 0.40 \times 43560 = 494 \text{ CF}$ FIRST FLUSH PONDING AREA REQD. = 494 CF < 515 CF PROVIDED (SEE NOTE 5)

LEGEND


6510	EXISTING INDEX CONTOUR
6509	EXISTING INTERIM CONTOUR
10	NEW INDEX CONTOUR
9	NEW INTERIM CONTOUR
+ 22.8	NEW SPOT ELEVATION
B4 4 4	NEW CONCRETE
	NEW ASPHALT PAVEMENT
	EXISTING BUILDING
	NEW BUILDING
FF	FINISH FLOOR ELEVATION
—	DIRECTION OF FLOW
φ	EXISTING FIRE HYDRANT
	EXISTING WATER METER
EE	EXISTING ELECTRIC LINE
\mathcal{O}	EXISTING UTILITY POLE
xx	EXISTING FENCE LINE
	EXISTING SIGN
*	EXISTING LIGHT POLE

PRIVATE DRAINAGE FACILITIES WITHIN CITY RIGHT-OF-WAY **NOTICE TO CONTRACTOR** (SPECIAL ORDER 19 ~ "SO-19")

- AN EXCAVATION PERMIT WILL BE REQUIRED BEFORE BEGINNING ANY WORK WITHIN CITY RIGHT-OF-WAY.
- ALL WORK ON THIS PROJECT SHALL BE PERFORMED IN ACCORDANCE WITH APPLICABLE FEDERAL, STATE AND LOCAL LAWS, RULES AND REGULATIONS CONCERNING CONSTRUCTION SAFETY AND HEALTH.
- TWO WORKING DAYS PRIOR TO ANY EXCAVATION, THE CONTRACTOR MUST CONTACT NEW MEXICO ONE CALL, DIAL "811" [OR (505) 260-1990] FOR THE LOCATION OF EXISTING UTILITIES.
- PRIOR TO CONSTRUCTION, THE CONTRACTOR SHALL EXCAVATE AND VERIFY THE LOCATIONS OF ALL OBSTRUCTIONS. SHOULD A CONFLICT EXIST, THE CONTRACTOR SHALL NOTIFY THE ENGINEER SO THAT THE CONFLICT CAN BE RESOLVED WITH A MINIMUM AMOUNT OF DELAY.
- BACKFILL COMPACTION SHALL BE ACCORDING TO TRAFFIC/STREET USE.
- MAINTENANCE OF THE FACILITY SHALL BE THE RESPONSIBILITY OF THE OWNER OF THE PROPERTY BEING SERVED.
- WORK ON ARTERIAL STREETS SHALL BE PERFORMED ON A 24-HOUR BASIS.
- CONTRACTOR MUST CONTACT JASON RODRIGUEZ AT 235-8016 AND CONSTRUCTION COORDINATION AT 924-3416 TO SCHEDULE AN

STREET MAINTENANCE INSPECTOR APPROVAL




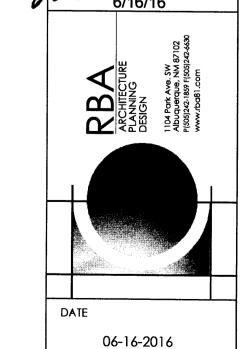


SHEET NUMBER C-1

GRADING & DRAINAGE PLAN


- 1. CONSTRUCT 80 LF 4" FIRE SERVICE LINE.
- 2. INSTALL NEW SINGLE CLEANOUT.
- 3. INSTALL NEW DOUBLE CLEANOUT.
- 4. CONSTRUCT NEW 4" SANITARY SEWER LATERAL WITH CLEANOUT. SEE PLUMBING PLANS FOR CONTINUATION.
- 5. CONSTRUCT NEW 6" SANITARY SEWER LATERAL. IF MINIMUM SLOPE OF PROPOSED LATERAL CANNOT MEET THE EXISTING SERVICE LINE INVERT, CONNECT NEW SERVICE LINE DIRECTLY TO EXISTING COA SAS IN WISCONSIN STREET PER COA STD DWG 2125.
- 6. CONSTRUCT 40 LF 4" LINE FROM REMOTE FIRE DEPARTMENT CONNECTION.
- 7. INSTALL 4" PIV ON FIRE LINE.
- 8. INSTALL 4" RBPA ON FIRE SERVICE LINE (OMIT IF PROVIDED AND LOCATED WITHIN FIRE RISER ROOM BY FIRE PROTECTION ENGINEER).
- 9. DOMESTIC WATER AND FIRE SYSTEM WATER SPLIT PER COA DWG 2394 - REFER TO C.C.C.C. MULTI-USE DOMESTIC AND FIRE SERVICE LINE.
- 10. INSTALL NEW 2" WATER METER PER COA STD DWG 2363 & CONNECT TO BUILDING. RESIZE/REPLACE WATER SERVICE LINES TO STREET AS REQUIRED. SEE PLUMBING PLANS FOR CONTINUATION.
- 11. REMOVE EXISTING WATER METER.

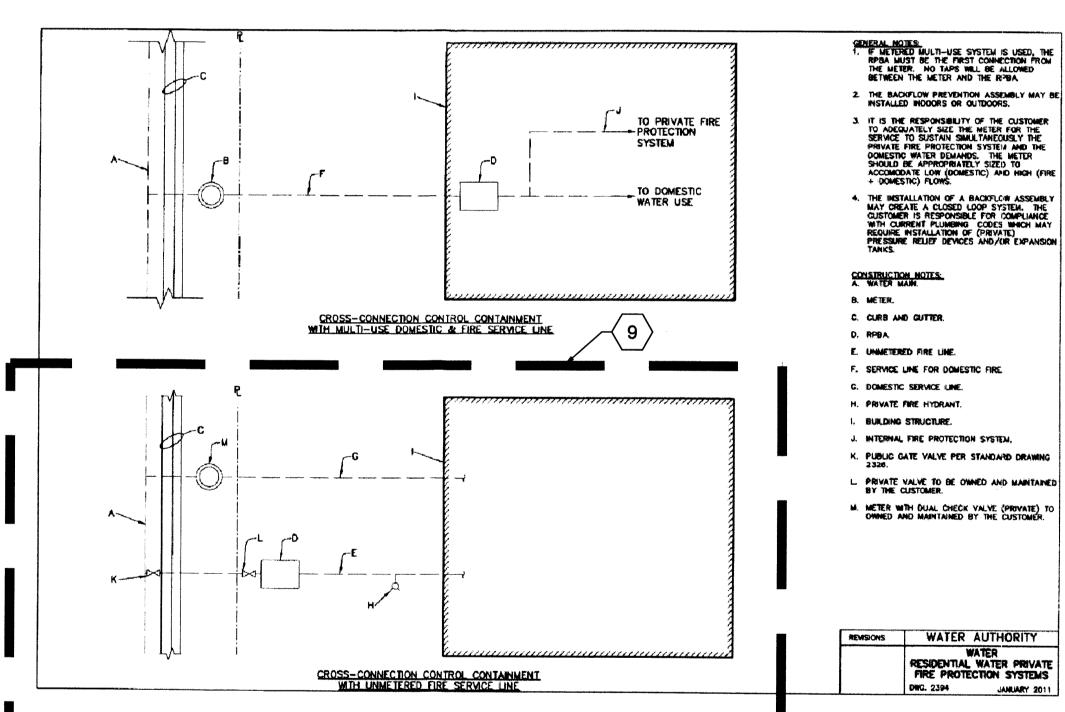

ROUTE SITE PLA 8521 CI REVISION DATE

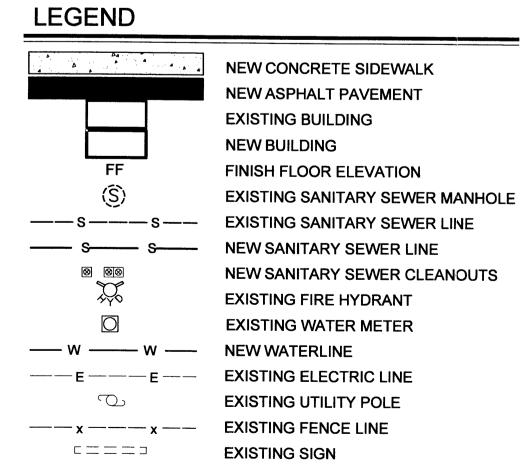

ABQ Engineering Engineers • Planners • Construction Services 8102 Menaul Blvd. NE, Suite D, Albuquerque, NM 87110 tele: 505.255.7802 Proj. No.: 16-042 www.abqeng.com

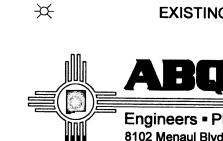

SITE PLAN

LAST MODIFIED: V DWG. LOCATION: DWG. NAME: 16

Scale: 1" = 10'

CENTRAL AVENUE N.E.

S 88°39'17" E

Gr

(\$)

EX. FIRE HYDRANT TO——/ REMAIN

EXISTING LIGHT POLE

SHEET NUMBER

C-2

06-16-2016

RBA ARCHITECTUR PLANNING DESIGN

S 88°39'17" E 145.37' J. C 3 SPACES @ 8.5' k 18' 11 COMPACT SPACES @ 8' x 15 35' CLEAR SITE TRIANGLE 35' CLEAR SITE TRIANGLE CENTRAL AVENUE N.E. 35' CLEAR SITE TRIANGLE SITE PLAN Scale: 1" = 10'

POINT TABLE POINT # | ELEVATION | NORTHING | EASTING DESCRIPTION 1483039.77 | 1550630.42 **BLDG COR** 5388.90 | 1483038.52 | 1550696.41 **BLDG COR** 1482953.20 | 1550694.78 **BLDG COR** 4 | 5387.20 | 1482949.27 | 1550602.70 DRIVE ENTRANCE-EP 5388.00 | 1482959.52 | 1550602.89 PC 2'R - EP 5388.25 1482961.48 PT - EP 5388.74 1482961.18 | 1550620.93 COR PARKING - EP 1483036.16 | 1550622.35 5388.74 **COR PARKING - EP** 9 | 5388.40 | 1483036.47 | PC 2'R - EP 10 | 5388.40 | 1483039.68 | 1550604.82 PCC 15'R - EP 5388.30 1483045.58 PT - EP 12 5388.50 | 1483043.61 | DRIVE ENTRANCE - EP 1550702.29 DRIVE ENTRANCE - FL - BEGIN CURB 5388.50 14 | 5388.65 | 1483065.72 | 1550696.43 PC 2'R - FL 5388.65 1483067.77 PT - FL 16 | 5388.50 | 1483080.78 | **COR PARKING - FL** 5387.00 1483083.45 COR PARKING - FL 1550581.29 18 | 5387.03 | 1483081.45 CURB CUT - FL 19 | 5387.28 | 1483067.45 | 1550580.93 PC 2'R - FL 20 5387.33 1483065.50 PT - FL 21 | 5387.60 | 1483065.87 1550562.90 **COR PARKING - FL** 5387.01 1482969.03 CURB CUT - FL 23 5387.00 1482967.03 COR PARKING - FL 24 | 5387.40 | 1482966.73 | 1550577.02 PC 2'R - FL 1482964.69 PT - FL

> BLDG = BUILDING COR = CORNER EP = EDGE OF PAVEMENT FL = FLOWLINE OF CURB PC = POINT OF CURVATURE PCC = POINT OF COMPOUND CURVATURE PT = POINT OF TANGENCY

END CURB - FL

KEYED NOTES

26 | 5387.10 | 1482952.52 | 1550578.75

REVISION DATE

ARCHITECTURI PLANNING DESIGN 1104 Park Ave. SW Abuquerque, NM P(505)242-1859 F(505) www.rbo81.com


06-16-2016

C-3

SHEET NUMBER


1. CONSTRUT DUMPSTER ENCLOSURE. SEE ARCHITECTURAL PLANS FOR DETAILS.


LEGEND

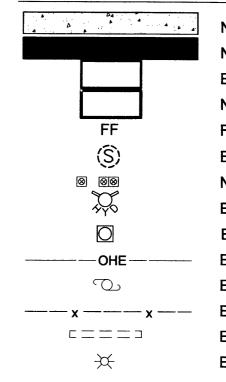


NEW CONCRETE SIDEWALK NEW ASPHALT PAVEMENT **EXISTING BUILDING NEW BUILDING** FINISH FLOOR ELEVATION **EXISTING SANITARY SEWER MANHOLE** NEW SANITARY SEWER CLEANOUTS EXISTING FIRE HYDRANT EXISTING WATER METER **EXISTING ELECTRIC LINE EXISTING UTILITY POLE** EXISTING FENCE LINE **EXISTING SIGN EXISTING LIGHT POLE**



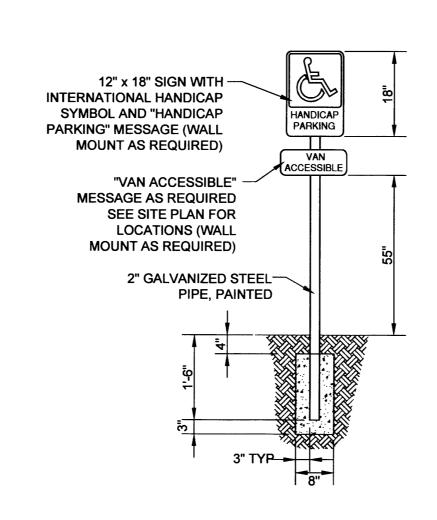

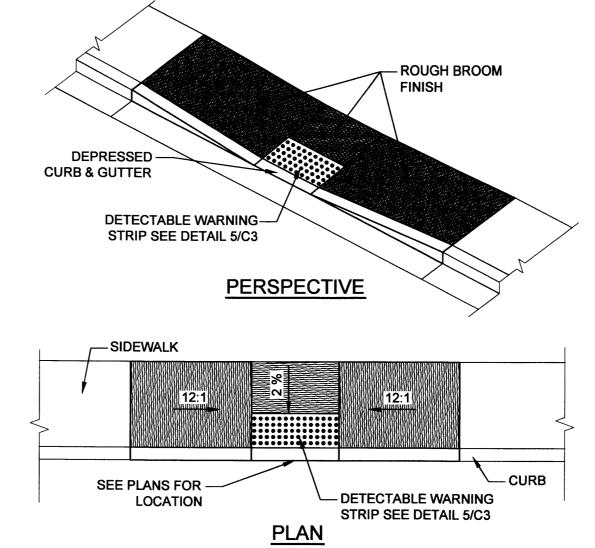

NOTE: PROVIDE TRANSVERSE CONTROL JOINTS AT INTERVALS NOT **EXCEEDING 6'-0" ON CENTER. PROVIDE CENTERLINE CONTROL JOINTS IN** SIDEWALK WIDER THAN 8'-0". SPACING OF CENTERLINE CONTROL JOINTS SHALL NOT EXCEED 6'-0" OR AS SHOWN ON PLANS. PROVIDE EXPANSION JOINTS AT INTERVALS NOT EXCEEDING 24'-0" ON CENTER WHERE WALK DOES NOT ABUT CURB.

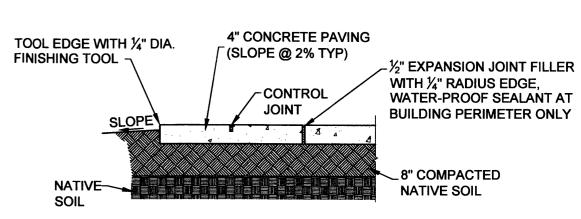

HANDICAP ACCESSIBLE PARKING LAYOUT PLAN


HANDICAP ACCESSIBLE PARKING SIGN

SIDEWALK RAMP


Scale: NTS

Scale: NTS

SIDEWALK SECTION Scale: NTS

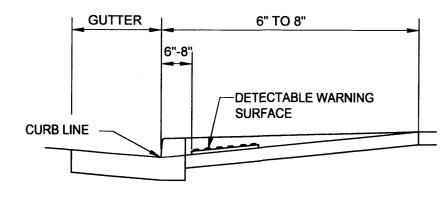

LOCATION **TRUNCATED** DOME-

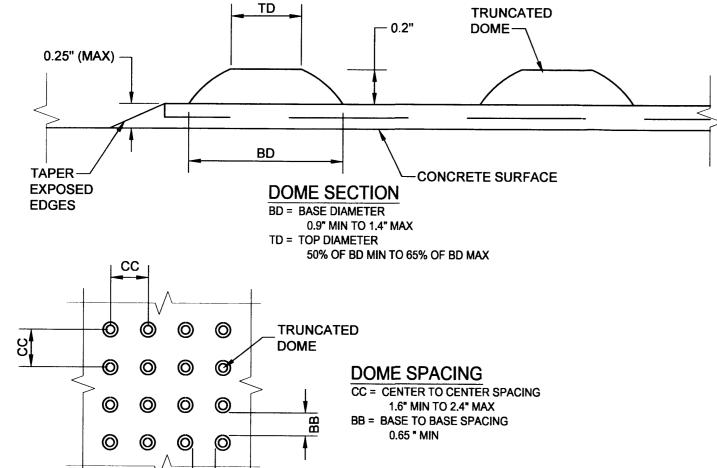


DETECTABLE WARNINGS: A SURFACE FEATURE BUILT IN OR APPLIED TO WALKING SURFACES OR OTHER ELEMENTS TO WARN OF HAZARDS ON A CIRCULATION PATH TO AID PERSONS WITH VISUAL IMPAIRMENTS.

CURB LINE: A LINE AT THE FACE OF THE CURB THAT MARKS THE TRANSITION BETWEEN THE SIDEWALK AND THE GUTTER OR ROADWAY.

- 1. DETECTABLE WARNING SURFACES SHALL BE PROVIDED WHERE A CURB RAMP OR LANDING CONNECTS TO A CROSSWALK AND/OR PEDESTRIAN ROUTE CROSSING A ROADWAY.
- 2. DETECTABLE WARNING SURFACE SHALL BE LOCATED SO THAT THE EDGE NEAREST THE CURB LINE IS 6 INCHES (150 MM) MINIMUM AND 8 INCHES (205 MM) MAXIMUM FROM THE CURB LINE.
- 3. MEDIAN AND REFUGE ISLANDS SHALL HAVE DETECTABLE WARNINGS. DETECTABLE WARNINGS AT CUT THROUGH ISLANDS SHALL BE SEPARATED BY A 24 INCH (610 MM) MINIMUM LENGTH OF WALKWAY WITHOUT WARNINGS. EXCEPTION: DETECTABLE WARNINGS SHALL NOT BE REQUIRED ON CUT THROUGH ISLANDS WHERE THE CROSSINGS ARE CONTROLLED BY SIGNALS AND ARE TIMED FOR FULL CROSSING ON MEDIANS LESS THAN 7 FEE WIDE.

Scale: NTS

- 1. DETAILS SPECIFIED ON THIS PLAN APPLY TO ALL CONSTRUCTION OR RECONSTRUCTION OF STREETS, CURBS OR SIDEWALKS BY ALL PUBLIC AGENCIES AND BY ALL PRIVATE ORGANIZATIONS CONSTRUCTING FACILITIES FOR PUBLIC USE.
- SIDEWALK RAMPS ARE TO BE LOCATED AS SPECIFIED ON THE PLANS OR AS DIRECTED BY
- THE TOP OF THE JOINT FILLER FOR ALL RAMP TYPES SHALL BE FLUSH WITH THE ADJACENT CONCRETE.
- 4. ALL PRODUCTS USED FOR DETECTABLE WARNING SURFACES SHALL BE ON THE DEPARTMENT'S APPROVED PRODUCT LIST.

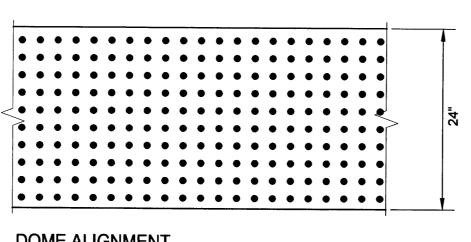

DOME ALIGNMENT DETECTABLE WARNING SURFACES SHALL EXTEND 24" MIN. IN THE DIRECTION OF TRAVEL AND FULL WIDTH OF THE CURB RAMP, LANDING, OR TRANSITION. DOMES SHALL BE ALIGNED ON A SQUARE GRID IN THE PREDOMINANT DIRECTION OF THE CROSSWALK TO PERMIT WHEELS TO ROLL BETWEEN DOMES.

HEADER CURB DETAIL

-ASPHALT -PRIME COAT -AGGREGATE BASE COURSE - SUBGRADE PREP **COMPACTED TO 95%** DENSITY

7 PAVEMENT SECTION

Scale: NTS

DETECTABLE WARNING SURFACE

-ASPHALT PAVEMENT PROPERTY LINE **EXISTING CURB** - & GUTTER 5'-0"
TRANSITION 25'-0" 5'-0" TRANSITION 31'-0"

DRIVEPAD DETAIL

6"x 6" PRECAST CONCRETE WHEEL STOP BEVEL-CORNERS AS SHOWN - #5 REBAR DOWELED 2'-0" MINIMUM THRU CONCRETE PAVING

WHEEL STOP DETAIL

SITE PLAN 8521 CENT **REVISION DATE**


OPMENT


'E/WORK DEVELC I INFORMATION ALBUQUERQUE. N

RBA ARCHITECTURE PLANNING DESIGN 06-16-2016 SHEET NUMBER


C-4


ABQ Engineering Engineers - Planners - Construction Services 8102 Menaul Blvd. NE, Suite D, Albuquerque, NM 87110 tele: 505.255.7802 Proj. No.: 16-042 www.abqeng.com

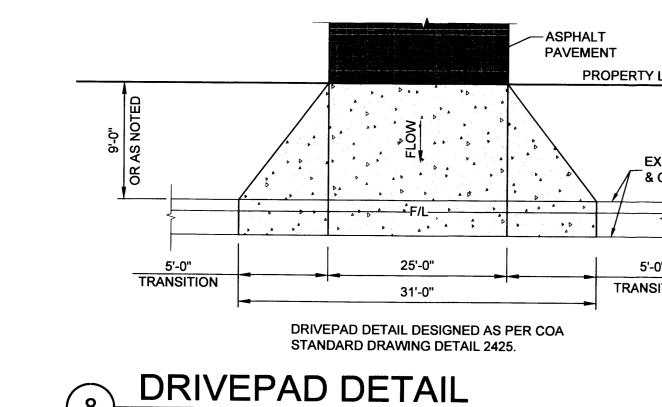

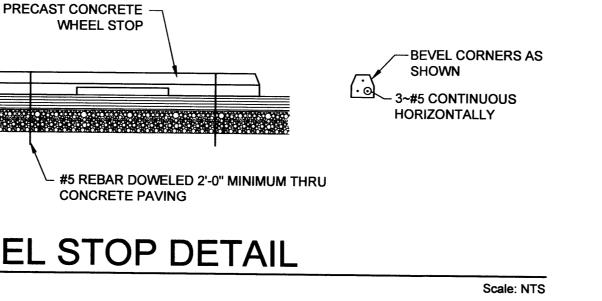

Scale: NTS

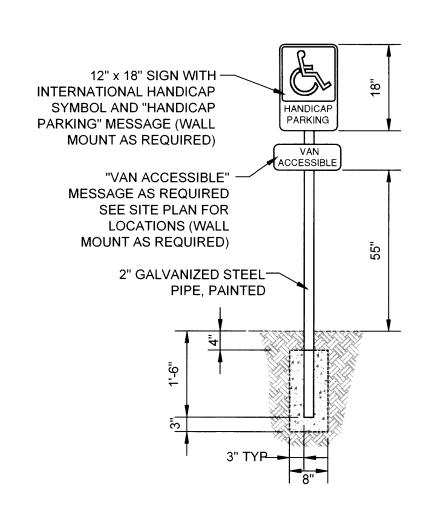

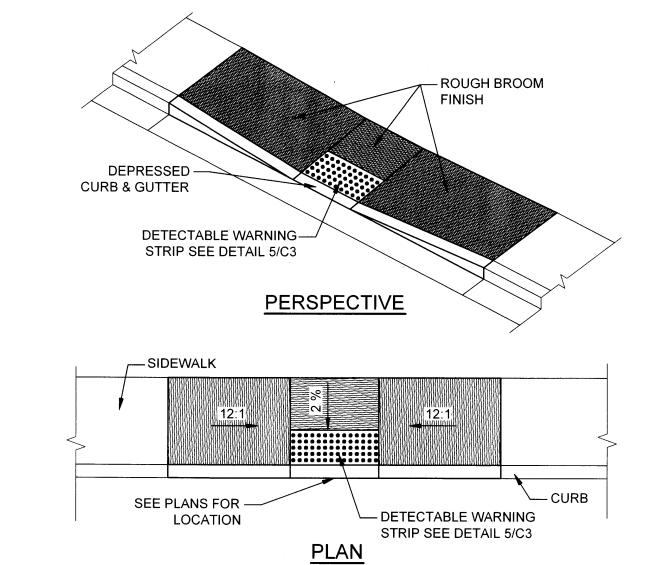

4" CONCRETE PAVING TOOL EDGE WITH 1/4" DIA. (SLOPE @ 2% TYP) FINISHING TOOL -1/2" EXPANSION JOINT FILLER WITH ¼" RADIUS EDGE, CONTROL WATER-PROOF SEALANT AT JOINT **BUILDING PERIMETER ONLY** ∠8" COMPACTED NATIVE SOIL

NOTE: PROVIDE TRANSVERSE CONTROL JOINTS AT INTERVALS NOT

NOT ABUT CURB.

EXCEEDING 6'-0" ON CENTER. PROVIDE CENTERLINE CONTROL JOINTS IN

SIDEWALK WIDER THAN 8'-0". SPACING OF CENTERLINE CONTROL JOINTS

SHALL NOT EXCEED 6'-0" OR AS SHOWN ON PLANS. PROVIDE EXPANSION

JOINTS AT INTERVALS NOT EXCEEDING 24'-0" ON CENTER WHERE WALK DOES


SIDEWALK SECTION

HANDICAP ACCESSIBLE PARKING LAYOUT PLAN

HANDICAP ACCESSIBLE PARKING SIGN

6" TO 8" —DETECTABLE WARNING SURFACE **CURB LINE**

LOCATION TRUNCATED DOME-0.25" (MAX) —

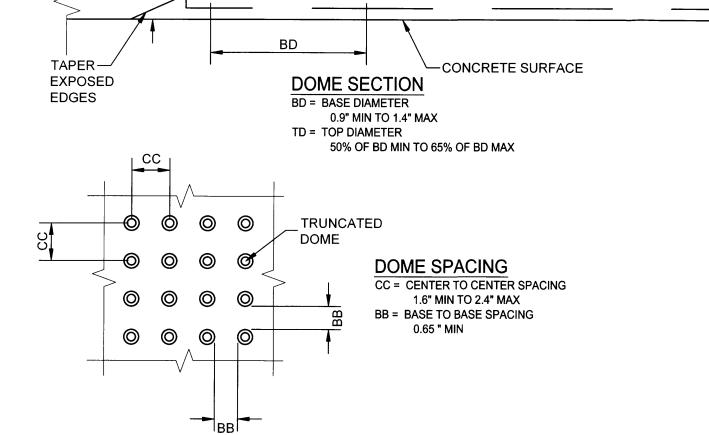

DETECTABLE WARNINGS: A SURFACE FEATURE BUILT IN OR APPLIED TO WALKING SURFACES OR OTHER ELEMENTS TO WARN OF HAZARDS ON A CIRCULATION PATH TO AID PERSONS WITH VISUAL IMPAIRMENTS

CURB LINE: A LINE AT THE FACE OF THE CURB THAT MARKS THE TRANSITION BETWEEN THE SIDEWALK AND THE GUTTER OR ROADWAY

- 1. DETECTABLE WARNING SURFACES SHALL BE PROVIDED WHERE A CURB RAMP OR LANDING CONNECTS TO A CROSSWALK AND/OR PEDESTRIAN ROUTE CROSSING A ROADWAY.
- 2. DETECTABLE WARNING SURFACE SHALL BE LOCATED SO THAT THE EDGE NEAREST THE CURB LINE IS 6 INCHES (150 MM) MINIMUM AND 8 INCHES (205 MM) MAXIMUM FROM THE CURB LINE.
- MEDIAN AND REFUGE ISLANDS SHALL HAVE DETECTABLE WARNINGS. DETECTABLE WARNINGS AT CUT THROUGH ISLANDS SHALL BE SEPARATED BY A 24 INCH (610 MM) MINIMUM LENGTH OF WALKWAY WITHOUT WARNINGS. EXCEPTION: DETECTABLE WARNINGS SHALL NOT BE REQUIRED ON CUT THROUGH ISLANDS WHERE THE CROSSINGS ARE CONTROLLED BY SIGNALS AND ARE TIMED FOR FULL CROSSING ON MEDIANS LESS THAN 7 FEE WIDE.

- DETAILS SPECIFIED ON THIS PLAN APPLY TO ALL CONSTRUCTION OR RECONSTRUCTION OF STREETS, CURBS OR SIDEWALKS BY ALL PUBLIC AGENCIES AND BY ALL PRIVATE ORGANIZATIONS CONSTRUCTING FACILITIES FOR PUBLIC USE.
- SIDEWALK RAMPS ARE TO BE LOCATED AS SPECIFIED ON THE PLANS OR AS DIRECTED BY THE ENGINEER.
- 3. THE TOP OF THE JOINT FILLER FOR ALL RAMP TYPES SHALL BE FLUSH WITH THE ADJACENT CONCRETE.
- 4. ALL PRODUCTS USED FOR DETECTABLE WARNING SURFACES SHALL BE ON THE DEPARTMENT'S APPROVED PRODUCT LIST.

• •

DETECTABLE WARNING SURFACES SHALL EXTEND 24" MIN. IN THE DIRECTION OF TRAVEL AND FULL WIDTH OF THE CURB RAMP, LANDING, OR TRANSITION. DOMES SHALL BE ALIGNED ON A SQUARE GRID IN THE PREDOMINANT DIRECTION OF THE CROSSWALK TO PERMIT WHEELS TO ROLL BETWEEN DOMES.

DOME ALIGNMENT

DETECTABLE WARNING SURFACE

31'-0"

STANDARD DRAWING DETAIL 2425.


DRIVEPAD DETAIL DESIGNED AS PER COA

Scale: NTS

-ASPHALT PAVEMENT PROPERTY LINE **EXISTING CURB** _ & GUTTER 25'-0" 5'-0" TRANSITION

DRIVEPAD DETAIL

Scale: NTS

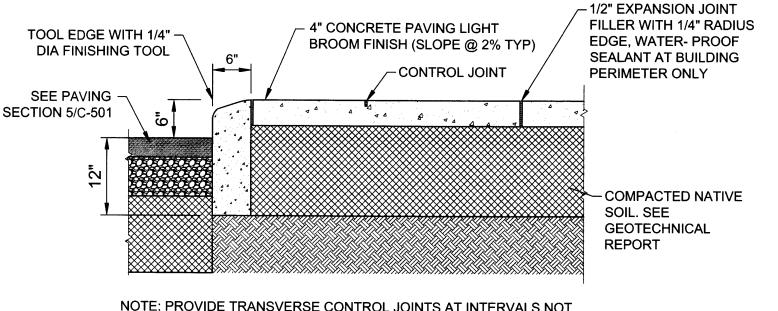

SIDEWALK RAMP


NOTE: PROVIDE TRANSVERSE CONTROL JOINTS AT INTERVALS NOT EXCEEDING 6'-0" ON CENTER, PROVIDE CENTERLINE CONTROL JOINTS IN SIDEWALK WIDER THAN 8'-0". SPACING OF CENTERLINE CONTROL JOINTS SHALL NOT EXCEED 6'-0" OR AS SHOWN ON PLANS. PROVIDE EXPANSION JOINTS AT INTERVALS NOT EXCEEDING 20'-0" ON CENTER WHERE WALK DOES NOT ABUT CURB.

CURB/SIDEWALK DETAIL

Scale: NTS

्रियो । जिस्स १८ क्रिकेश के मार्थक १५ के सम्बद्धक स्टूबिक स

Scale: NTS

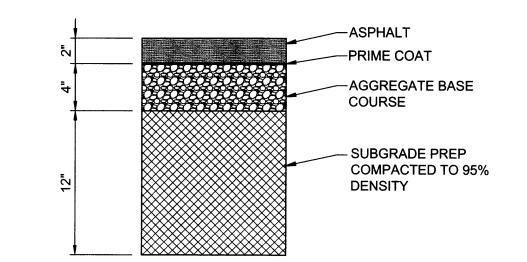

PAVEMENT SECTION

Scale: NTS

Scale: NTS

REVISION DATE **四**馬

DATE

SHEET NUMBER

06-16-2016

C-3


DEVELOPMEN

WORK I FORMA UQUER

ABQ Engineering Engineers • Planners • Construction Services 8102 Menaul Blvd. NE, Suite D, Albuquerque, NM 87110 tele: 505.255.7802 Proj. No.: 16-042 www.abqeng.com

ROUTE 66 PLAZA


8521 CENTRAL AVENUE NE

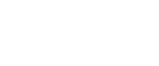



PARKING LOT DIMENSIONS ARE FROM FACE OF CURB TO FACE OF CURB UNLESS OTHERWISE NOTED.

GENERAL NOTES

- PROVIDE EXPANSION JOINTS IN CONCRETE WALK AT 4' O.C. AND WHERE CONCRETE ABUTS THE BUILDING.
- PREMIS IDENTIFICATION SHALL BE MINIMUM 12 INCHES HIGH x 1 INCH WIDE AND SHALL CONTRAST WITH THEIR BACKGROUND AND SHALL BE VISIBLE FROM THE STREET OR ROAD FRONTING THE PROPERTY
- PROPOSED BUILDING TO HAVE FIRE SPRINKLER SYSTEM THROUGHOUT PER 2009 I.B.C. SECTION 903 AND MANUAL FIRE ALARM SYSTEM PER SECTION 907. FIRE SPRINKLER SYSTEM PLANS TO BE SUBMITTED UNDER SEPARATE PERMIT G.C. TO PROVIDE KEY BOX, KEY BOX TO BE INSTALLED IN AN ACCESSIBLE LOCATION. THE KEY BOX SHALL BE OF AN APPROVED TYPE LISTED IN
- ACCORDANCE WITH UL 1037, AND SHALL CONTAIN KEYS TO GAIN ACCESS TO BUILDING AND FIRE RISER ROOM.
- G.C. TO PROVIDE FIRE EXTINGUISHERS 2A-10-BC, 1 PER EACH 3,000 S.F., REF: FLOOR PLANS FOR QUANTITY AND LOCATIONS.

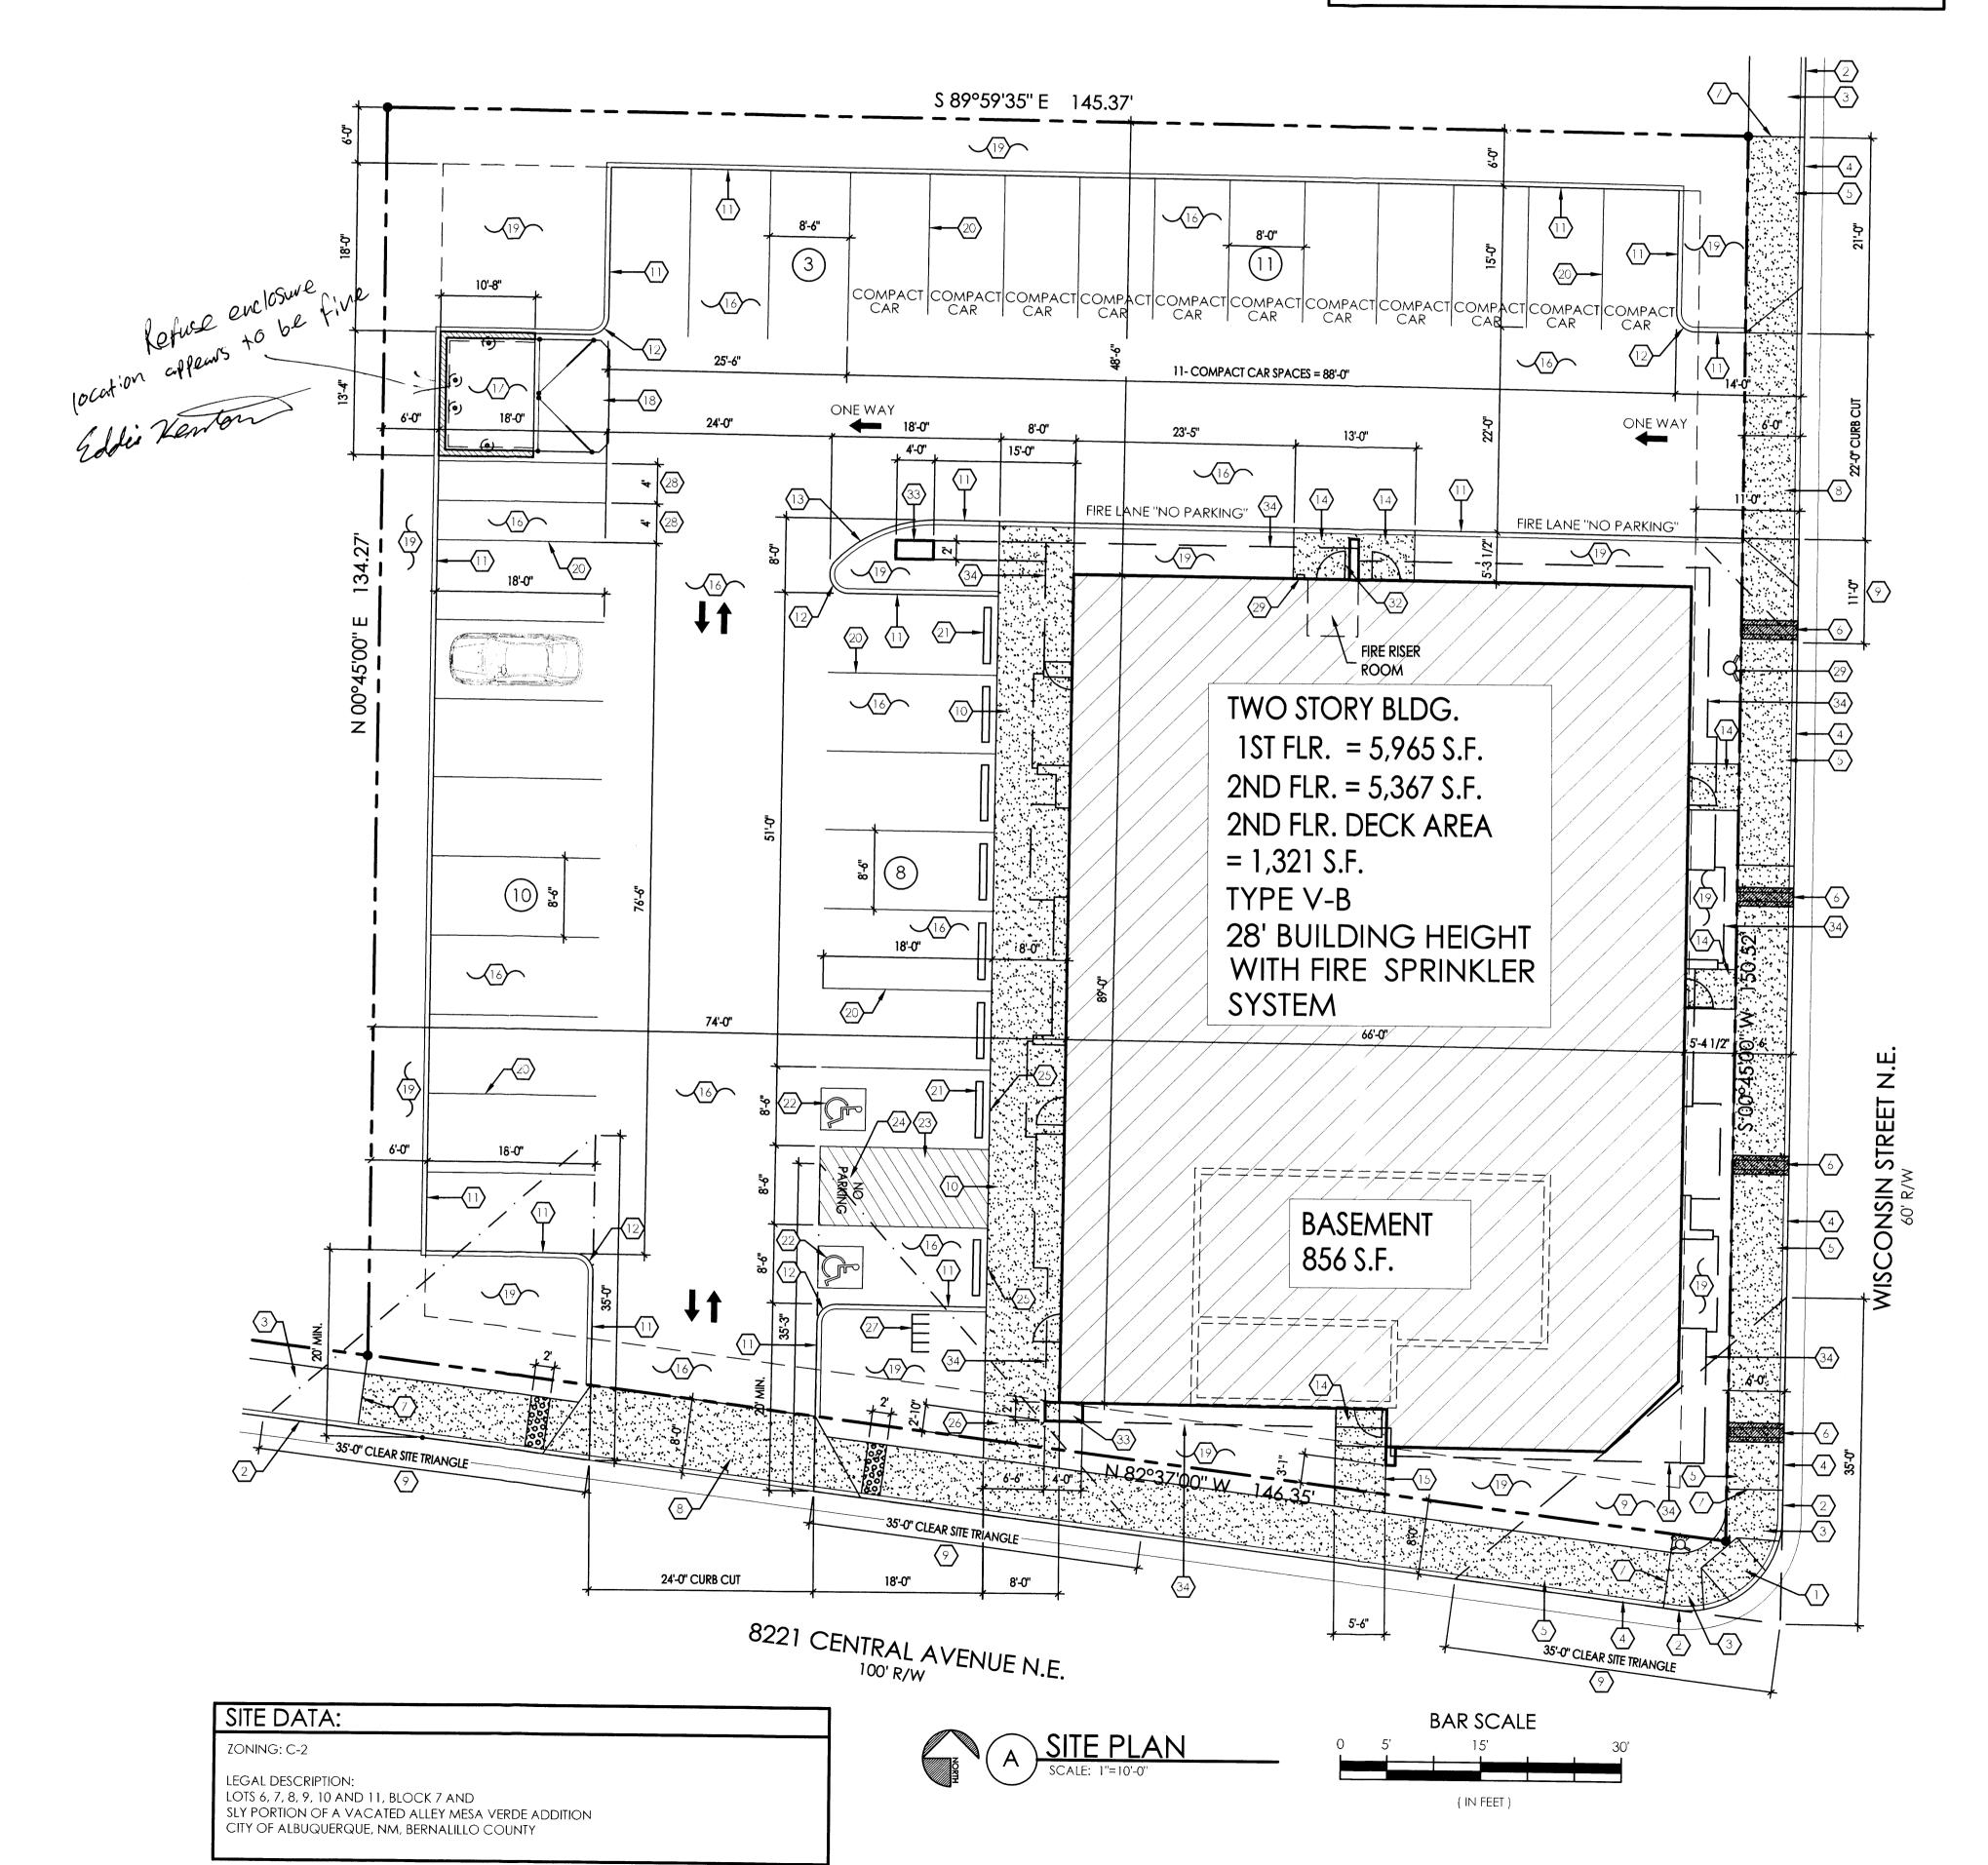

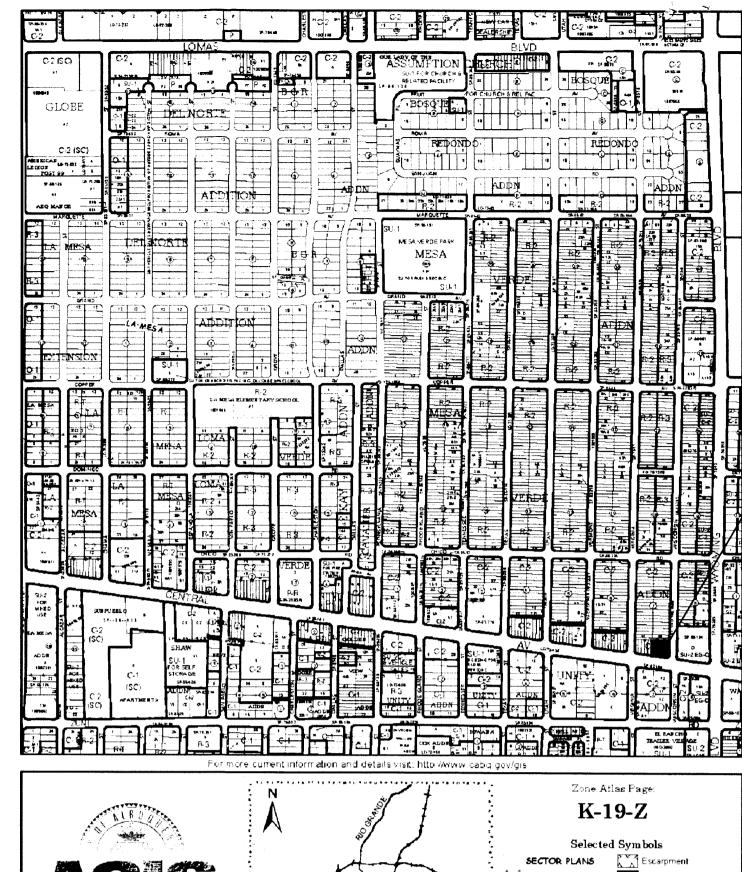

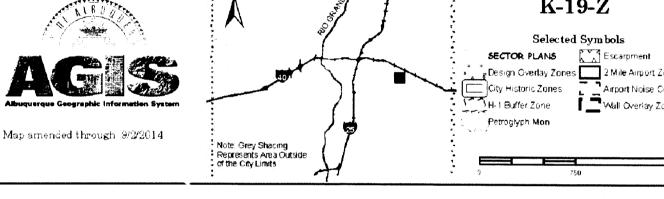

VICINITY MAP - K-19-Z

KEYED NOTES

- EXISTING ACCESSIBLE CONCRETE CURB RAMP TO REMAIN,
- EXISTING RAISED CONCRETE CURB AND GUTTER TO REMAIN. 3. EXIST. CONC. SIDEWALK.
- 4. REMOVE EXIST. CONC. CURB AND GUTTER AND CONSTRUCT NEW RAISED CONCRETE CURB AND GUTTER PER C.O.A. STANDARD DRAWING 2415A.
- REMOVE EXIST. CONG. SIDEWALK AND CONSTRUCT NEW 6' WIDE CONCRETE SIDEWALK PER C.O.A. STANDARD DWG. 2430.
- . NEW 12" WIDE SIDEWALK CULVERT PER C.O.A. DWG. 2236
- 7. NEW SIDEWALK TRANSITION PER C.O.A. STD. DWG. 2432. . REMOVE EXIST. CURB CUT, AND BUILD NEW CURB CUT AND DRIVE PAD PER C.O.A. STANDARD DRAWING 2425, REF: GRADING AND DRAINAGE PLANS. NOTE: ANY WORK WITHIN PUBLIC RIGHT OF
- WAY REQUIRES A WORK ORDER WITH DRC APPROVED PLANS. . LANDSCAPING AND SIGNAGE WILL NOT INTERFERE WITH CLEAR SITE REQUIREMENT. THEREFORE, SIGNS, WALLS, TREES AND SHRUBBERY BETWEEN 3 AND 8 FEET TALL AT MEASURED FROM THE GUTTER WILL NOT BE ACCEPTABLE IN THIS AREA. NOTE: ANY WORK WITHIN PUBLIC RIGHT OF WAY REQUIRES A WORK
- ORDER WITH DRC APPROVED PLANS. 10. 4" THICK CONCRETE SIDEWALK WITH CONC. TURNDOWN, TOP OF CONC. SIDEWALK AND ASPHALT PAVING TO BE FLUSH, SLOPE SIDEWALK 1/4"/FT. AWAY FROM BUILDING.
- 11. 6" HIGH CONCRETE CURB, REF: GRADING AND DRAINAGE PLAN.
- 12. 2'-0" RADIUS. 13. 15'-0" RADIUS.
- 14. 4" THICK CONCRETE STOOP AT EXIT DOOR, REF: 1ST FLOOR PLAN. 15. 4" THICK CONCRETE SIDEWALK.
- 16. REMOVE EXIST. ASPHALT PAVING AND INSTALL NEW ASPHALT PAVING OVER BASE COURSE, REF:
- GRADING AND DRAINAGEPLAN. 17. DUMPSTER ENCLOSURE, REF: AS-2.0.
- 18. 6" THICK CONCRETE SLAB AND APRON AT DUMPSTER ENCLOSURE, REF: AS-2.0.
- 19. LANDSCAPING AREA, REF: LANDSCAPING PLAN AND GRADING AND DRAINAGE PLAN. 20. 2" WIDE PAINTED PARKING STRIPE PER C.O.A. STANDARDS, REF: AS-2.0 FOR DETAILS.
- 21. CONCRETE WHEEL STOP, TYPICAL.
- 22. HANDICAP SYMBOL PER C.O.A. STANDARDS, REF: AS-2.0 FOR DETAILS.
- 23. PAINTED STRIPE HANDICAP ACCESSIBLE AISLE PER C.O.A. STANDARDS, REF: AS-2.0 FOR DETAIL. 24. "NO PARKING" IN CAPITAL LETTERS, 12" HIGH x 2" WIDE, LOCATE SIGN AT THE REAR OF THE PARKING SPACE SO AS TO BE CLOSE TO WHERE AN ADJACENT VEHICLE'S TIRE WOULD BE PLACES. (66-1-4.1.B
- 25. HANDICAP ACCESSIBLE SIGNAGE PER C.O.A. REQUIREMENTS, REF: AS-2.0 FOR DETAILS.
- 26. 6'-0" WIDE MIN. PEDESTRIAN PATH-WAY/SIDEWALK PER C.O.A. REQUIREMENTS.
- 27. BICYCLES RACK, FOR FIVE BICYCLES MIN. REF: AS-2.0 FOR DETAIL. 28. TWO MOTORCYCLE PARKING REQUIRED, SIGNAGE PER C.O.A. REQUIREMENTS.
- 29. G.C. TO PROVIDE AND INSTALL RECESSED KNOX BOX WITH KEY FOR FIRE DEPARTMENT ACCESS WITH BUILDING AND FIRE RISER ROOM, MOUNT BOX 5'-0" HIGH A.F.F. 30. FIRE DEPARTMENT CONNECTION (FDC) LOCATION, NOTE: FDC LOCATION TO BE WITHIN 100 FEET OF
- 31. Premis id to be 12 inch high numerals, 1" stroke on a contrasting background.
- 32. FIRE RISER ROOM WITH SIGNAGE "FIRE RISER ROOM".
- 33. FRAMED COLUMN WITH STUCCO, REF: PLANS. 34. DASHED LINE DENOTES: 2ND FLOOR ABOVE, REF: PLANS.

PARKING CALCULATIONS OFFICE STREET PARKING REQUIRED:

DENTAL: 5 SPACES FOR EACH DOCTOR; 1 DOCTOR = 5 SPACES

RETAIL: 1 PER 200 S.F.; 2,671 S.F. = 14 SPACES APARTMENTS: 1 PER BATH; 6 APARTMENTS WITH 2 BATHS EACH = 12 SPACES

TOTAL PARKING REQUIRED: 31 SPACES (2 H.C. ACCESSIBLE SPACES) TOTAL PARKING PROVIDED: 2 H.C. SPACES + 18 REGULAR SPACES + 11 COMPACT CAR SPACES

= 31 TOTAL PARKING SPACES MOTORCYCLE PARKING REQUIRED:

31 TOTAL OFF STREET PARKING REQUIRED: 26 -50 SPACES = 2 MOTORCYCLE PARKING SPACES REQUIRED, 2 PROVIDED

BICYCLE PARKING REQUIRED:

RESIDENTIAL USE: 1 SPACE FOR EACH 2 DWELLING UNITS:

5 BICYCLE PARKING SPACES REQUIRED, 5 PROVIDED

6 DWELLING UNITS = 3 BICYCLE PARKING SPACES NON-RESIDENTIAL USE: 1 SPACE FOR EACH 20 REQUIRED PARKING SPACES: 31 PARKING SPACES = 2 BICYCLE PARKING SPACES

ALL WHEELCHAIR RAMPS LOCATED

WITHIN THE PUBLIC RIGHT OF WAY MUST HAVE TRUNCATED DOMES.


TRAFFIC CIRCULATI A LAYOUT APPROVED

REVISION DATE

OF NEW MA

M4Y 18 2016


LAND DEVELOPMENT SECTION

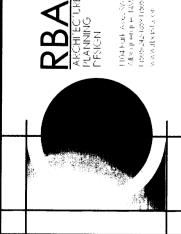


DATE 05-17-2016

SHEET NUMBER

AS-1.0

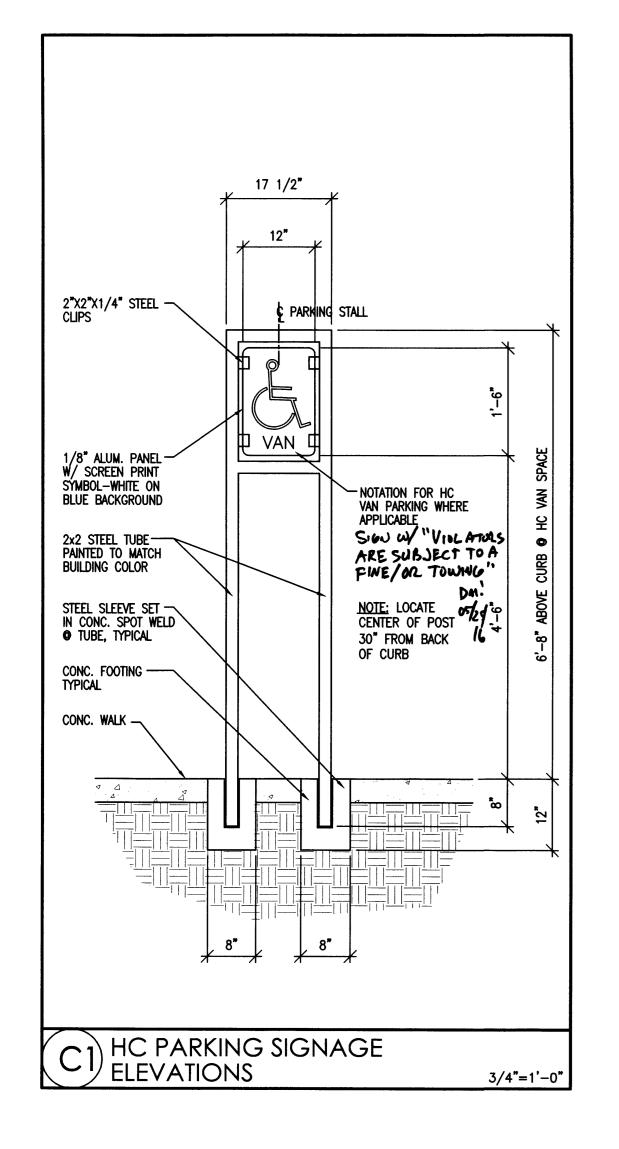


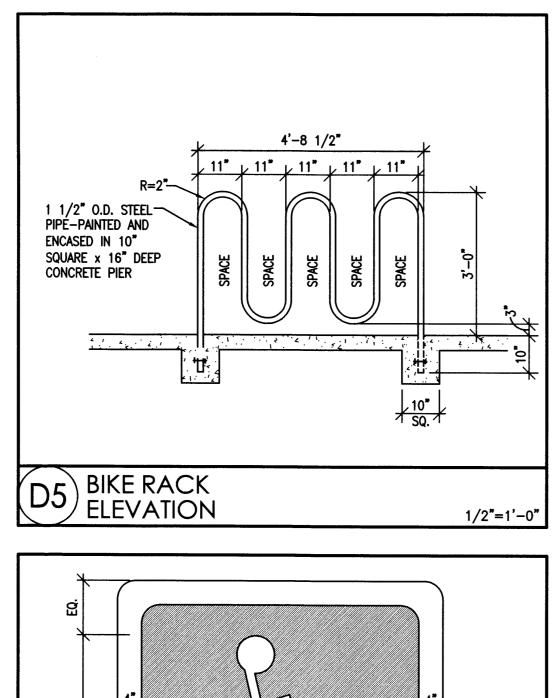



3'-0"

4'-6" SQ.


_k 8'-6"

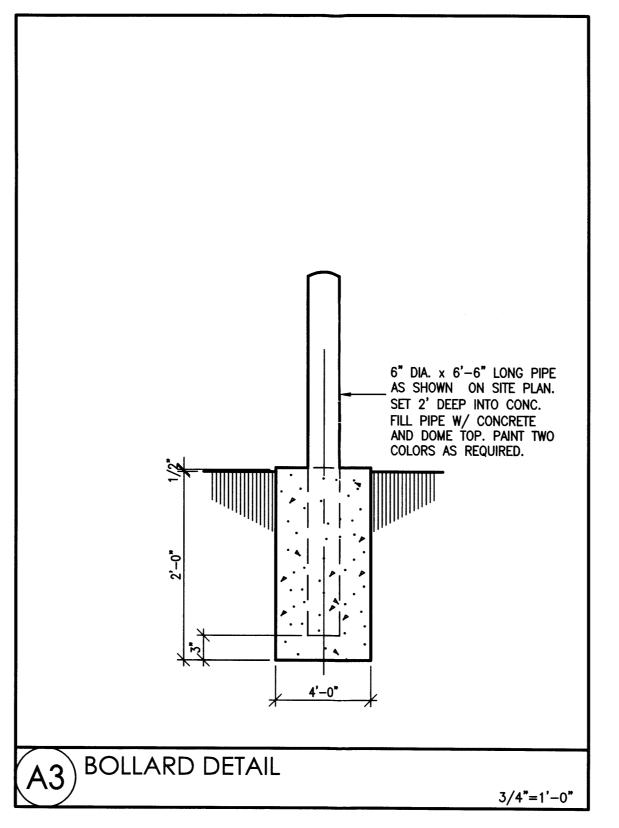


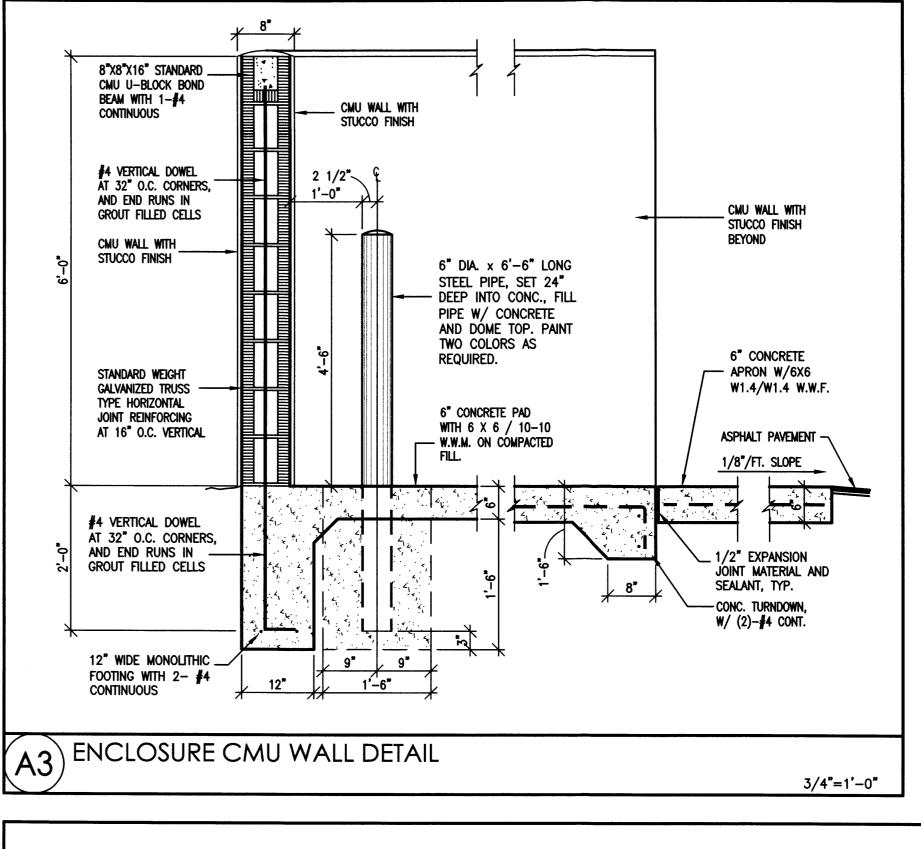


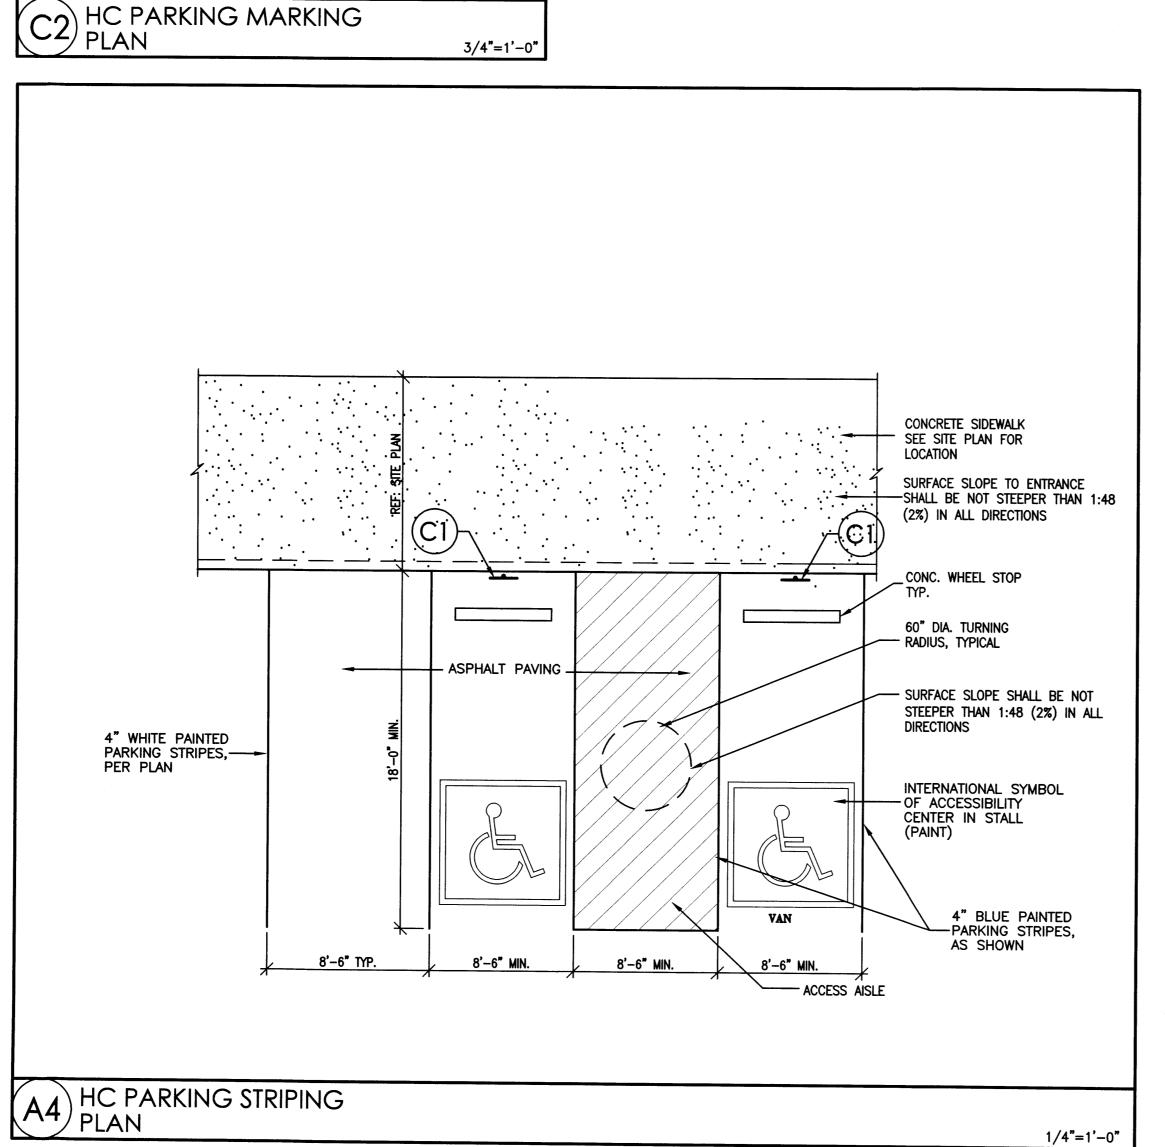

-BLUE FIELD

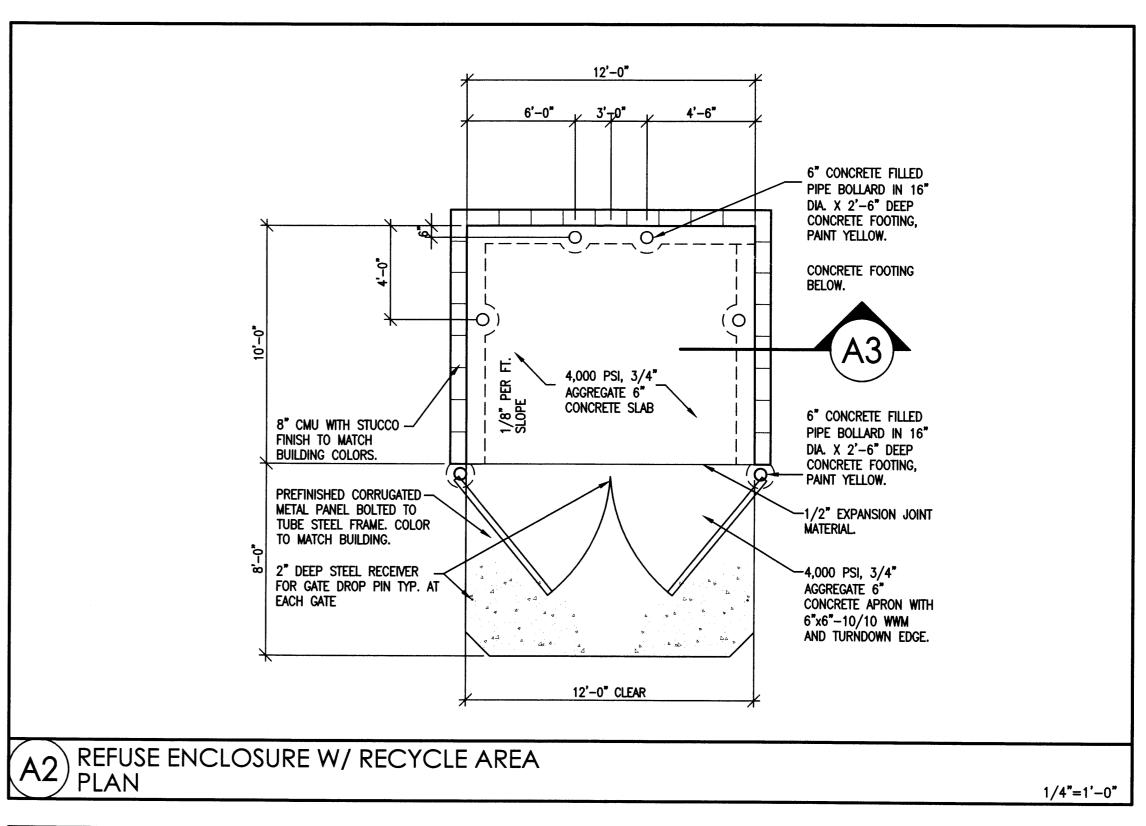

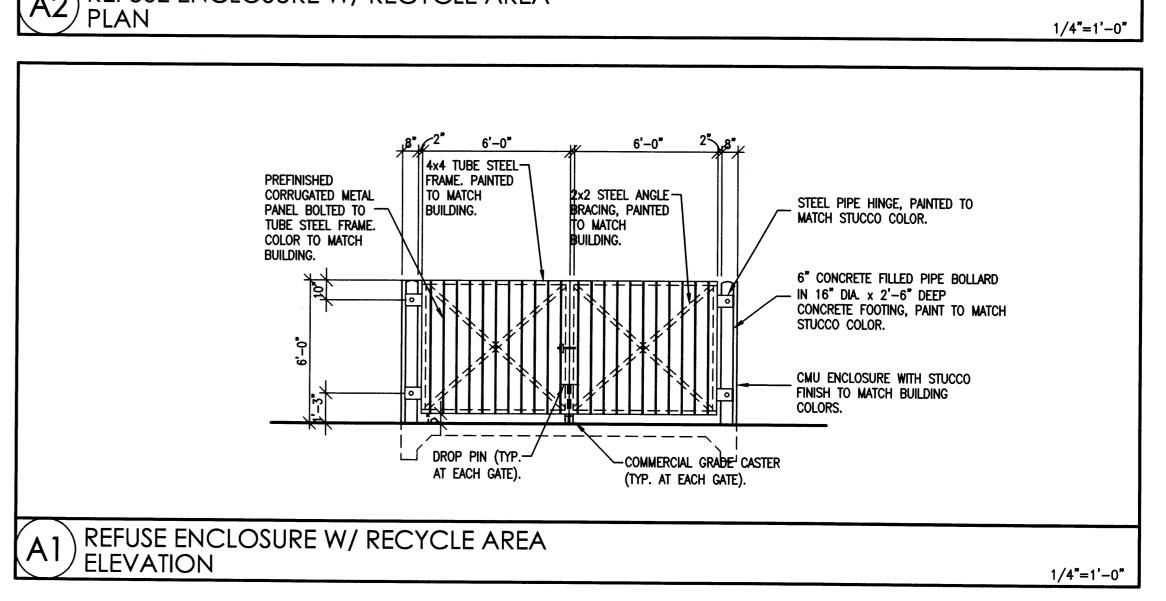

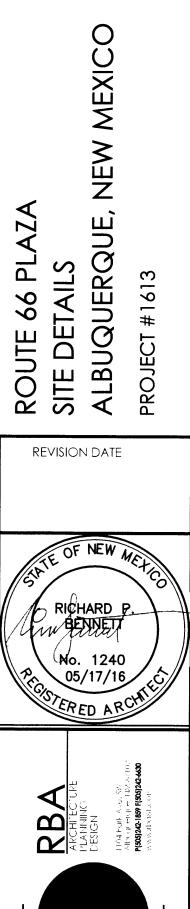

05-17-2016

AS-2.0

SHEET NUMBER