# CITY OF ALBUQUERQUE

*Planning Department* Brennon Williams, Director



Mayor Timothy M. Keller

April 29, 2022

Patricia Hancock, RA SMPC Architects 219 Central Ave. NW Albuquerque, NM 87104

#### Re: Fiesta Subaru 7100 Lomas Blvd. NE 4400 Cutler Ave. NE Traffic Circulation Layout Architect's Stamp 4-28-22 (K19-D108A)

Dear Ms. Hancock,

The TCL submittal received 04-7-2022 is approved for Building Permit with. A copy of the stamped and signed plan will be needed for each of the building permit plans. Please keep the original to be used for certification of the site for final C.O. for Transportation.

When the site construction is completed and an inspection for Certificate of Occupancy (C.O.) is requested, use the original City stamped approved TCL for certification. Redline any minor changes and adjustments that were made in the field. A NM registered architect or engineer must stamp, sign, and date the certification TCL along with indicating that the development was built in "substantial compliance" with the TCL. Submit this certification, the TCL, and a completed Drainage and Transportation Information Sheet to front counter personnel for log in and evaluation by Transportation.

<sup>NM 87103</sup> Once verification of certification is completed and approved, notification will be made to Building Safety to issue Final C.O. To confirm that a final C.O. has been issued, call Building Safety at 924-3690.

www.cabq.gov

eanne Wolfenbarger

Sincerely,

Jeanne Wolfenbarger, P.E. Traffic Engineer, Planning Dept. Development Review Services

\xxx via: emailC: CO Clerk, File



## City of Albuquerque

Planning Department Development & Building Services Division DRAINAGE AND TRANSPORTATION INFORMATION SHEET (REV 11/2018)

Project Title:	Building	Permit #: Hydrology File #:
DRB#:	EPC#:	Work Order#:
Legal Description:		
City Address:		
Applicant:		Contact:
Address:		
		E-mail:
Owner:		Contact:
Address:		
		E-mail:
TYPE OF SUBMITTAL: PLAT (	# OF LOTS)	RESIDENCE DRB SITE ADMIN SITE
IS THIS A RESUBMITTAL?:	Yes	No
DEPARTMENT: TRAFFIC/ TRAN	SPORTATION _	HYDROLOGY/ DRAINAGE
Check all that Apply: <b>TYPE OF SUBMITTAL:</b> ENGINEER/ARCHITECT CERTIFICA PAD CERTIFICATION CONCEPTUAL G & D PLAN GRADING PLAN DRAINAGE MASTER PLAN	ATION	TYPE OF APPROVAL/ACCEPTANCE SOUGHT: BUILDING PERMIT APPROVAL CERTIFICATE OF OCCUPANCY PRELIMINARY PLAT APPROVAL SITE PLAN FOR SUB'D APPROVAL SITE PLAN FOR BLDG. PERMIT APPROVAL EINAL PLAT APPROVAL
DRAINAGE MASTER PLAN DRAINAGE REPORT FLOODPLAIN DEVELOPMENT PER ELEVATION CERTIFICATE CLOMR/LOMR TRAFFIC CIRCULATION LAYOUT TRAFFIC IMPACT STUDY (TIS) OTHER (SPECIFY) PRE-DESIGN MEETING?	(TCL)	FINAL PLAT APPROVAL SIA/ RELEASE OF FINANCIAL GUARANTEE FOUNDATION PERMIT APPROVAL GRADING PERMIT APPROVAL SO-19 APPROVAL PAVING PERMIT APPROVAL GRADING/ PAD CERTIFICATION WORK ORDER APPROVAL CLOMR/LOMR FLOODPLAIN DEVELOPMENT PERMIT OTHER (SPECIFY)
DATE SUBMITTED	Bv	

COA STAFF:

ELECTRONIC SUBMITTAL RECEIVED:

FEE PAID:



Traffic Control Layout Comment Response

- 1. Listed are the number of Bicycle parking spaces required by the IDO <u>Coordinate/discuss with</u> <u>Zoning.</u> See revised bicycle Parking count
- 2. Louisiana/Lomas:

The Minimum Throat depth off an Arterial needs to be comply, please review DPM Design Criteria Table 7.4.81 Minimum Throat Length.

- Per Meeting March 14, 2022 Current layout will be approved pending adjustment of gates and ADA drives
- 3. An ADA ramp will need to be provided at the corner of Louisiana/Lomas. The existing ramp doesn't provide a minimum pathway width of 4ft to service ADA prior to ramp landing.
  - Sidewalks at cornet of Lomas and Louisiana have been changed to have a 48" clearance from the poer pole and the traffic light post
- 4. All existing drive pads off Louisiana and Lomas are not ADA accessible. So the will need to be ADA accessible and the design will need to be Curb Return since both roadways are classified as Arterial.
  - Drives need to have accessible path. City prefers curb returns (COA STD DWG 2426)
- 5. Please label the name of side street on the eastern property. Chama?
  - Chama Street label added
- 6. Identify the right of way width, medians, curb cuts, and street widths on Chamas St. NE
  - See attached Chama ROW PDF
- 7. Provide details for all proposed pavement markings
  - Adding Pavement Details
    - PAINT 4" WIDE DOUBLE YELLOW STRIPE noted on Plan
      - PAINT 4" WIDE WHITE PARKING STRIPE noted on Plan
      - PAINT "NO PARKING" ON PAVEMENT. SEE DETAIL A1/AS501.
      - PAINTED DIRECTIONAL ARROW- See Added Detail A7/AS501
      - INSTALL VAN ACCESSIBLE PARKING SIGN & PAVEMENT MARKING. SEE DETAILS A1/AS501 & J10/AS102.
      - INSTALL CONCRETE WHEEL STOP PER DETAIL F7/AS501.
- 8. Chama's existing drive pads aren't ADA accessible and will need to be addressed.
  - Drives need to have accessible path. City prefers curb returns (COA STD DWG 2426)
- 9. Louisiana's, Lomas's and Chama's main access with proposed gates will need a setback of 20 feet to provide turnout.
  - Revised gate design attached.
- 10. A sidewalk easement will be needed at the corner of Louisiana/Lomas to encompass the full size of new ramp.
  - Sidewalk easement will be provided Precision
- 11. Provide turning templates for delivery vehicle.

### • Need BHI to provide templates


12. Maximum access width for arterial, collector, and local streets are as follows:

	Arterial & Collector	Local Streets
One-way Drive	20'-25'	12'-20'
Two-Lane Drive	22'-30'	22'-24'
Three-Lane Drive	24'-35'	22'-30'
Larger Vehicles	≤50′	≤30′

- Signage to be provided at entrance drives and at Service Drive BHI assist
- 13. The ADA access aisles shall have the words "NO PARKING" in capital letters, each of which shall be at least one foot high and at least two inches wide, placed at the rear of the parking space so as to be close to where an adjacent vehicle's rear tire would be placed. (66-1-4.1.B NMSA 1978)
  - ADA "NO PARKING" added
- 14. Motorcycle parking spaces: Label pavement MC.
  - Motorcycle Parking "MC" added
- 15. All bicycle racks shall be designed according to the following guidelines:
  - A. The rack shall be a minimum 30 inches tall and 18 inches wide. Added
  - B. The bicycle frame shall be supported horizontally at two or more places. Comb/toaster racks are not allowed. Rack changed see drawings
  - C. The rack shall be designed to support the bicycle in an upright position. See the IDO for additional information. Rack changed see drawings
  - D. The rack allows varying bicycle frame sizes and styles to be attached. The user is not required to lift the bicycle onto the bicycle rack. Rack changed see drawings
  - E. Each bicycle parking space is accessible without moving another bicycle. Layout clarified
- 16. Bicycle racks shall be sturdy and anchored to a concrete pad.
  - Add Bicycle detail
- 17. A 1-foot clear zone around the bicycle parking stall shall be provided.
  - Layout clarified see drawings
- 18. Bicycle parking spaces shall be at least 6 feet long and 2 feet wide.
  - Layout clarified see drawings
- 19. All internal radii's will need to be 15 feet.
  - Adjusted see drawings
- 20. Per the DPM, a 6 ft. wide ADA accessible pedestrian pathway is required from the public sidewalk to the building entrances. Please clearly show this pathway and provide details.
  - ADA path added to Louisiana
- 21. Per DPM, a 6 ft. wide ADA accessible pedestrian pathway is required from the ADA parking stall access aisles to the building entrances. Please clearly show this pathway and provide details.


- 22. All sidewalks along public streets need widths provided.
  - Added dimensions to Existing 6'-0" Sidewalks
- 23. Parking areas shall have barriers to prevent vehicles from extending over onto pedestrian pathway.
  - Added Parking bumpers
- 24. Provide a copy of refuse approval.
  - Attached
- 25. Fire Department: An approval Fire 1 plan needs to be provided.
  - Attached
- 26. Lomas and Louisiana: Show the intersection sight distance and add the following note to the plan: "Landscaping and signage will not interfere with clear sight requirements Sight distance @ Lomas and Louisiana Therefore, signs, walls, trees, and shrubbery between 3 and 8 feet tall (as measured from the gutter pan) will not be acceptable in the clear sight triangle.
  - Sight line clearance and note attached
- 27. Chamas St: Show the clear sight triangle and add the following note to the plan: "Landscaping and signage will not interfere with clear sight requirements. Therefore, signs, walls, trees, and shrubbery between 3 and 8 feet tall (as measured from the gutter pan) will not be acceptable in the clear sight triangle.
  - Sight line clearance and note attached
- 28. Please specify the City Standard Drawing Number when applicable.
  - City Standard Drawing Number have been added to drawings
- 29. Shared Site access: driveways that straddle property lines, or are entirely on one property but are to be used by another property, shall have an access easement. <u>Please provide a copy of the Access Easement for all properties abutting general lot and entrance access off Louisiana.</u>
  - See Attached plat showing this easement
- 30. Unused curb cuts must be replaced with sidewalk and curb & gutter. A build note must be provided referring to the appropriate City Standard drawing (2430 & 2415A). <u>Two have been identified but not addressed off Louisiana.</u>
  - Note added at existing curb cuts on Louisiana to be removed and city sidewalk and curb standard details
- Add a note stating "All broken or cracked sidewalk must be replaced with sidewalk and curb & gutter." A build note must be provided referring to the appropriate City Standard drawing (2430 & 2415A).
  - Note added to replace broken or cracked sidewalks
- 32. Please provide a letter of response for all comments given.
  - Included


- 33. Traffic Studies: See the Traffic Impact Study (TIS) thresholds. In general, a minimum combination of 100 vehicles entering and exiting in the peak hour warrants a Traffic Impact Study. Visit with Traffic Engineer for determination, and fill out a TIS Form that states whether one is warranted. In some cases, a trip generation may be requested for determination (Contact Matt Grush: mqrush@cabq.gov).
  - Traffic Study attached.

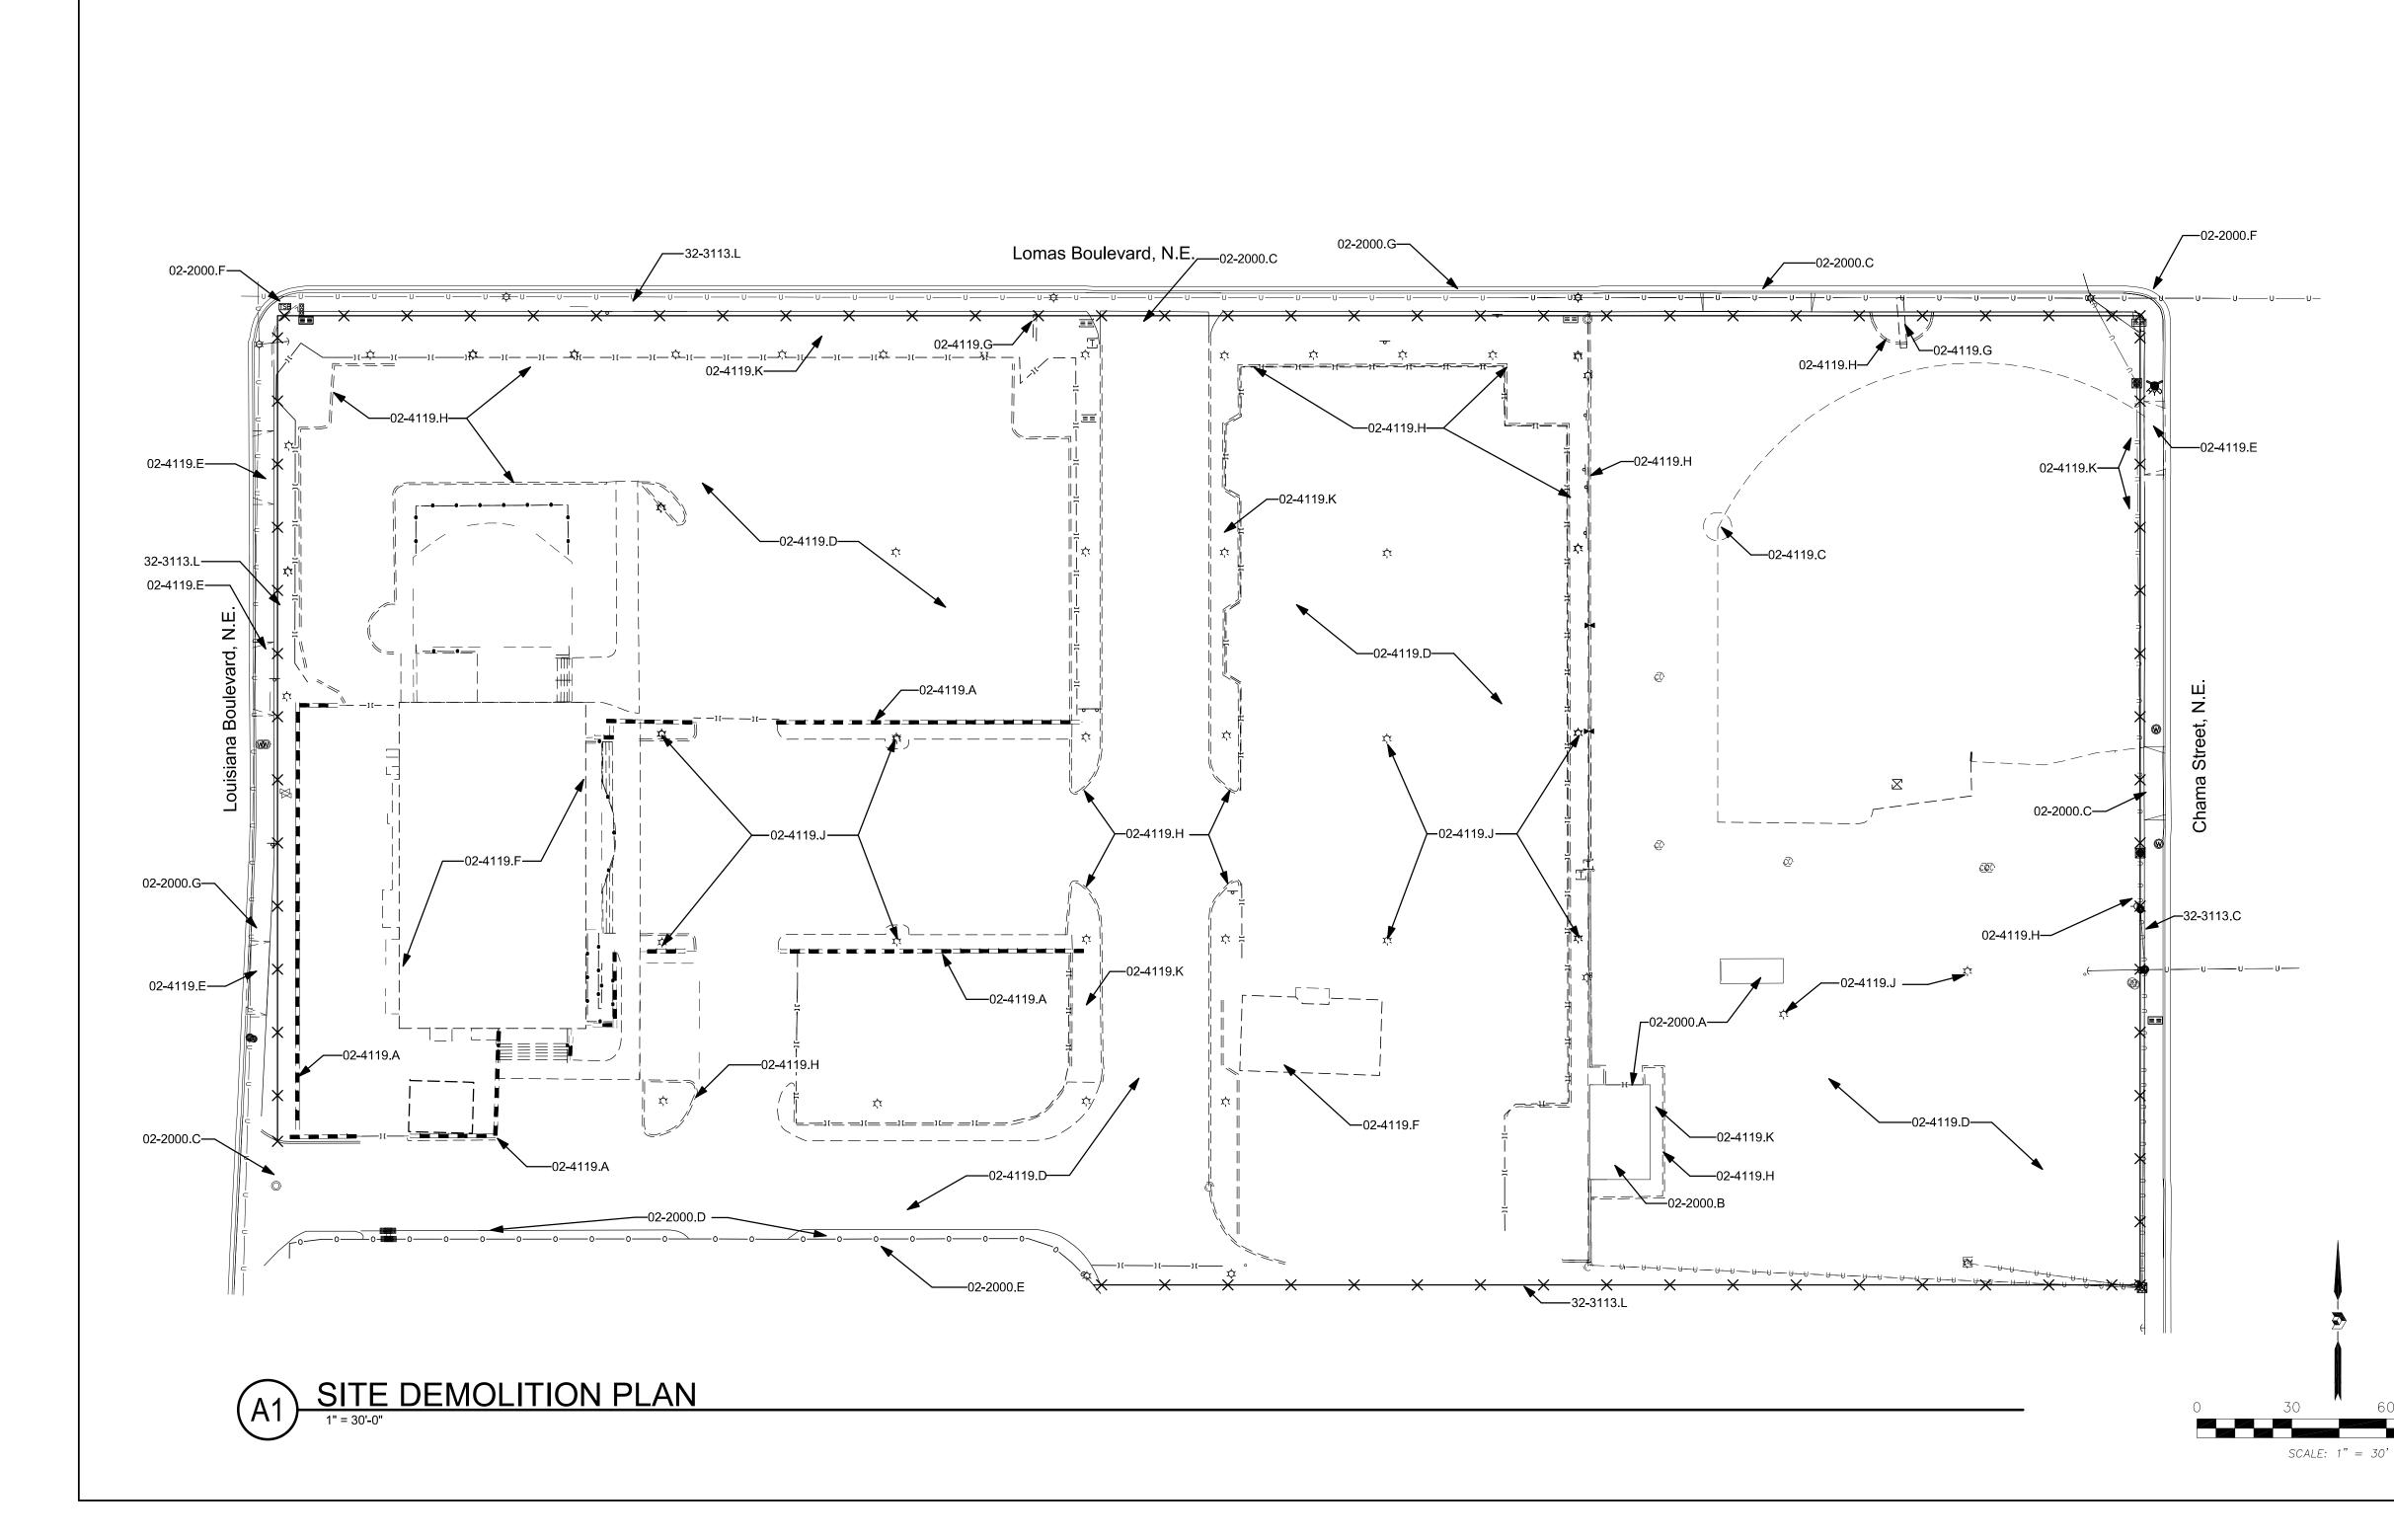



Jeanne Wolfenbarger


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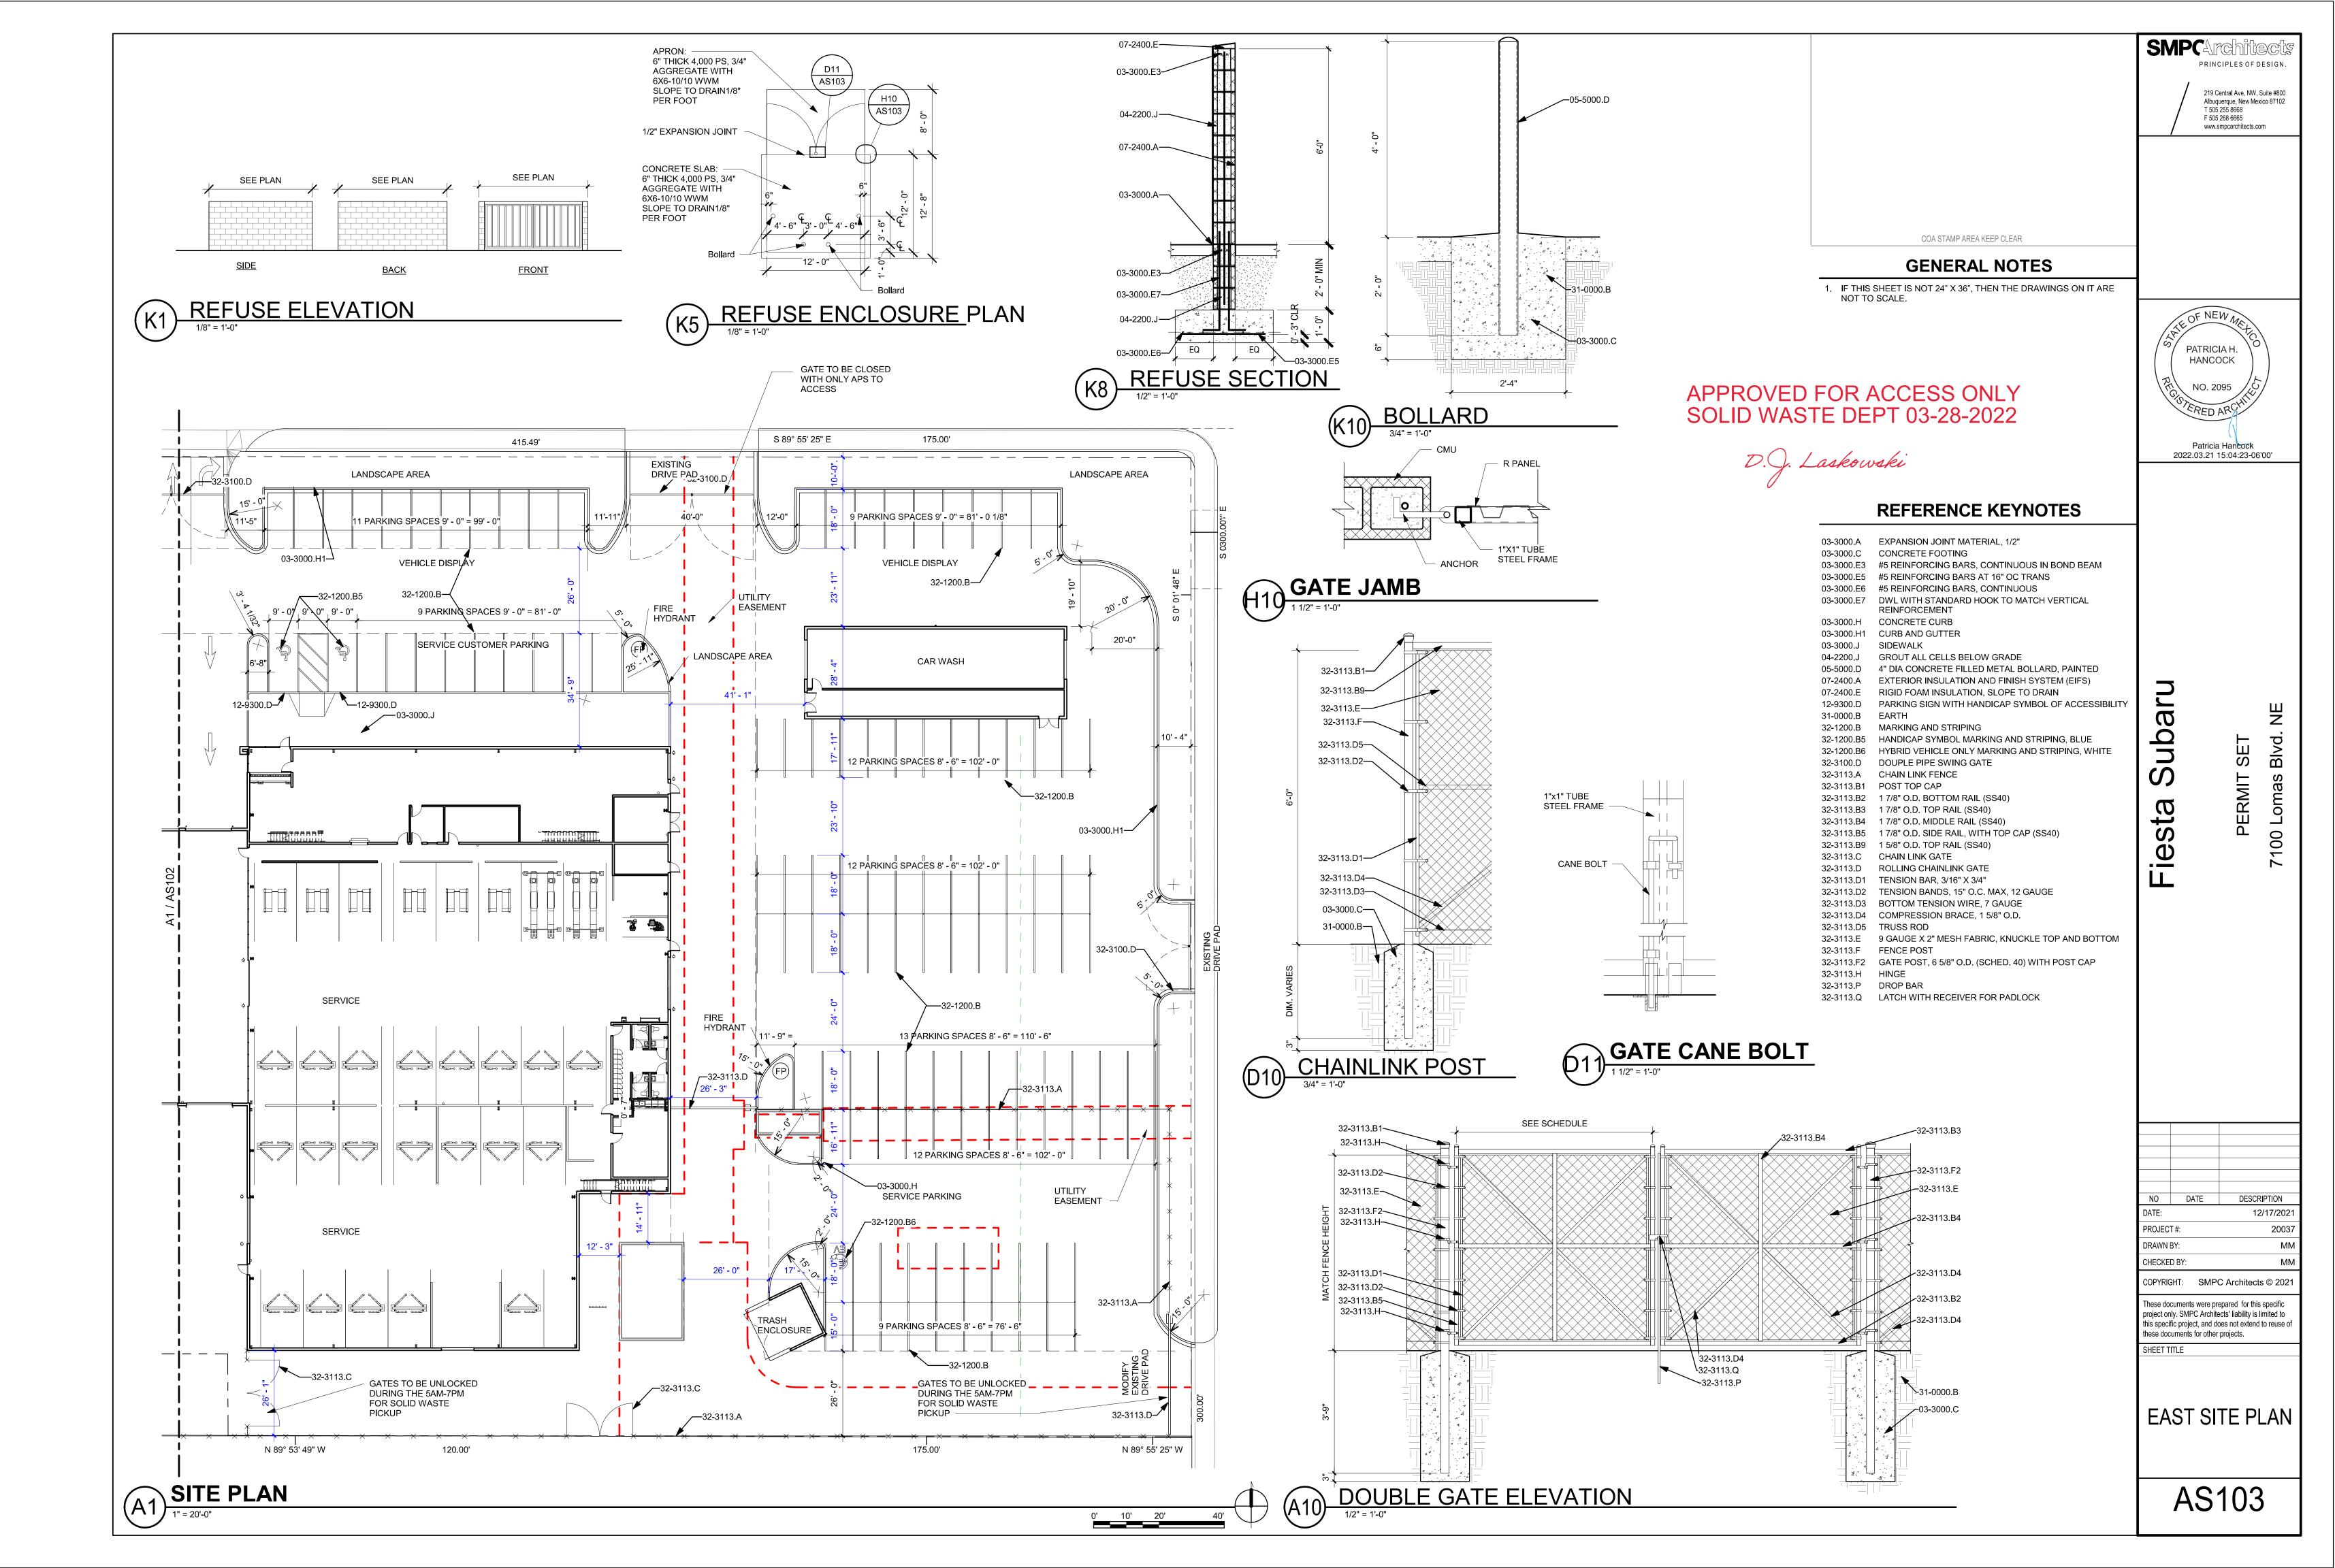


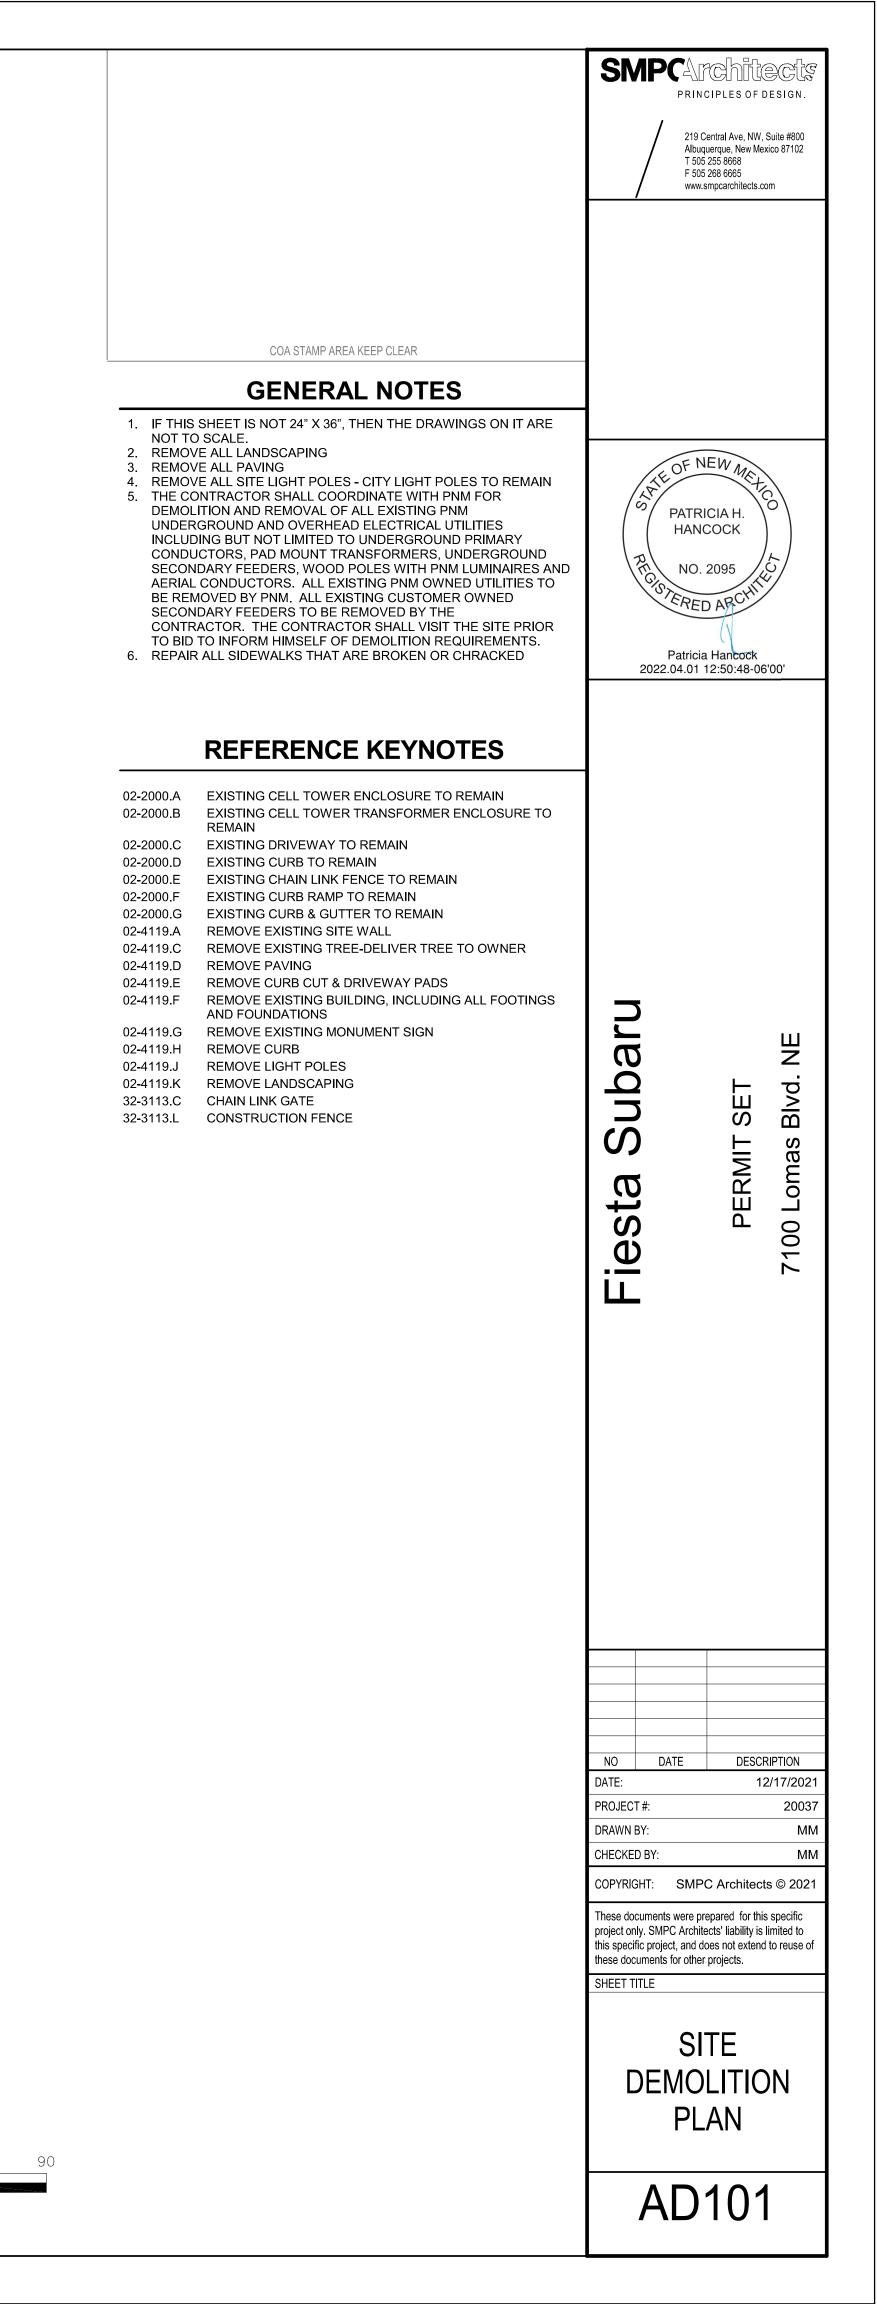


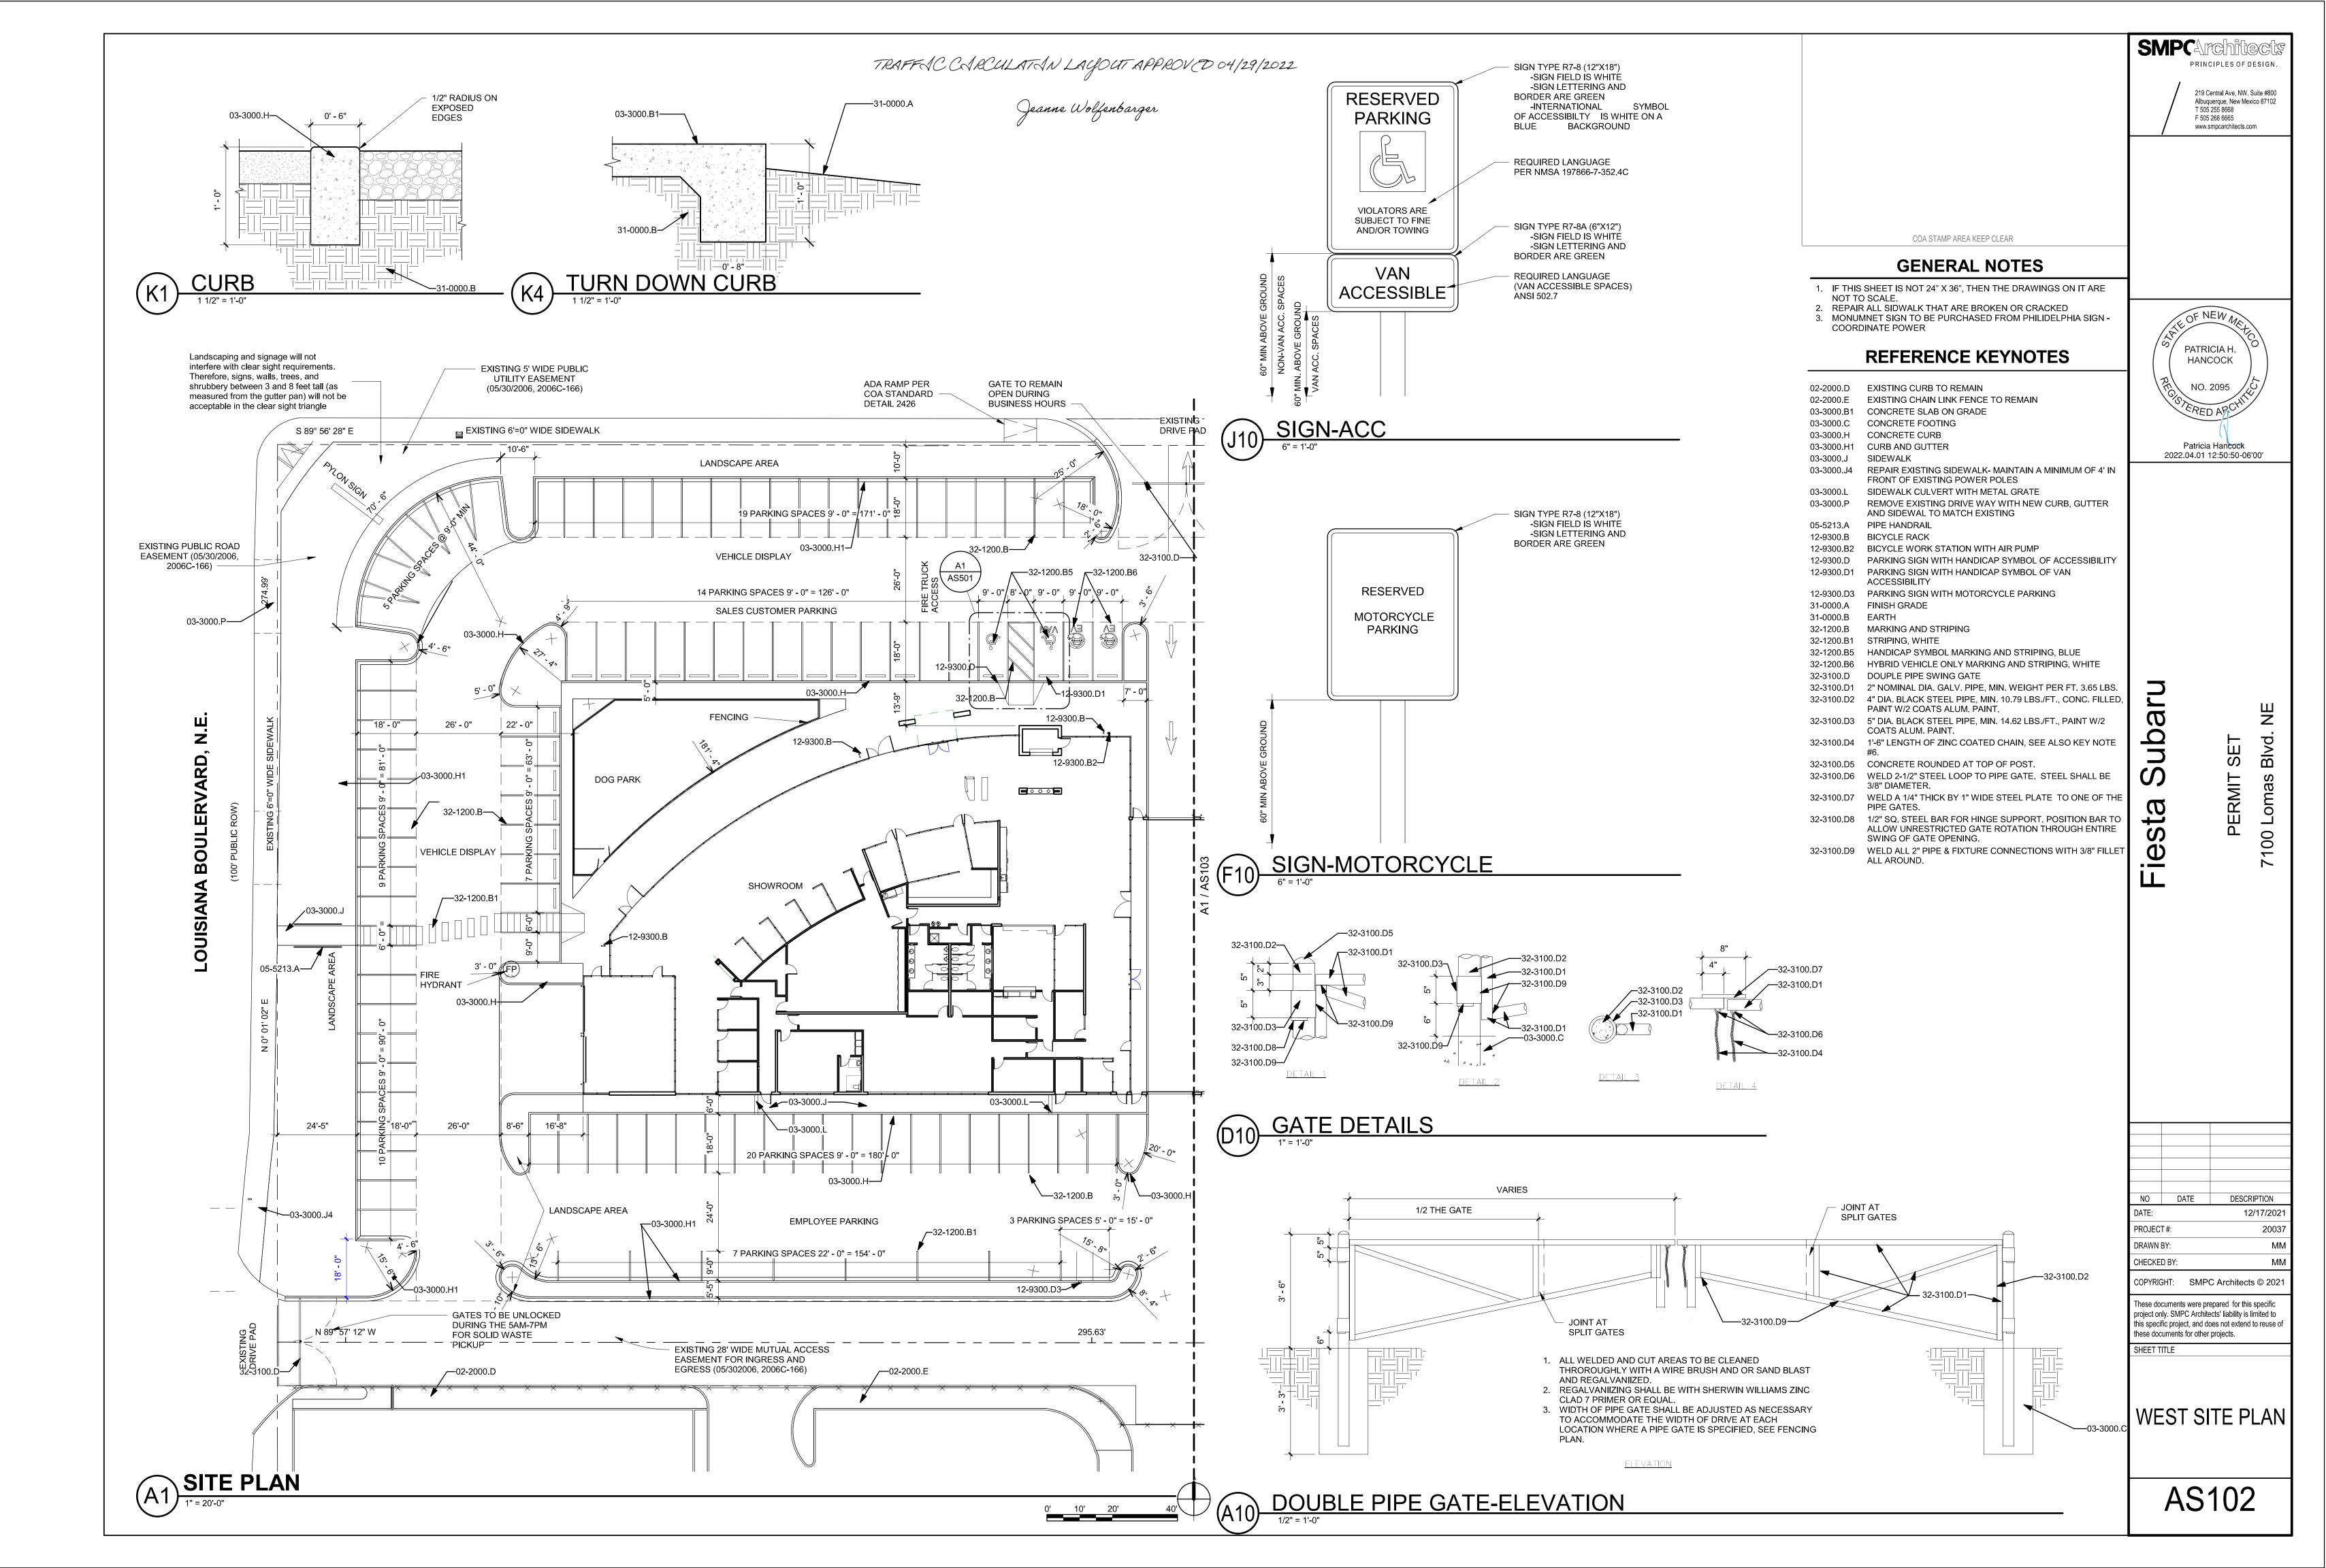

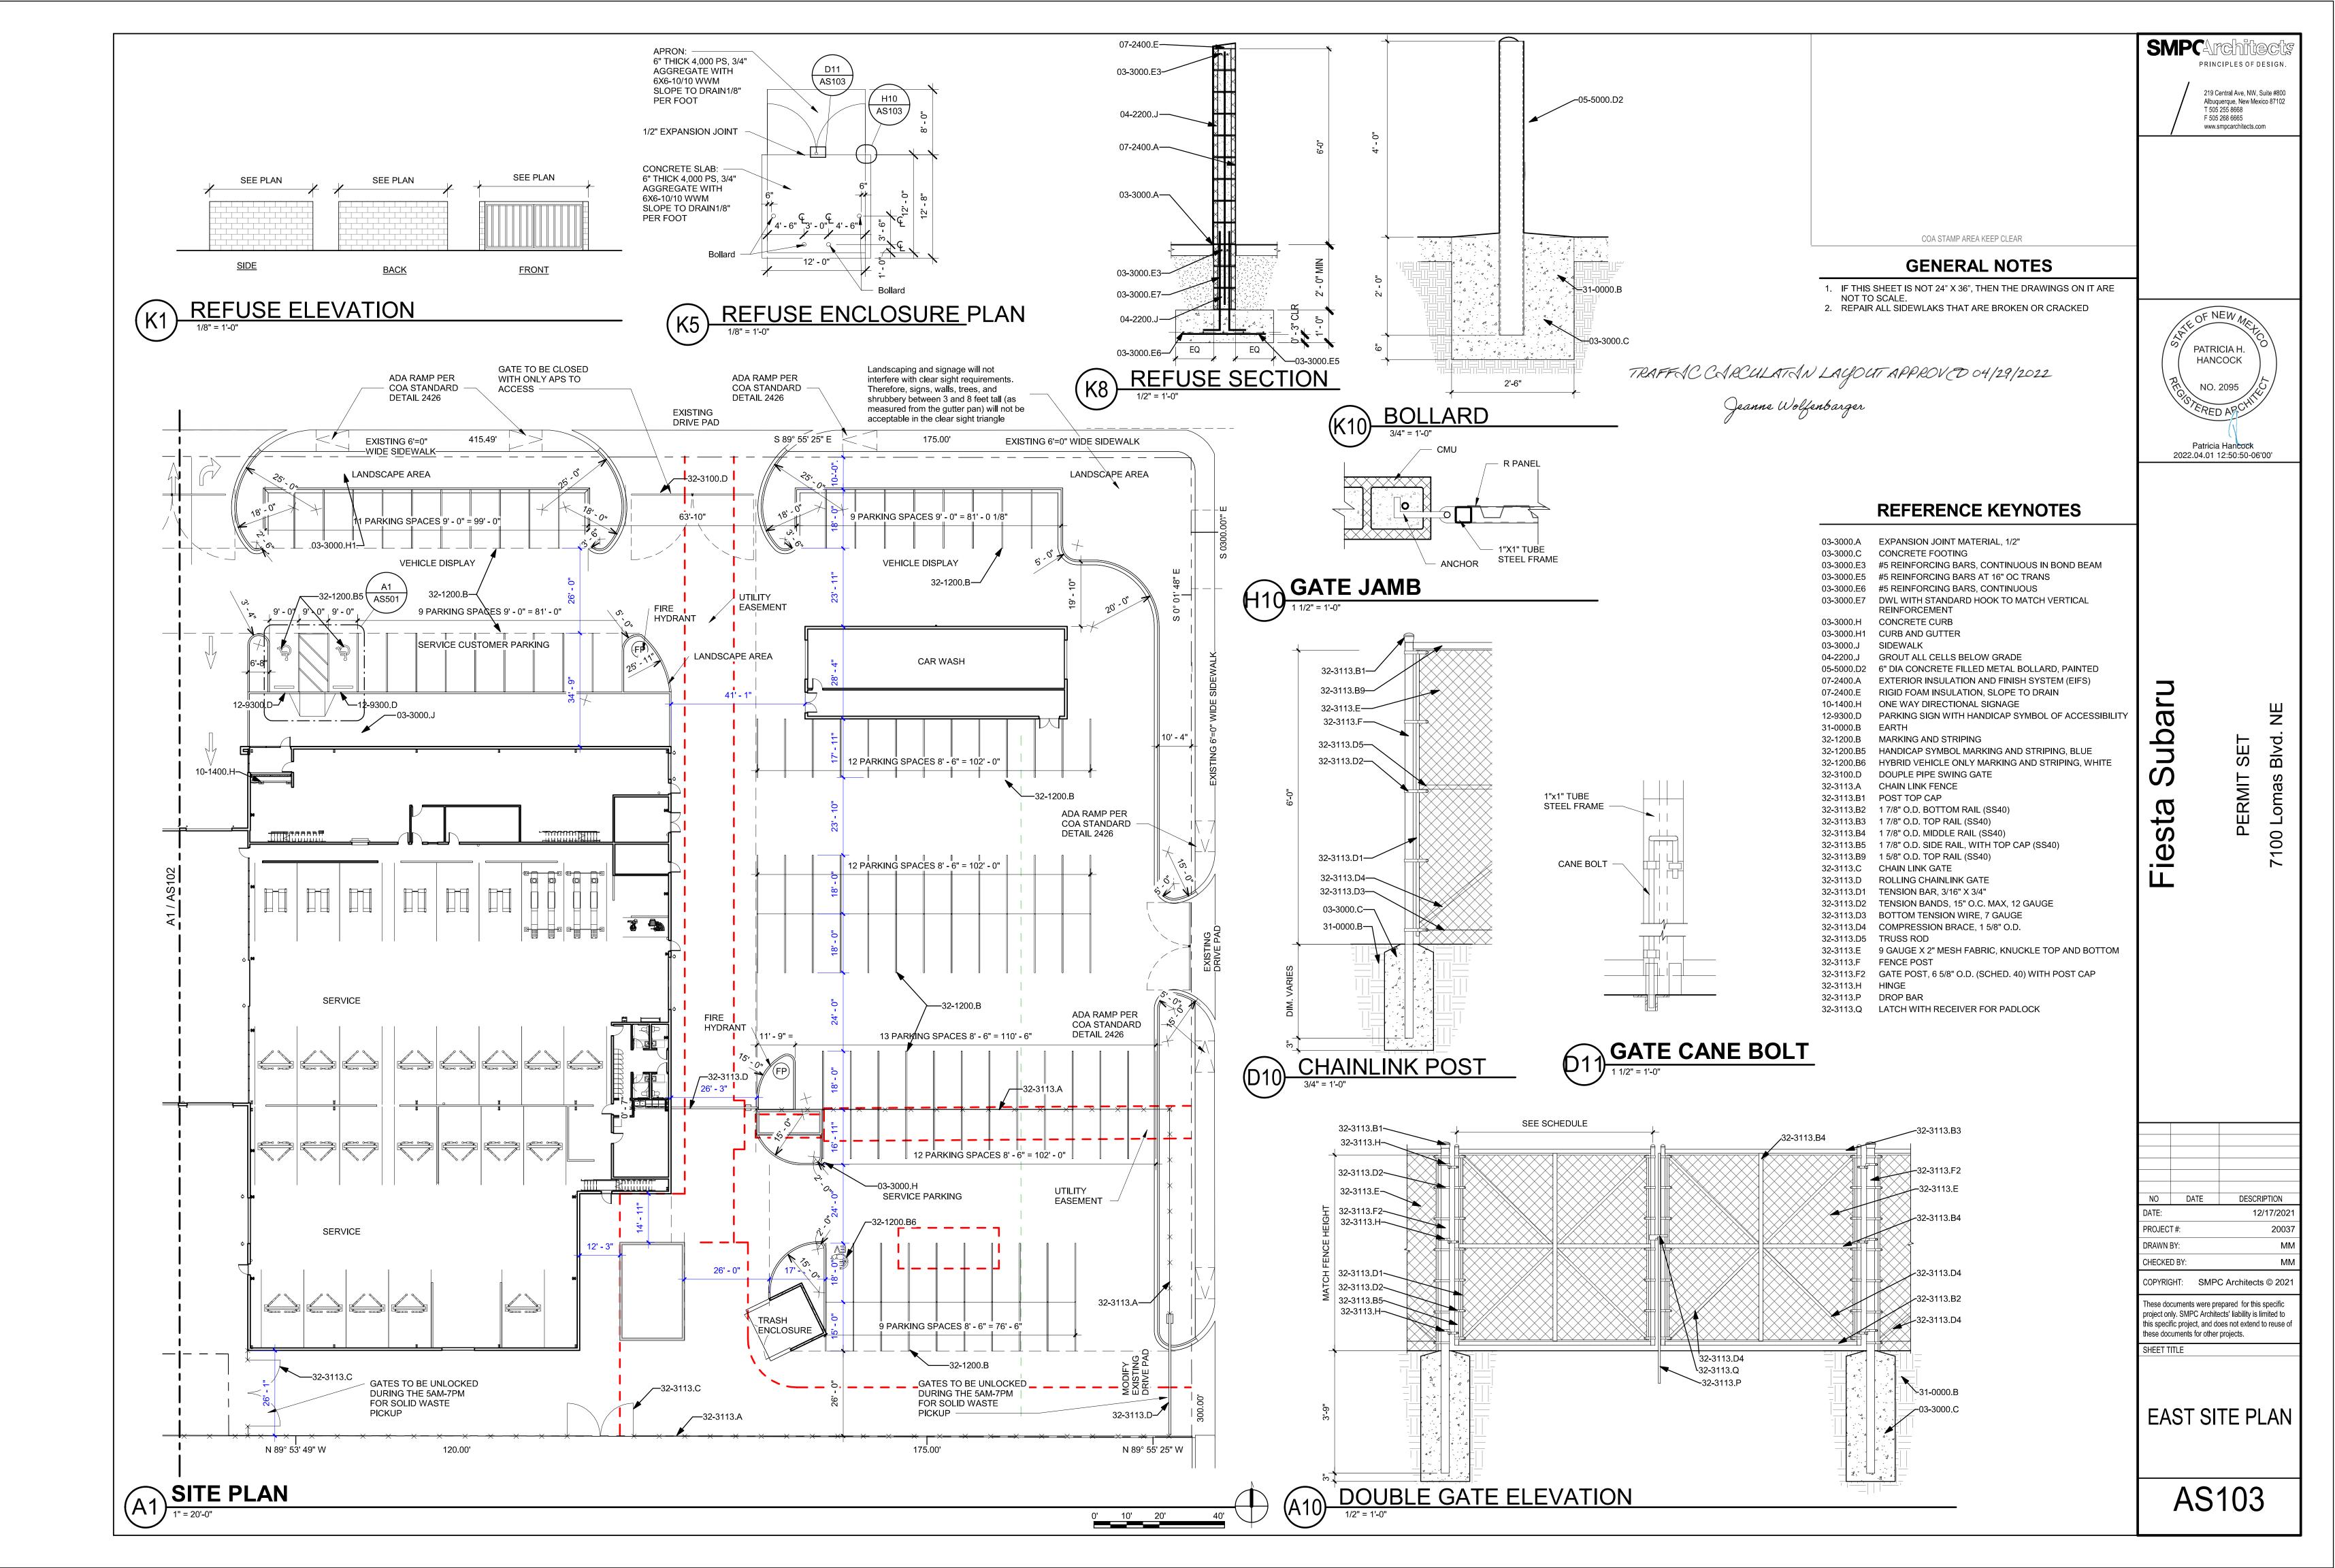


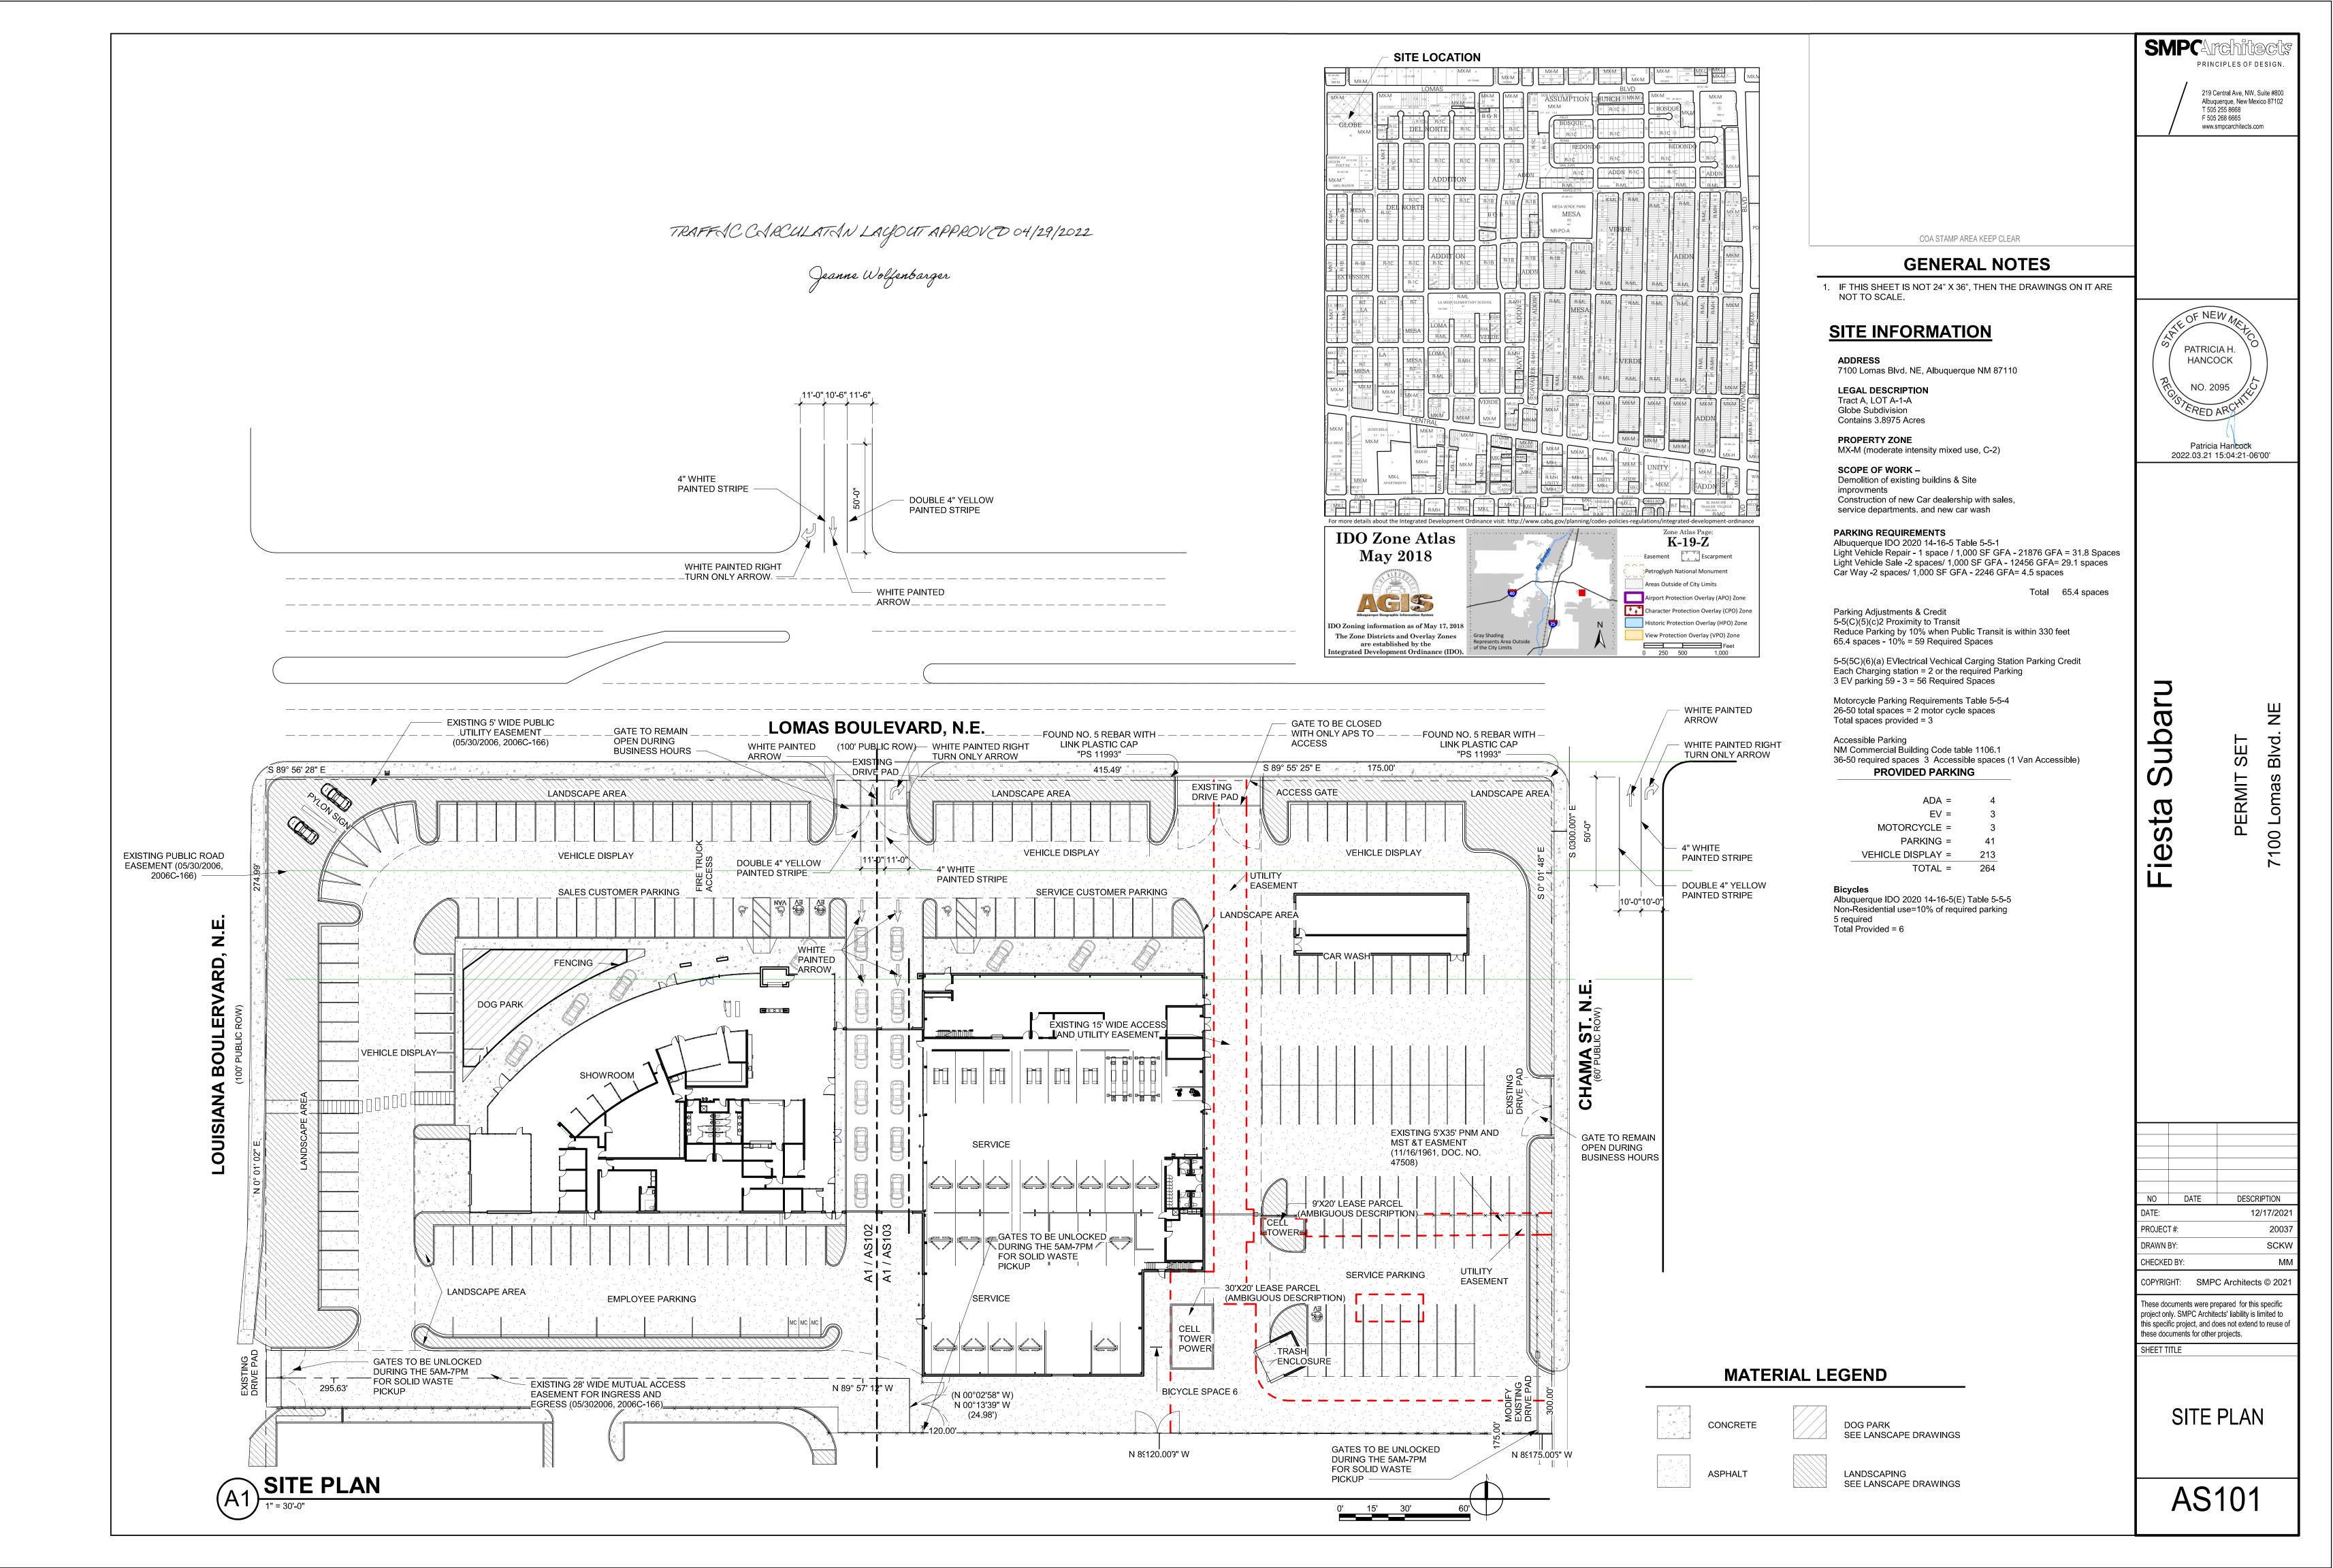


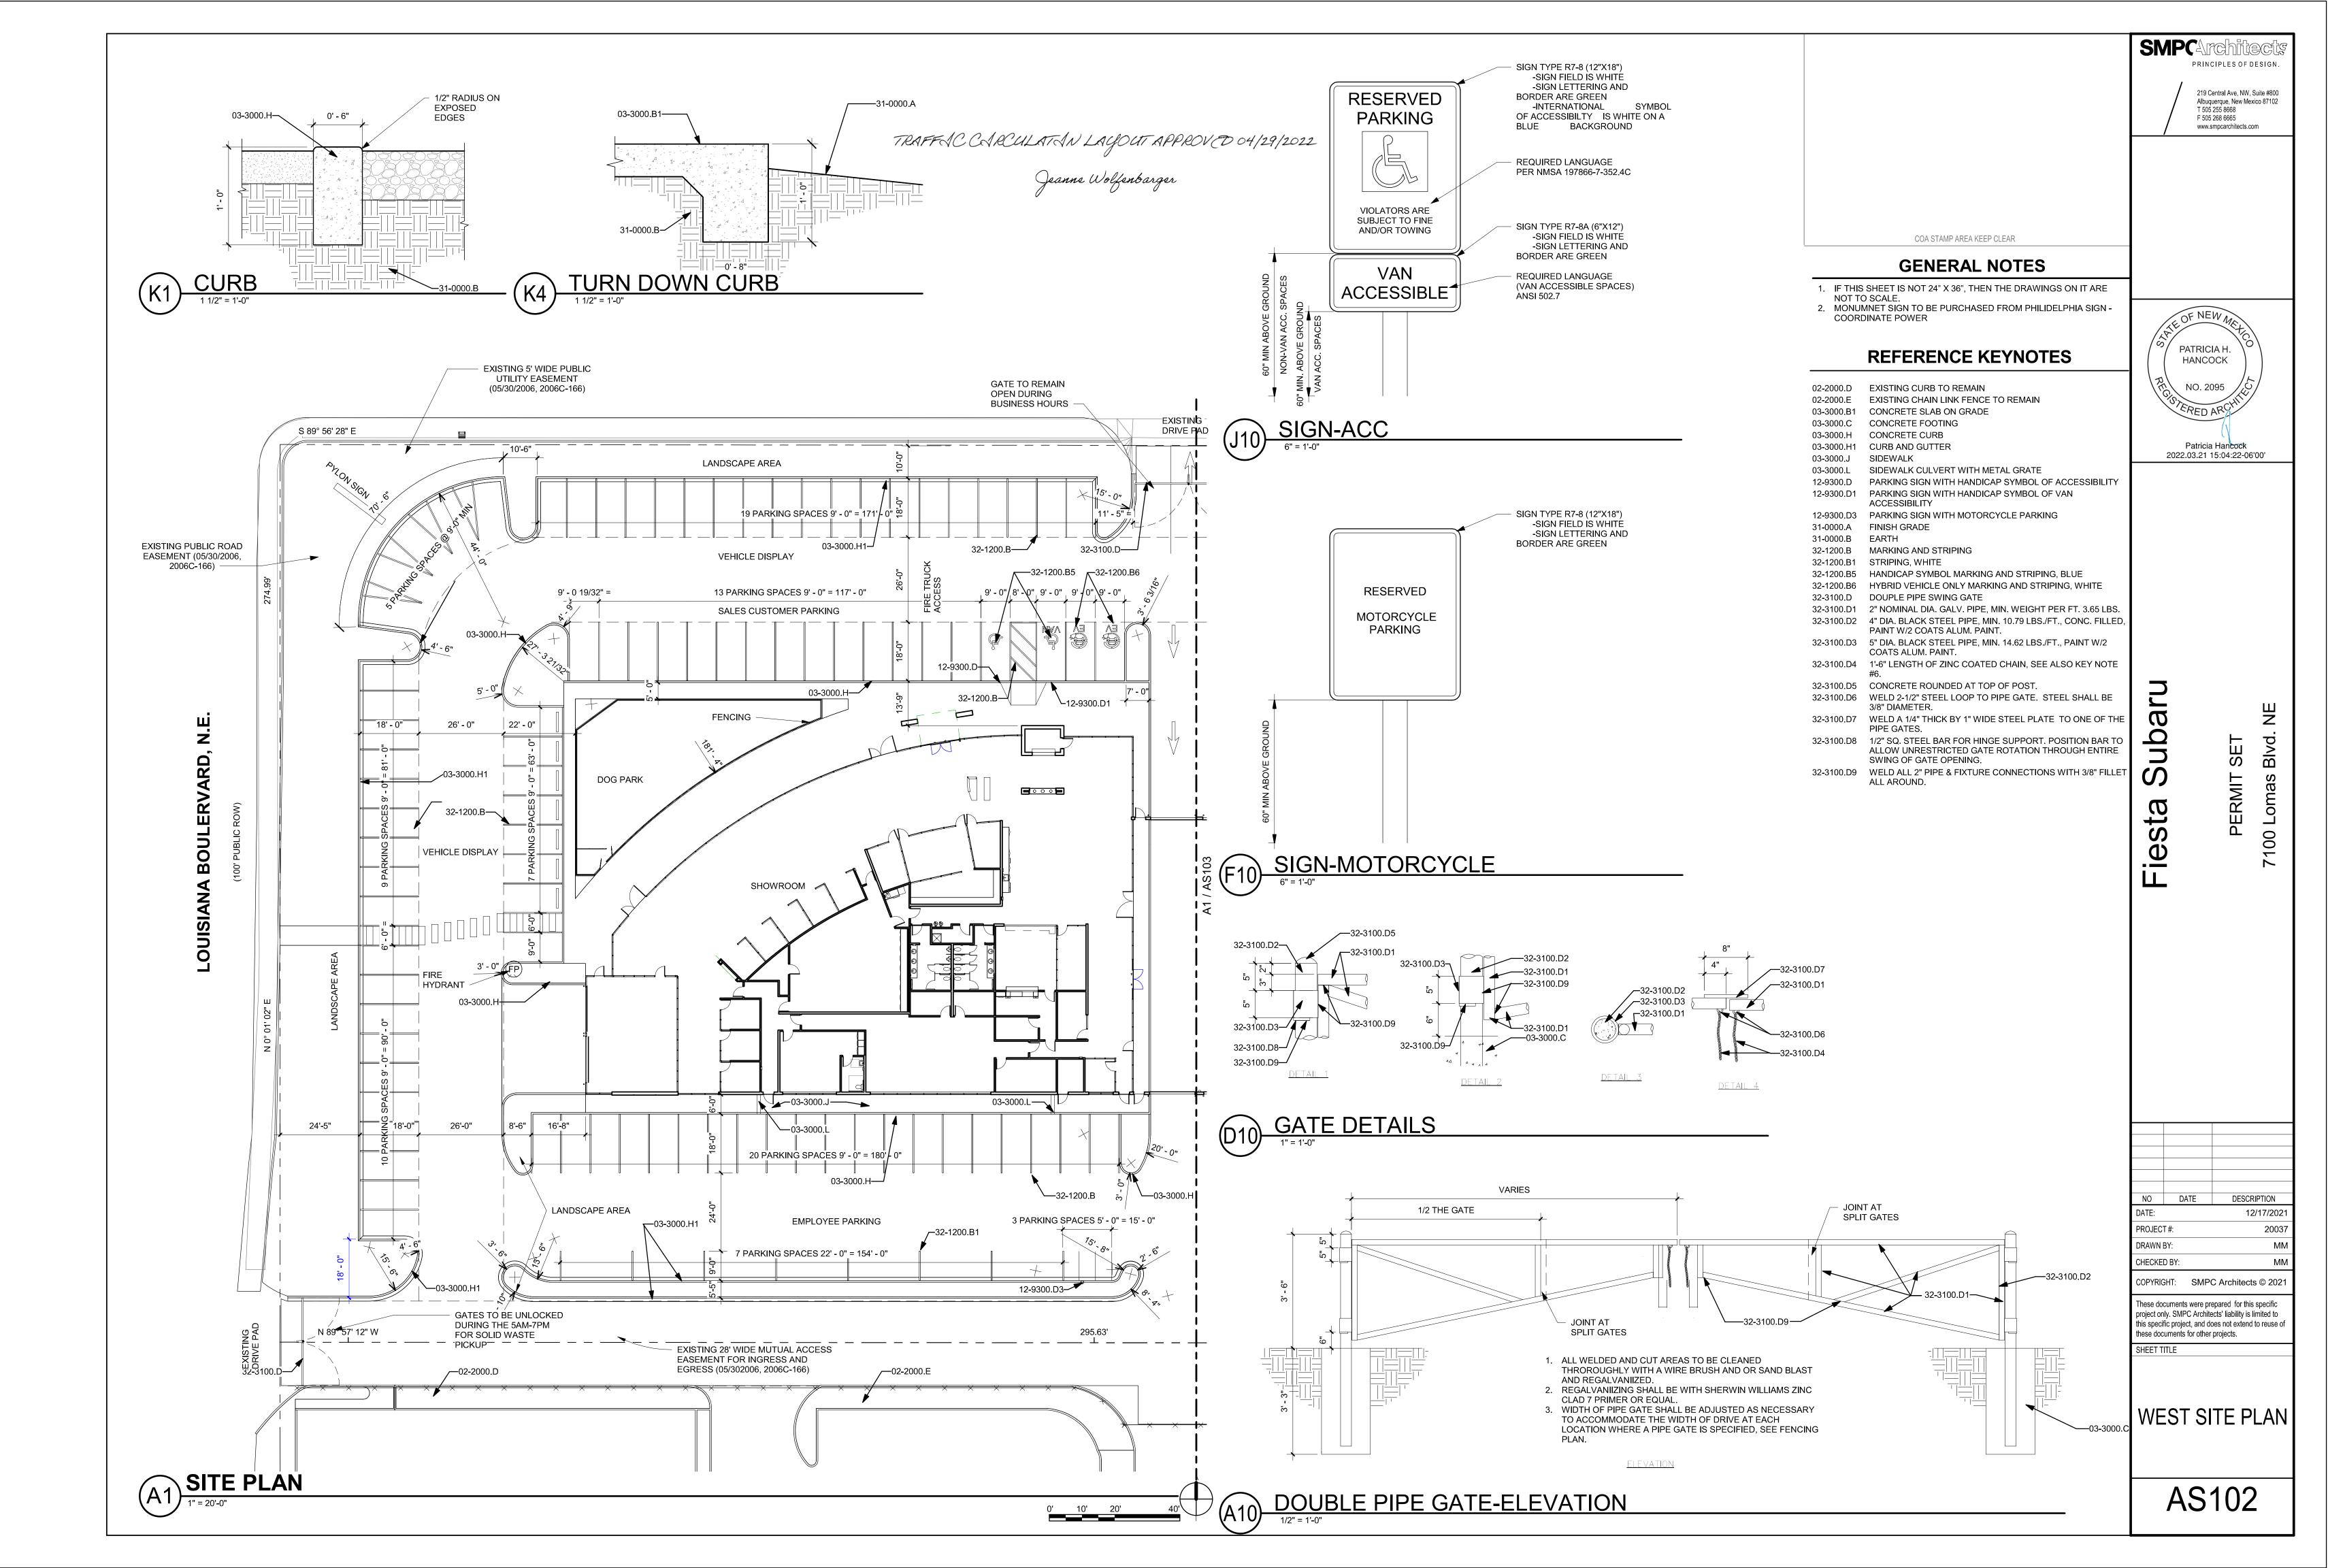

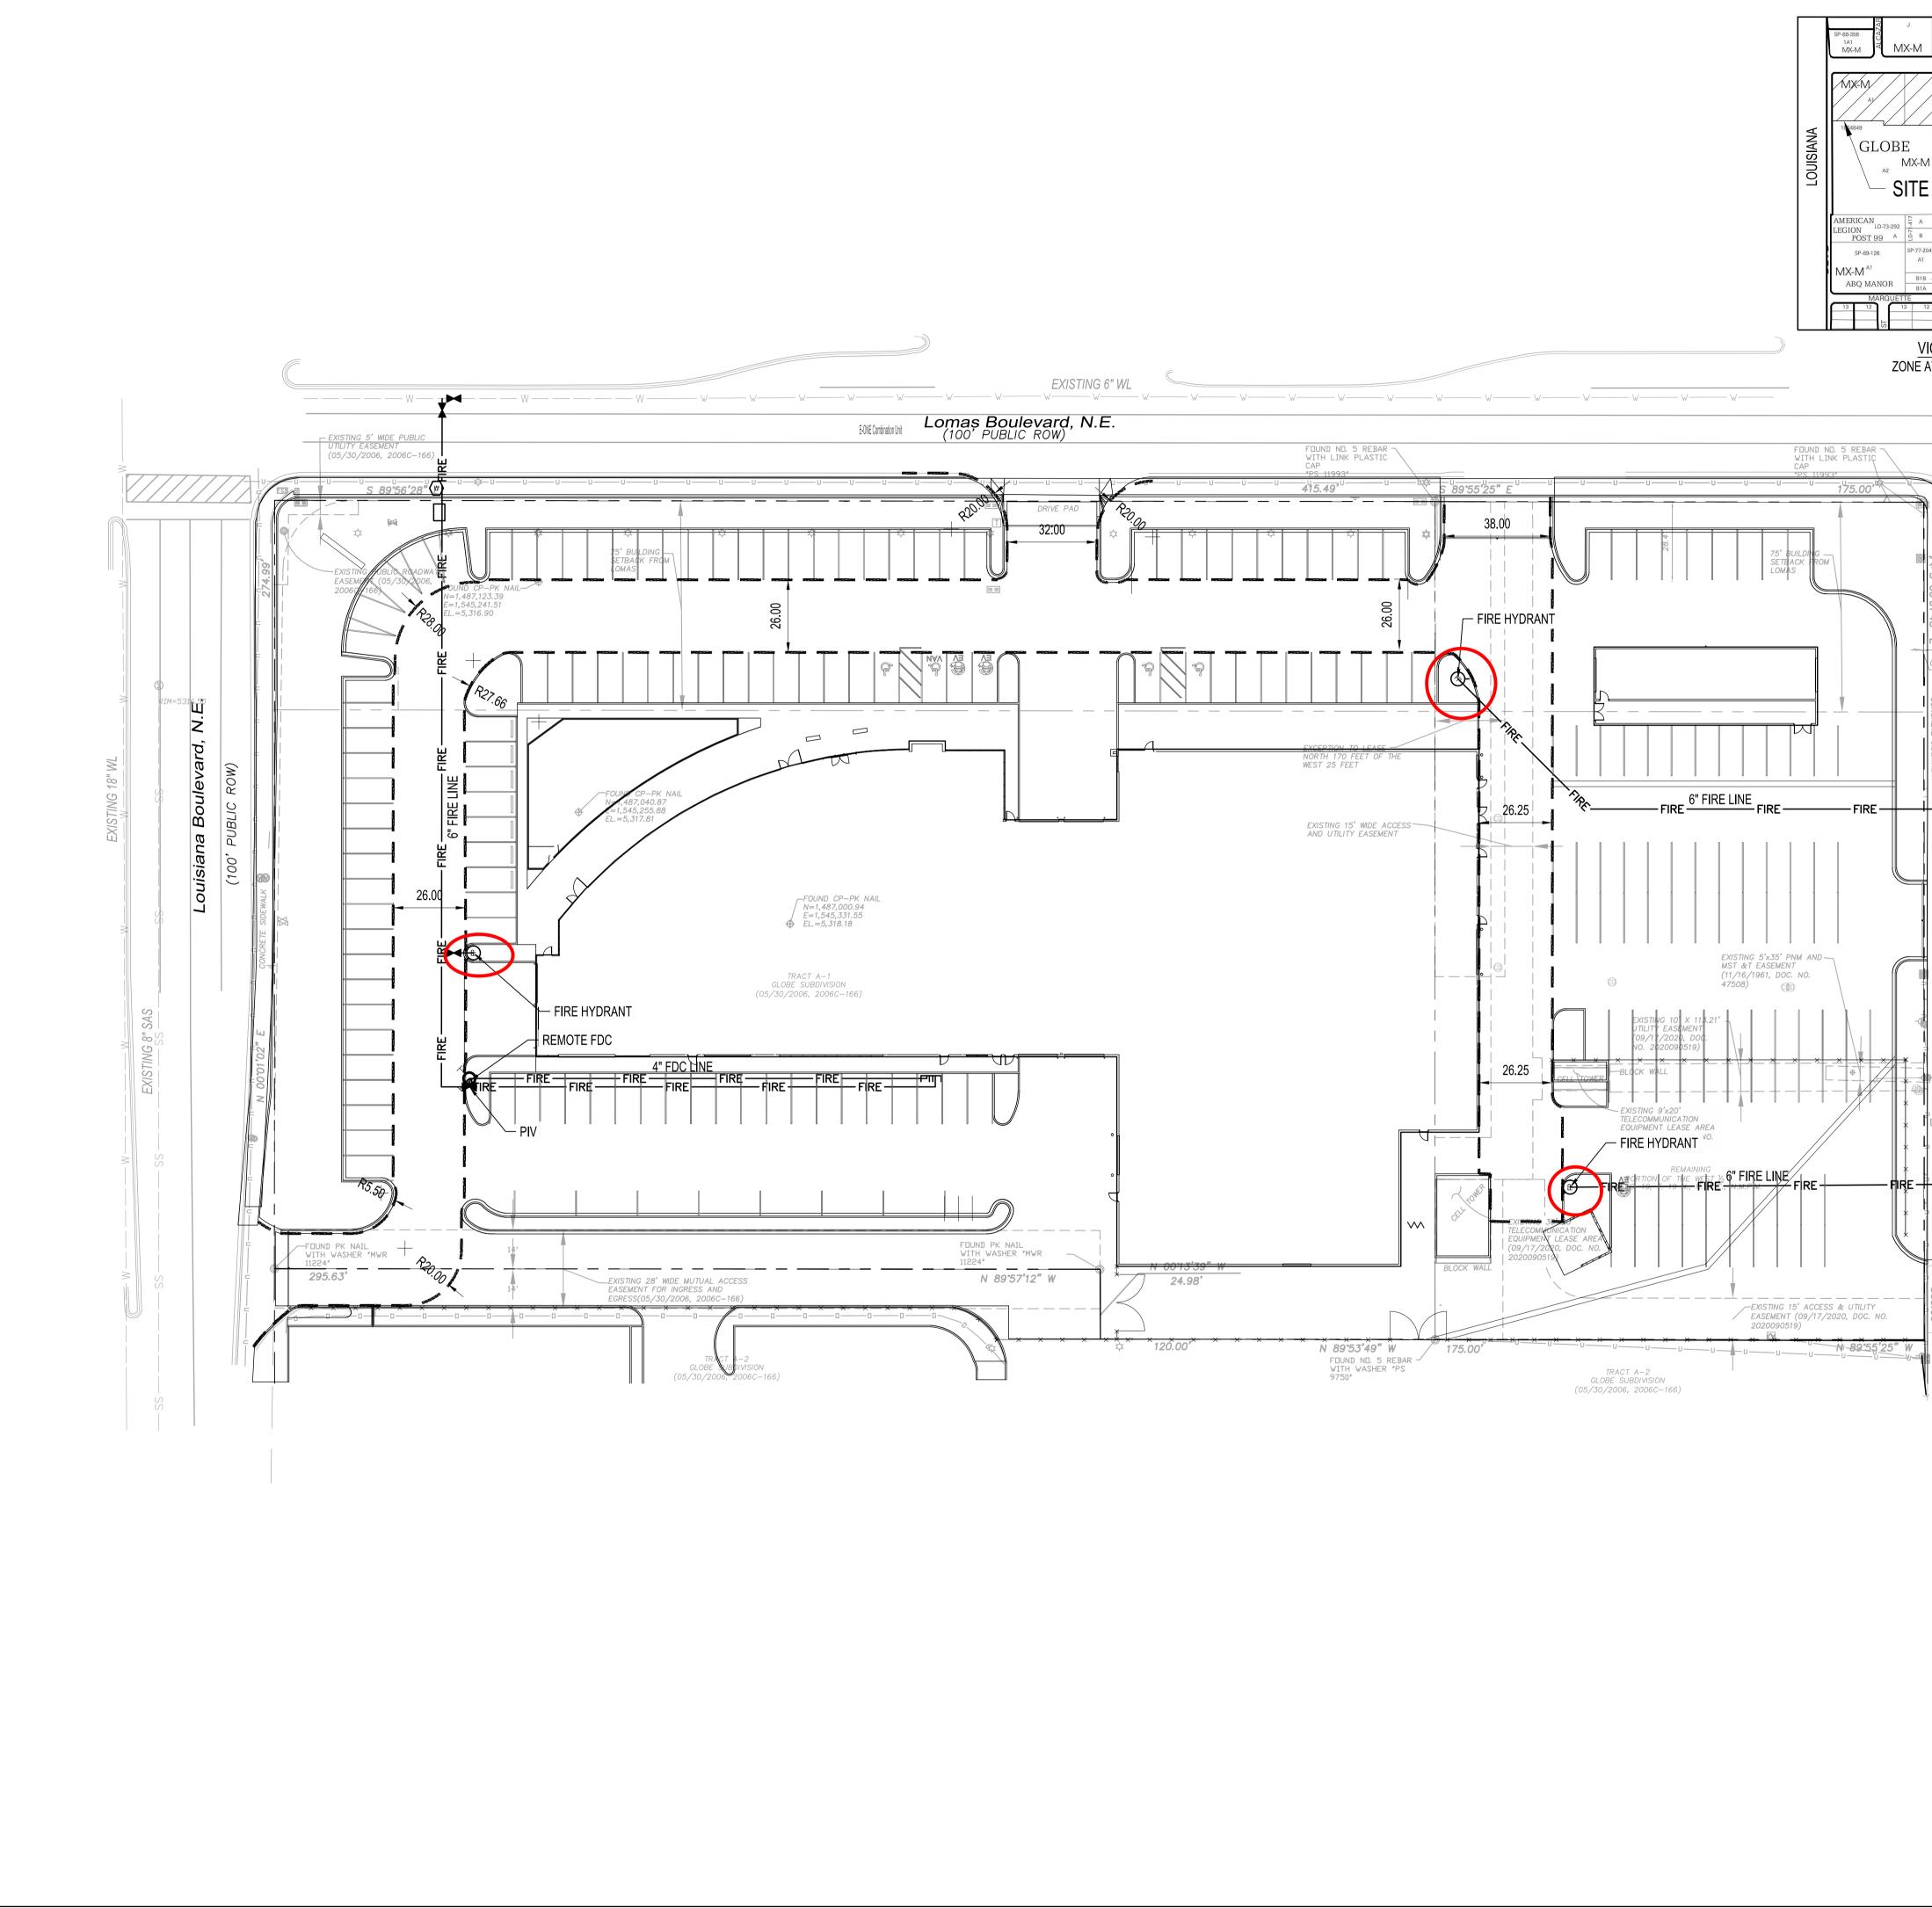

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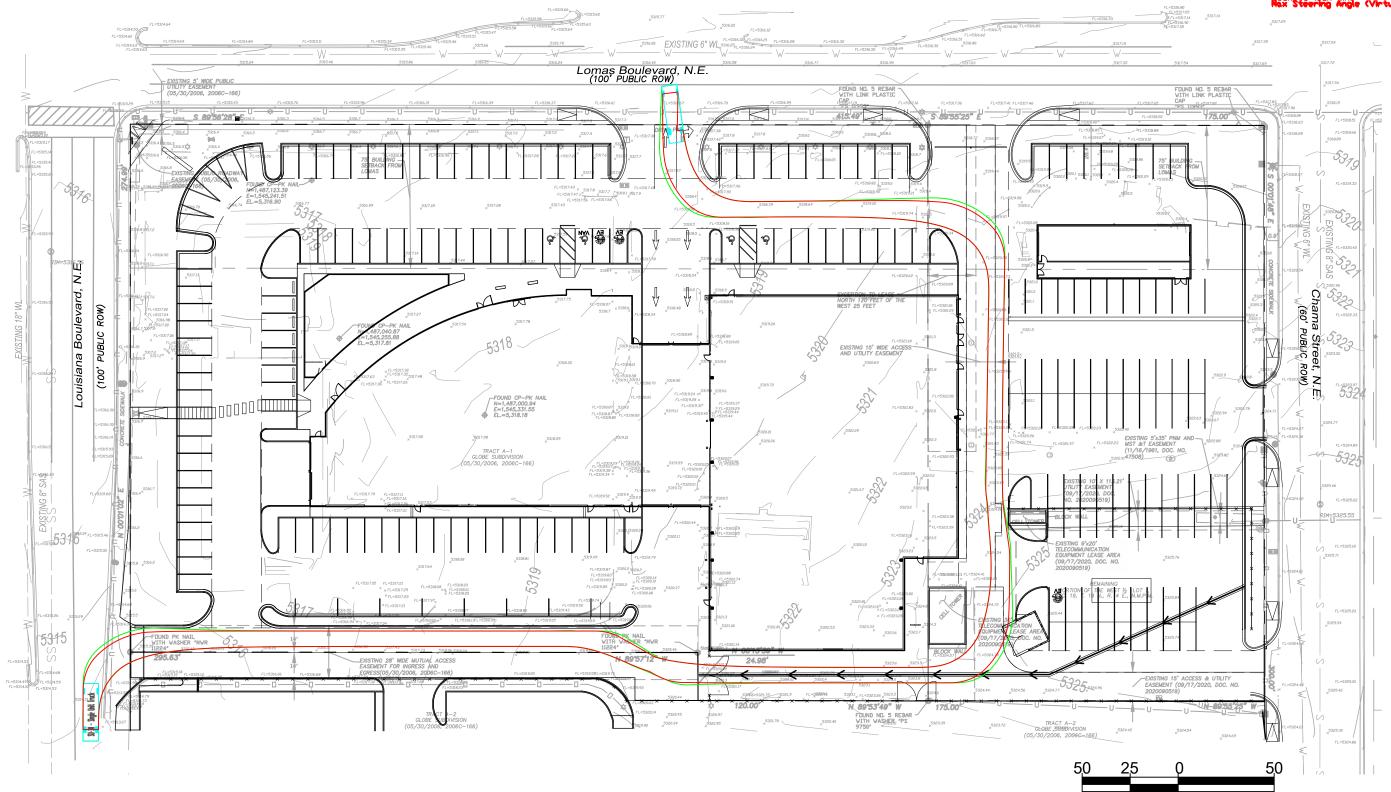


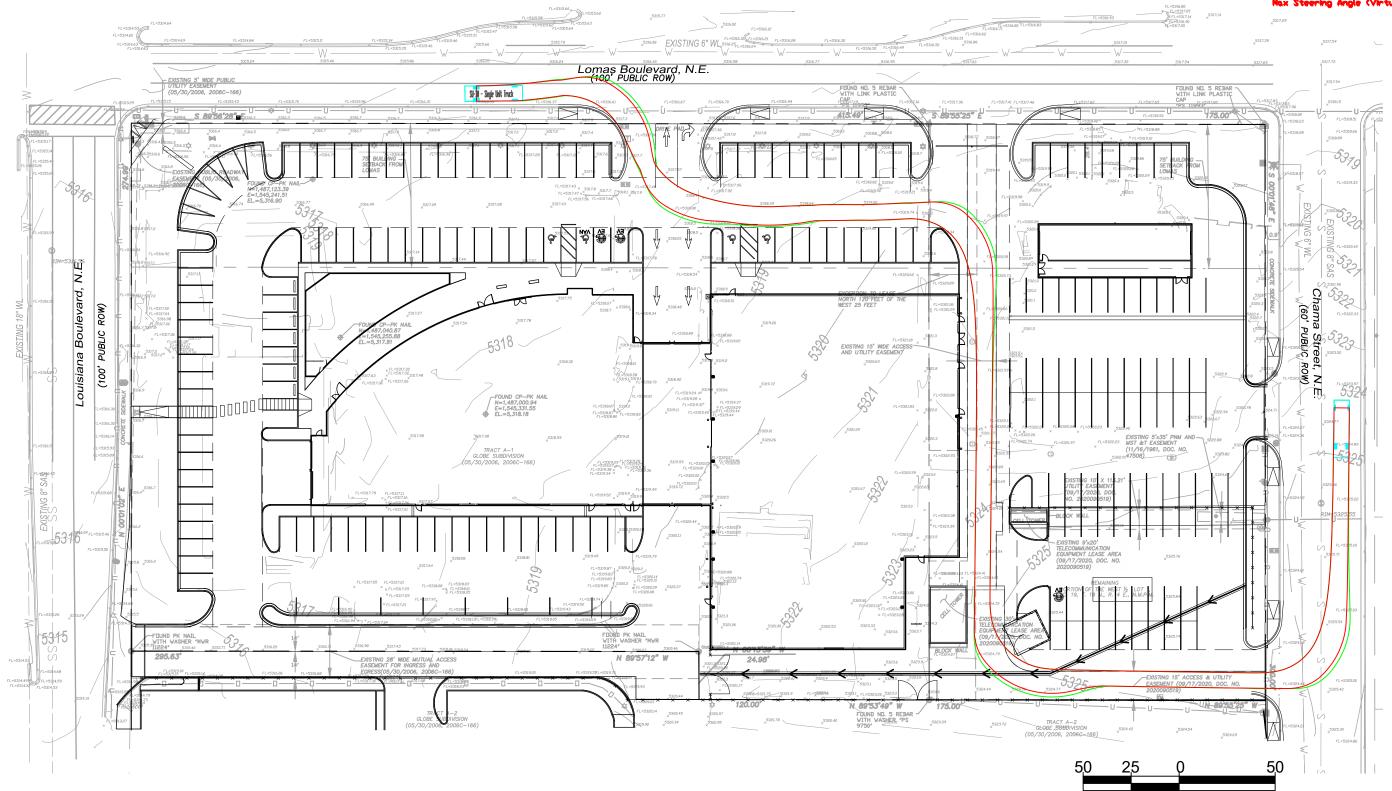


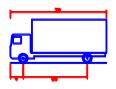1"=50'

SU-30 - Single Unit Truck Iverall Length Iverall Mask Height Im Bogy Fround Clearance Track Vidth Track To-lock time ack Steering Angle (Virtual






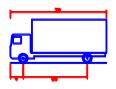


1"=50'

SU-30 - Single Unit Truck Overall Unith Iverall Moth In Body Ground Clearance Track Vidth Track Sto-lock time ack Steering Angle (Virtual



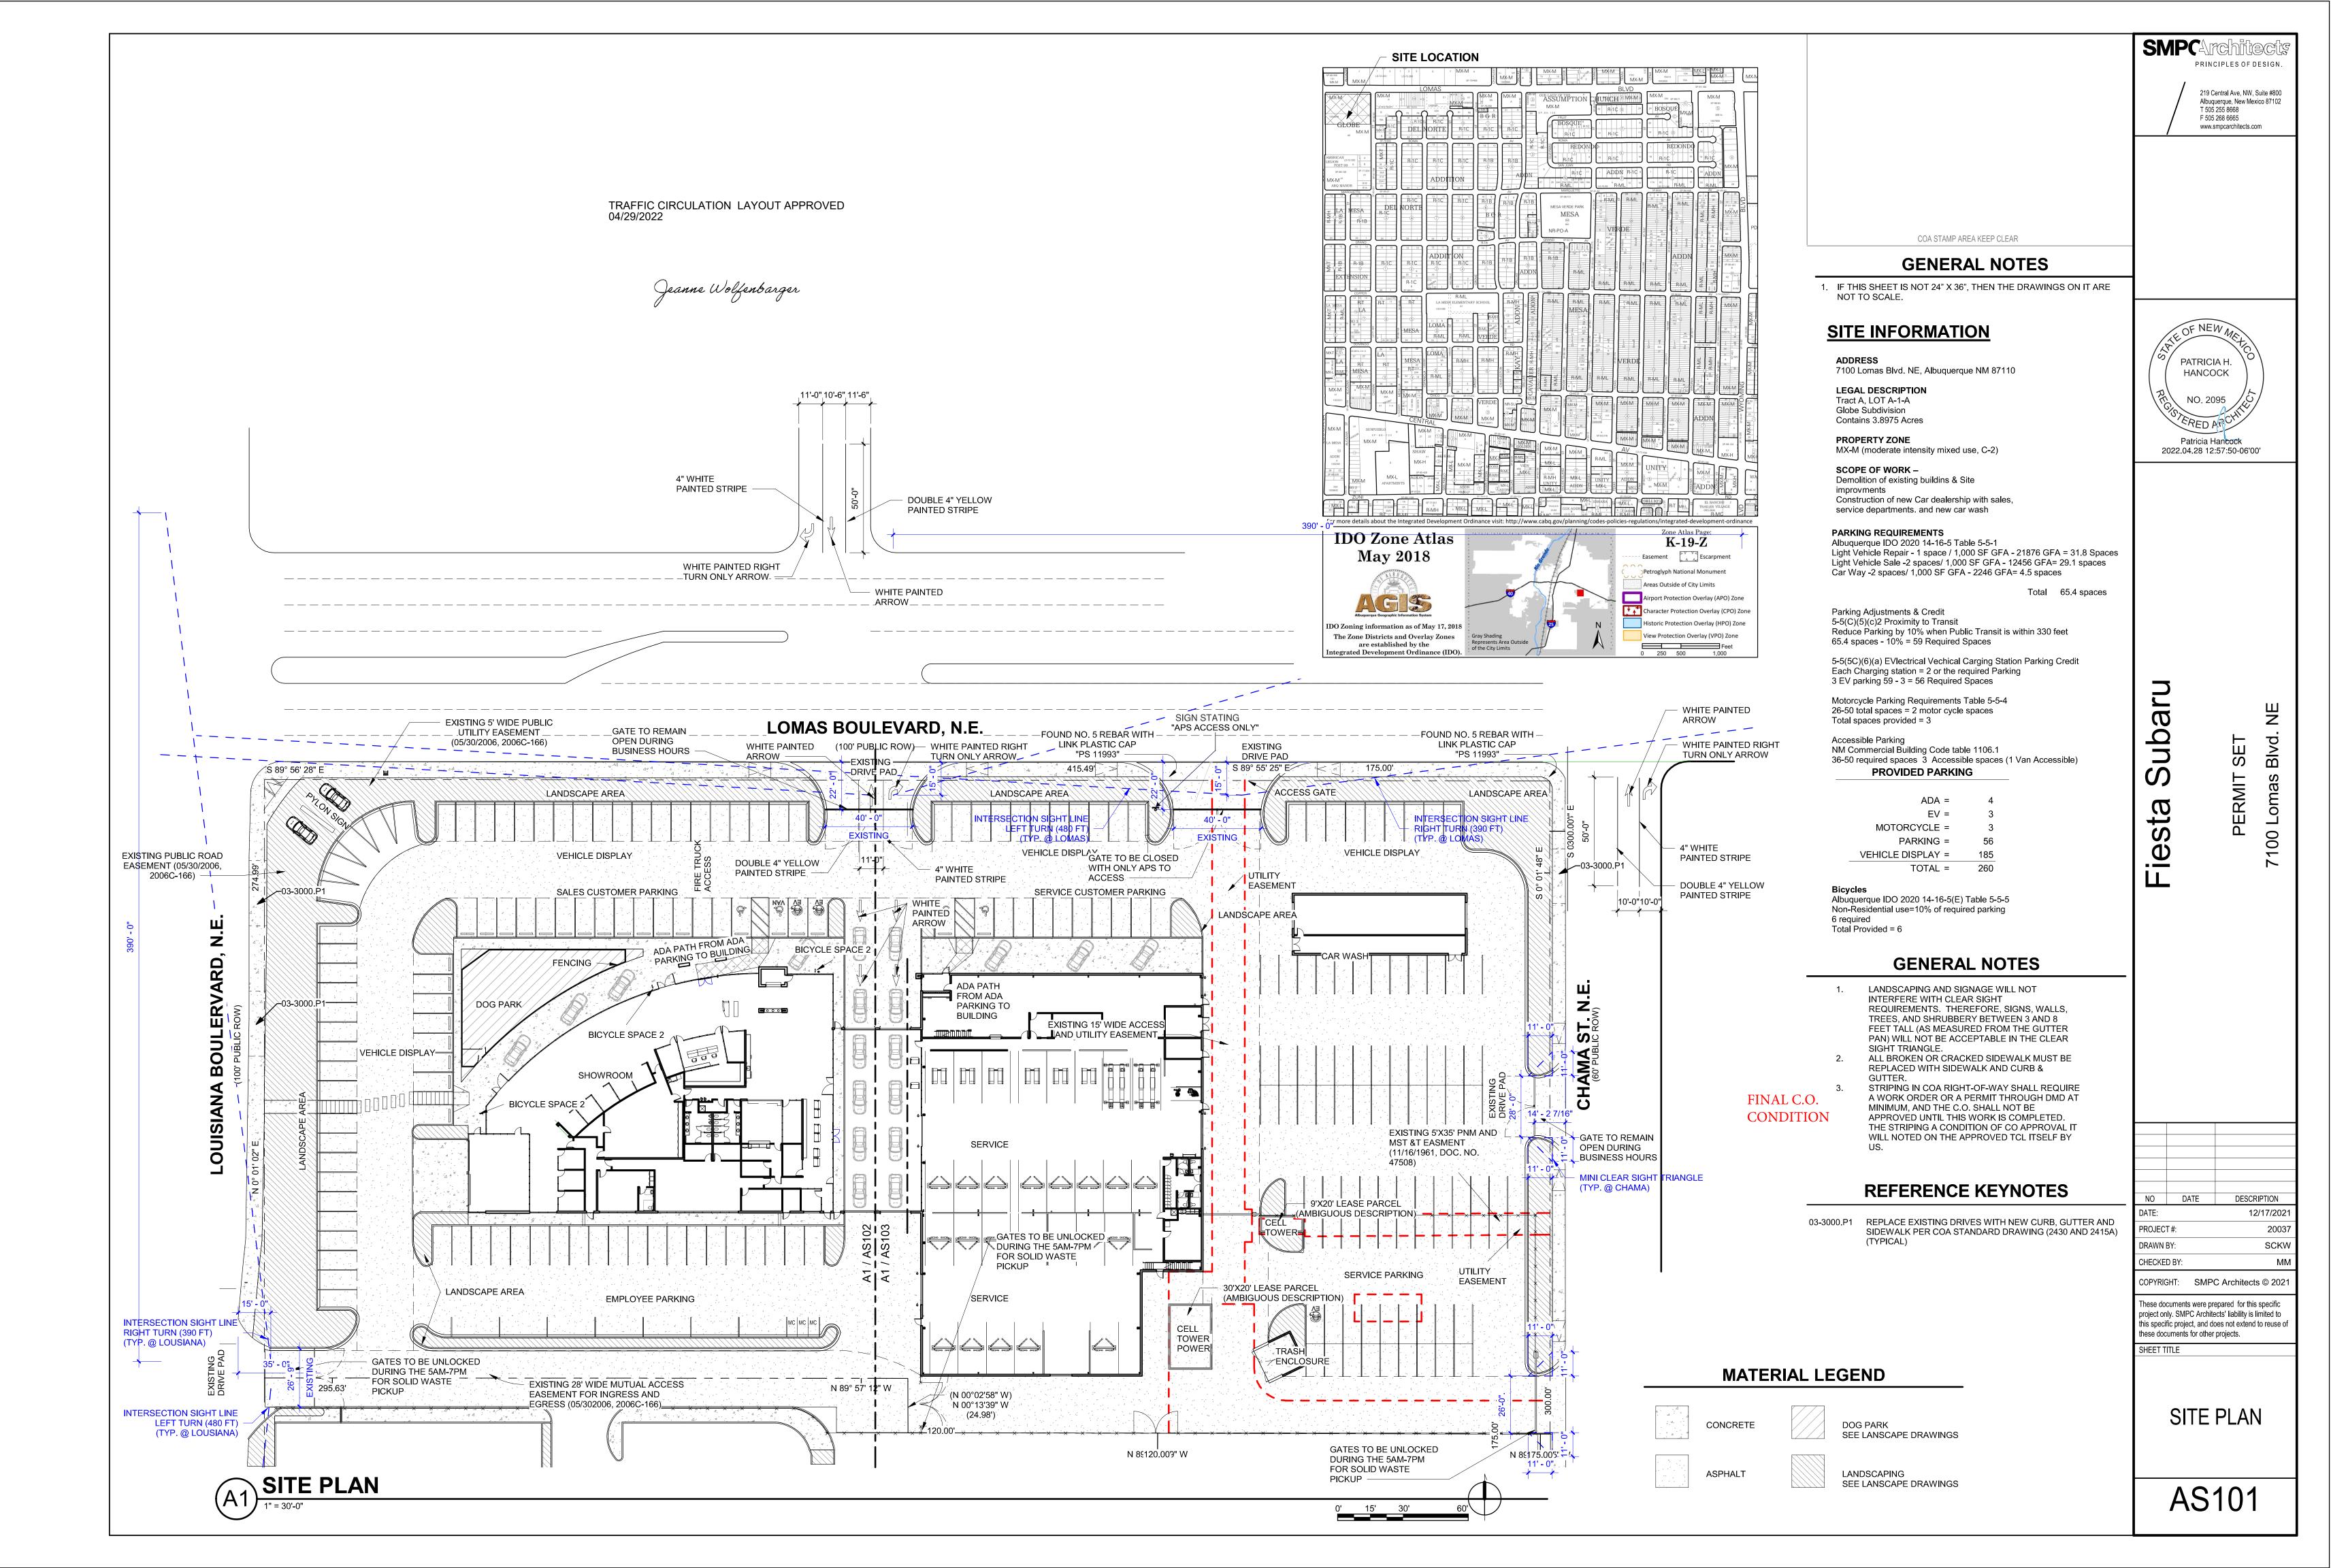

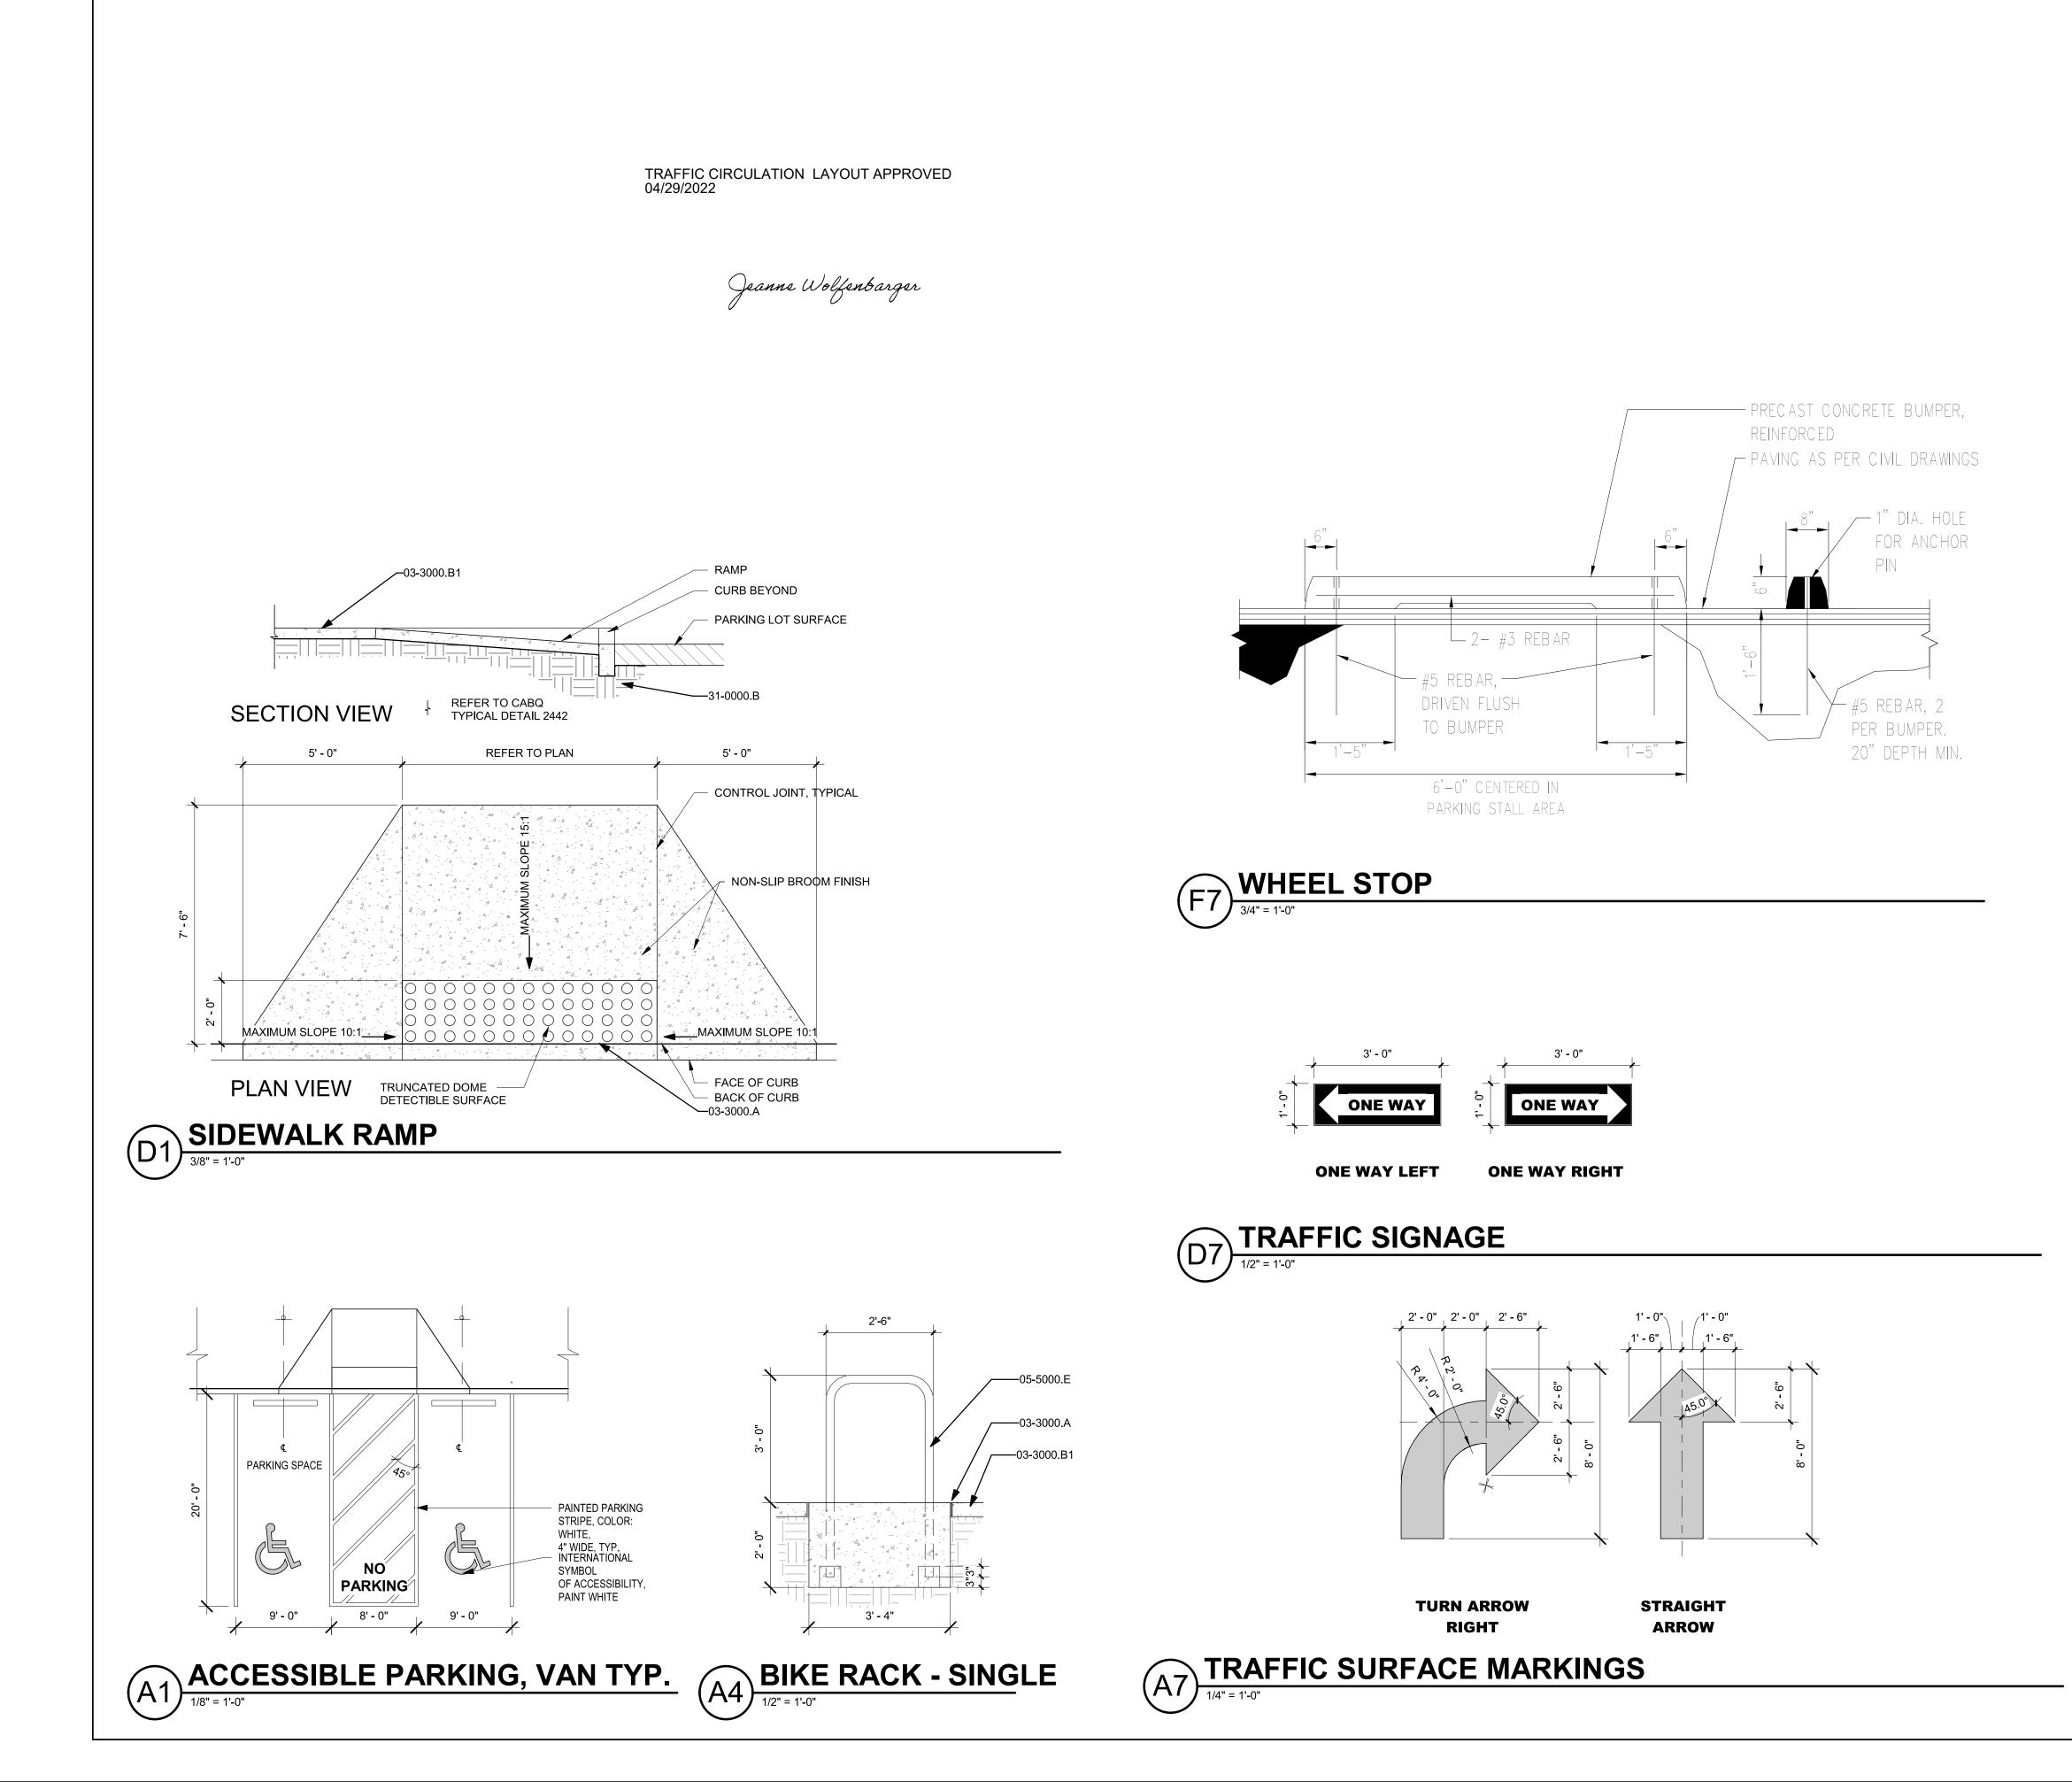

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