

CITY OF ALBUQUERQUE

Planning Department
Alan Varela, Director



Mayor Timothy M. Keller

October 3, 2022

Verlyn Miller, P.E.
Miller Engineering Consultants
3500 Comanche NE, Bldg F
Albuquerque, NM 87107

**RE: Wat Phrathat Doi Suthep NM
Grading and Drainage Plans
Engineer's Stamp Date: No stamp
Hydrology File: K19D125A**

PO Box 1293 Dear Mr. Miller,

Albuquerque Based upon the information provided in your submittal received 09/22/2022, the Conceptual Grading & Drainage Plan is not approved for Administrative Site Amendment until the following comments are addressed:

NM 87103 1. Provide for stormwater quality for the proposed impervious area: 0.26" of runoff. Hydrology realizes the area was previously impervious, but when construction is to occur on existing sites stormwater quality must be provided. Provide calculations for the required volume.

www.cabq.gov 2. Remove the Note "There is no stormwater quality volume required...." And remove the statement in the "Conclusions" paragraph that there is no stormwater quality volume required".

3. It appears there is adequate space for stormwater quality between the wall and the sidewalk along Louisiana Blvd. Provide required volume and provided volume.

When submitting for Building Permit approval, please address the following comments:

1. Keyed Note 22 states to build a 12" wide concrete channel, but the holes in the wall per Note 7 are only 6" wide. Seems the drainage will run into the wall and back-up.

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2. Near the NW corner of the new building, it is not clear, what the 2% and 5% MAX applies to. There is also a TOC grade in this area. Seems like a good place for landscaping/stormwater quality ponding area.

3. Do you have a typo in the project name? It ends in "MN" rather than in "NM".

If you have any questions, please contact me at 924-3999 or sbiazar@cabq.gov.

Sincerely,

Shahab Biazar, P.E. CFM
City Engineer
Development Review Services
Planning Department

PO Box 1293

Albuquerque

NM 87103

www.cabq.gov



City of Albuquerque

Planning Department

Development & Building Services Division

DRAINAGE AND TRANSPORTATION INFORMATION SHEET (REV 11/2018)

Project Title: _____ **Building Permit #:** _____ **Hydrology File #:** _____

DRB#: _____ **EPC#:** _____ **Work Order#:** _____

Legal Description: _____

City Address: _____

Applicant: _____ **Contact:** _____

Address: _____

Phone#: _____ **Fax#:** _____ **E-mail:** _____

Owner: _____ **Contact:** _____

Address: _____

Phone#: _____ **Fax#:** _____ **E-mail:** _____

TYPE OF SUBMITTAL: _____ PLAT (____# OF LOTS) _____ RESIDENCE _____ DRB SITE _____ ADMIN SITE

IS THIS A RESUBMITTAL?: _____ Yes _____ No

DEPARTMENT: _____ TRAFFIC/ TRANSPORTATION _____ HYDROLOGY/ DRAINAGE

Check all that Apply:

TYPE OF SUBMITTAL:

- _____ ENGINEER/ARCHITECT CERTIFICATION
- _____ PAD CERTIFICATION
- _____ CONCEPTUAL G & D PLAN
- _____ GRADING PLAN
- _____ DRAINAGE MASTER PLAN
- _____ DRAINAGE REPORT
- _____ FLOODPLAIN DEVELOPMENT PERMIT APPLIC
- _____ ELEVATION CERTIFICATE
- _____ CLOMR/LOMR
- _____ TRAFFIC CIRCULATION LAYOUT (TCL)
- _____ TRAFFIC IMPACT STUDY (TIS)
- _____ OTHER (SPECIFY) _____
- _____ PRE-DESIGN MEETING?

TYPE OF APPROVAL/ACCEPTANCE SOUGHT:

- _____ BUILDING PERMIT APPROVAL
- _____ CERTIFICATE OF OCCUPANCY
- _____ PRELIMINARY PLAT APPROVAL
- _____ SITE PLAN FOR SUB'D APPROVAL
- _____ SITE PLAN FOR BLDG. PERMIT APPROVAL
- _____ FINAL PLAT APPROVAL
- _____ SIA/ RELEASE OF FINANCIAL GUARANTEE
- _____ FOUNDATION PERMIT APPROVAL
- _____ GRADING PERMIT APPROVAL
- _____ SO-19 APPROVAL
- _____ PAVING PERMIT APPROVAL
- _____ GRADING/ PAD CERTIFICATION
- _____ WORK ORDER APPROVAL
- _____ CLOMR/LOMR
- _____ FLOODPLAIN DEVELOPMENT PERMIT
- _____ OTHER (SPECIFY) _____


DATE SUBMITTED: _____ **By:** _____

COA STAFF:

ELECTRONIC SUBMITTAL RECEIVED: _____

FEE PAID: _____

National Flood Hazard Layer FIRMette

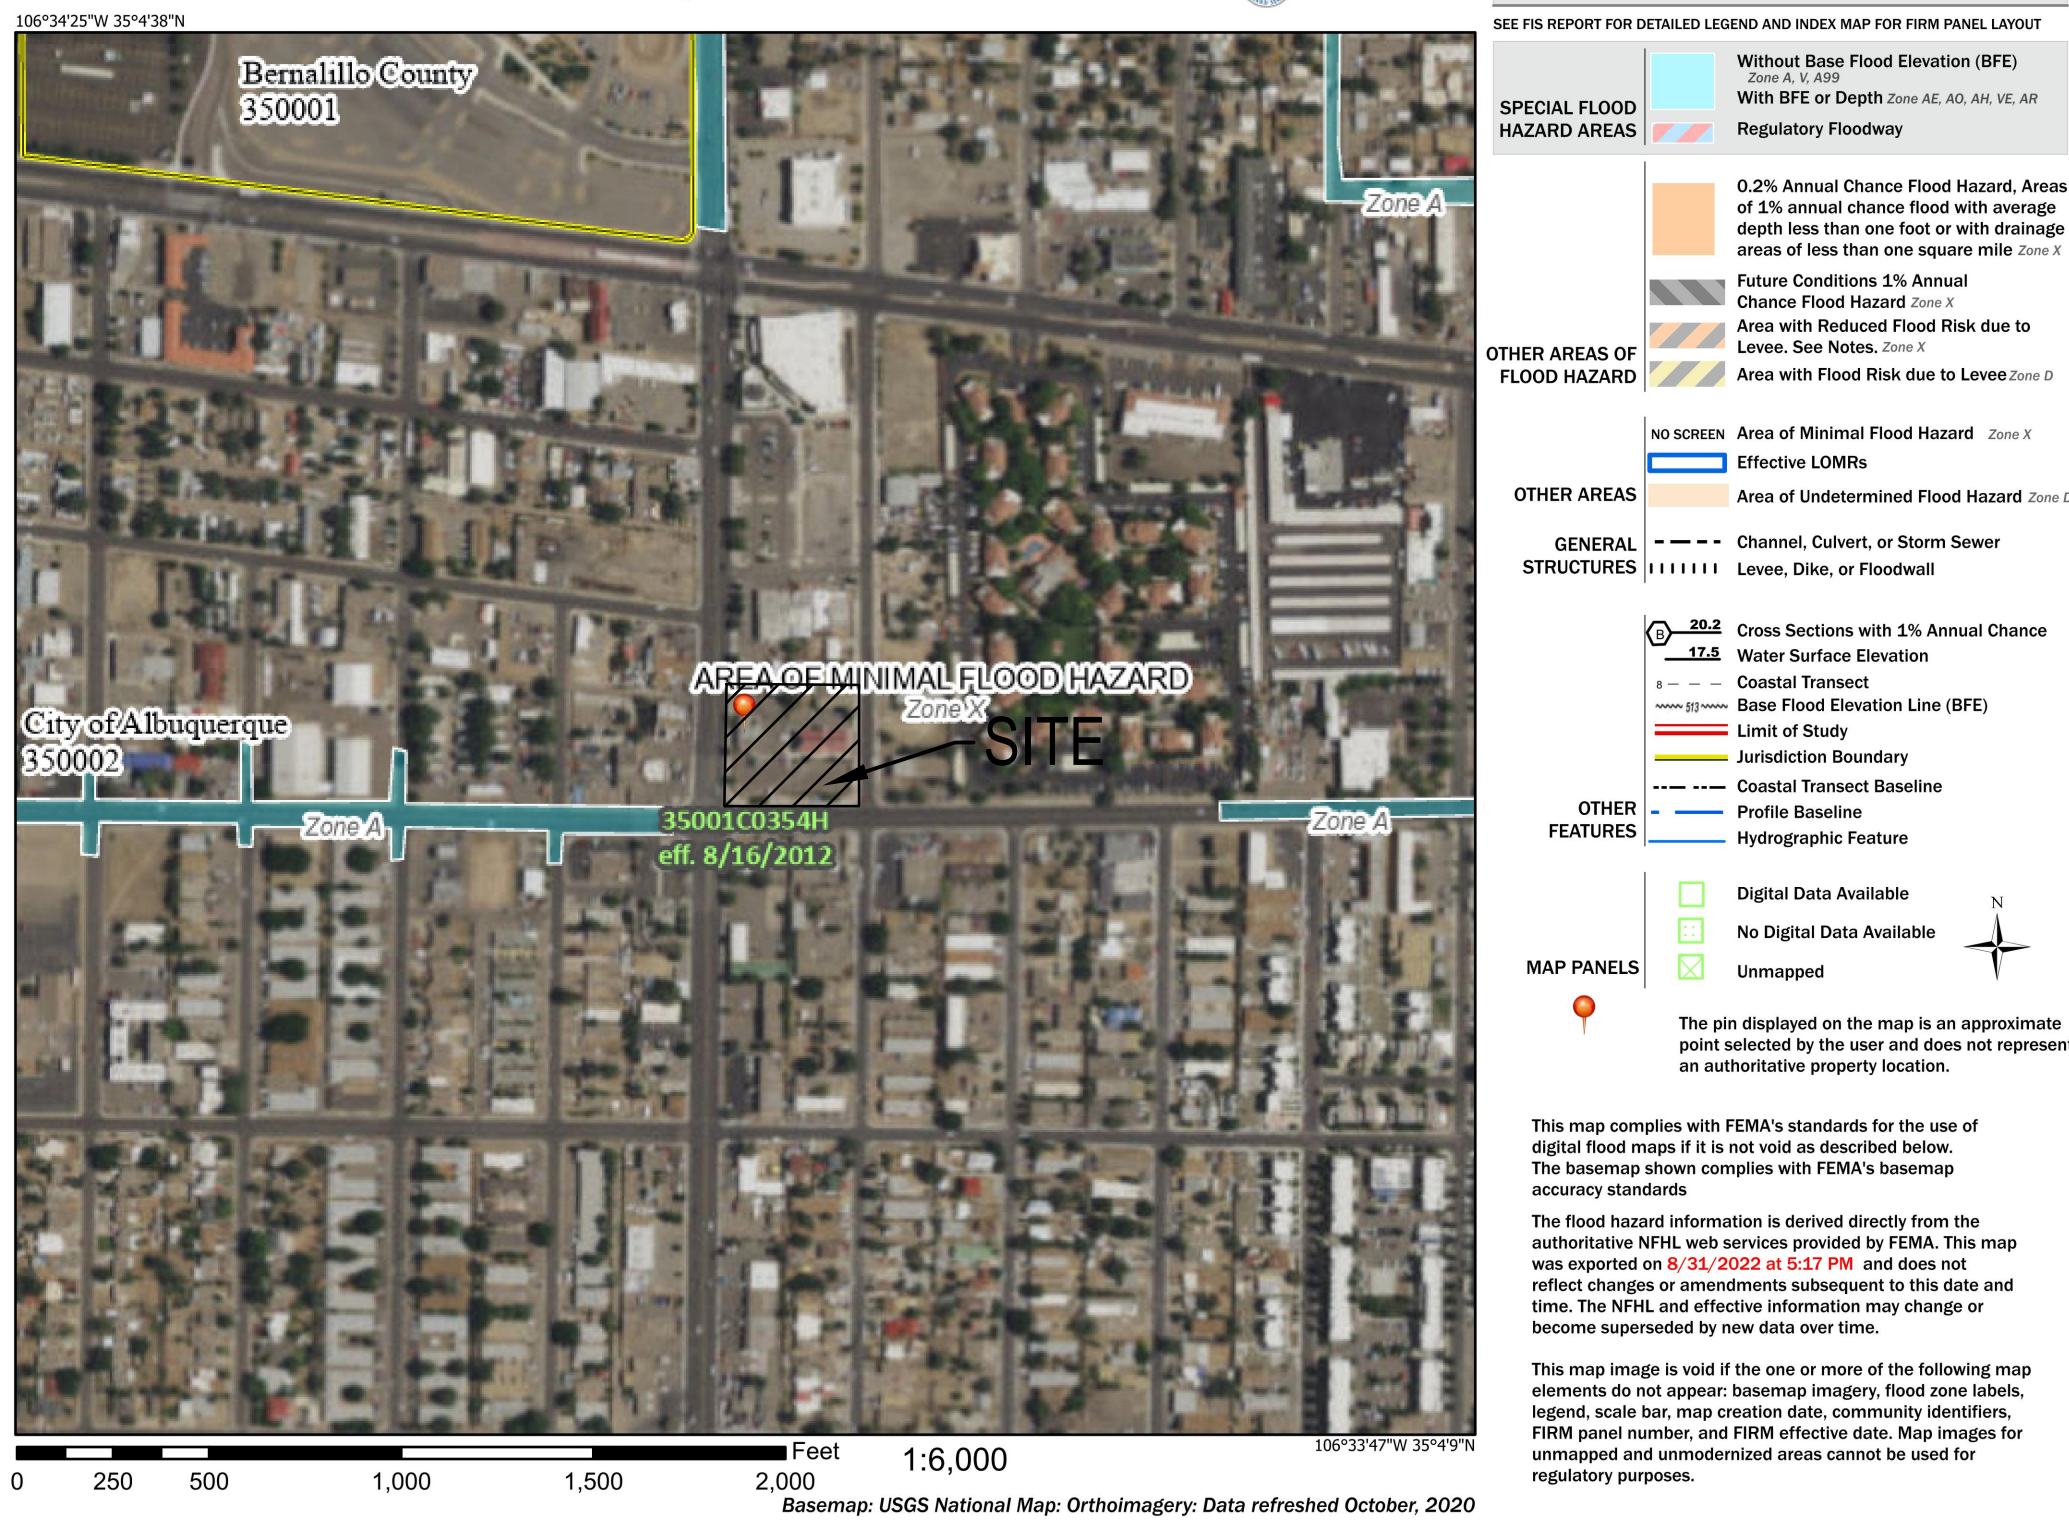

FLOOD ZONE MAP

FLOOD_ZONE_MAP_35001C0354H

DRAINAGE REPORT

SITE LOCATION

The existing site is an approximate 1-acre site located 320 Louisiana Boulevard SE in Albuquerque. The site is located on the east side of Louisiana Boulevard north of Zuni Road and can be accessed via Zuni Road south of the site (see vicinity map this sheet).

EXISTING CONDITIONS

The existing site is estimated at 1-acres and is mostly developed with buildings and asphalt paving. The site currently slopes from the east to west at a mild slope. The site does not lie within a 100-year FEMA floodplain (see FEMA panel on this sheet).

PROPOSED CONDITIONS

The proposed project will consist of a new building to be located on the western portion of the site. There is an existing building located on the eastern portion of the site that will remain. Since the existing site is currently fully developed and there will be no increase in impervious area on the site the current plan does not provide for a new water quality pond. The drainage calculations for proposed conditions are indicated on this sheet.

CONCLUSIONS

When fully developed as indicated on the grading and drainage plan, the runoff from the site will decrease by an estimated at 0.02 cfs and 0.001 acre-foot during the 100-year, 24-hour event. Storm water runoff from the site will discharge to its historical location west into Louisiana Boulevard. There is no storm water quality volume requirement for this site since the impervious area will decrease under fully developed conditions.

GENERAL NOTES:

1. EXISTING TOPOGRAPHIC SURVEY PERFORMED AND COMPILED BY HARRIS SURVEYING INC., CORRALES, NEW MEXICO AUGUST, 2022. MILLER ENGINEERING CONSULTANTS HAS UNDERTAKEN NO FIELD VERIFICATION OF THIS INFORMATION.
2. THE CONTRACTOR IS RESPONSIBLE FOR ALL TEMPORARY SEDIMENT AND EROSION CONTROL DEVICES DURING THE CONSTRUCTION PHASE.
3. CONTRACTOR SHALL OBTAIN A GRADING PERMIT FROM THE CITY OF ALBUQUERQUE, PRIOR TO ANY GRADING OR CONSTRUCTION.
4. TWO WORKING DAYS PRIOR TO ANY EXCAVATION CONTRACTOR MUST CONTACT LINE LOCATING SERVICE 260-1990 FOR LOCATION OF EXISTING UTILITIES.
5. ALL EMBANKMENTS SHALL BE PLACED AND COMPACTED IN LIFTS OF MAXIMUM OF 8". THE EMBANKMENTS SHALL BE WETTED AND COMPACTED TO 95% OPTIMUM DENSITY PER ASTM D1557 AND 95% UNDER ALL STRUCTURES INCLUDING DRIVEWAYS AND PARKING LOTS.
6. THE CONTRACTOR SHALL FIELD VERIFY LOCATION AND SIZE OF ALL UTILITIES PRIOR TO CONSTRUCTION.
7. ALL WORK PERFORMED SHALL COMPLY WITH THE REQUIREMENTS OF THE CITY OF ALBUQUERQUE STORM DRAINAGE REGULATIONS. ALL WORK PERFORMED SHALL COMPLY WITH THE REQUIREMENTS OF THE CITY OF ALBUQUERQUE "GRADING AND DRAINAGE DESIGN REQUIREMENTS AND POLICIES FOR LAND DEVELOPMENT."
8. THE OWNER, CONTRACTOR AND/OR BUILDER SHALL COMPLY WITH ALL APPROPRIATE LOCAL, STATE AND FEDERAL REGULATIONS AND REQUIREMENTS.
9. THE CONTRACTOR SHALL TAKE ALL APPROPRIATE AND REASONABLE MEASURES TO PREVENT SEDIMENT OR POLLUTANT LADEN STORM WATER FROM EXITING THE SITE DURING CONSTRUCTION. STORMWATER MAY BE DISCHARGED IN A MANNER, WHICH COMPLIES WITH THE APPROVED GRADING AND DRAINAGE PLAN.
10. THE CONTRACTOR SHALL TAKE ALL APPROPRIATE MEASURES TO PREVENT THE MOVEMENT OF CONSTRUCTION RELATED SEDIMENT, DUST, MUD, POLLUTANTS, DEBRIS, WASTE, ETC FROM THE SITE BY WIND, STORM FLOW OR ANY OTHER METHOD EXCLUDING THE INTENTIONAL, LEGAL TRANSPORTATION OF SAME IN A MANNER ACCEPTABLE BY THE CITY.
11. THE CONTRACTOR SHALL NOT DISTURB AREAS OUTSIDE THE AREAS SHOWN AS "SLOPE LIMITS" ON THE GRADING AND DRAINAGE PLAN.
12. SEE ARCHITECTURAL DRAWINGS FOR SIDEWALK AND HANDICAPPED RAMPS, DETAILS AROUND THE BUILDING.
13. THE CONTRACTOR SHALL CONTACT THE PROJECT ENGINEER FOR CLARIFICATION IF THERE ARE ANY SPOT ELEVATIONS ON THE GRADING AND DRAINAGE PLAN WHICH APPEAR TO BE AMBIGUOUS OR DO NOT MEET THE INTENT OF THE GRADING AND DRAINAGE PLAN.
14. THE CONTRACTOR SHALL CONTACT THE PROJECT ENGINEER FOR CLARIFICATION IF THERE ARE SIDEWALKS OR CONCRETE FLATWORK WHICH DOES NOT MEET ADA ACCESSIBILITY REQUIREMENTS. ALL SIDEWALKS SHALL HAVE A MAXIMUM CROSS SLOPE OF 2.0%, ALL SIDEWALKS SHALL HAVE A MAXIMUM LONGITUDINAL SLOPE OF 5.0%, AND ALL RAMPS SHALL HAVE A MAXIMUM LONGITUDINAL SLOPE OF 15:1.
15. ALL SIDEWALKS AND CONCRETE FLATWORK SHALL HAVE A MINIMUM OF 0.5% SLOPE. CONTRACTOR SHALL CONTACT PROJECT ENGINEER IF THERE ARE SIDEWALKS OR CONCRETE FLATWORK WHICH DO NOT MEET THIS REQUIREMENT.
16. THE CONTRACTOR SHALL SUBMIT MATERIAL SUBMITTALS, CUT SHEETS AND SHOP DRAWINGS FOR ALL CIVIL RELATED ITEMS FOR REVIEW PRIOR TO CONSTRUCTION.
17. THIS PROJECT SHALL BE CONSTRUCTED IN ACCORDANCE WITH THE 2014 EDITION OF THE NEW MEXICO STATE DEPARTMENT OF TRANSPORTATION STANDARD SPECIFICATIONS FOR HIGHWAY AND BRIDGE CONSTRUCTION (GREY BOOK).
18. ALL EXISTING MANHOLES, VALVES AND METERS SHALL BE ADJUSTED TO NEW FINISH GRADE.

DPM HYDROLOGY CALCULATIONS

Precipitation Zone 3 - 100-year Storm					P(360) = 2.6 in		P(1440) = 3.1 in		
Basin	Basin Area (Ac)	Land Treatment Factors				Ew (in)	V(100-6) (af)	V(100-24) (af)	Q(100) (cfs)
		A	B	C	D				
Existing Conditions									
Site	1.14	0.00	0.00	0.15	0.99	2.22	0.211	0.252	5.49
Total	1.14								5.49
Proposed Conditions									
Site	1.14	0.00	0.00	0.16	0.98	2.21	0.210	0.251	5.47
Total	1.14								5.47

STORM WATER QUALITY VOLUME CALCULATIONS

THERE IS NO STORM WATER QUALITY VOLUME REQUIRED FOR THIS SITE DUE TO THE DECREASE IN IMPERVIOUS AREA UNDER FULLY DEVELOPED CONDITIONS.



VICINITY MAP

ZONE MAP K-18-Z

WAT PHRATHAT DOI SUTHEP MN

CONGREGATE LIVING
NON-TRANSIENT

320 LOUISIANA BLVD. SE.
ALBUQUERQUE, NEW MEXICO 87108-3183


ISSUE/REVISION

PROJECT NUMBER
20_1611.03
CAD DWG FILE:
DWL-NM_APS OSUNA
DRAWN BY:
MEC
CHECKED BY:
VAM
SHEET TITLE:

HYDROLOGY PLAN

C-100

OF SHEET

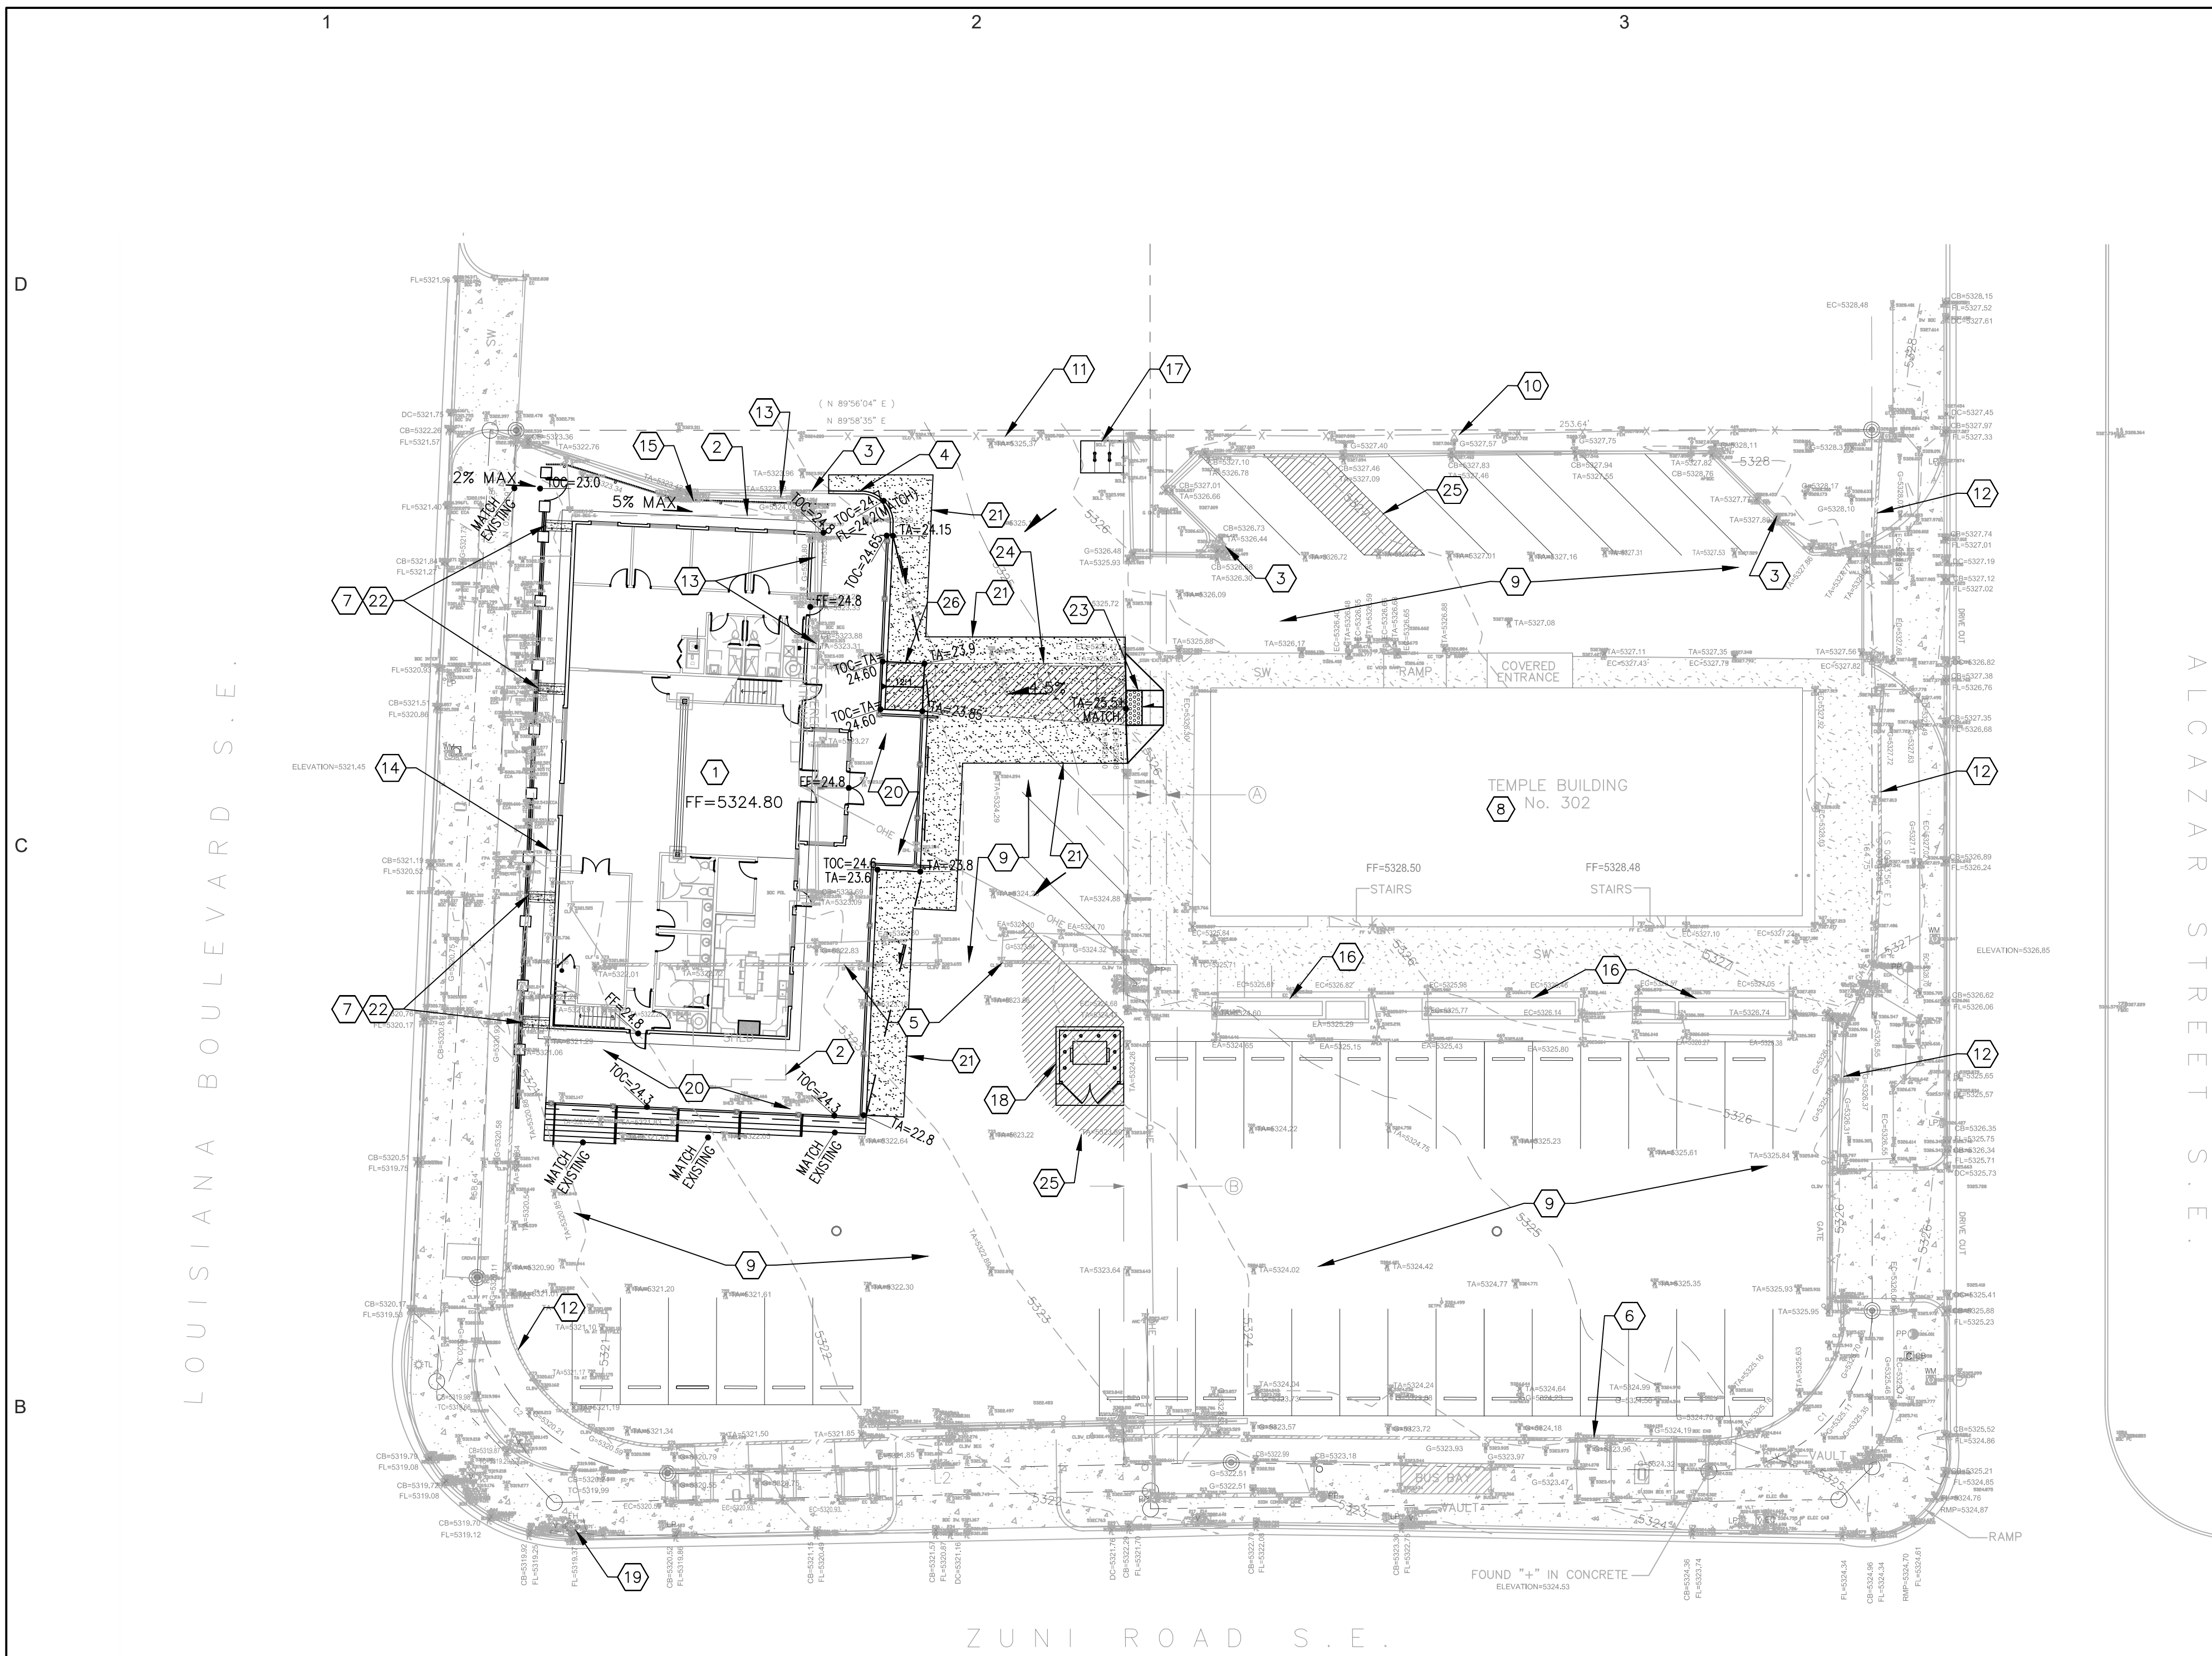


LEGEND:

38.00 FG	PROPOSED SPOT ELEVATIONS (FINISHED GRADE)	~	GRADE BREAK-HIGH POINT
MATCH (95.19)	MATCH EXISTING ELEVATIONS	---	SWALE
TC	TOP OF CONCRETE	SD	STORM DRAIN LINE
FL	FLOW LINE, CURB	5895	PROPOSED MAJOR CONTOUR
INV	INVERT	5895	PROPOSED MINOR CONTOUR
FG	FINISH GRADE	---	EXISTING MAJOR CONTOUR
TBC	TOP OF BASE COURSE	---	EXISTING MINOR CONTOUR
TG	TOP OF GRATE	---	TOP OF CUT SLOPE
TA	TOP OF ASPHALT	---	EXISTING TELEPHONE MANHOLE
FLOW ARROW	FLOW ARROW	---	EXISTING WATER METER
		---	EXISTING LIGHT POLE
		---	EXISTING CABLE BOX
		---	EXISTING ELECTRICAL CABINET
		---	EXISTING TRAFFIC LIGHT
		---	EXISTING VAULT

- KEYED NOTES:**
- NEW BUILDING. SEE ARCHITECTURAL PLANS FOR DETAILS.
 - EXISTING BUILDING TO BE REMOVED.
 - EXISTING CURB AND GUTTER TO REMAIN.
 - NEW CURB AND CUTTER. SEE DETAIL SHEET C-501.
 - EXISTING BLOCK WALL TO BE REMOVED.
 - EXISTING 6' MASONRY AND DECORATIVE STEEL FENCE TO REMAIN.
 - NEW 6' MASONRY AND DECORATIVE STEEL FENCE. PLACE 6"x6" WEEP HOLES IN WALL AS REQUIRED FOR DRAINAGE FROM ROOF DRAINS.
 - EXISTING BUILDING TO REMAIN.
 - EXISTING ASPHALT PARKING LOT.
 - EXISTING WOOD FENCE TO REMAIN.
 - EXISTING CHAIN LINK FENCE TO REMAIN.
 - EXISTING BLOCK WALL TO REMAIN. PROVIDE 6"x6" WEEP HOLES IN WALL AS REQUIRED FOR DRAINAGE.
 - EXISTING CURB AND GUTTER TO BE REMOVED AND DISPOSED OF.
 - EXISTING GAS METER.
 - NEW 6' STEEL PICKET FENCE SEE ARCHITECTURAL DRAWINGS.
 - EXISTING PLANTERS TO REMAIN.
 - NEW BIKE RACK. SEE ARCHITECTURAL DRAWINGS.
 - NEW TRASH ENCLOSURE SEE ARCHITECTURAL DRAWINGS.
 - EXISTING FIRE HYDRANT TO REMAIN.
 - NEW COVERED PATIO.
 - EXISTING ASPHALT TO BE REMOVED AND REPLACED. SAW CUT TO A CLEAN STRAIGHT EDGE TO ADJOINING ASPHALT DEPTH. MATCH EXISTING ELEVATIONS.
 - NEW 12" WIDE CONCRETE CHANNEL TO BE PLACED AT ALL DOWNSPOUT LOCATIONS. SEE DETAIL SHEET C-501.
 - NEW ADA RAMP. SEE DETAIL SHEET C-501.
 - NEW ADA CROSSWALK STRIPING. SEE ARCHITECTURAL SHEETS.
 - NEW ASPHALT STRIPING. SEE ARCHITECTURAL PLANS.
 - NEW 9' ADA RAMP. 12:1 MAX. SLOPE. SEE ARCHITECTURAL PLANS FOR DETAILS.

3' PNM EASEMENT
FILED: DECEMBER 3, 1999
BOOK 9915, PAGE 9262

10' PUBLIC UTILITY EASEMENT
FILED: JUNE 8, 2013
BOOK 2013C, FOLIO 44

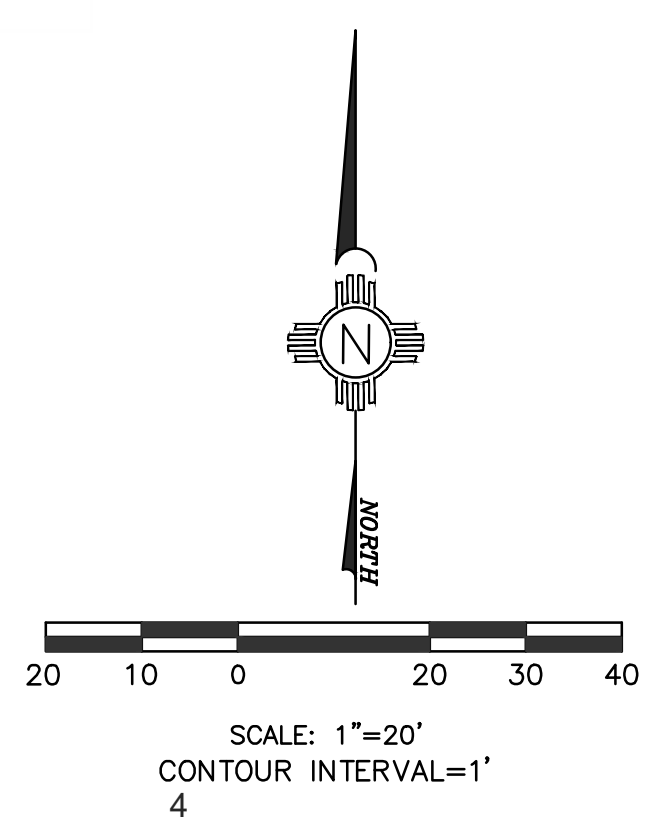

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Engineers • Planners
3500 COMANCHE NE
BLDG F
ALBUQUERQUE, NM 87107
(505) 888-7500
(505) 888-3800 (FAX)

A1 CONCEPTUAL GRADING AND DRAINAGE PLAN
SCALE: 1"=20'

DWL ARCHITECTS
DWL ARCHITECTS & PLANNERS, INC. OF NM
202 CENTRAL AVE. S.E.
EAST COURTYARD
ALBUQUERQUE,
NEW MEXICO, 87102
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WEASTMAN@DWLNM.COM


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ISSUE/REVISION

PROJECT NUMBER	20_1611.03
CAD DWG FILE	DWL-NM_APS OSUNA
DRAWN BY:	MEC
CHECKED BY:	VAM
SHEET TITLE:	CONCEPTUAL GRADING AND DRAINAGE PLAN
OF	SHEET



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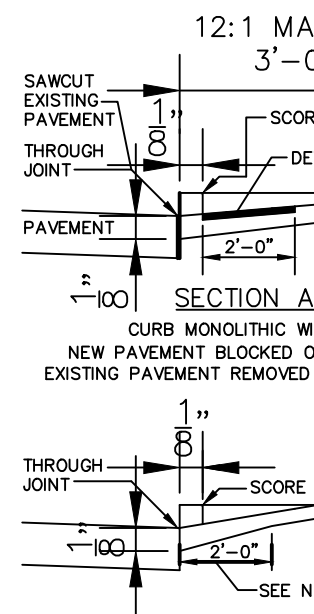
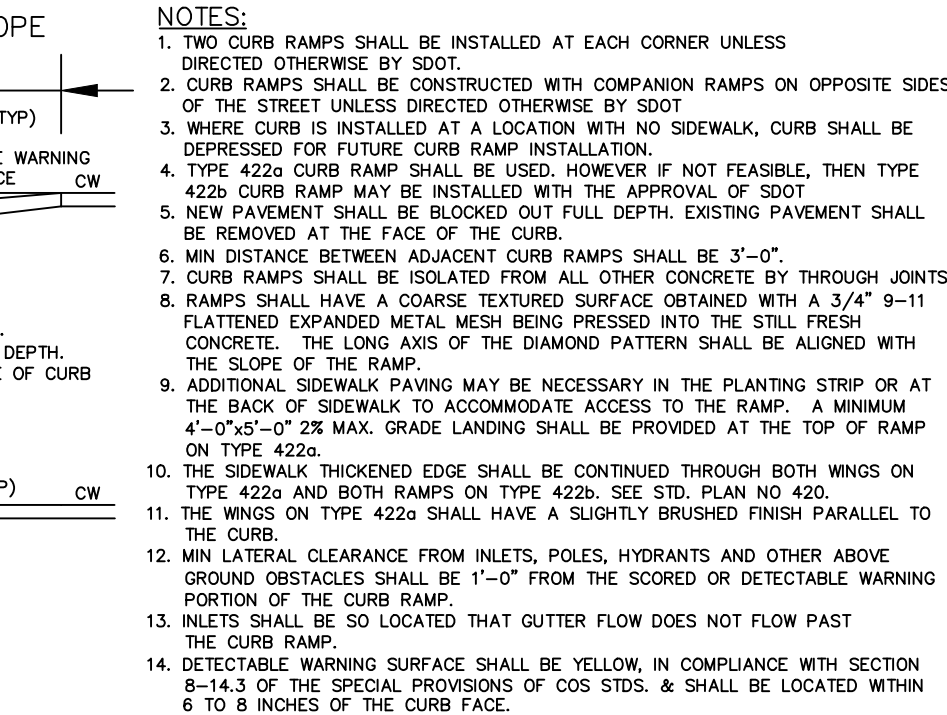
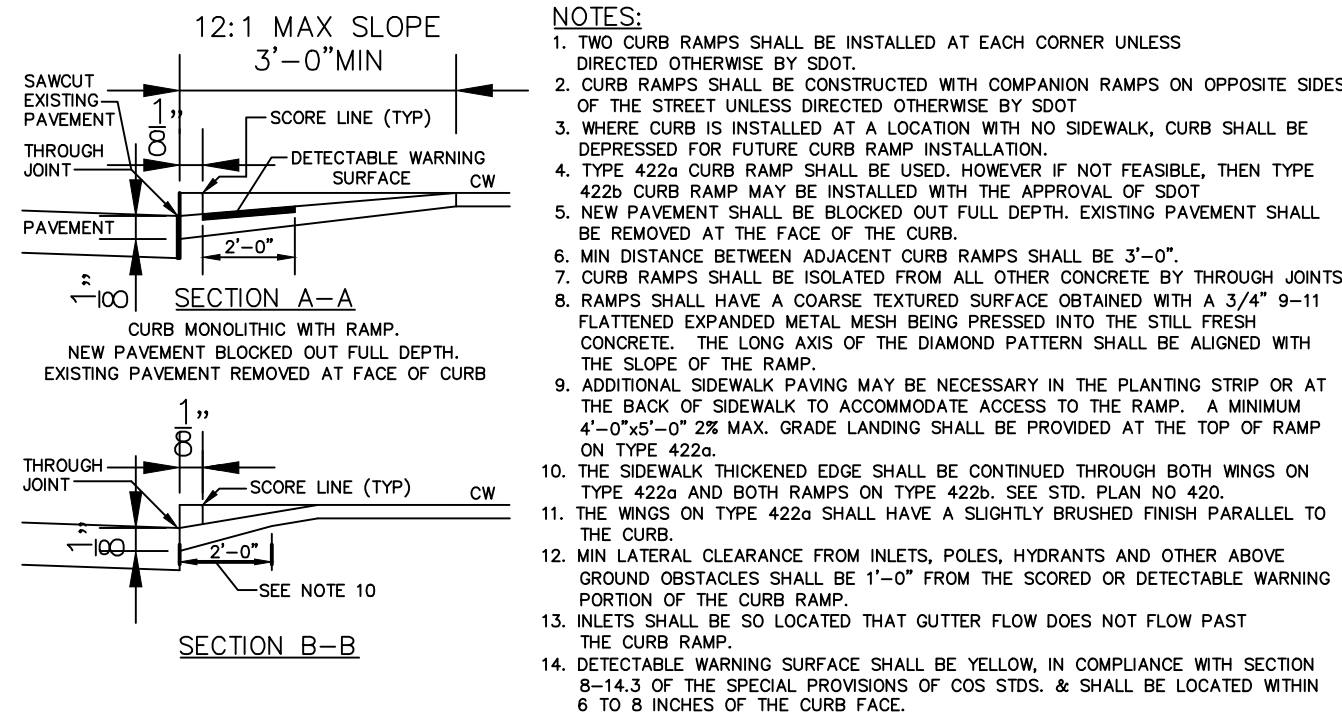


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DWL ARCHITECTS &
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CAD DWG FILE:
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DRAWN BY:
MEC

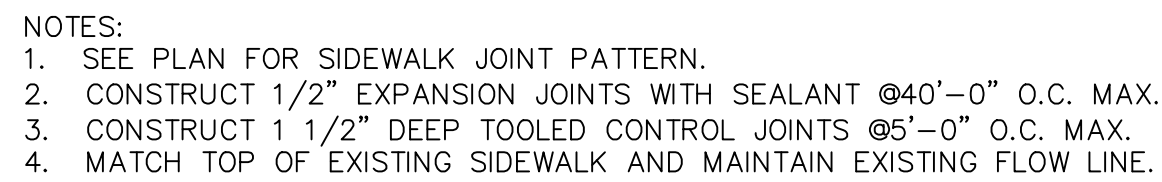CHECKED BY:
VAM

SHEET TITLE:

MISCELLANEOUS DETAILS

C-501

OF SHEET



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