

SITE PLAN



Public Infrastructure shown on these plans for information only and not part of approval. Separate DRC/Permit approval and Work Order required.

ALL WHEELCHAIR RAMPS LOCATED WITHIN THE PUBLIC RIGHT OF WAY MUST HAVE TRUNCATED DOMES.



P.O. BOX 3366
ALBUQUERQUE,NM 87190
T: (505) 281-9560
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C: (505) 259-7919
aktarch@earthlink.net


CONSULTANT

KENT TRAUERNICHT 1285

PROJECT

AUTO SHOP BUILDING FOR NICE CARS, LLC

PROJECT ADDRESS
7800 LOMAS BLVD NE
ALBUQUERQUE 87110

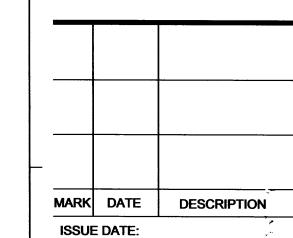

PROJECT NO: 0635 COPYRIGHT AKT ARCHITECTS, LLC

SHEET TITLE

SITE PLAN AND TRAFFIC

CIRCULATION

AS-101

MH N 89° 35' 00" E □⊕□ 25'R 35.33' -25'R 35.38' S 45° 27' 30" E N 44° 32' 30" E 35'-5 1/4" EXISTING BLDG +/- 5600 SF 15-FT VACATED ALLEY RETAINED AT CABQ UTILITY EASEMENT: RESOLUTION #V-80-21 NEW 3000 SF BLDG 260.00' 20'-0" INSTALL TREES, 30 OC MAX, ALL OTHER LANDSCAPING TO REMAIN, NO CHANGE (7)

1" = 20'-0"

,

ZONING DATA

REQUIRED PARKING

ZONING: C-2 (COMMUNITY COMMERCIAL) ADDRESS: 7800 LOMAS BLVD. 87110

NEW SHOP: 2770 SF / 1000 =

KEYED NOTES (NEW CONSTRUCTION)

PAINT STRIPING AS SHOWN.

QIL/SAND SEPARATOR TANK.

EXISTING LINE IN EASEMENT.

BUILDING.

REQUIRED BY PROJECT.

REQUIRED ON-SITE PARKING:

SITE AREA: 1.206 ACRES (+/- 52,533 SF)

EXISTING BUILDING AREA: 5600 SF NEW AUTO SHOP BUILDING AREA: 3000 SF

EXISTING OFFICES: 1500 SF / 200 = 8 SPACEEXISTING STORAGE: 2120 SF / 2000 = 1 SPACEEXISTING SHOP: 2000 SF / 1000 = 2 SPACES

1. PAINT-OUT EXISTING PARKING STRIPING AND INSTALL NEW

3. TIE NEW SHOP BUILDING'S TRENCH DRAINS INTO EXISTING

5. EXTEND SANITARY SEWER FROM NEW BUILDING AND TIE INTO

6. EXTEND NEW LINE FROM EXISTING GAS REGULATOR TO NEW

MINIMUM 10-12 FOOT HEIGHT OR 2-INCH CALIPER.

7. REMOVE AND REPLACE EXISTING LANDSCAPE ROCK AS REQUIRED BY NEW TREE PLANTINGS. TREE TYPES AS SHOWN,

4. EXTEND TELEPHONE, DATA, AND ELECTRICAL SERVICE,

UNDERGROUND, TO NEW SHOP BUILDING.

2. PATCH BACK EXISTING ASPHALT PAVING, (3-INCH OVER 6-INCH

COMPACTED BASE, SHALL MEET CABO SP3 SPECIFICATION), AS

ON-SITE PARKING PROVIDED: 19 SPACES (PLUS AUTO DISPLAY PARKING) INCLUDES 2 ACCESSIBLE PARKING SPACE (VAN) PER NM BLDG CODE

3 SPACE

14 SPACES


UTILITY PLAN GENERAL NOTES:

- A. UTILITY LINES AND SERVICE LOCATIONS ARE SHOWN RELATIVE TO SURVEY INFORMATION. THE CONTRACTOR SHALL VERIFY EXISTING CONDITIONS AND SHALL BE RESPONSIBLE FOR ALL UTILITY INSTALLATIONS. ALL UTILITIES SHALL BE COORDINATED AND INSTALLED PER CITY AND UTILITY COMPANY REQUIREMENTS.
- B. ANY UTILITIES INSTALLED IN STATE OR CITY RIGHT OF WAYS SHALL BE COORDINATED WITH AND INSTALLED PER THEIR SPECIFICATIONS AND REQUIREMENTS.
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- D. INSTALLATION SHALL BE COMPLETE AND SHALL INCLUDE ALL EQUIPMENT AND LABOR, PIPE OR CONDUIT, METERS, BOXES, VALVES, DISCONNECTS, CONCRETE PADS, BOLLARDS, CUTTING OF EXISTING PAVING, WALKS, AND CURBS, TRENCHING, BACKFILL, COMPACTION, AND PATCHING OF EXISTING CONDITIONS. ALL TESTING IN ASSOCIATION WITH UTILITY INSTALLATION SHALL BE INCLUDED IN THE CONTRACT.
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- F. THE CONTRACTOR SHALL CONTACT THE RESPECTIVE LOCAL CODE ENFORCEMENT OFFICERS AND THE LOCAL FIRE MARSHAL. ALL UTILITY INSTALLATIONS SHALL COMPLY WITH THE CODES AND INTERPRETATIONS SET FORTH BY THE GOVERNING LOCAL AUTHORITIES.
- G. ALL UNUSED AND ABAMDONED UTILITIES SHALL BE REMOVED TO THE PROPERTY LINE AND CAPPED.
 - WHERE POTABLE WATER LINES CROSS SEWER LINES
 THERE SHALL BE A MINIMUM 18—INCH VERTICAL
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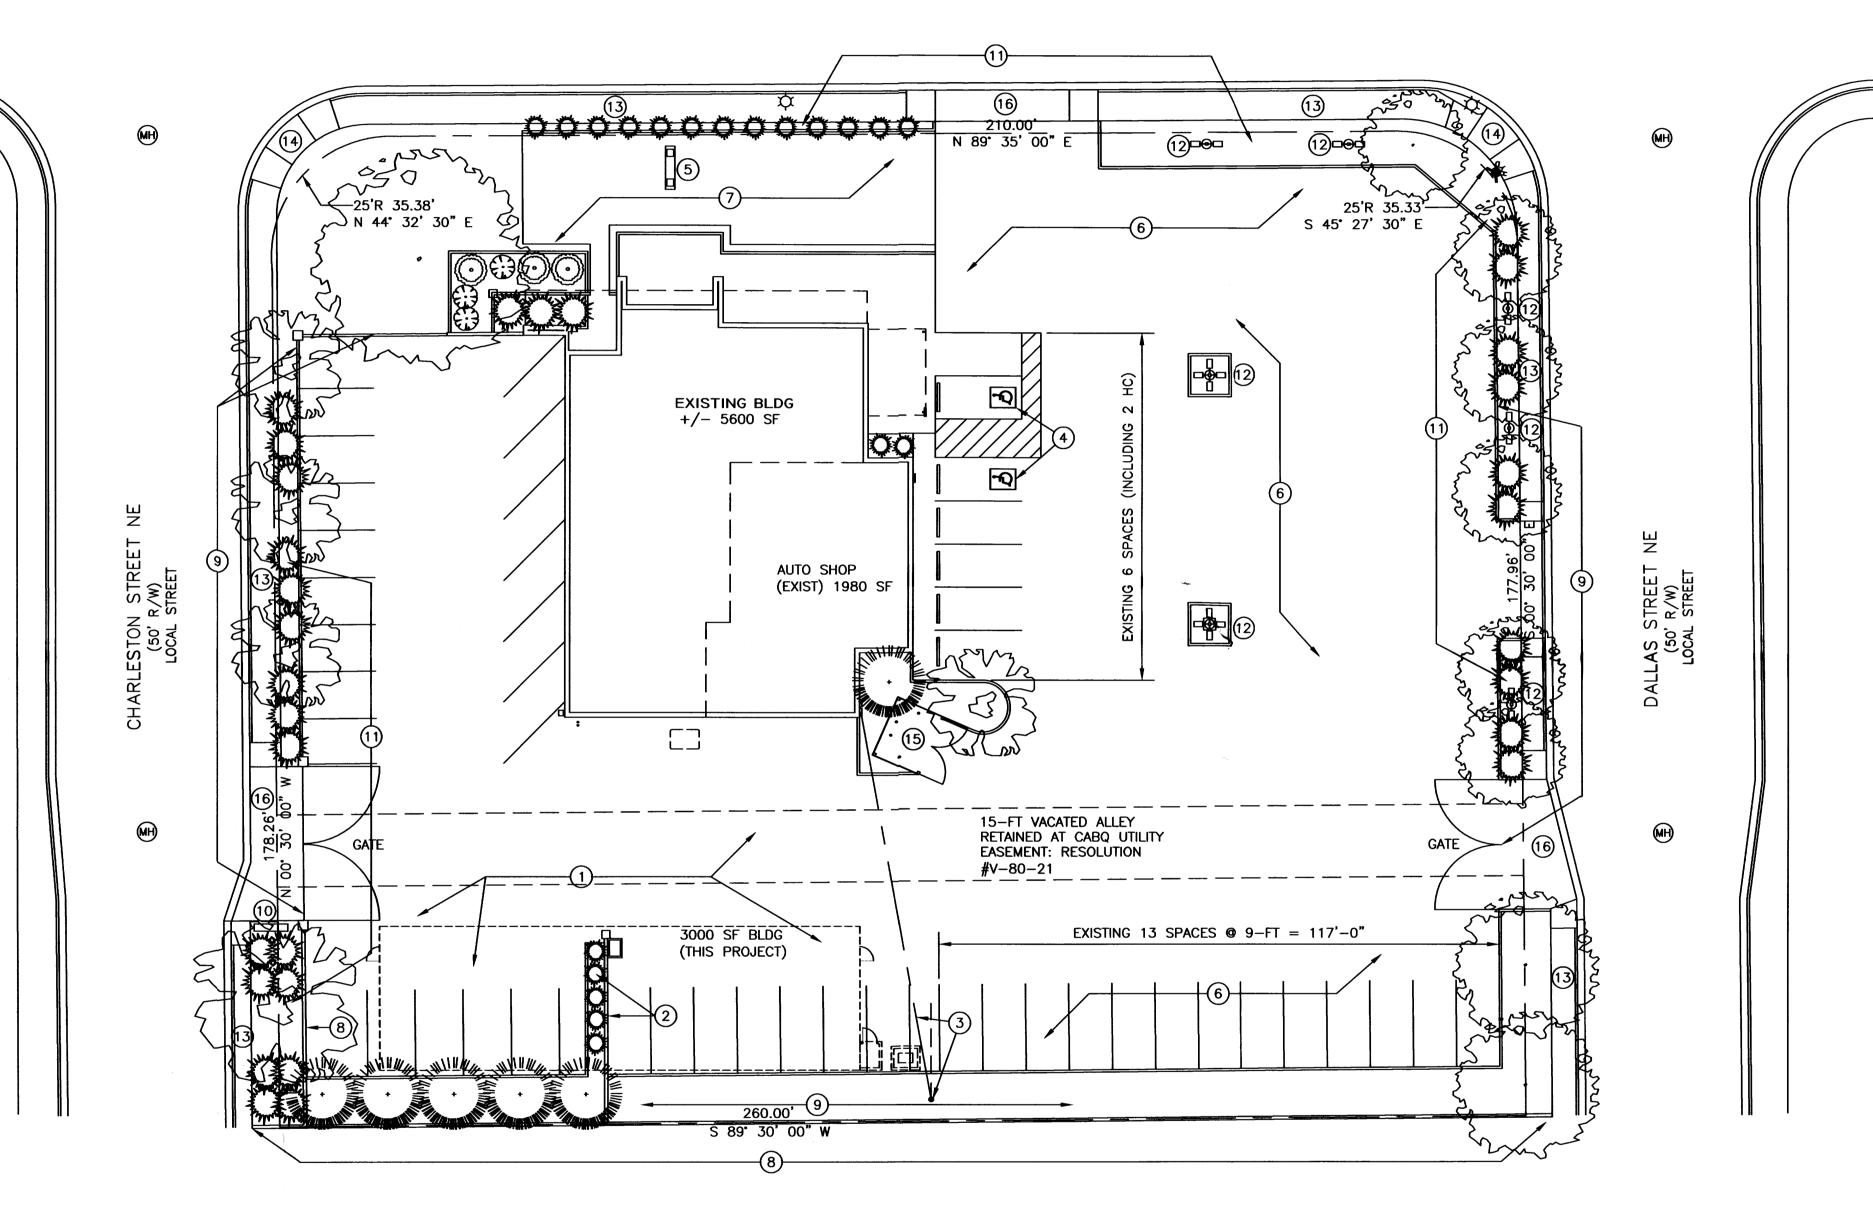
JUN 1 - 2012

HYDROLOGY SECTION



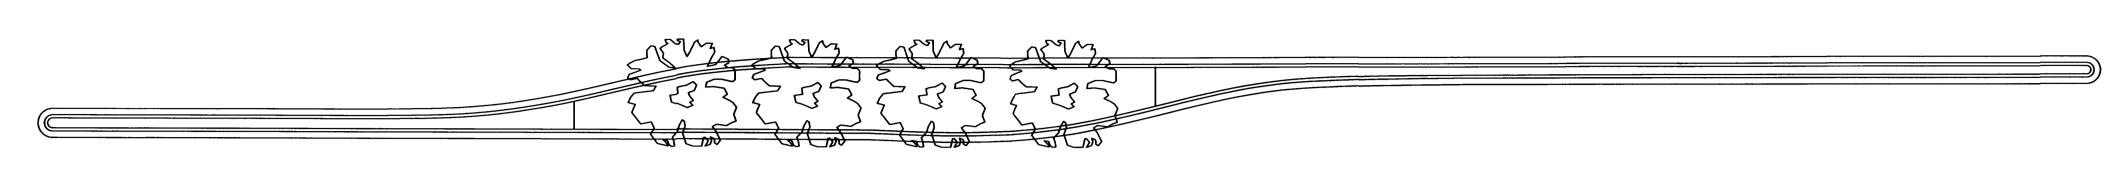

1" = 20'-0"



EXISTING/DEMOLITION SITE PLAN

KEYED NOTES (EXISTING CONDITIONS)

- 1. CUT AND REMOVE EXISTING ASPHALT PAVING AS REQUIRED BY
- NEW CONSTRUCTION. 2. REMOVE EXISTING CMU WALL, FOOTING, LANDSCAPE MATERIAL, AND ALL OTHER EXISTING IMPROVEMENTS AS REQUIRED BY NEW
- 3. ELECTRICAL POWER POLE WITH GUY WIRE. TRANSFORMER AND OVERHEAD SERVICE DROP TO EXISTING BUILDING, TO REMAIN.
- 4. CONCRETE ENTRANCE WALK, AT SAME GRADE AS EXISTING ASPHALT PAVING. EXISTING PAINTED ACCESSIBLE PARKING SYMBOL, ACCESSIBLE ISLE, AND SIGNS.
- 5. FREE STANDING PYLON SIGN.
- 6. ASPHALT PAVING, NO CHANGE.
- 7. CONCRETE PAVING, NO CHANGE. 8. 6-FT HIGH CMU SCREEN WALL, NO CHANGE
- 9. 6-FT HIGH ORNAMENTAL STEEL FENCING, WITH GATES AS SHOWN, AROUND SITE.
- 10. MONUMENT SIGN, NO CHANGE. 11. LANDSCAPE AREAS WITH CONCRETE CURBING, AS SHOWN, NO

12. AREA LIGHTING, POLE MOUNTED FIXTURES, WITH CONCRETE BASE, TO REMAIN.

13. PUBLIC CONCRETE WALK, NO CHANGE.

14. ACCESSIBLE CURB RAMP, NONDIRECTIONAL.

15. EXISTING DUMPSTER ENCLOSURE, NO CHANGE.


16. EXISTING CURB CUT WITH SIDEWALK RAMPS, TO REMAIN, NO CHANGE.

EXISTING CONDITIONS
FOR INFORMATION ONLY

(REFERENCE)

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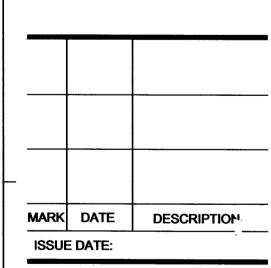
CONSULTANT

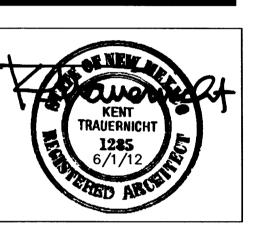

PROJECT

AUTO SHOP BUILDING FOR NICE CARS, LLC

PROJECT ADDRESS
7800 LOMAS BLVD NE **ALBUQUERQUE 87110**




PROJECT NO: 0635 COPYRIGHT AKT ARCHITECTS, LLC

SHEET TITLE

EXISTING SITE PLAN

RECEIVED

AS-100

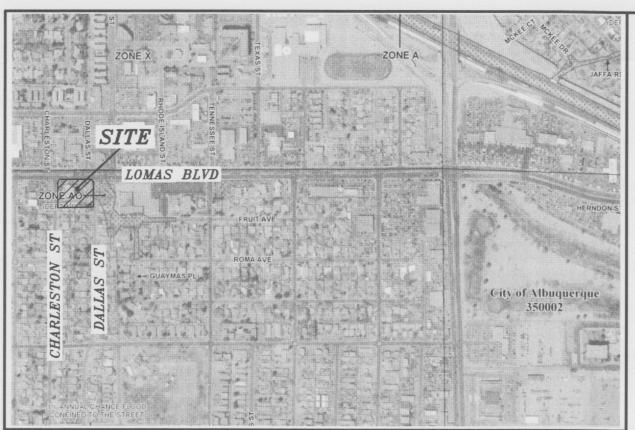

FIRM MAP:

35001C0358G

******************** * ZONE 3 100-YEAR, 6-HR STORM (UNDER EXISTING CONDITIONS) **************

START RAINFALL

TYPE=1 RAIN QUARTER=0.0 IN RAIN ONE=2.14 IN RAIN SIX=2.60 IN RAIN DELAY=3.10 IN DT=0.03333 HR ID=1 HYD NO=100.0 AREA=0.00191 SQ MI PER A=0.00 PER B=7.00 PER C=0.00 PER D=93.00

TP=0.1333 HR MASS RAINFALL=-1

********************** FINISH

COMPUTE NM HYD

Location

The site is located at 7800 Lomas Boulevard NE between Dallas St., ne and Charleston St., NE.

The purpose of this Grading and Drinage Plan is to show the proposed grades for the new building and the exiting drainge pattern for this site. We are requesting building permit approval.

Existing Drainage Conditions

The site drains from east to west to Charleston St. According to FIRM map number 35001C0358G, map revised September 08, 2008, the site does not fall within a 100-year floodplain.

Proposed Conditions and On-Site Drainage Management Plan The new building will be built over exiting impervious surface, and no additional runoff is being generated from this site. The drainage pattern will remain the same. The runoff will drain west throught the existing entrance to Charleston St.

Calculations

City of Albuquerque, Development Process Manuel, Section 22.2, Hydrology Section, was used for runoff calculations. See this plan for AHYMO input and Summary output files.

AHYMO PROGRAM SUMMARY TABLE (AHYMO 97) -- VERSION: 1997.02d RUN DATE (MON/DAY/YR) = 06/21/2012INPUT FILE = CENTRAL.TXT USER NO. = AHYMO-I-9702c01000R31-AH

FROM TO PEAK RUNOFF TIME TO CFS PAGE = 1 HYDROGRAPH ID ID AREA DISCHARGE VOLUME RUNOFF PEAK PER COMMAND IDENTIFICATION NO. NO. (SQ MI) (CFS) (AC-FT) (INCHES) (HOURS) ACRE NOTATION START TIME= RAINFALL TYPE= 1 RAIN6= 2.600 COMPUTE NM HYD 100.00 - 1 2.25487 1.500 4.864 PER IMP= 93.00 5.95 FINISH

GENERAL NOTES:

1: CONTOUR INTERVAL IS ONE (1.00) FOOT.

2: ELEVATIONS ARE BASED ON CITY OF ALBUQUERQUE CONTROL STATION 26-K19, HAVING AN ELEVATION OF 5329.456 FEET ABOVE SEA LEVEL

3: UTILITIES SHOWN HEREON ARE IN THEIR APPROXIMATE LOCATION BASED ONLY ON ABOVE GROUND EVIDENCE FOUND IN THE FIELD AND AS-BUILT INFORMATION PROVIDED BY THE CLIENT. UTILITIES SHOWN HEREON, WHETHER INDICATED AS ABANDONED OR NOT, SHALL BE VERIFIED BY OTHERS FOR EXACT LOCATION AND/ OR DEPTH PRIOR TO EXCAVATION OR DESIGN CON-SIDERATIONS.

4: THIS IS NOT A BOUNDARY SURVEY, BEARINGS ARE ASSUMED, DISTANCES AND FOUND PROPERTY CORNERS ARE FOR INFORMATIONAL PURPOSES ONLY.

5: SLOPES ARE AT 3:1 MAXIMUM.

O KEYED NOTES

1. CUT AND REMOVE EXISTING ASPHALT PAVING AS REQUIRED BY NEW CONSTRUCTION. 2. EXISTING ASPHALT PAVING. 3. EXISTING CONCRETE PAVING.

4. EXISTING SIDEWALK. 5. EXISTING CURB CUT WITH SIDEWALK RAMPS. 6. EXISTING WC RAMP.

EROSION CONTROL PLAN AND POLLUTION PREVENTION NOTES

- 1. CONTRACTOR IS RESPONSIBLE FOR OBTAINING A TOPSOIL DISTURBANCE PERMIT PRIOR TO BEGINNING WORK.
- 2. CONTRACTOR IS RESPONSIBLE FOR CLEANING ALL SEDIMENT OUT OF EXISTING RIGHT-OF-WAY.
- 3. CONTRACTOR IS RESPONSIBLE FOR MAINTAINING ALL STORM RUNOFF ON SITE.
- 4. REPAIR OF DAMAGED FACILITIES AND CLEAN-UP OF SEDIMENT ACCUMULATION ON ADJACENT PROPERTIES AND IN PUBLIC FACILITIES IS THE RESPONSIBILITY OF THE CONTRACTOR.
- 5. ALL EXPOSED EARTH SURFACES MUST BE PROTECTED FROM WIND AND WATER EROSION PRIOR TO FINAL ACCEPTANCE OF ANY
- 6. ALL THE DISTURBED AREAS MUST BE REVEGETATED.


NOTICE TO CONTRACTORS

1. AN EXCAVATION/CONSTRUCTION PERMIT WILL BE REQUIRED BEFORE BEGINNING ANY

2. ALL WORK DETAILED ON THESE PLANS TO BE PERFORMED, EXCEPT AS OTHERWISE

3. TWO WORKING DAYS PRIOR TO ANY EXCAVATION, CONTRACTOR MUST CONTACT LINE LOCATING SERVICE, 765-1234, FOR LOCATION OF EXISTING UTILITIES.

- 4. PRIOR TO CONSTRUCTION, THE CONTRACTOR SHALL EXCAVATE AND VERIFY THE HORIZONTAL AND VERTICAL LOCATIONS OF ALL CONSTRUCTIONS. SHOULD A CONFLICT EXIST, THE CONTRACTOR SHALL NOTIFY THE ENGINEER SO THAT THE CONFLICT CAN BE RESOLVED WITH A MINIMUM AMOUNT OF DELAY.
- 6. MAINTENANCE OF THESE FACILITIES SHALL BE THE RESPONSIBILITY OF THE OWNER OF THE PROPERTY SERVED.

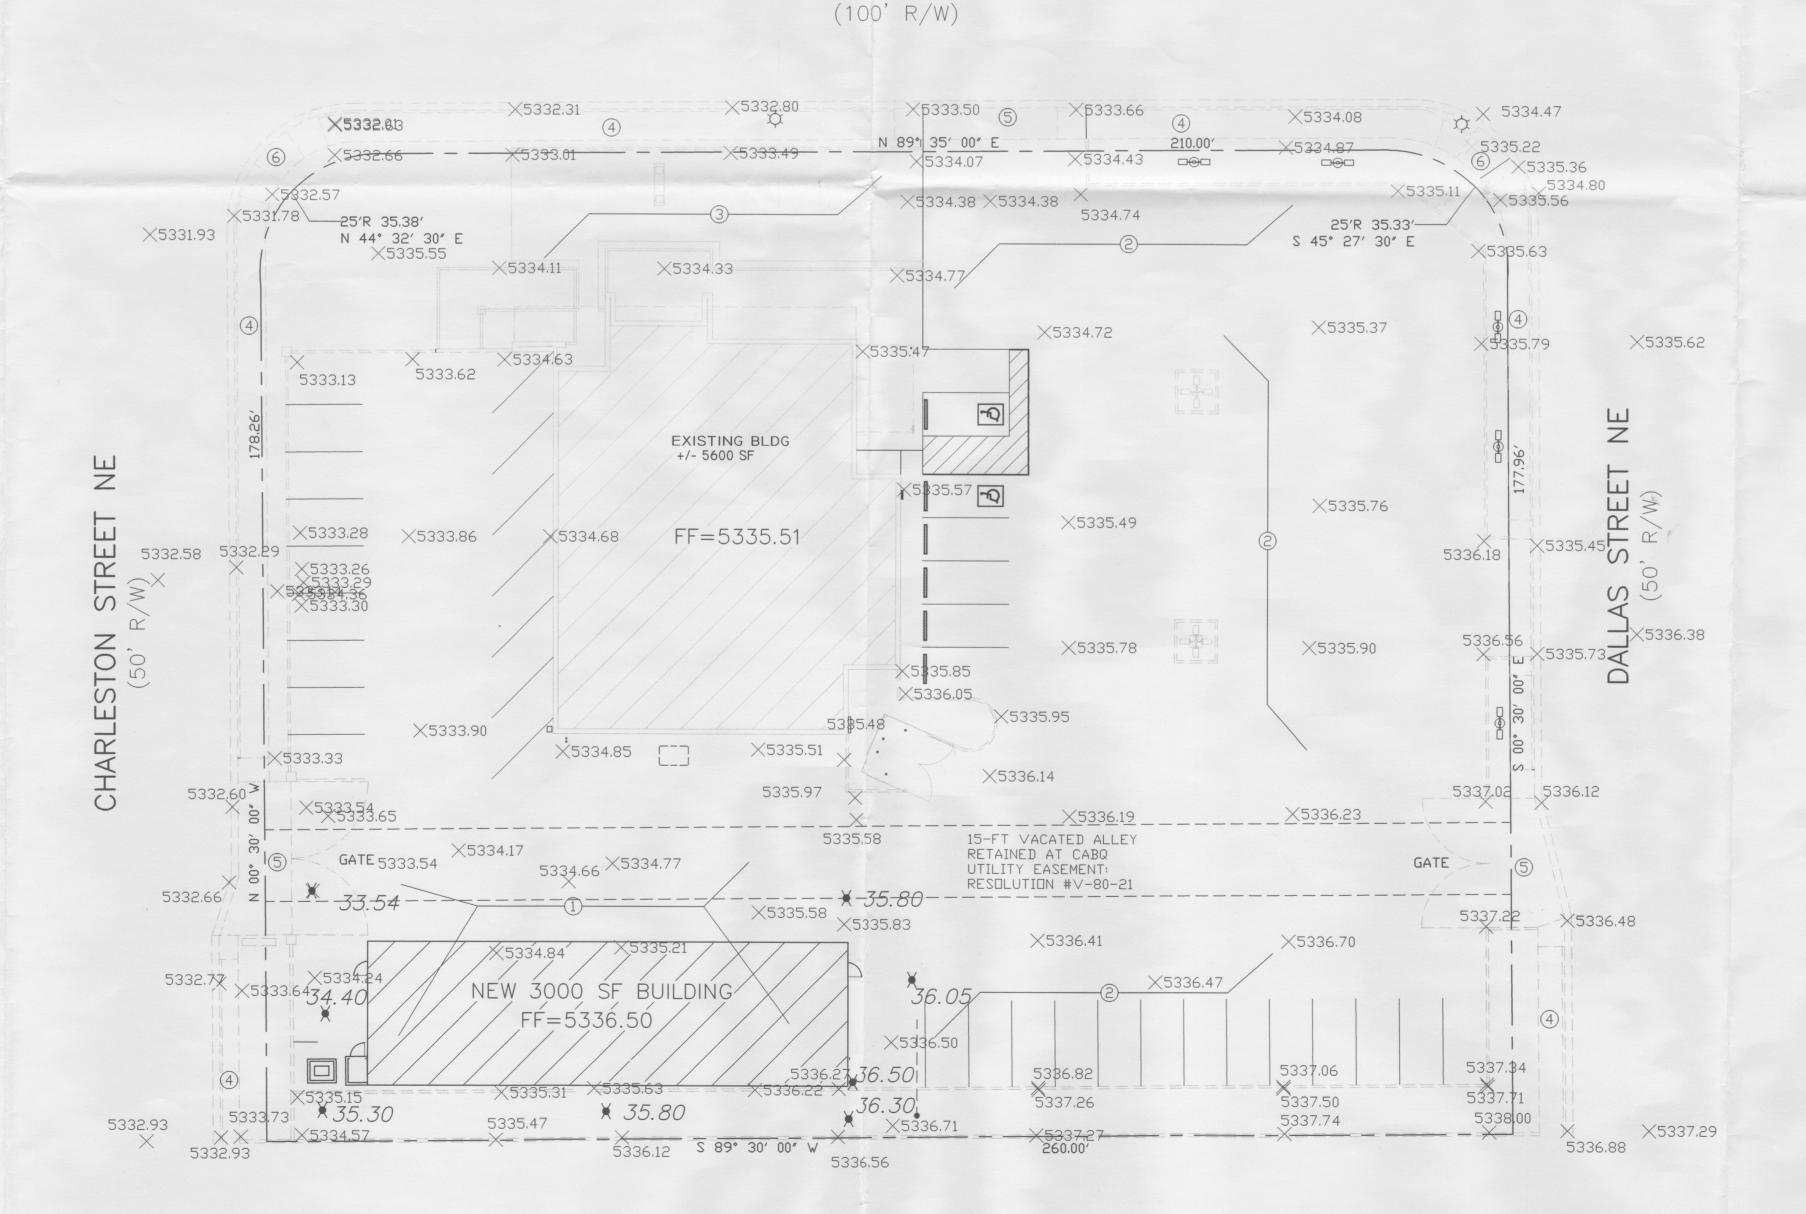

LOMAS BOULEVARD NE



7800 LOMAS, NE

NEW BUILDING ADDITION GRADING AND DRAINAGE PLAN

DATE:

06-22-12

DRAWN BY:


SBB

201212-GR.DWG

ALBUQUERQUE, NEW MEXICO 87184

SHEET#

(505)899-5570

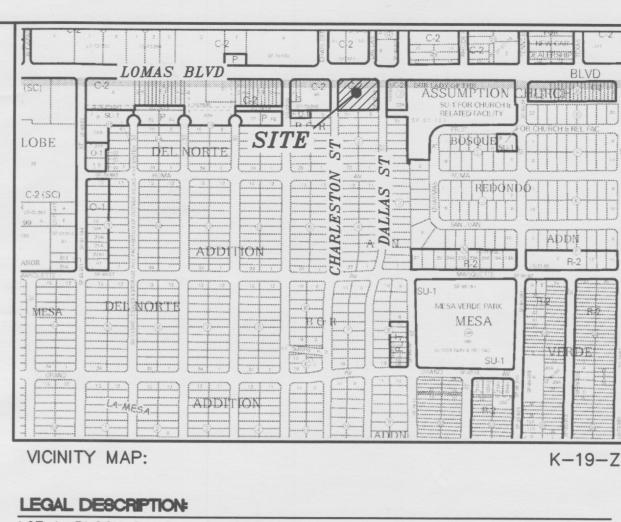

LOT A, BLOCK 2, B & R ADDITION CONTAINING 1.2060 ACRE

WORK WITHIN CITY RIGHT-OF-WAY.

STATED OR PROVIDED HEREON, SHALL BE CONSTRUCTED IN ACCORDANCE WITH CITY OF ALBUQUERQUE INTERIM STANDARD SPECIFICATIONS FOR PUBLIC WORKS CONSTRUCTION, 1985.

- 5. BACKFILL COMPACTION SHALL BE ACCORDING TO TRAFFIC/STREET USE.
- 7. WORK ON ARTERIAL STREETS SHALL BE PERFORMED ON A 24-HOUR BASIS.

LOMAS BOULEVARD NE (100' R/W) ARTERIAL

EXISTING BLDG +/- 5600 SF

NEW 3000 SF BLDG

260.00'

SITE PLAN

20'-0"

-25'R 35.38'

STON (50'

MH

N 44° 32' 30" E

N 89° 35' 00" E

15-FT VACATED ALLEY RETAINED AT CABO UTILITY EASEMENT: RESOLUTION

INSTALL TREES, 30 OC MAX, ALL OTHER LANDSCAPING TO REMAIN, NO CHANGE (7)

#V-80-21



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Separate DRC/Permit approval
and Work Order required.

P.O. BOX 3366 ALBUQUERQUE,NM 87190 T: (505) 281-9560 F: (505) 286-1055 C: (505) 259-7919 aktarch@earthlink.net

CONSULTANT

ALL WHEELCHAIR RAMPS LOCATED WITHIN THE PUBLIC RIGHT OF WAY MUST HAVE TRUNCATED DOMES.

ZONING DATA

ZONING: C-2 (COMMUNITY COMMERCIAL) ADDRESS: 7800 LOMAS BLVD. 87110 SITE AREA: 1.206 ACRES (+/- 52,533 SF) EXISTING BUILDING AREA: 5600 SF NEW AUTO SHOP BUILDING AREA: 3000 SF

ON-SITE PARKING PROVIDED: 19 SPACES (PLUS AUTO DISPLAY PARKING) INCLUDES 2 ACCESSIBLE PARKING SPACE (VAN) PER NM BLDG CODE REQUIRED PARKING EXISTING OFFICES: 1500 SF / 200 = 8 SPACE


EXISTING STORAGE: 2120 SF / 2000 = 1 SPACE EXISTING SHOP: 2000 SF / 1000 = 2 SPACES NEW SHOP: 2770 SF / 1000 = REQUIRED ON-SITE PARKING: 14 SPACES

KEYED NOTES (NEW CONSTRUCTION)

- 1. PAINT-OUT EXISTING PARKING STRIPING AND INSTALL NEW PAINT STRIPING AS SHOWN.
- 2. PATCH BACK EXISTING ASPHALT PAVING, (3-INCH OVER 6-INCH COMPACTED BASE, SHALL MEET CABQ SP3 SPECIFICATION), AS REQUIRED BY PROJECT.
- 3. TIE NEW SHOP BUILDING'S TRENCH DRAINS INTO EXISTING OIL/SAND SEPARATOR TANK.
- EXTEND TELEPHONE, DATA, AND ELECTRICAL SERVICE,
- UNDERGROUND, TO NEW SHOP BUILDING.
- 5. EXTEND SANITARY SEWER FROM NEW BUILDING AND TIE INTO EXISTING LINE IN EASEMENT.
- 6. EXTEND NEW LINE FROM EXISTING GAS REGULATOR TO NEW
- 7. REMOVE AND REPLACE EXISTING LANDSCAPE ROCK AS REQUIRED BY NEW TREE PLANTINGS. TREE TYPES AS SHOWN, MINIMUM 10-12 FOOT HEIGHT OR 2-INCH CALIPER.

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 - WHERE POTABLE WATER LINES CROSS SEWER LINES THERE SHALL BE A MINIMUM 18-INCH VERTICAL SEPARATION OR 10-FT DISTANCE FROM THE POINT OF CROSSING TO ANY JOINTS IN THE SEWER LINES. THERE SHALL BE A MINIMUM 18-INCH VERTICAL

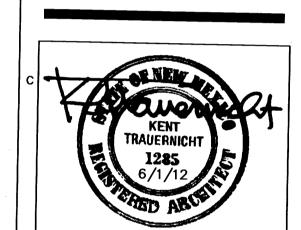

PROJECT

AUTO SHOP **BUILDING FOR** NICE CARS, LLC

PROJECT ADDRESS 7800 LOMAS BLVD NE **ALBUQUERQUE 87110**

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	MARK	DATE	DESCRIPTION	-
ISSUE DATE:				-

PROJECT NO: 0635 COPYRIGHT AKT ARCHITECTS, LLC

SHEET TITLE

SITE PLAN AND

TRAFFIC CIRCULATION

AS-101

JUN 1 - 2012

HYDROLOGY SECTION

BUILT IN SUBSTANTIAL COMPLIANCE TRAUERNICHT


MH

\S (50°

25'R 35.33'-

S 45° 27' 30" E

1" = 20'-0"

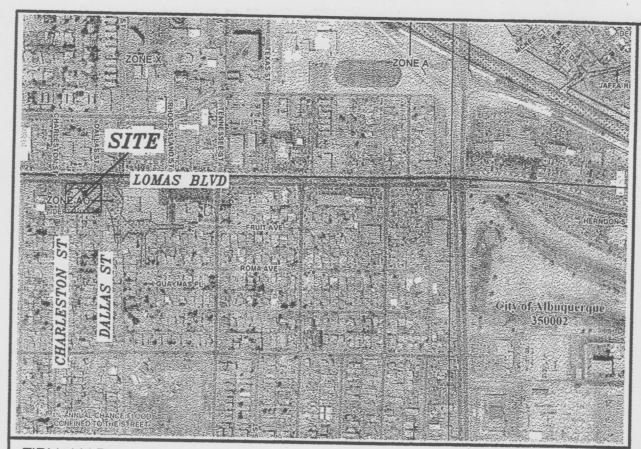

FIRM MAP:

35001C0358G

************* * ZONE 3 100-YEAR, 6-HR STORM (UNDER EXISTING CONDITIONS) **************

START RAINFALL

TYPE=1 RAIN QUARTER=0.0 IN

RAIN ONE=2.14 IN RAIN SIX=2.60 IN RAIN DELAY=3.10 IN DT=0.03333 HR

COMPUTE NM HYD ID=1 HYD NO=100.0 AREA=0.00191 SQ MI

PER A=0.00 PER B=7.00 PER C=0.00 PER D=93.00 TP=0.1333 HR MASS RAINFALL=-1 ***************

FINISH

Location The site is located at 7800 Lomas Boulevard NE between Dallas St., ne

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City of Albuquerque, Development Process Manuel, Section 22.2, Hydrology Section, was used for runoff calculations. See this plan for AHYMO input and Summary output files.

I REZA AFAGHPOUR, NMPE, HEREBY CERTIFY THAT PROJECT HAS BEEN GRADED AND WILL DRAIN IN SUBSTANTIAL COMPLIANCE WITH AND IN ACCORDANCE WITH THE DESIGN INTENT OF THE APPROVED PLAN DATED 06/22/2012 . THE RECORD INFORMATION EDITED ONTO THE ORIGINAL DESIGN DOCUMENT HAS BEEN OBTAINED BY ME OR UNDER MY DIRECT SUPERVISION AND IS TRUE AND CORRECT TO THE BEST OF MY KNOWLEDGE AND BELIEF. THIS CERTIFICATION IS SUBMITTED IN SUPPORT OF A REQUEST FOR ____Final Certificate

THE RECORD INFORMATION PRESENTED HEREON IS NOT NECESSARILY COMPLETE AND INTENDED ONLY TO VERIFY SUBSTANTIAL COMPLIANCE OF THE GRADING AND DRAINAGE ASPECTS OF THIS PROJECT. THOSE RELYING ON THIS RECORD DOCUMENT ARE ADVISED TO OBTAIN INDEPENDENT VERIFICATION OF ITS ACCURACY BEFORE USING IT FOR ANY OTHER PURPOSE.

HEZA AFAGHPONR NMPE # 11814

11/1/2012

DATE The second Information Editedonto the original design document has been obtained by NMPS 9801, of the Firm SBS Construction and Engineering, LLC (3B) 11/2/2012

AHYMO PROGRAM SUMMARY TABLE (AHYMO 97) -- VERSION: 1997.02d RUN DATE. (MON/DAY/YR) =06/21/2012 INPUT FILE = CENTRAL.TXT USER NO. = AHYMO-I-9702c01000R31-AH FROM TO PEAK RUNOFF HYDROGRAPH ID ID TIME TO CFS PAGE = 1AREA DISCHARGE VOLUME RUNOFF COMMAND IDENTIFICATION NO. NO. PEAK PER (SQ MI) (CFS) (INCHES) (HOURS). ACRE (AC-FT) NOTATION START RAINFALL TYPE= 1 TIME= COMPUTE NM HYD 100.00 - 1 RAIN6= 2.600 .00191 5.95 2.25487 1.500 4.864 PER IMP= 93.00 FINISH

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1. CUT AND REMOVE EXISTING ASPHALT PAVING AS REQUIRED

BY NEW CONSTRUCTION. 2. EXISTING ASPHALT PAVING.

3. EXISTING CONCRETE PAVING.

4. EXISTING SIDEWALK.

5. EXISTING CURB CUT WITH SIDEWALK RAMPS.

6. EXISTING WC RAMP.

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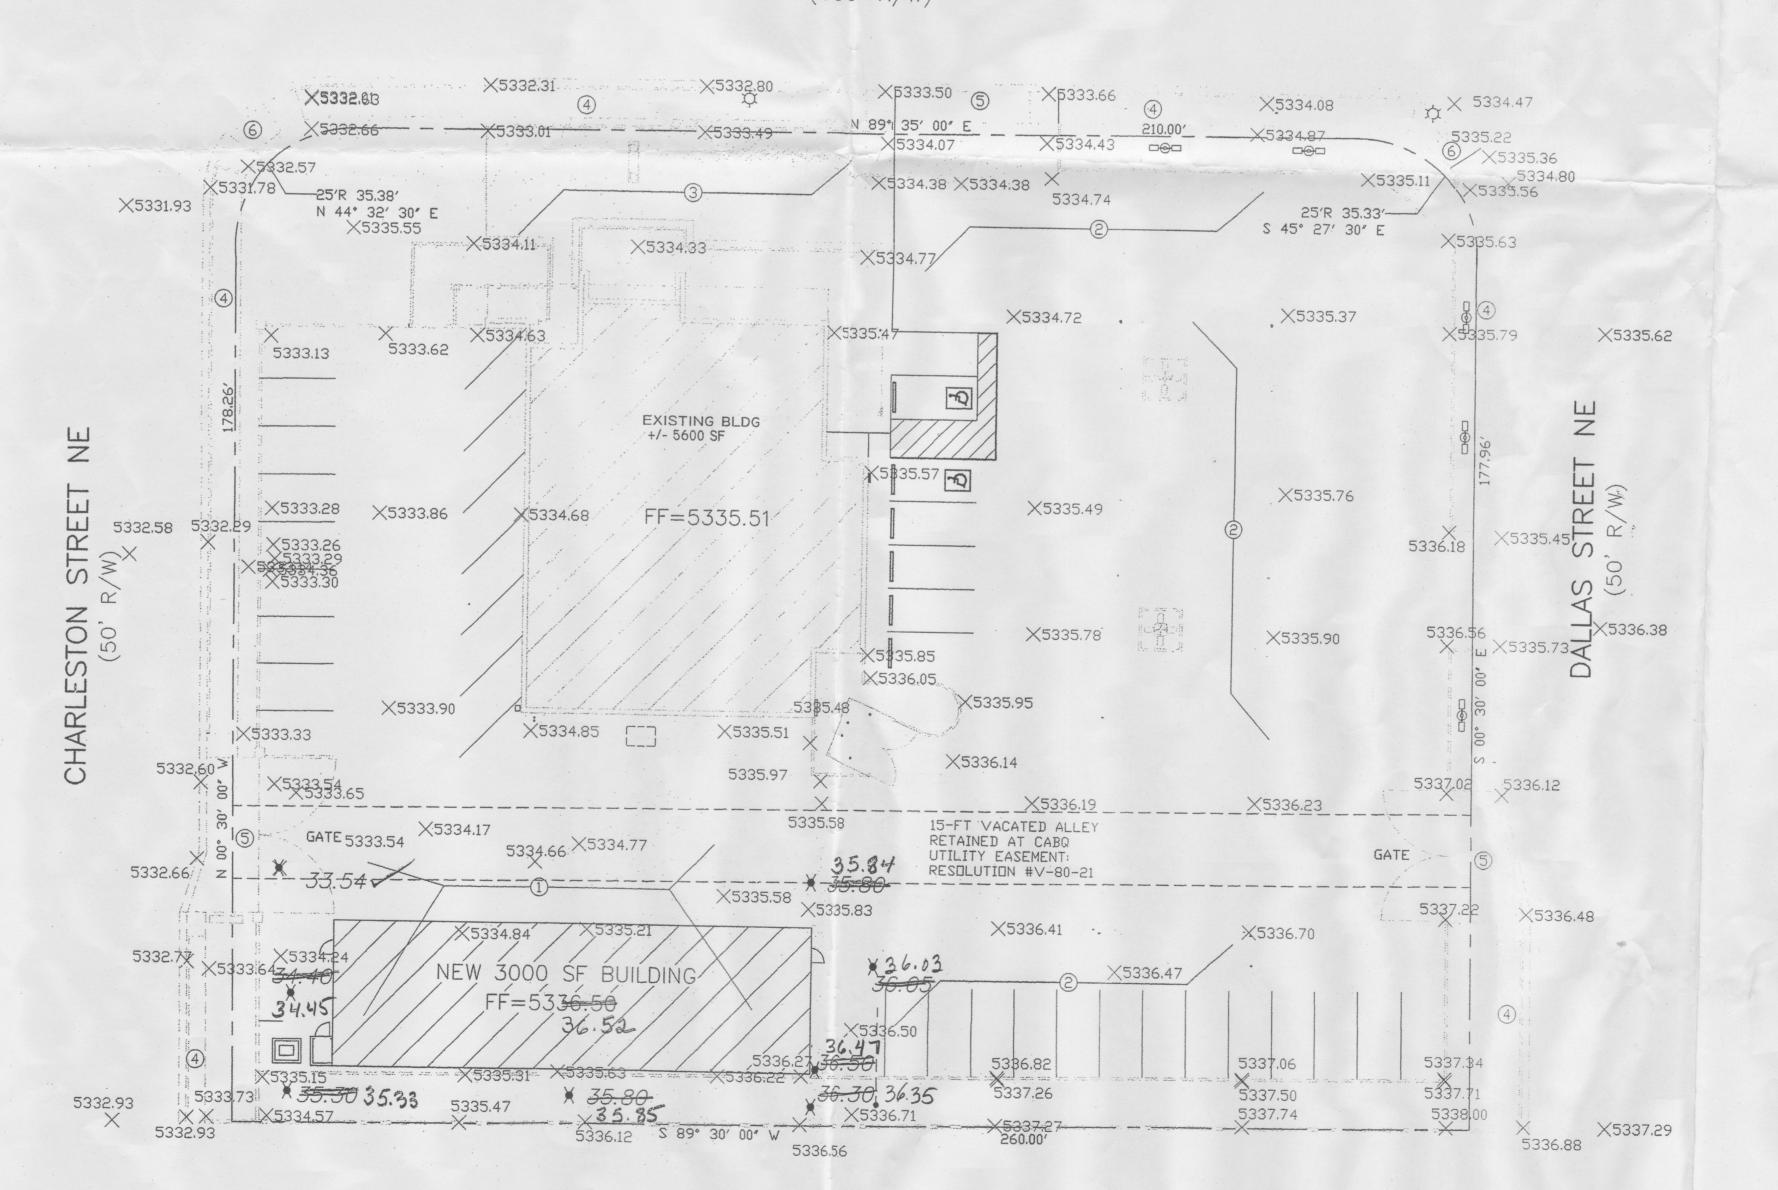
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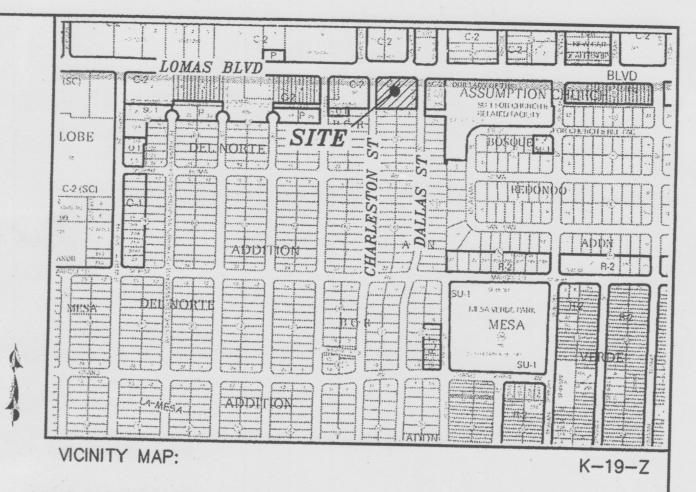
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6. ALL THE DISTURBED AREAS MUST BE REVEGETATED.

LOMAS BOULEVARD NE (100' R/W)





LEGAL DESCRIPTION

LOT A, BLOCK 2, B & R ADDITION CONTAINING 1.2060 ACRE

NOTICE TO CONTRACTORS

1. AN EXCAVATION/CONSTRUCTION PERMIT WILL BE REQUIRED BEFORE BEGINNING ANY WORK WITHIN CITY RIGHT-OF-WAY.

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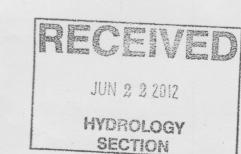
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7. WORK ON ARTERIAL STREETS SHALL BE PERFORMED ON A 24-HOUR BASIS.




- EXISTING CONTOUR (MAJOR) EXISTING CONTOUR (MINOR) - BOUNDARY LINE

× 36.05 PROPOSED SPOT ELEVATION $\times 5336.70$ EXISTING GRADE



GRAPHIC SCALE

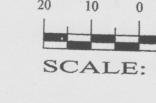

SCALE: 1"=20"

SBS CONSTRUCTION AND ENGINEERING, LLC P. O. BOX 10264 ALBUQUERQUE, NEW MEXICO 87184

(505)899-5570 7800 LOMAS, NE NEW BUILDING ADDITION GRADING AND DRAINAGE PLAN

DRAWN BY: DATE: SHEET# 201212-GR.DWG SBB 06-22-12 1 OF