CITY OF ALBUQUERQUE

Planning Department Alan Varela, Director



Mayor Timothy M. Keller

September 30, 2024

Justin Simenson, Isaacson & Arfman, Inc 128 Monroe St NE, Albuquerque, NM 87108

Re: Somos Apartments 7200 Central Ave SE Traffic Circulation Layout Engineer's/Architect's Stamp 08/28/24 (K19D155)

Dear Mr. Simenson,

The TCL submittal received 09-18-2024 is approved for Building Permit by transportation. A copy of the stamped and signed plan will be needed for each of the building permit plans. Please keep the original to be used for certification of the site for final C.O. for Transportation.

When the site construction is completed and an inspection for Certificate of Occupancy (C.O.) is requested, use the original City stamped approved TCL for certification. Redline any minor changes and adjustments that were made in the field. A NM registered architect or engineer must stamp, sign, and date the certification TCL along with indicating that the development was built in "substantial compliance" with the TCL. Submit this certification, the TCL, and a completed <u>Drainage and Transportation</u> Information Sheet to <u>plndrs@cabq.gov</u> for log in and evaluation by Transportation.

Once verification of certification is completed and approved, notification will be made to Building Safety to issue Final C.O. To confirm that a final C.O. has been issued, call Building Safety at 924-3690.

Sincerely,

Ernest Armijo, P.E. Principal Engineer, Planning Dept. Development Review Services

via: emailC: CO Clerk, File




City of Albuquerque

Planning Department Development & Building Services Division

DRAINAGE AND TRANSPORTATION INFORMATION SHEET (DTIS)

Project Title:		Hydrology File #				
Legal Description:						
City Address, UPC, OR Parcel:						
Applicant/Agent:Address: Email:Applicant/Owner: Address:Email:		Phone:				
		Contact Phone:	:			
TYPE OF DEVELOPMENT: Plat (# of lots)			Single Family Home All other Developments			
	RE-SUBMITTAL:	YES	NO			
DEPARTMENT: TRANS	SPORTATION	HYDROLO	DGY/DRAINAGE			
Check all that apply under Both	the Type of Submittal a	nd the Type	of Approval Sought:			
TYPE OF SUBMITTAL:		TYPE OF APPROVAL SOUGHT:				
Engineering / Architect Certification		Pad Certification				
Conceptual Grading & Drainage Plan		Building Permit				
Grading & Drainage Plan, and/or Drainage Report		Grading Permit Paving Permit				
Drainage Report (Work Order)		SO-19 Permit				
Drainage Master Plan		Foundation Permit				
Conditional Letter of Map Revision (CLOMR)			te of Occupancy - Temp	Perm		
Letter of Map Revision (LOMR)		Preliminary / Final Plat				
Floodplain Development Permit		Site Plan for Building Permit - DFT				
Traffic Circulation Layout (TCL) – Administrative		Work Order (DRC)				
Traffic Circulation Layout (TCL) – DFT Approval		Release of Financial Guarantee (ROFG) CLOMR / LOMR				
Traffic Impact Study (TIS)		Conceptual TCL - DFT				
Street Light Layout		OTHER	(SPECIFY)			
OTHER (SPECIFY)						

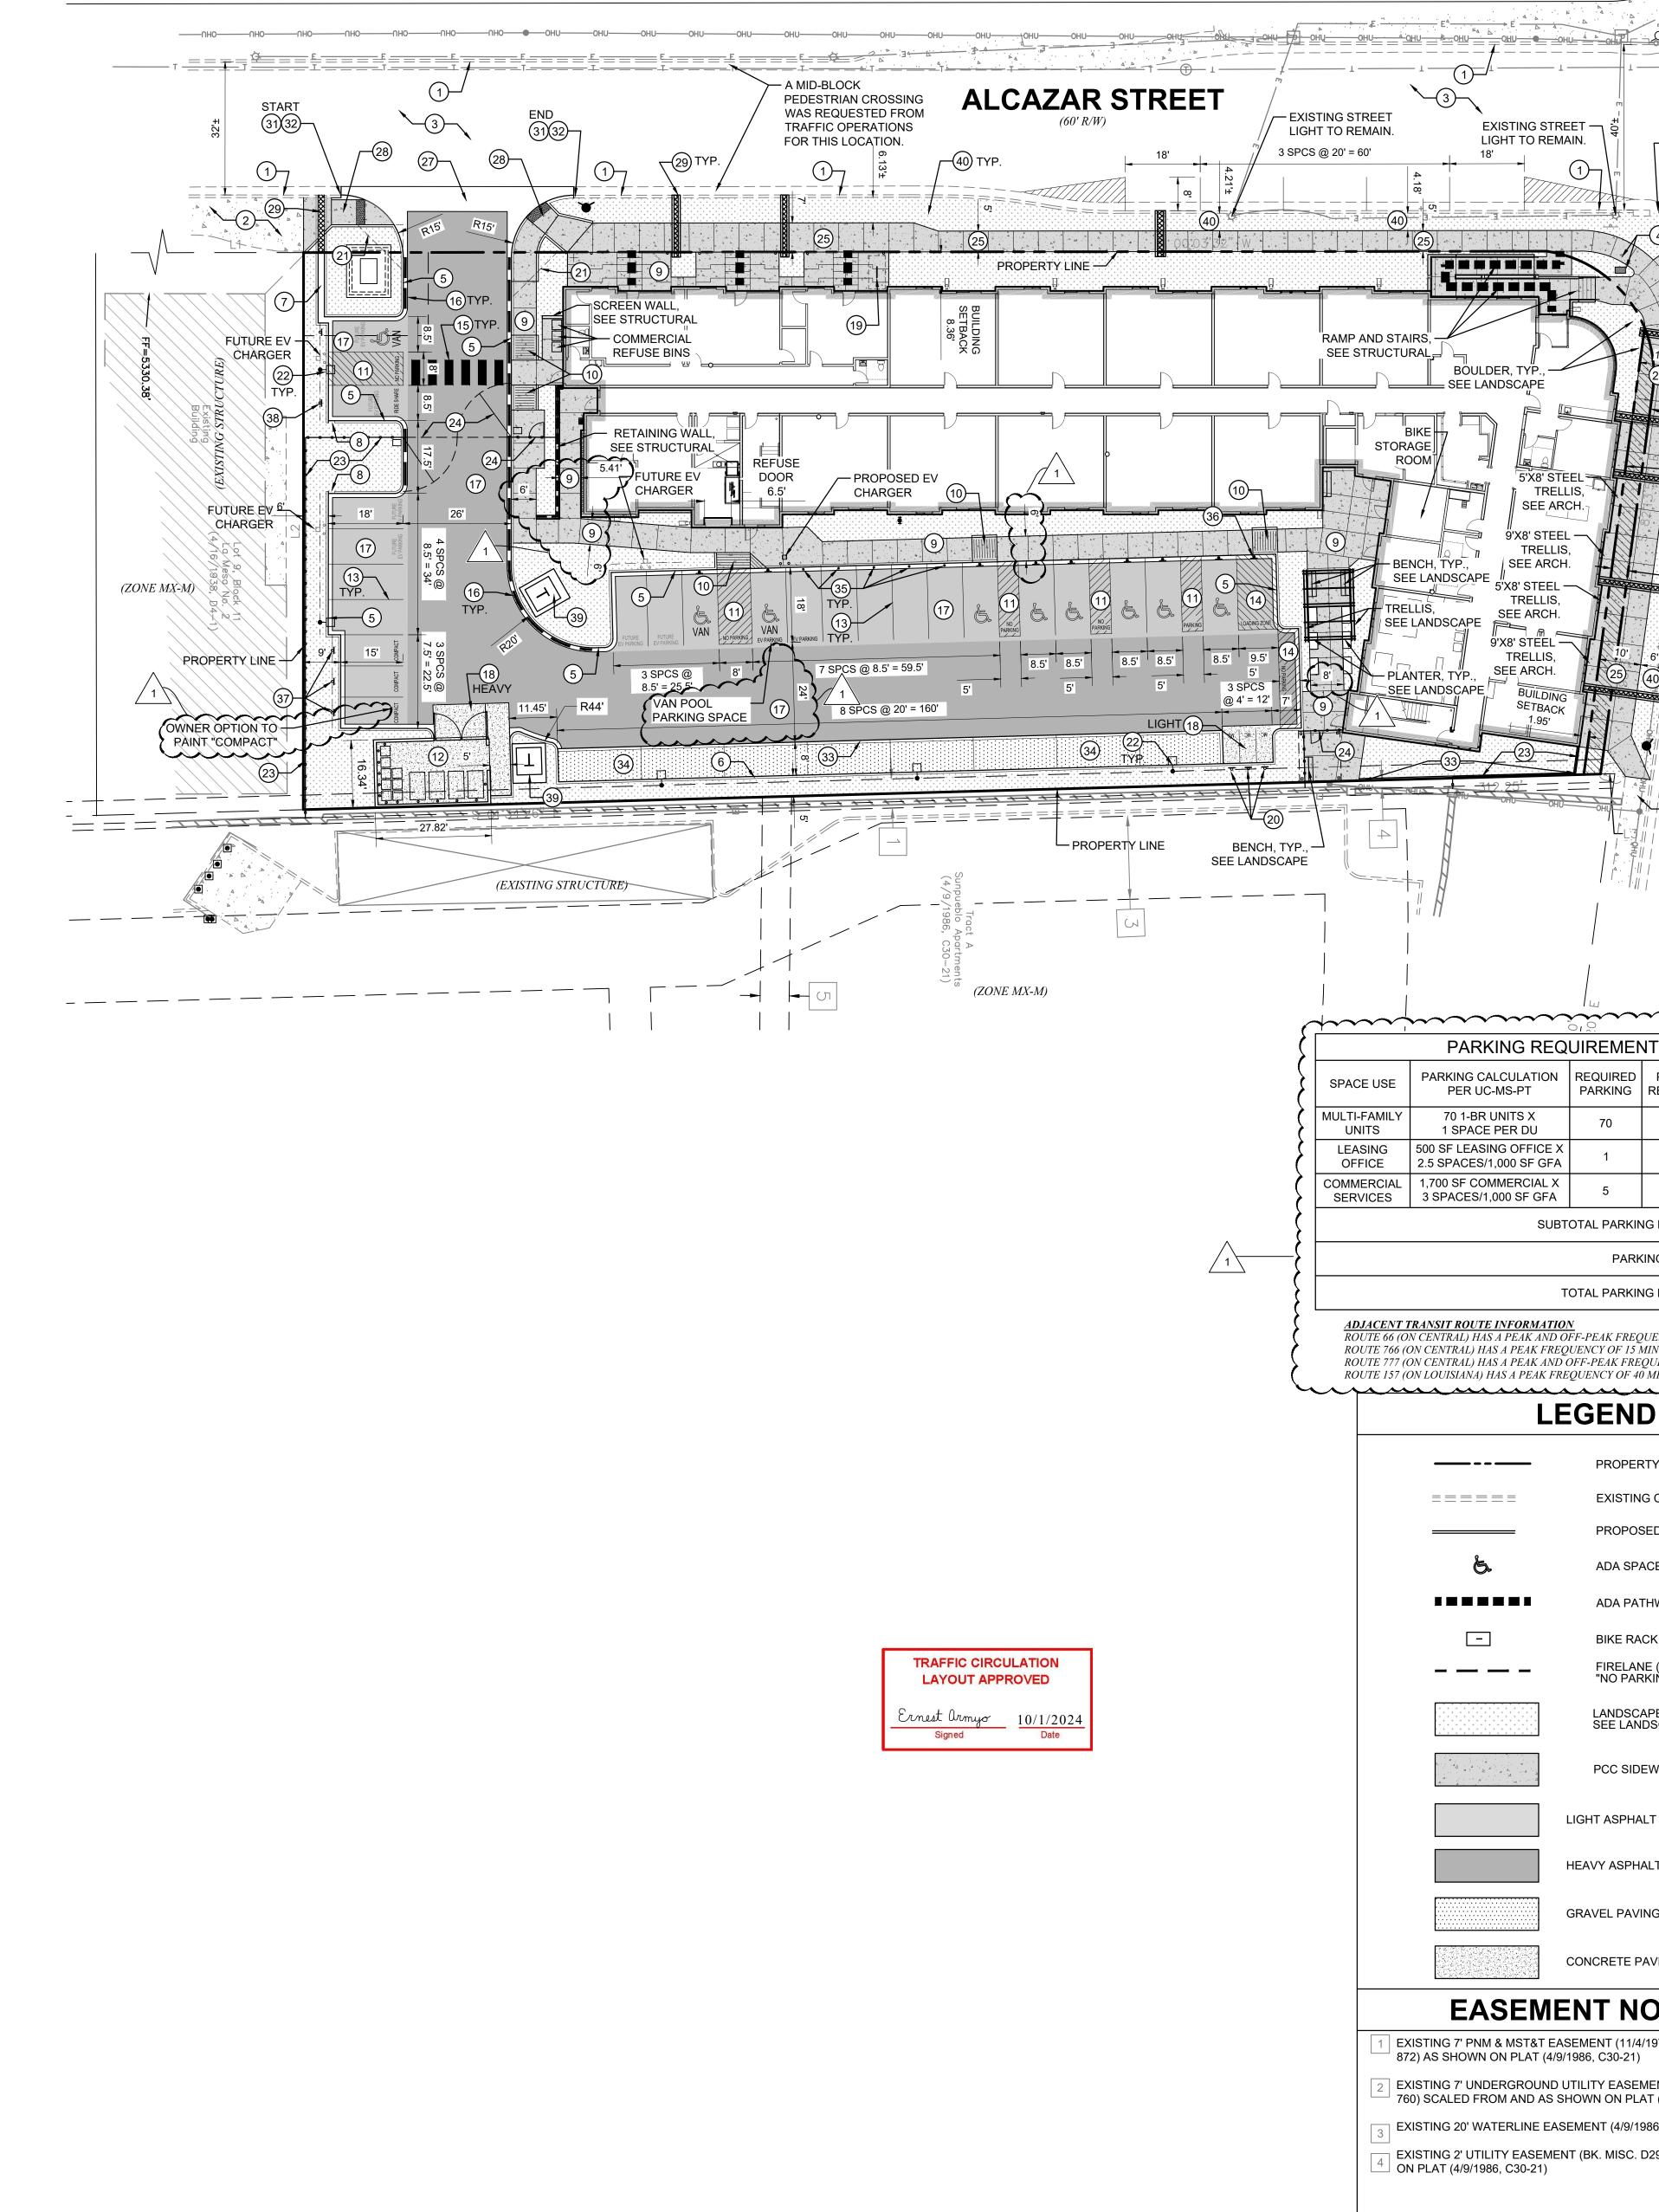

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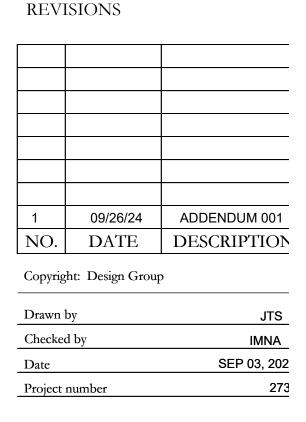
	5	6
		C.C.O.A. VICINITY MAP K-19-Z Image: constraint of the state of
Image: Constraint of the second system NTS PARKING REDUCTION 28 (40%) 42 1 (40%) 0 3 (50%) 2 NG REQUIRED 44	NOTE: ALL BROKEN OR CRACKED SIDEWALK MUST BE REPLACED WITH SIDEWALK AND CURB & GUTTER.	SITE AREA: 0.9494 ACRES ZONING: MX-M BUILDING CALCULATIONS: GROSS FLOOR AREA (GFA)=64,380 SF ± 1-BEDROOM UNITS= 70 LEASING OFFICE= 500 SF COMMERCIAL= 1,700 SF OPEN SPACE CALCULATIONS: UC-MS-PT OPENSPACE REQUIREMENTS 225 SQUARE FEET x I BED= 15,750 SF 50% MAIN STREET CORRIDOR REDUCTION=7,875 SF REQUIRED: 7,875 SF PROVIDED: 10,853 SF PARKING CALCULATIONS: SEE TABLE THIS SHEET NOTE: COMMERCIAL SPACE MAY BE COMMERCIAL SERVICE, COMMERCIAL RETAIL, OR A COMBINATION OF BOTH. THEREFORE, THE PARKING CALCULATION USED BELOW IS BASED ON COMMERCIAL SERVICES, WHICH REQUIRES MORE PARKING THAN COMMERCIAL RETAIL.
KING CREDITS 11 NG REQUIRED 33 QUENCY OF 15 MINUTES MINUTES EQUENCY OF 15 MINUTES EQUENCY OF 15 MINUTES MINUTES EQUENCY OF 15 MINUTES EQUENCY OF 15 MINU	 EXISTING SIDEWALK TO REMAIN. EXISTING ASPHALT TO REMAIN. EXISTING ART PILLAR TO BE RELOCATED. MEDIAN CURB & GUTTER, PER DETAIL ON SHEET CP-501. HEADER CURB, PER DETAIL ON SHEET CP-501. PCC RUNDOWN, PER DETAIL ON SHEET CP-501. CURB OPENING, PER DETAIL ON SHEET CP-501. SEE SHEET CG-101 FOR SIZE. PCC SIDEWALK, PER DETAIL ON SHEET CP-501. ADA RAMP, PER DETAIL ON SHEET CP-501. ADA PARKING AND SIGNAGE, PER DETAIL ON SHEET CP-502. REFUSE ENCLOSURE, PER DETAIL ON SHEET CP-502. 4" WHITE STRIPE. 4" WHITE STRIPE @ 45° ANGLE WITH 2' SPACING. 12" WHITE STRIPE, 4' O.C ALONG DASHED LINE, PAINT FACE AND TOP OF CURB RED AND PAINT WHITE STENCILED LETTERING ON TOP OF CURB "NO PARKING" AND "FIRE LANE" ALTERNATING AT 30 FT O.C. ASPHALT PAVING (LIGHT DUTY OR HEAVY DUTY), PER DETAIL ON 	APPLICABLE PARKING REDUCTIONS MULTI-FAMILY UNITS: 5-5(C)(3)(d)(1&2) 40% PROXIMITY TO TRANSIT REDUCTION LEASING OFFICE: 5-5(C)(3)(d)(1&2) 40% PROXIMITY TO TRANSIT REDUCTION COMMERCIAL SERVICES: 5-5(C)(3)(d) 50% PREMIUM TRANSIT REDUCTION APPLICABLE PARKING CREDITS 5-5(C)(6)(b) 1 VAN POOL PARKING x 7 SPACES = 7 SPACES 5-5(C)(6)(c) SHARED VEHICLE PROGRAM x 4 SPACES = 4 SPACES I PARKING SPACE TO BE DESIGNATED AS "CAR SHARING PARKING ONLY" AND TO BE MADE PART OF A CAR SHARING PROGRAM ESTABLISHED BY <u>THE OWNER DURING DEVELOPMENT OF THE PROJECT</u> TOTAL CREDITS = 11 TOTAL REQUIRED: 33 SPACES TOTAL PROVIDED: 37 SPACES (INCLUDES 9 ADA, 3 COMPACT, AND 5 ON-STREET) ADA REQUIRED: 2 SPACES (1 VAN SPACE) (PER 26-50 REQUIRED PARKING) ADA PROVIDED: 9 SPACES (3 VAN SPACES) EV READY REQUIRED: 2 SPACES (5% OF REQUIRED PARKING) EV READY REQUIRED: 2 SPACES (15% OF REQUIRED PARKING) EV READY PROVIDED: 2 SPACES MOTORCYCLE REQUIRED: 6 SPACES EV CAPABLE PROVIDED: 6 SPACES MOTORCYCLE REQUIRED: 2 SPACES (15% OF REQUIRED PARKING) EV CAPABLE PROVIDED: 3 SPACES BICYCLE REQUIRED: 2 SPACES (10% OF REQUIRED PARKING) MOTORCYCLE PROVIDED: 3 SPACES BICYCLE PROVIDED: 3 SPACES (10% OF REQUIRED PARKING) BICYCLE PROVIDED: 2 SPACES (10% OF REQUIRED PARKING)
NE (RED) RKING" CAPE AREA NDSCAPE PLANS DEWALK ALT PAVING SECTION HALT PAVING SECTION HALT PAVING SECTION VING SECTION PAVING SECTION DEVING SECTION	 SHEET CP-501. 18. CONCRETE PAVING (LIGHT DUTY OR HEAVY DUTY), PER DETAIL ON SHEET CP-501. 19. BICYCLE RACK, PER DETAIL ON SHEET CP-501. 20. SITE SIGNAGE: MOTORCYCLE PARKING, PER DETAIL ON SHEET CP-501. 21. MINI CLEAR SIGHT TRIANGLE. SEE GENERAL NOTE H. 22. SITE LIGHTING ON 20' POLE, SEE ELECTRICAL. 23. PERIMETER SECURITY FENCE. SEE ARCHITECTURAL. 24. 36" ACCESS GATE, SEE ARCHITECTURAL. 25. PUBLIC PCC SIDEWALK (WIDTH PER PLAN) PER COA STD DWG #2430. 26. STANDARD CURB & GUTTER PER COA STD DWG #2415A. 27. PCC VALLEY GUTTER 6' WIDE, 1 1/2" INVERT PER COA STD DWG #2420. 28. UNI-DIRECTIONAL ADA RAMP PER COA STD DWG #2443, DETAIL C. 29. SIDEWALK CULVERT PER COA STD DWG #2236. 30. NOT USED. 31. REMOVE AND DISPOSE EXISTING PCC CURB & GUTTER. 32. REMOVE AND DISPOSE EXISTING PCC SIDEWALK. 33. CUT-OFF WALL, PER DETAIL ON SHEET CP-501. 	 A. THE SUBJECT SITE IS WITHIN A DESIGNATED MAIN STREET CORRIDOR, WHICH PURSUANT TO IDO TABLE 5-1-2, ALLOWS FOR REDUCED SETBACKS AND TALLER MAXIMUM BUILDING HEIGHTS, AND PURSUANT TO TABLE 5-5-1, PARKING REDUCTIONS TO 1 SPACE PER DWELLING UNIT (SEE PARKING CALCULATIONS, THIS SHEET). THE SUBJECT SITE IS ALSO WITHIN A PREMIUM TRANSIT STATION AREA. B. THERE ARE NO ADJACENT OR ABUTTING PROTECTED LOTS ZONED R-A, R-1, R-MC, OR R-T THAT CONTAIN LOW DENSITY RESIDENTIAL DEVELOPMENT; THEREFORE, IDO SECTION 5-9 DOES NOT APPLY. C. DIMENSIONS ARE TO FACE OF CURB, OR WALL, OR EDGE OF PAVEMENT UNLESS OTHERWISE NOTED. D. ALL CURB RADII ARE 2' UNLESS OTHERWISE NOTED. E. ALL INTERNAL SIDEWALKS SHALL BE A MINIMUM OF 5 FEET IN WIDTH UNLESS OTHERWISE NOTED. F. CURBS AND ACCESSIBLE RAMPS WILL BE DESIGNED AND BUILT ACCORDING TO THE CITY OF ALBUQUERQUE STANDARDS. G. STREETS, PARKING SPACES AND ASSOCIATED DRIVES TO BE ASPHALT UNLESS NOTED OTHERWISE.
4/1971, BK. MISC. 235, PG.) EMENT (BK. MISC. 697, PG. .AT (4/9/1986, C30-21) 1986, C30-21) D299, PG. 499) AS SHOWN	 34. GRAVEL PAVING, PER DETAIL ON SHEET CP-501. 35. CONCRETE FILLED BOLLARD, PER DETAIL ON SHEET CP-501. 36. SITE SIGNAGE: LOADING ONLY, PER DETAIL ON SHEET CP-501. 37. SITE SIGNAGE: COMPACT PARKING, PER DETAIL ON SHEET CP-501. 38. SITE SIGNAGE: RIDE SHARE PARKING, PER DETAIL ON SHEET CP-501. 39. TRANSFORMER LOCATION, SEE ELECTRICAL. 40. DEPRESSED LANDSCAPE BUFFER SWALE PER COA STD DWG #2414. 	 UNLESS NOTED OTHERWISE. H. LANDSCAPING AND SIGNAGE WILL NOT INTERFERE WITH CLEAR SIGHT REQUIREMENTS. THEREFORE, SIGNS, WALLS, TREES, AND SHRUBBERY BETWEEN 3 AND 8 FEET TALL AS MEASURED FROM THE GUTTER PAN WILL NOT BE ACCEPTABLE IN THE LINE OF SIGHT AREA. I. ALL OUTDOOR LIGHT FIXTURES SHALL BE IN COMPLIANCE WITH IDO SECTION 5-8 OUTDOOR AND SITE LIGHTING AND TABLE 5-8-1. J. ONSITE TRANSFORMERS SHALL HAVE A 5-FOOT CLEAR AREA ON THE SIDES AND REAR AND A 10-FOOT CLEAR AREA IN FRONT TO ALLOW FOR ACCESS AND MAINTENANCE OR AS PER PNM STANDARD REQUIREMENTS.




SHEET NUMBER

SITE PLAN


SHEET TITLE



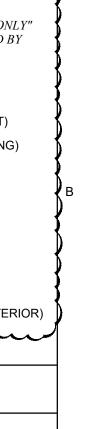



7200 CENTRAL AVE SE, ALBUQUERQUE, NEW MEXICO 87108

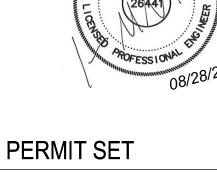

PROJECT NAME

SOMOS

STAMP



Arfman, Inc


Civil Engineering Consultan

505-268-8828 | www.iacivil.coi

128 Monroe Street N


Albuquerque, NM 8710

Isaacson &

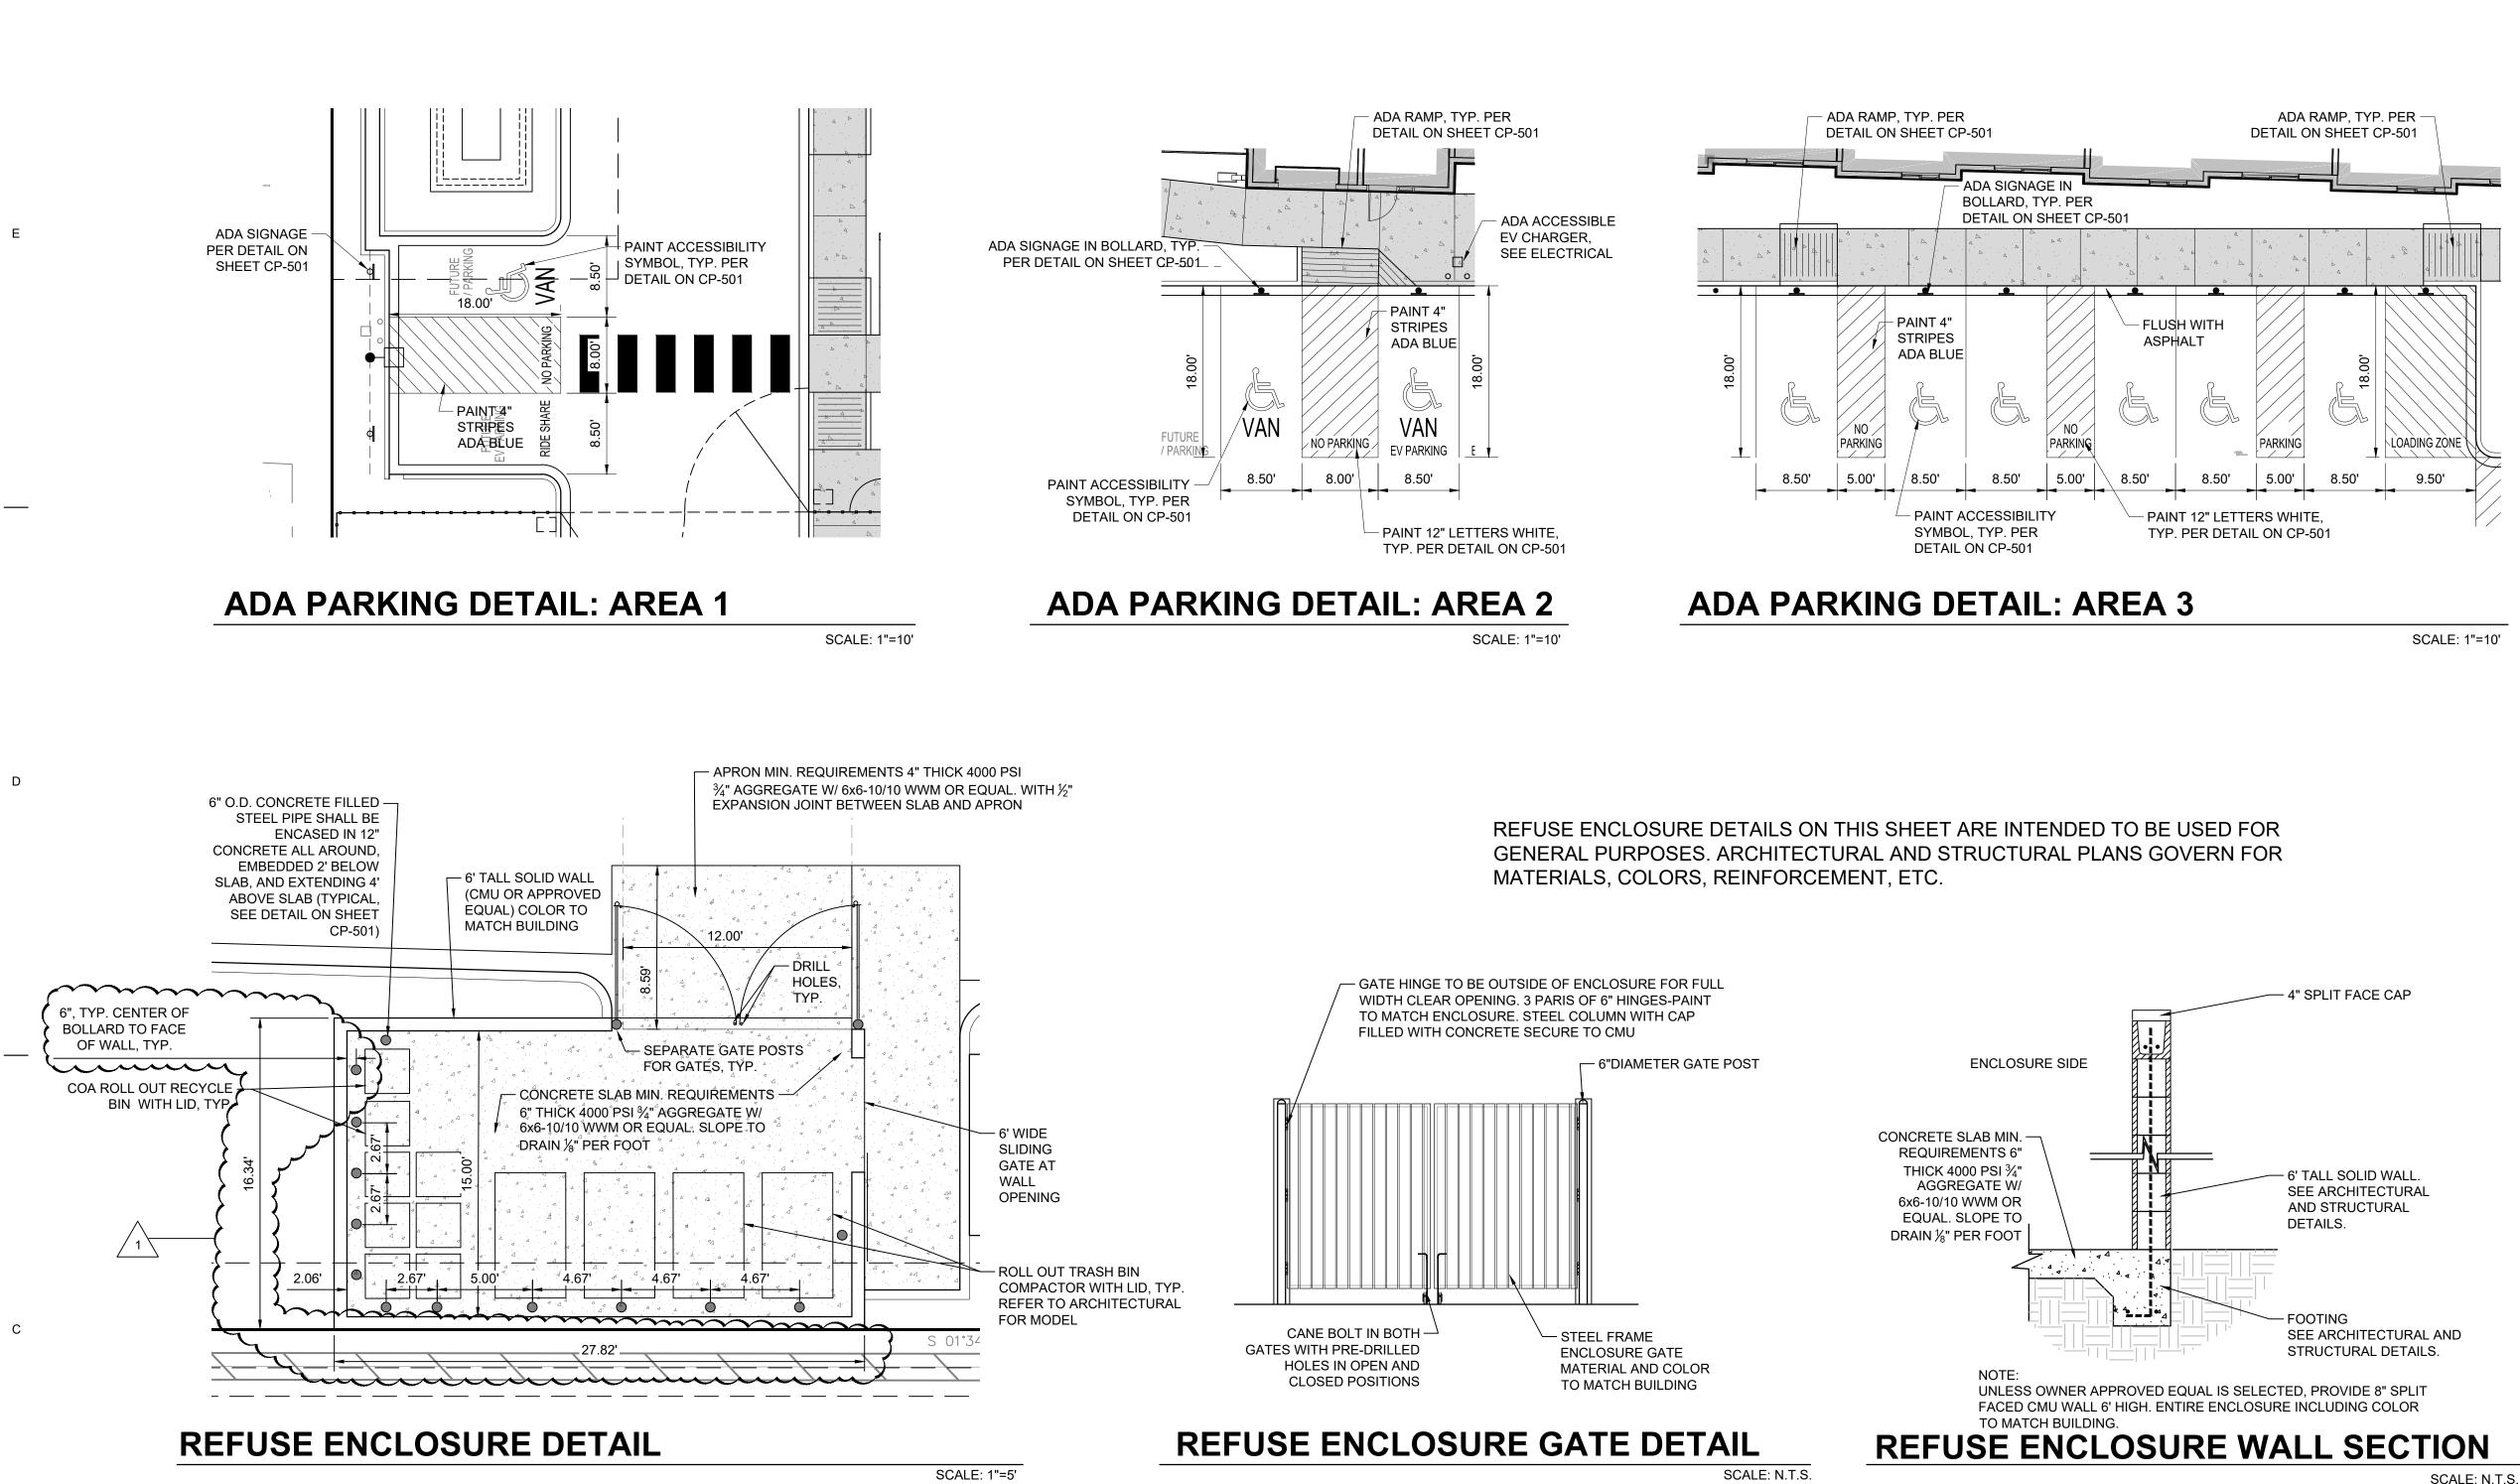

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TRAFFIC CIRCULATION LAYOUT APPROVED Ernest armyo <u>Signed</u> <u>10/1/2024</u> Date

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SCALE: N.T.S.
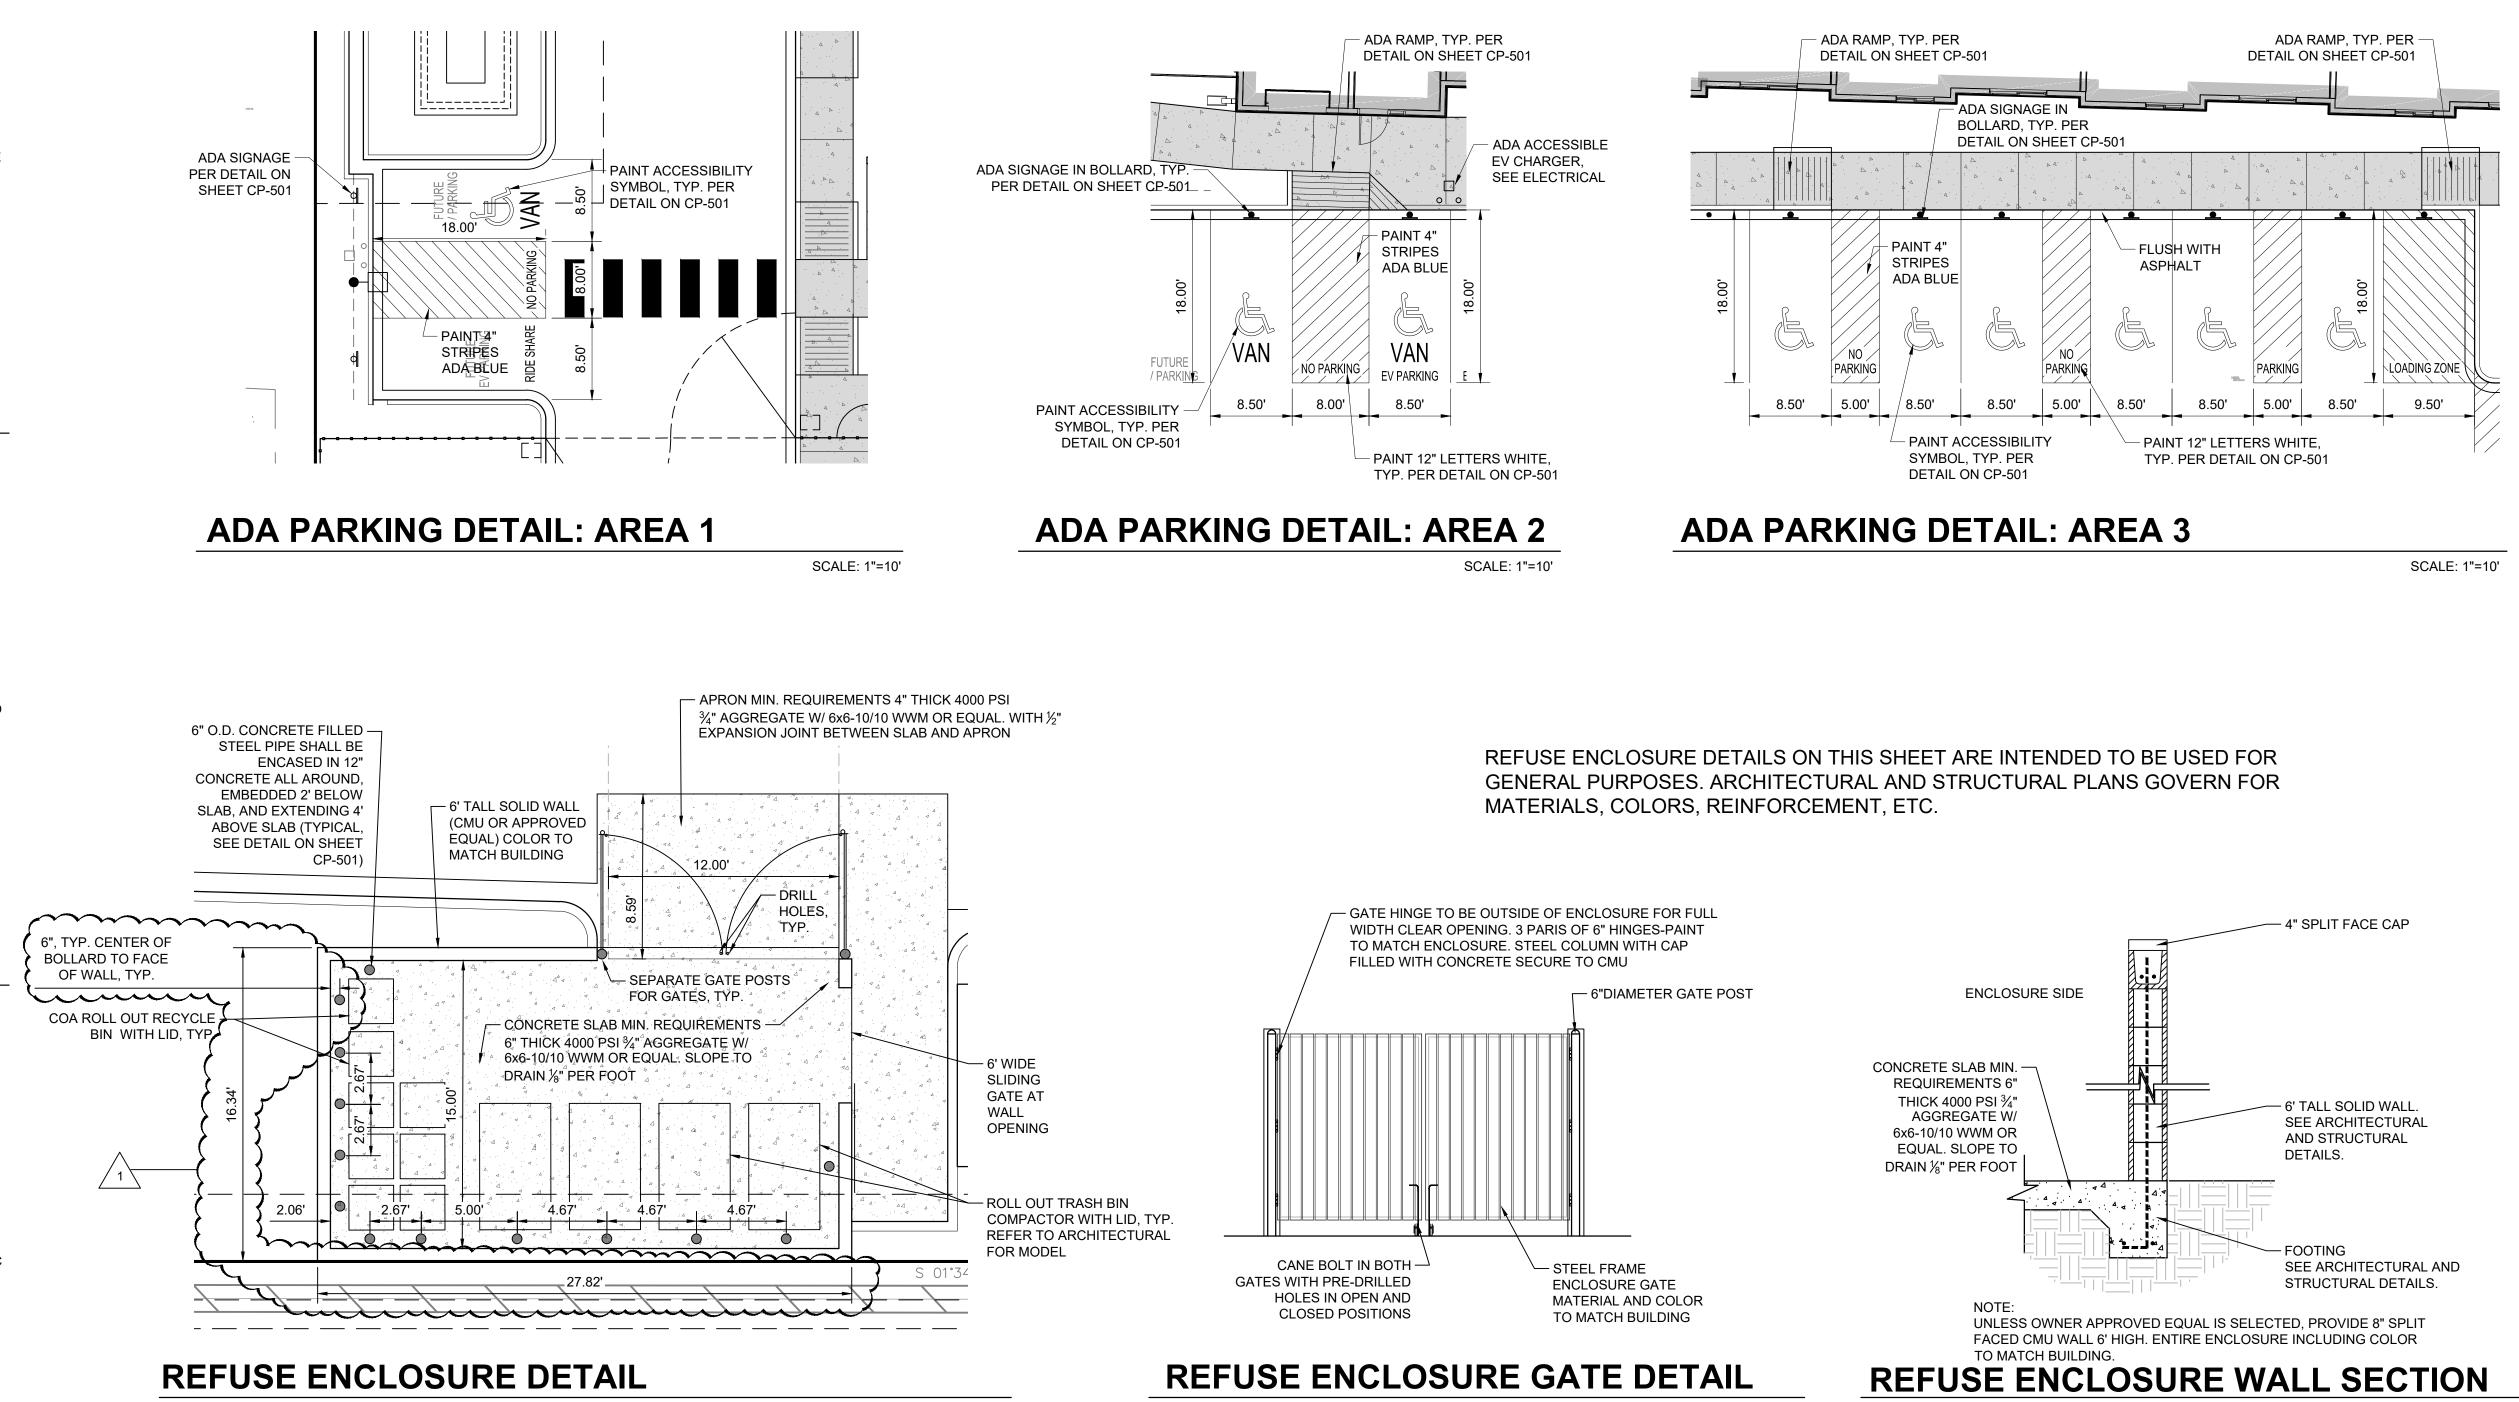
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STAMP




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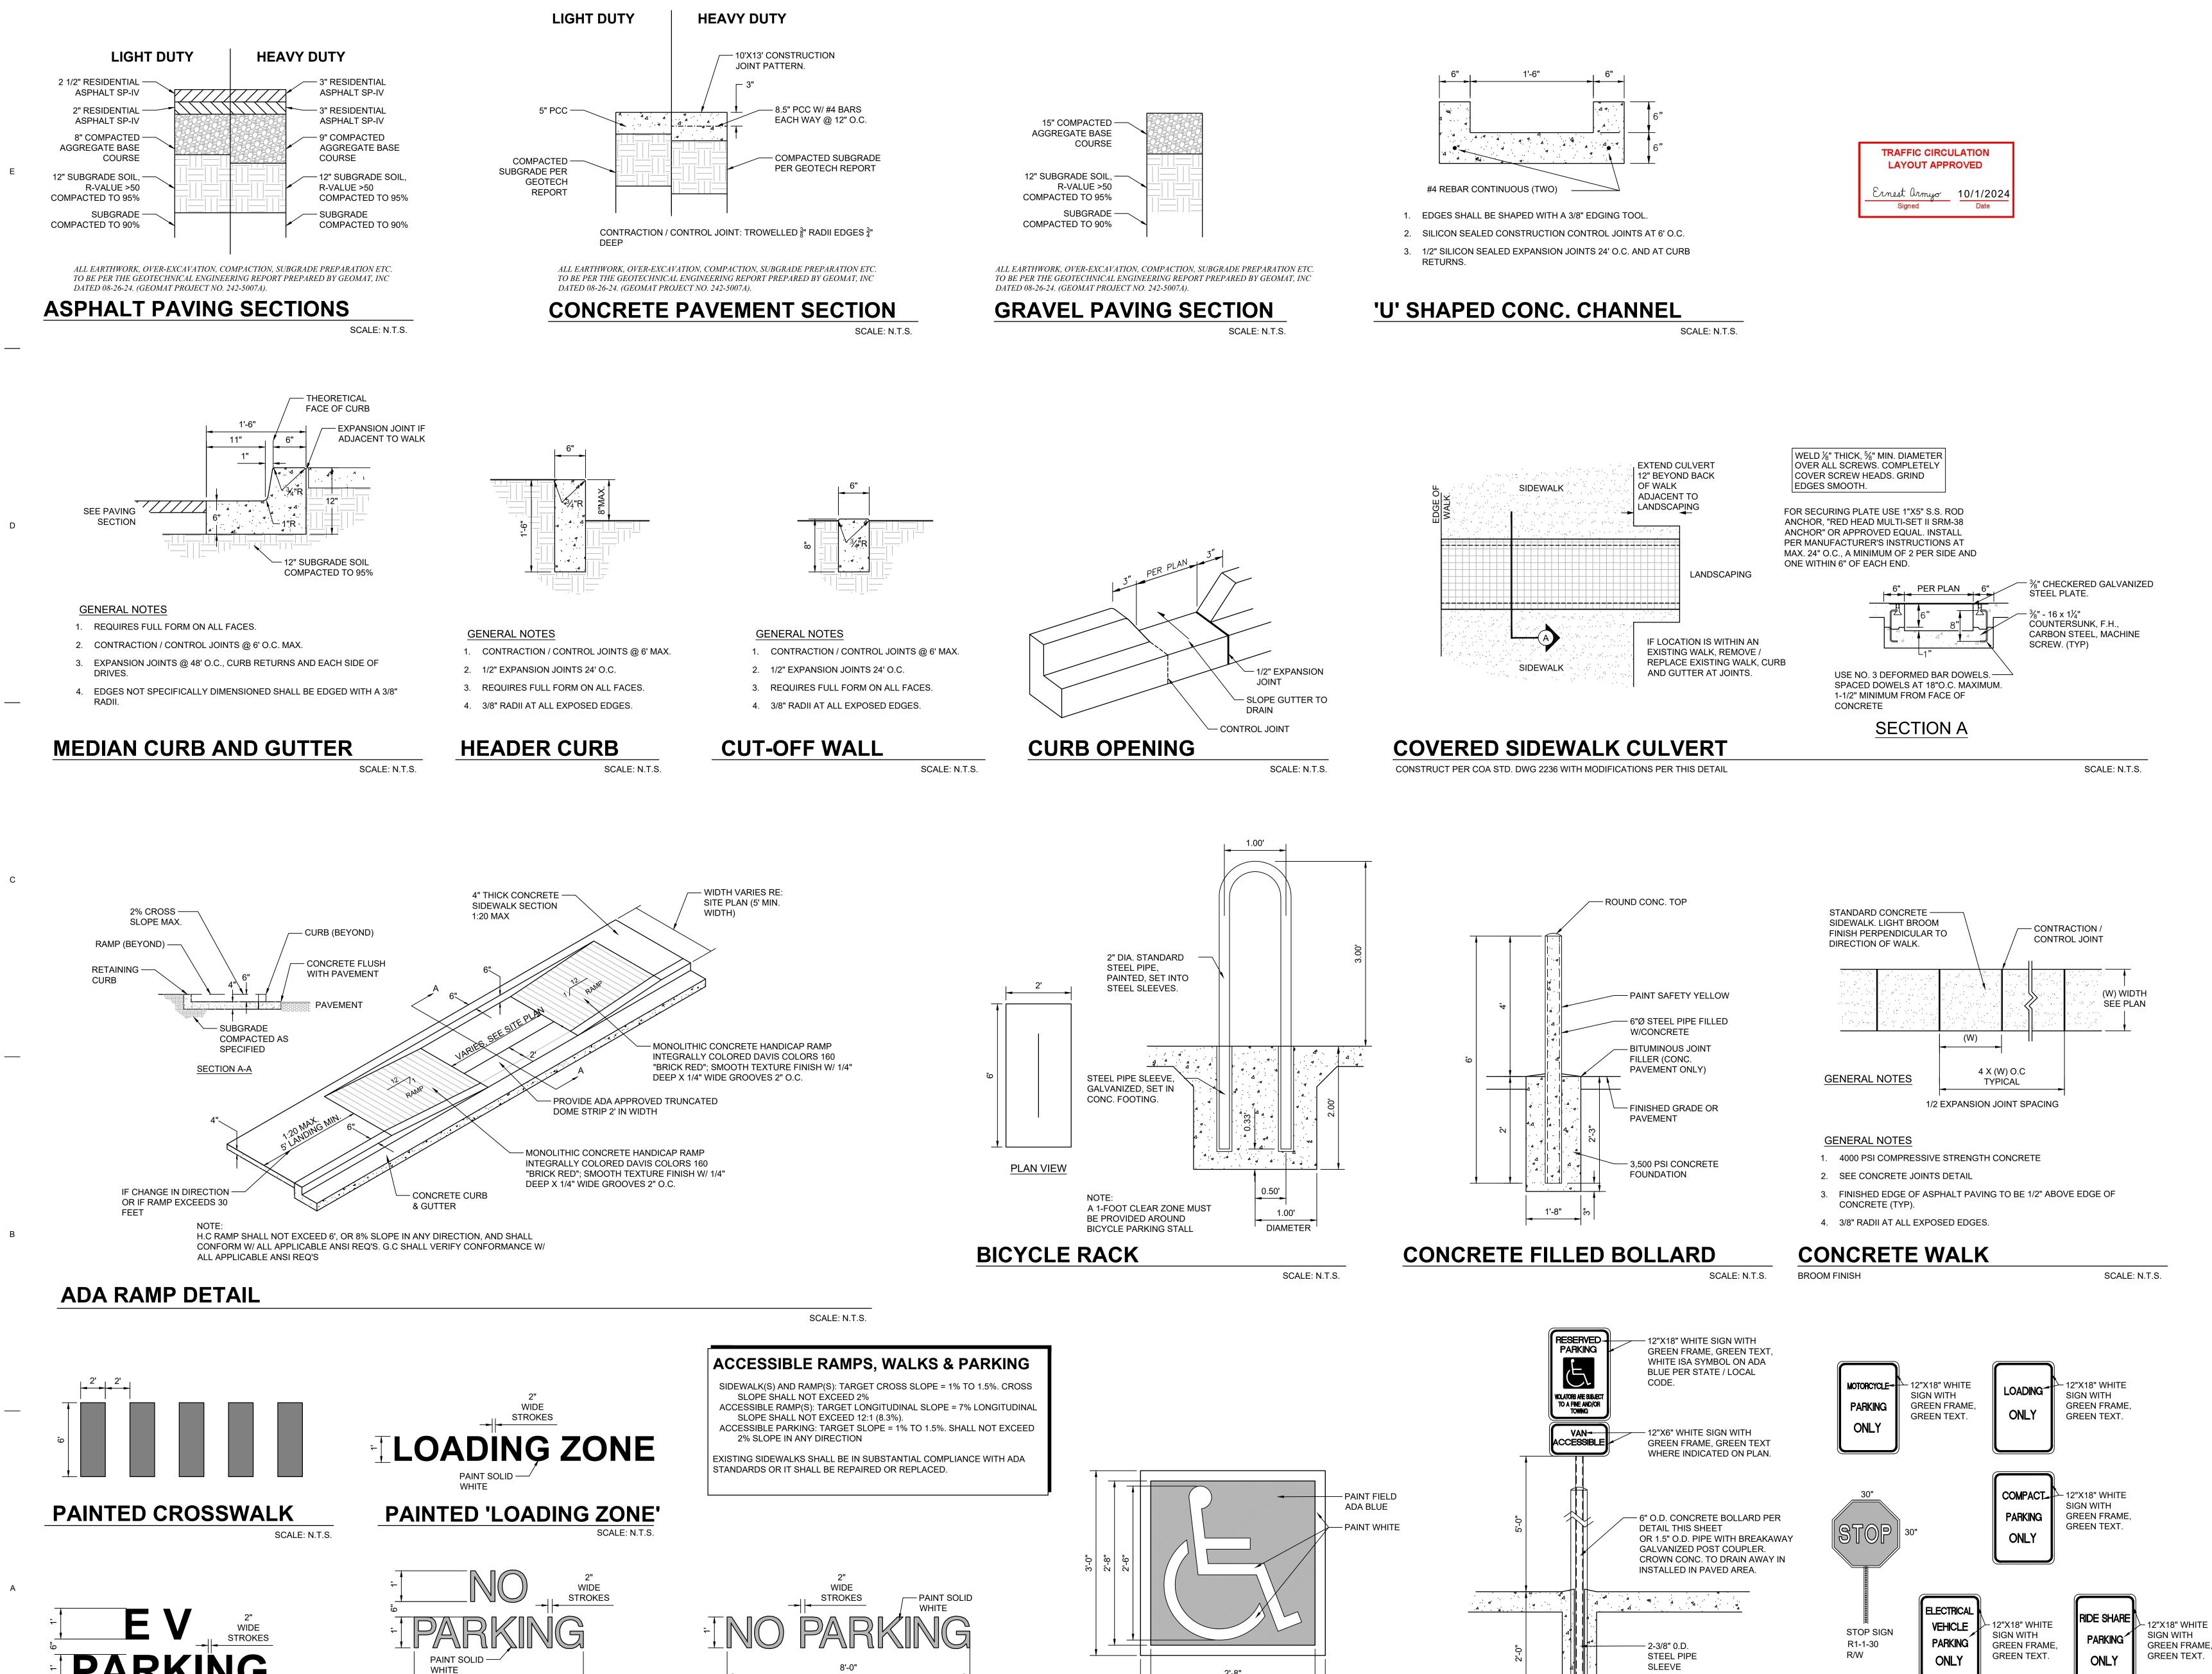



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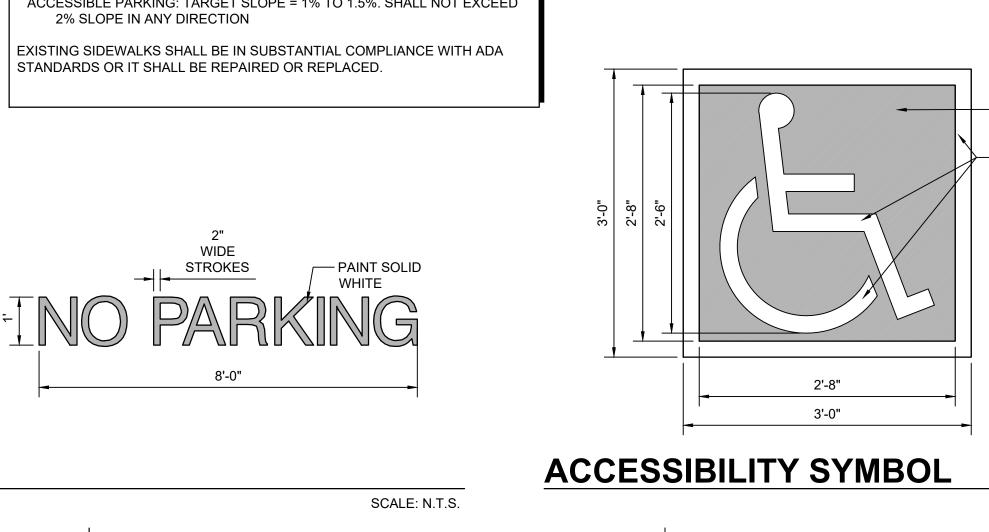




6'-0"

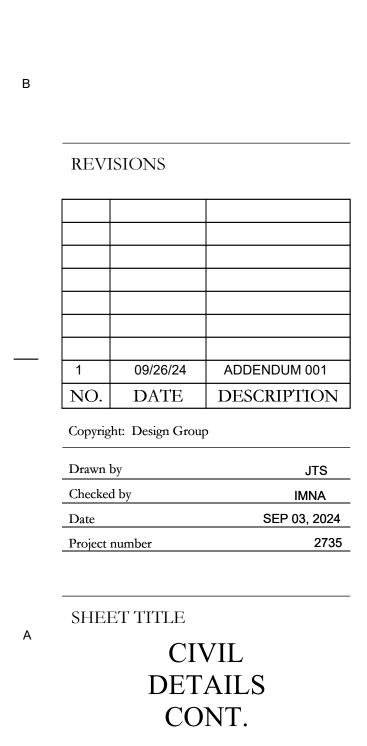PAINTED 'NO PARKING'

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SIGNAGE

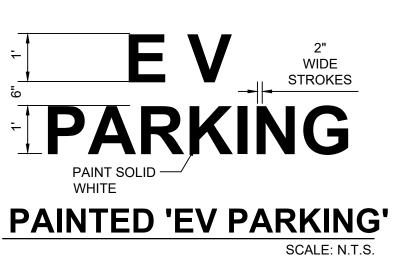SCALE: N.T.S.

– 8" X 2.0' CONCRETE

FOOTING

SCALE: N.T.S.




SHEET NUMBER





SHEET TITLE

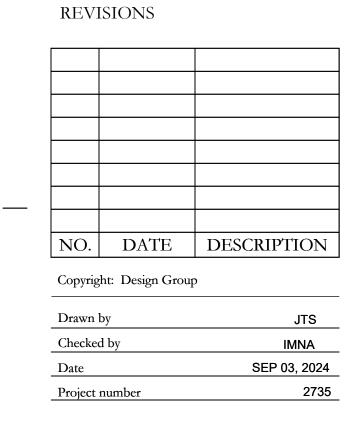

LIMITED PARTNERSHIP LLLP

SOMOS APARTMENTS

7200 CENTRAL AVE SE, ALBUQUERQUE, NEW MEXICO 87108

PROJECT NAME

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HARTMAN + MAJEWSKI DESIGN GROUP CONSULTANT Isaacson &