
CITY OF ALBUQUERQUE

Planning Department Alan Varela, Director

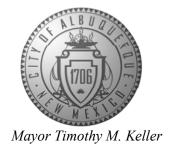

December 22, 2022

Scott McGee, P.E. SMM PE LLC 790 Tramway Lane NE #10C Albuquerque, NM 87122

RE: BOB'S BURGERS III

305 Eubank Blvd. NE, Albuquerque, NM 87123

Grading and Drainage Plan

Engineer's Stamp Date: 10/10/2022

Hydrology File: K20D049

Dear Mr. McGee:

Based upon the information provided in your submittal received 10/24/2022, the Grading & Drainage Plan is approved for Building Permit approval. Please attach a copy of this approved plan in the construction sets for Building Permit processing along with a copy of this letter.

PO Box 1293

PRIOR TO CERTIFICATE OF OCCUPANCY:

Albuquerque

Engineer's Certification, per the DPM Part 6-14 (F): *Engineer's Certification Checklist For Non-Subdivision* is required.

NM 87103

As a reminder, if the project total area of disturbance (including the staging area and any work within the adjacent Right-of-Way) is 1 acre or more, then an Erosion and Sediment Control (ESC) Plan and Owner's certified Notice of Intent (NOI) is required to be submitted to the Stormwater Quality Engineer (Doug Hughes, PE, jhughes@cabq.gov, 505-924-3420) 14 days prior to any earth disturbance.

www.cabq.gov

If you have any questions, please contact me at 924-3695 or tchen@cabq.gov.

Sincerely,

Tiequan Chen, P.E.

Principal Engineer, Hydrology

Planning Department, Development Review Services

File: K20D049



City of Albuquerque


Planning Department


Development & Building Services Division

DRAINAGE AND TRANSPORTATION INFORMATION SHEET (REV 10/2018)

Project Title:	Building	Permit #:	Hydrology File #:	
DRB#:	EPC#:		Work Order#:	
Legal Description:				
City Address:				
Applicant:			Contact	
Address:Phone#:				
Other Contact:				
Address:				_
		E-mail:		
TYPE OF DEVELOPMENT:	PLAT (# of lots)	RESIDENCE _	DRB SITE	ADMIN SITE
IS THIS A RESUBMITTAL? Y				
DEPARTMENT: TRAFFIC/TRANSPORTATION		HYDROLOGY/DRAINAGE		
Check all that Apply:		TYPE OF APPROVAL/ACCEPTANCE SOUGHT:		
TYPE OF SUBMITTAL: ENGINEER/ARCHITECT CERTIFICATION PAD CERTIFICATION CONCEPTUAL G & D PLAN GRADING PLAN DRAINAGE MASTER PLAN DRAINAGE REPORT FLOODPLAIN DEVELOPMENT PERMIT APPLIC ELEVATION CERTIFICATE CLOMR/LOMR TRAFFIC CIRCULATION LAYOUT (TCL) TRAFFIC IMPACT STUDY (TIS) OTHER (SPECIFY) PRE-DESIGN MEETING?		BUILDING PERMIT APPROVAL CERTIFICATE OF OCCUPANCY PRELIMINARY PLAT APPROVAL SITE PLAN FOR SUB'D APPROVAL SITE PLAN FOR BLDG. PERMIT APPROVA FINAL PLAT APPROVAL SIA/ RELEASE OF FINANCIAL GUARANTE FOUNDATION PERMIT APPROVAL GRADING PERMIT APPROVAL SO-19 APPROVAL PAVING PERMIT APPROVAL GRADING/ PAD CERTIFICATION WORK ORDER APPROVAL CLOMR/LOMR FLOODPLAIN DEVELOPMENT PERMIT OTHER (SPECIFY)		
DATE SUBMITTED:	By:			

FEE PAID:___

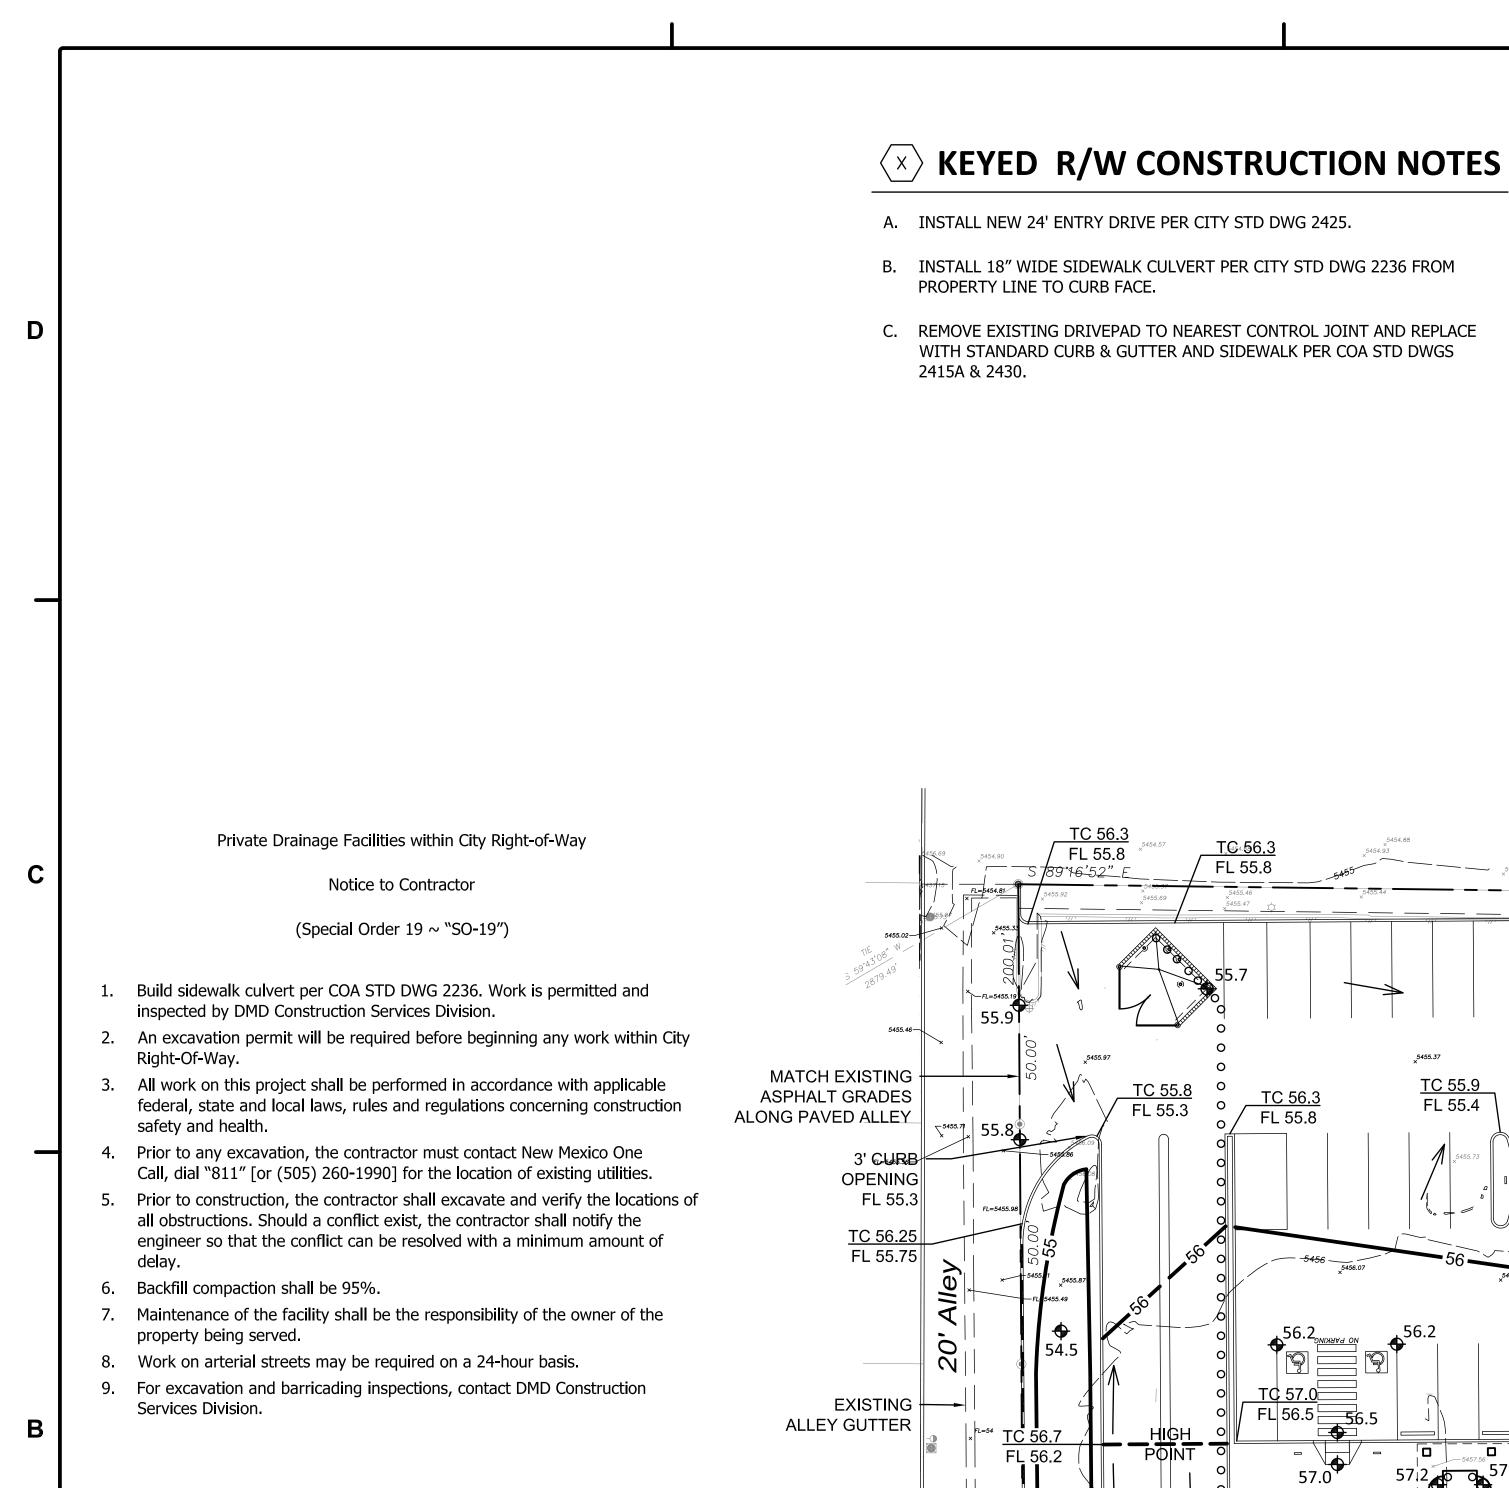

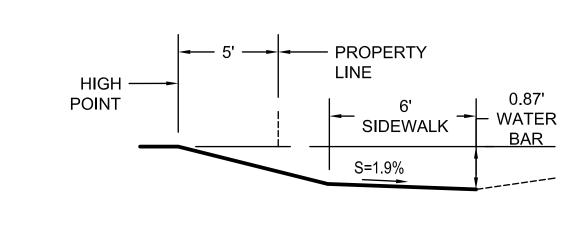

ENTRY DRIVE SECTION SCALE: NTS

SWQ POND(N)

BTM EL 54.0 TOP EL 55.0

V = 360CF

FL 55:00 9

FL 55.12

TC 55.5 FL 55.0

TC 56.1

NEW BUILDING FF = 5457.2

FL 56.7

FL 56.2

Chico Road, N.E.

57.2

*"*FL 56.6

TC 56.6 FL 56.1

//TC 56.9 FL 56.4

V = (60)(6)(1.0)

<u>3' CURB OPÉNING</u>

TC 55.3 / F/L 54.8

HYDROLOGY SECTION

APPROVED

12/22/2022

K20D049

GENERAL DRAINAGE NOTE: SIDE SLOPES NEED TO BE STABILIZED

WITH NATIVE GRASS SEED (PER CITY SPEC 1012) WITH 3" DEPTH

AGGREGATE MULCH OR EQUAL (MUST SATISFY THE "FINAL

STABILIZATION" CGP 2.2.14.b.).

VICINITY MAP

K-20-Z

LEGEND

EXISTING CONTOURS NEW CONTOUR FF = 5457.2 PROPOSED BUILDING FINISH FLOOR ELEV **NEW SPOT ELEVATION NEW CONSTRUCTION ROOF DRAIN** TOP OF CURB 000000 DRAINAGE BASIN BOUNDARY

DRAINAGE ANALYSIS

Lots, 21, 22, and 24-A, Block 24 Buena Ventura

AREA: 0.65 acres (28,306 SF)

SURVEYOR: Precision Surveys, Inc. dated January, 2022

FLOOD HAZARD: From FIRM Panel 35001C0358H (8/16/12), this site is identified as being within Zone 'X'; areas of 0.2% annual chance flood, areas of 1% annual chance flood depth of < 1' or with drainage areas protected by levees from 1% annual chance flood.

at the NW corner of Eubank Blvd and Chico Road NE. The commercial area includes an existing building and an asphalt-paved parking lot.


OFFSITE FLOWS: No offsite flow enters the site.


PROPOSED IMPROVEMENTS: The proposed improvements include a 2,055 SF

DRAINAGE APPROACH: The proposed drainage plan will direct the building rooftop flow toward a depressed landscape area at the SW corner of the site. Runoff from the north half of the site will flow to the NE corner of the site.

HYDROLOGY: Existing site land treatment: 28% C and 72% D Precipitation Zone 3 --- Q= (.18)(3.17)+(.47)(4.49)=2.7 CFS

Since the impervious portion of the runoff is discharged to the depressed

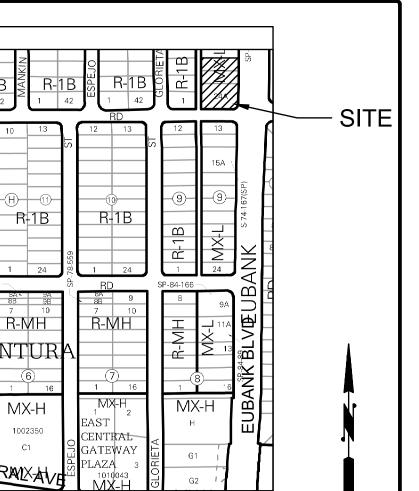

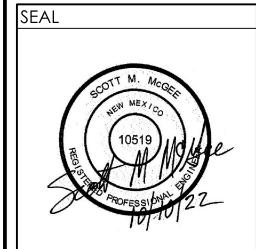

buffalodesign

architects

10899 montgomery blvd ne suite a

albuquerque, nm 87111

PROJECT

BURGER BS RIVE 30 ALB $\mathbf{\Omega}$

CLIENT PROJ #:

ARCHT PROJ #:

CHECKED BY:

SHEET TITLE

GRADING &

DRAINAGE PLAN

September 9, 2022

DRAWN BY:

BENCHMARK: AGRS monument '5-K20', ELEV= 5429.995 (NAVD 1988)

EXISTING CONDITIONS: The site is an existing commercial development located

building with adjacent double drive through lane, paved parking, and xeric landscaping.

The developed flow is based on 17% C and 83% D (23,442 SF) Developed Q = (.11)(3.17) + (.64)(4.49) = 3.2 CFSSouth SWQ V=(10,902)(.34/12)= 309 CF (420 CF Provided) North SWQ V=(12,540)(.34/12)= 355 CF (360 CF Provided)

landscape areas, the effective site runoff will be mitigated by the onsite retention.

SWQ POND(S)

V = (100)(12)(0.5)(0.7)

3' CURB OPENING -

FL <u>55.2</u>

BTM EL 54.5 TOP EL 55.2

V = 420CF

3' CURB OPĒNINO

TC 56.2 / FL 55.7

GRADING & DRAINAGE PLAN

Δ=89°39'33" CH=S 45°10'45" W

~ EXISTING DRØP

FL=5456.46 FL=5456.34

2' CURB OPENING

TC 56.6 / FL*5*6.1