3. EXCAVATION IS UNCLASSIFIED AND INCLUDES EXCAVATION TO SUBGRADE ELEVATIONS INDICATED BY GEOTECHNICAL REPORT, REGARDLESS OF CHARACTER OF MATERIALS ENCOUNTERED.

4. PAD AND ROUGH GRADING ELEVATIONS SHALL CONFORM TO ELEVATIONS SHOWN ON PLANS.

5. FINAL GRADES SHOWN REPRESENT TOP OF FINISH MATERIAL (I.E. TOP OF CONCRETE, TOP OF PAVEMENT MATERIAL, TOP OF LANDSCAPING MATERIAL, ETC.). CONTRACTOR SHALL GRADE, COMPACT SUBGRADE AND DETERMINE EARTHWORK ESTIMATES BASED ON ELEVATIONS SHOWN MINUS MATERIAL THICKNESSES.

6. MAXIMUM SLOPES SHALL BE 3:1. MINIMUM SLOPES SHALL BE 1% UNLESS OTHERWISE NOTED.

7. FIVE (5) WORKING DAYS PRIOR TO ANY EXCAVATION, CONTRACTOR MUST CONTACT NEW MEXICO ONE CALL SYSTEM, 260-1990, FOR LOCATION OF EXISTING UTILITIES.


8. IF ANY UTILITY LINES, PIPELINES, OR UNDERGROUND UTILITY LINES ARE SHOWN ON THESE DRAWINGS, THEY ARE SHOWN IN AN APPROXIMATE MANNER ONLY, AND SUCH LINES MAY EXIST WHERE NONE ARE SHOWN. IF ANY SUCH EXISTING LINES ARE SHOWN, THE LOCATION IS BASED UPON INFORMATION PROVIDED BY THE OWNER OF SAID UTILITY, AND THE INFORMATION MAY BE INCOMPLETE, OR MAY BE OBSOLETE BY THE TIME CONSTRUCTION COMMENCES. THE ENGINEER HAS CONDUCTED ONLY PRELIMINARY INVESTIGATION OF THE LOCATION, DEPTH, SIZE OR TYPE OF EXISTING UTILITY LINES, PIPELINES, OR UNDERGROUND UTILITY LINES. THIS INVESTIGATIONS IS NOT CONCLUSIVE, AND MAY NOT BE COMPLETE, THEREFORE, MAKES NO REPRESENTATION PERTAINING THERETO, AND ASSUMES NO RESPONSIBILITY OR LIABILITY THEREFORE. THE CONTRACTOR SHALL INFORM ITSELF OF THE LOCATION OF ANY UTILITY LINE, PIPELINE, OR UNDERGROUND UTILITY LINE IN OR NEAR THE AREA OF THE WORK IN ADVANCE OF AND DURING EXCAVATION WORK. THE CONTRACTOR IS FULLY RESPONSIBLE FOR ANY AND ALL DAMAGE CAUSED BY ITS FAILURE TO LOCATE, IDENTIFY AND PRESERVE ANY AND ALL EXISTING UTILITIES, PIPELINES, AND UNDERGROUND UTILITY LINES. IN PLANNING AND CONDUCTING EXCAVATION, THE CONTRACTOR SHALL COMPLY WITH STATE STATUES, MUNICIPAL AND LOCAL ORDINANCES, RULES AND REGULATIONS, IF ANY, PERTAINING TO THE LOCATION OF THESE LINES AND FACILITIES.

9. OWNER WILL PROVIDE SOIL TESTING AND INSPECTION SERVICES DURING EARTHWORK OPERATIONS. CONTRACTOR SHALL ALLOW TESTING LABS TO INSPECT AND APPROVE COMPACTED SUBGRADES AND FILL LAYERS BEFORE FURTHER CONSTRUCTION WORK IS DONE. SHOULD COMPACTION TESTS INDICATE INADEQUATE DENSITY, CONTRACTOR SHALL PROVIDE ADDITIONAL COMPACTION AND TESTING AT THE CONTRACTOR'S SOLE EXPENSE.

10. OWNER HAS ESTABLISHED SUBDIVISION BOUNDARY CORNERS. CONTRACTOR SHALL PROVIDE ALL OTHER CONSTRUCTION STAKING INCLUDING TRACT CORNERS. CONTRACTOR SHALL LOCATE AND PRESERVE ALL BOUNDARY CORNERS AND REPLACE ANY LOST OR DISTURBED CORNERS AT THE CONTRACTOR'S SOLE EXPENSE.


11. IT IS THE CONTRACTOR'S RESPONSIBILITY TO FIELD VERIFY EXISTING CONDITIONS PRIOR TO CONSTRUCTION. REPORT ALL DISCREPANCIES TO THE ENGINEER AND VERIFY THE ENGINEER'S INTENT BEFORE PROCEEDING.

12. ALL NEW PAVEMENT GRADES SHOWN AS 'MATCH' OR '±' REPRESENT TRANSITIONS TO EXISTING.
TRANSITIONS SHALL BE SMOOTH AND LEVEL. ANY NEW PAVING SURFACE HOLDING WATER (BIRDBATH)
SHALL BE REMOVED AND REPLACED AT THE CONTRACTOR'S SOLE EXPENSE.

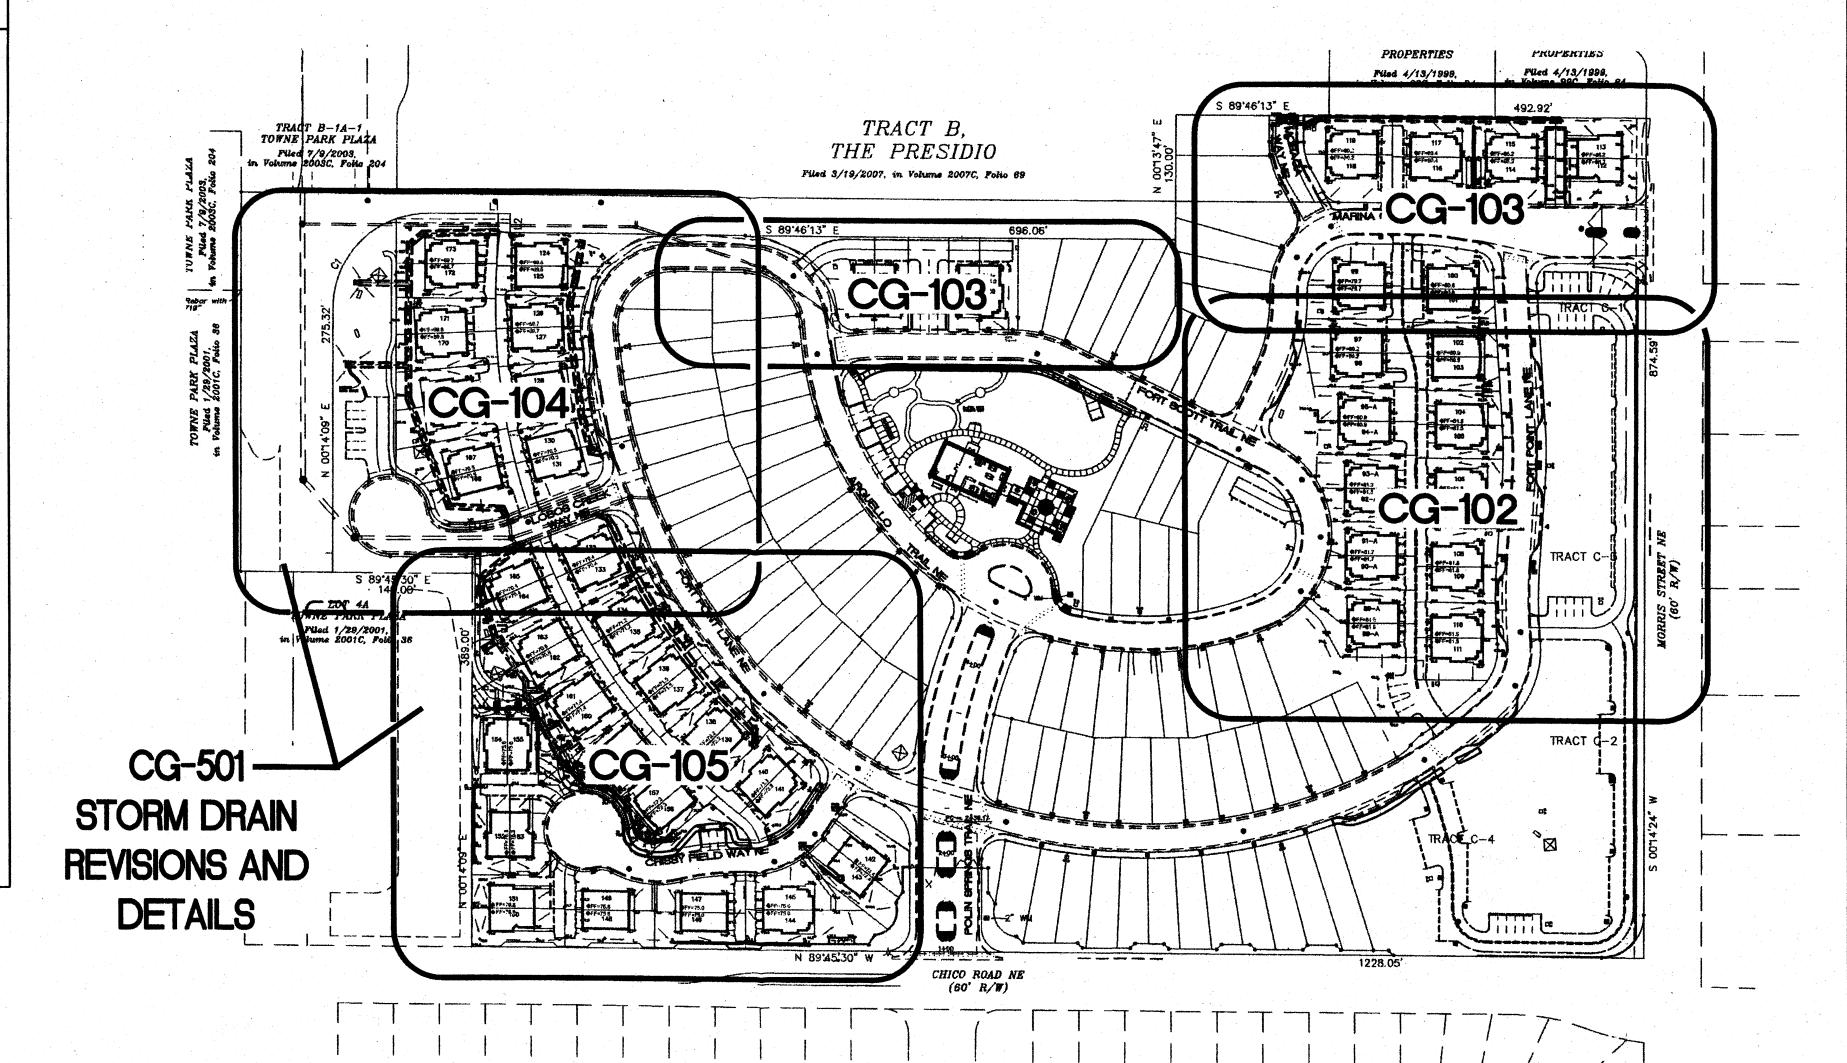

SHEET KEY

1"=100'

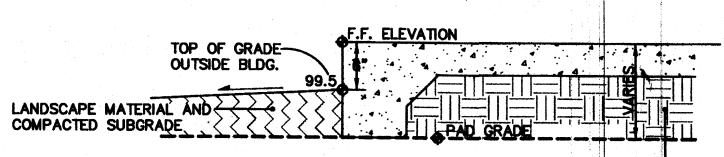

TYPICAL SECTION AT BUILDING


COMPACTED FILL PER THE GEOTECHNICAL REPORT AND CITY OF ALBUQUERQUE SPECIFICATIONS.

# **⊗ TYPICAL LOT GRADING PLAN**

# **KEYED NOTES**

- 1. EXISTING ASPHALT ACCESS DRIVE.
- 2. EXISTING CONCRETE RIBBON CURB.
- LOT NUMBER.
   BUILDING OUTLINE REPRESENTS FURTHEST POSSIBLE BUILDING EXTENTS, HEAVY
  DASHED LINE REPRESENTS FURTHEST POSSIBLE COVERED PORCH EXTENTS. ACTUAL
  UNITS AND PORCHES WILL VARY. FINE GRADE EACH UNIT TO ESTABLISH POSITIVE
  DRAINAGE AWAY.
- 5. CONSTRUCT NEW CONCRETE DRIVEPAD BETWEEN BACK OF CONCRETE RIBBON CURB AND NEW BUILDING AT ELEVATIONS SHOWN. PROVIDE SMOOTH TRANSITION TO
- 6. ELEVATION AT GARAGE DOOR IS SET 6" BELOW FINISH FLOOR ELEVATION (FF) TO ACCOMMODATE 2" SLOPE IN GARAGE FLOOR AND 4" WHEEL STOP. SEE ARCHITECTURAL FOR INTERIOR GRADE TRANSITIONS.
- 6. ELEVATION AT PEDESTRIAN ENTRY DOORS ARE TO BE 4" BELOW FF ELEVATION TO ACCOMMODATE 4" STOOP. COVERED PORCH CONCRETE TO SLOPE AT 1% MIN. TO DRAIN. SEE ARCHITECTURAL.
- 7. CONSTRUCT CONCRETE WALKS TO ACCESS UNITS. WALKS TO BE 5' WIDE FOR MULTI-UNIT ACCESS AS SHOWN ON GRADING AND DRAINAGE PLANS (WITH STAIRS WHERE REQUIRED) AND 3' WIDE FOR INDIVIDUAL UNIT WALKS (NOT SHOWN ON GRADING AND DRAINAGE PLANS). LOCATION OF INDIVIDUAL UNIT WALKS WILL VARY DEPENDING ON WHICH UNIT TYPE IS CHOSEN FOR CONSTRUCTION. MAX. SLOPE = 5%. PROVIDE STEPS AS REQUIRED (ESTIMATED NO. OF RISERS FROM PUBLIC WALK TO COVERED PORCH NOTED AS 

  WITHIN COVERED PORCH AREA).
- \* PROVIDE 2% CROSS-SLOPE TO DRAIN WALKS TO LANDSCAPING.
- \* TOP OF WALK ELEVATION AT PORCH TRANSITION TO BE FLUSH.
- \* SLOPE WALK AWAY FROM PORCH TRANSITION AT 2% FOR 5' MIN.
- \* WHERE WALKS CROSS DRAINAGE PATHS, DIP WALK OR INSTALL SIDEWALK TRENCH DRAIN TO PASS FLOW.
- 8. 1% MINIMUM SLOPE DRAINAGE SWALE SHALL BE ESTABLISHED AS PART OF FINAL GRADING OF EACH INDIVIDUAL UNIT AND BE MAINTAINED BY HOME OWNER (TYPICAL). AS SIDE YARD WALLS ARE CONSTRUCTED, CONTRACTOR SHALL PROVIDE 1 TURNED BLOCK O.E. AT ALL FLOWLINE LOW POINTS (PASSING FLOW INTO AND OUT OF SIDE YARD) TO PASS FLOW WITHIN LOT BOUNDARY. TYPICAL.

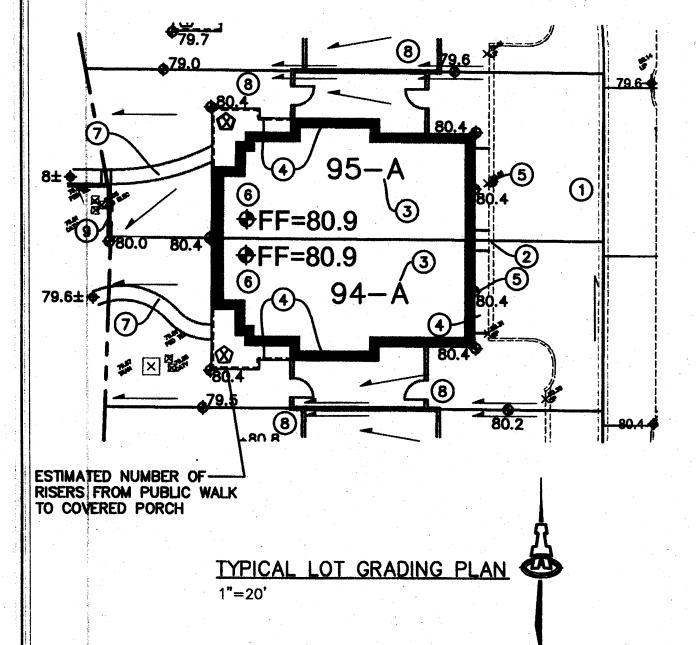



1"=20'

#### DRAINAGE CERTIFICATION

I, Fred C. Arfman, NMPE 7322, of the firm Isaacson & Arfman, P.A., hereby certify that this project has been graded and will drain in substantial compliance with and in accordance with the design intent of the approved plan dated 08/18/2010. The record information edited onto the original design document has been obtained by Russ P. Hugg, NMPS 9750, of the firm Surv-Tek, inc. I further certify that I have personally visited the project site on 10/18/2011 and have determined by visual inspection that the survey data provided is representative of actual site conditions and is true and correct to the best of my knowledge and belief. This certification is submitted in support of a request for Permanent Certificate of Occupancy.

The record information presented hereon is not necessarily complete and intended only to verify substantial compliance of the grading and drainage aspects of this project. Those relying on this record document are advised to obtain independent verification of its accuracy before using it for any other purpose.

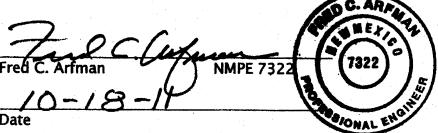

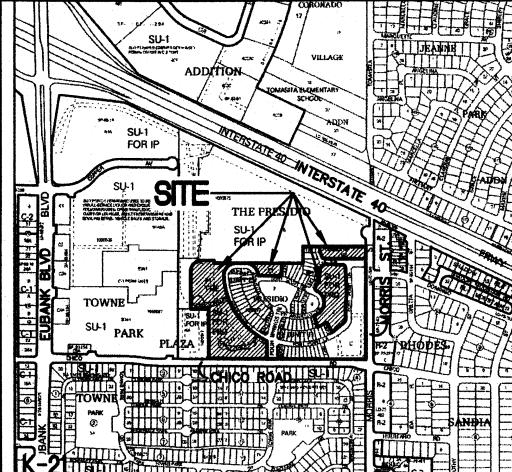

**VICINITY MAP K-21** 

LEGAL (EXISTING):

TRACT D, THE PRESIDIO, UNIT 1 (04-13-07, 2007C-81);
TRACT J-2A, THE PRESIDIO UNIT 1 (05-11-10, 2010C-57);
TRACTS E-1, H-1 AND R-1, THE PRESIDIO, UNIT 2.

TEMPORARY BENCHMARK: STREET CENTERLINE MONUMENTS HAVE BEEN PROVIDED AS PART OF PHASE I. SEE CG-102 THROUGH CG-105 FOR LOCATIONS AND ELEVATIONS TO NAVD 1988 DATUM.

#### PROJECT NOTES:

THE PAVING, CURB AND GUTTER (PRIVATE STREETS AND ALLEYS), WATER AND SANITARY SEWER WERE INSTALLED WITH THE PRESIDIO, UNIT 1 PLANS (CPN 797481) AND UNIT 2 PLANS (CPN 797482).

THIS PLAN SET SHOWS REVISED GRADES FOR EACH AREA TO BE REVISED.

DRAINAGE PATTERNS SHALL FOLLOW THE APPROVED PLAN FOR THE CONDOMINIUM UNITS, AND THE EXISTING CONDOMINIUM PADS SHALL BE RESHAPED TO ACCOMMODATE THE SINGLE-DETACHED LOTS.

CHANGE IN DISCHARGE RATE: IN GENERAL, EACH PREVIOUSLY PROPOSED CONDO UNIT (3045 SF FOOTPRINT) WILL BE REPLACED BY A MAXIMUM FOOTPRINT OF 2860 SF (DEPENDING ON WHICH MODEL IS CHOSEN) — A REDUCTION OF 115 SF LAND TREATMENT 'D' PER UNIT (MINIMUM). ADDITIONAL IMPERMEABLE FOR DRIVEPAD EXTENSIONS WILL ACCOUNT FOR SOME OF THE SAVINGS. THE CHANGE IN THE SITE DISCHARGE RATE DUE TO THIS PROPOSED CONVERSION WILL BE NEGLIGIBLE.

#### **LEGEND**

**♦**81.0 **♦**81.0± PROPOSED SPOT ELEVATION

EXISTING DESIGN SPOT ELEVATION
(ADJUSTED TO NEW DATUM)

FLOW ARROW

(NAVD 1988)

8.0<del>8-T</del>T

FINISH FLOOR ELEVATION


AS-BUILT SPOT ELEVATION

TURKKE MON 97

(NAVD 1988)

TBM: AS-BUILT SPOT ELEVATION AT CENTERLINE MONUMENT



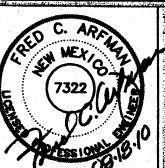

SAACSON & ARFMAN, P.A.

Lulting Engineering Associates

Incomplete N.E.


Lucrque, New Mexico 87108


This design, calculations, and concepts are owned by and remain the property of isaacson & Arfman, P.A. and no part thereof shall be utilized by any person, firm or corporation for any purpose whatsoever except with the written permission of isaacson & Arfman, P.A. (6)


# CENTEX HOMES PRESIDIO UNITS CONVERSION


#### **GRADING AND DRAINAGE 1 OF 5**


Date:	No.	Reddon		Delo	Job No.
JUNE 2010					1750
Drawn By:	1				00 101
BJB	$\vdash$				CG-101
Ckd By:	$\vdash$		•	-	
ANW					SH. OF

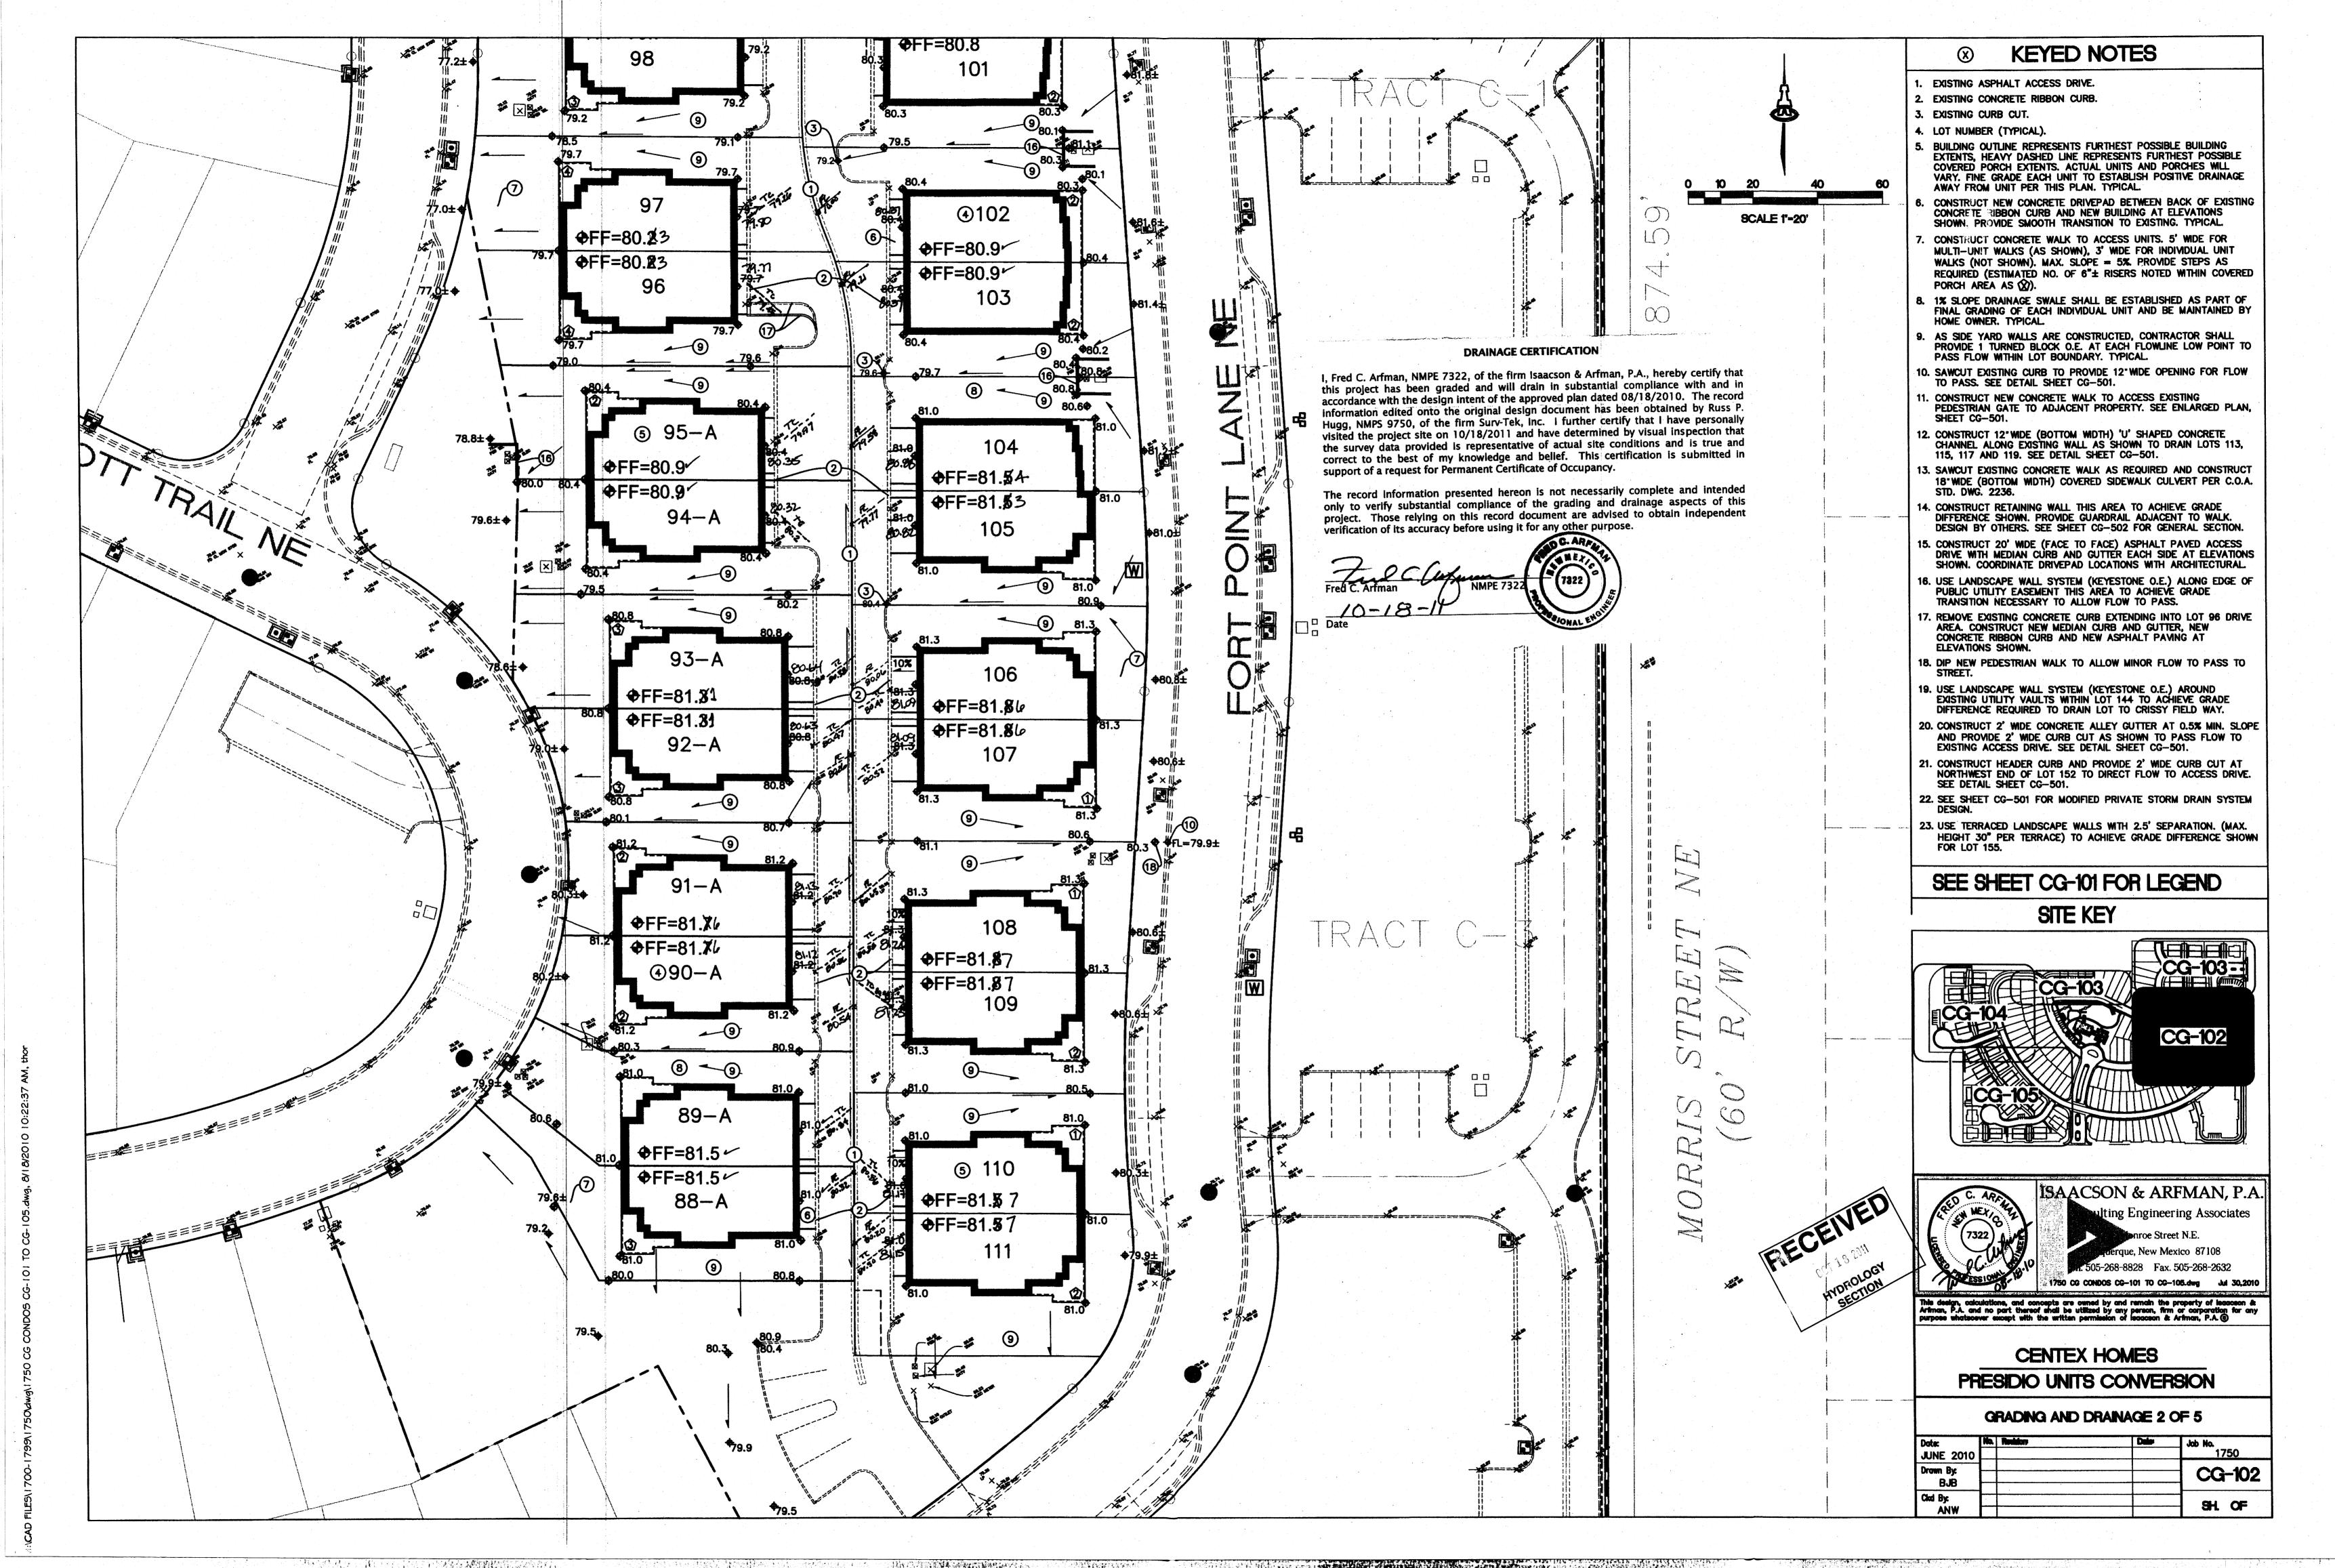

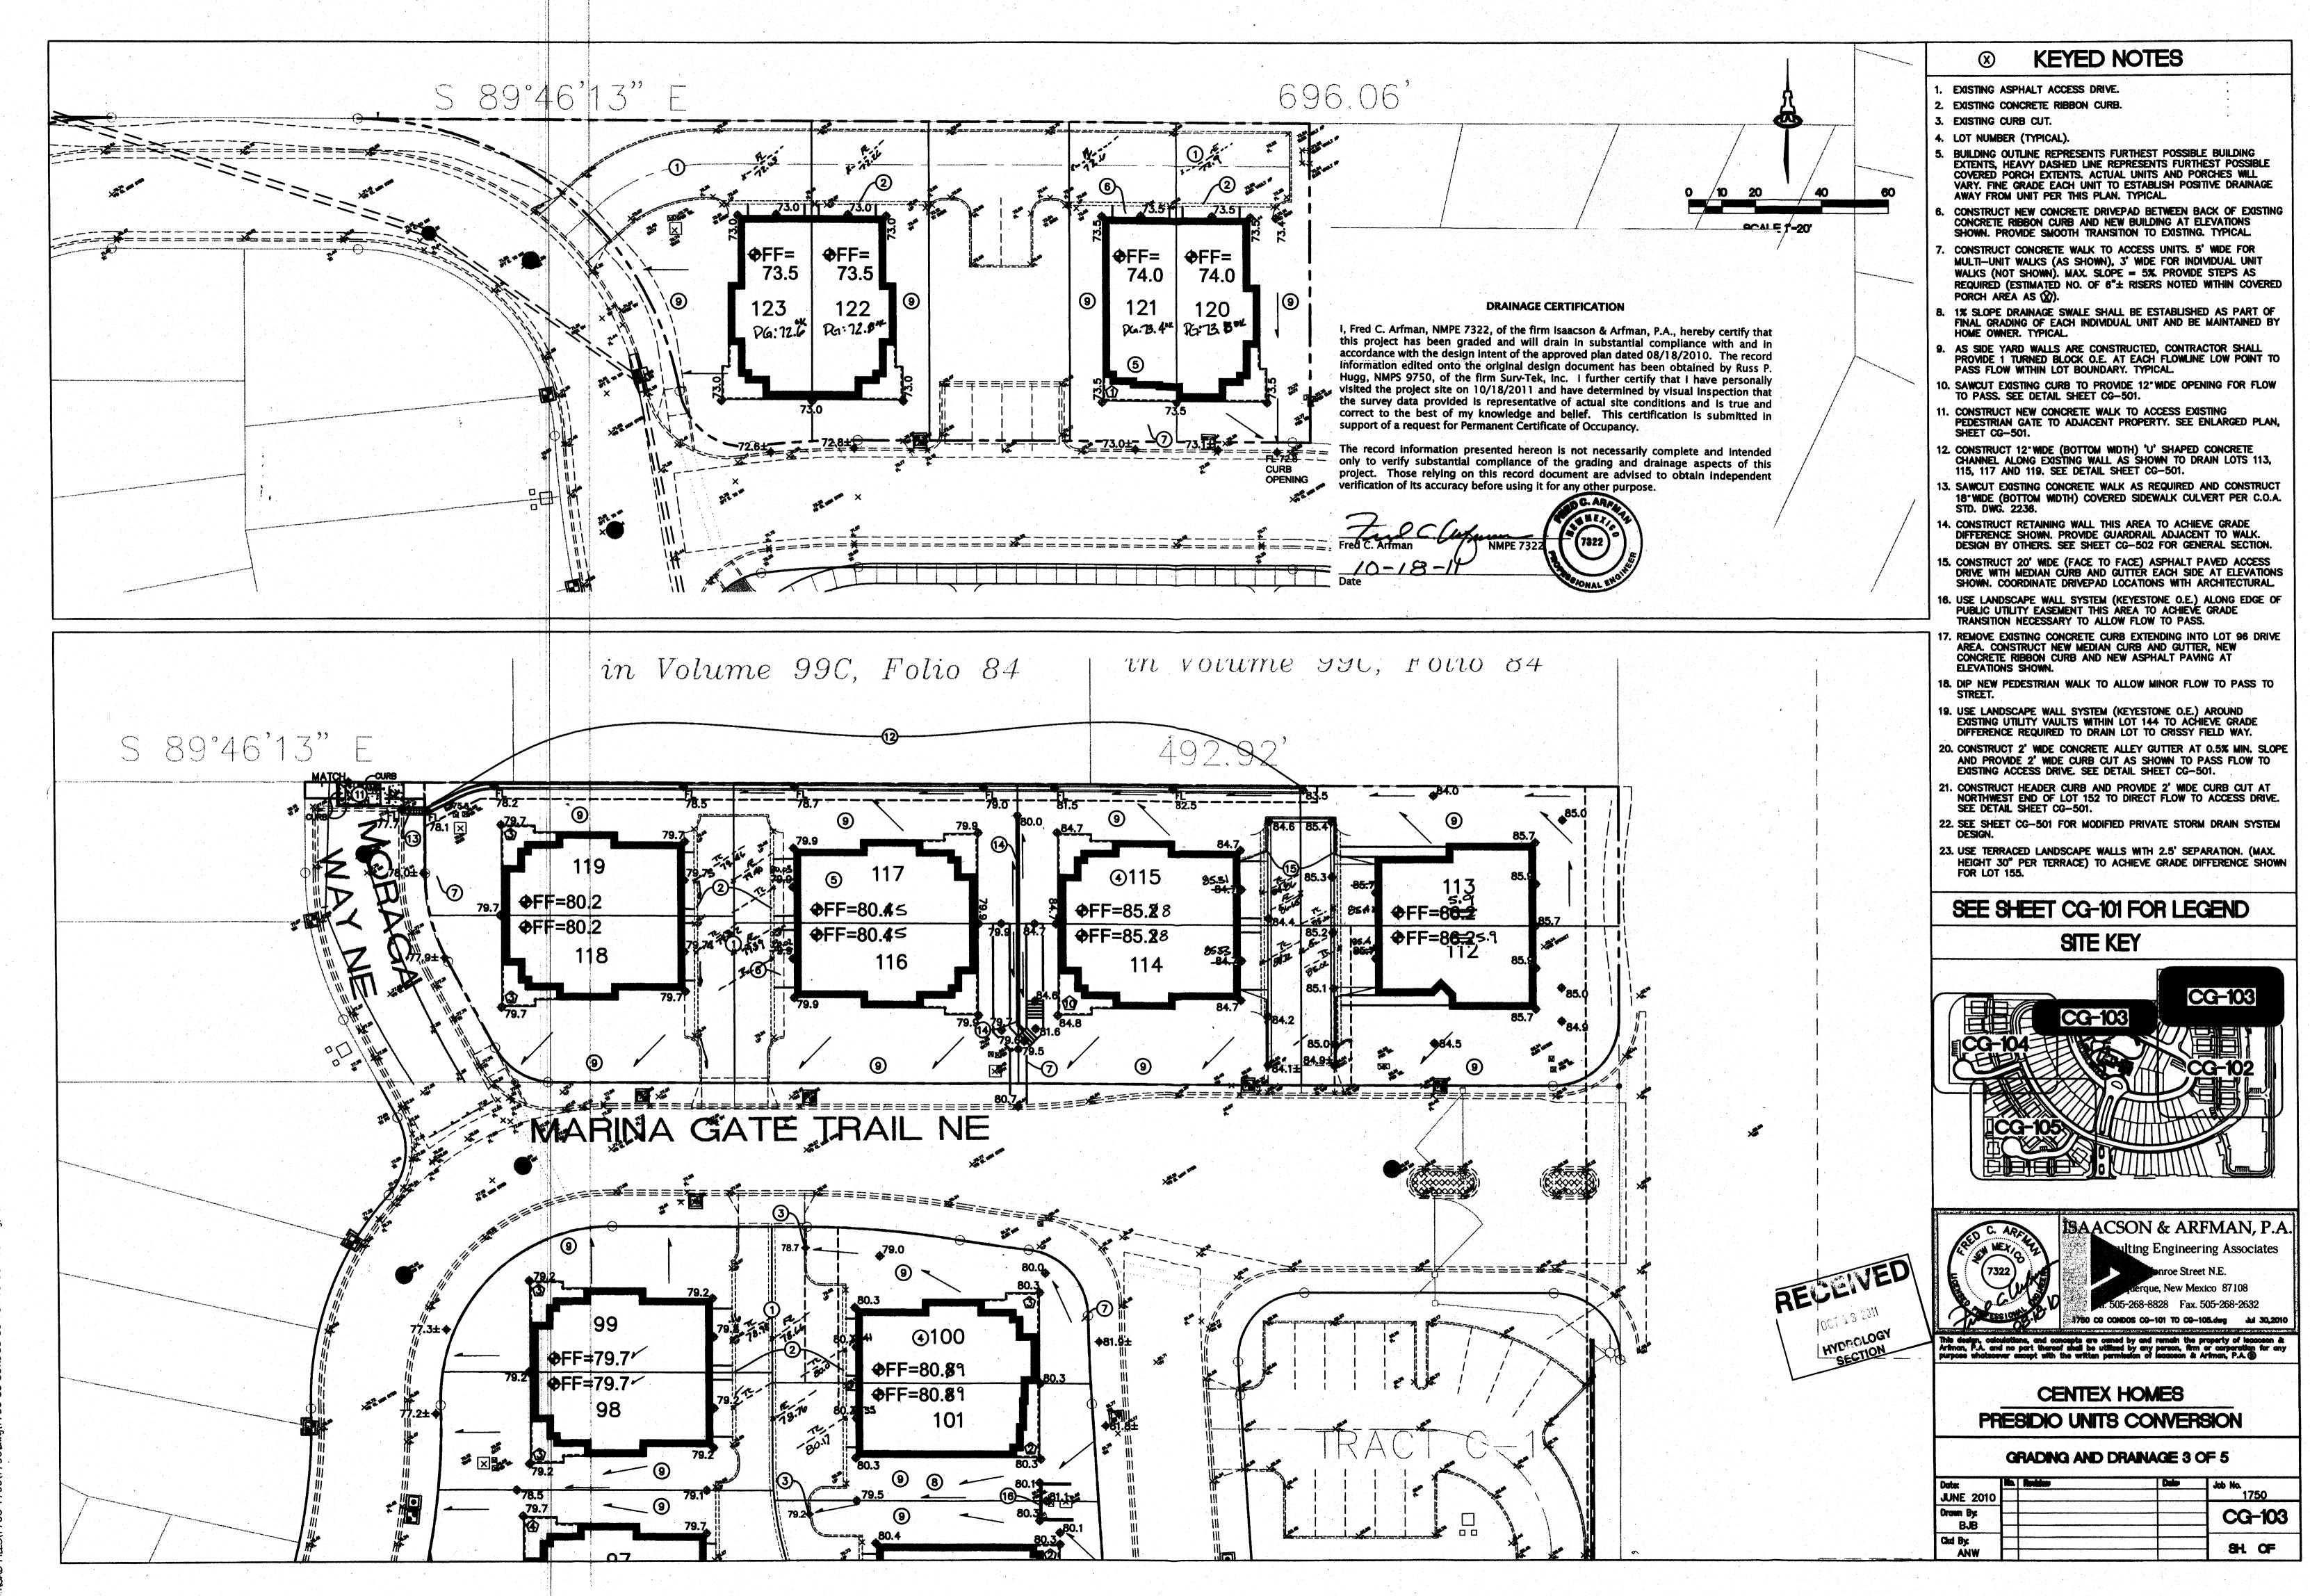

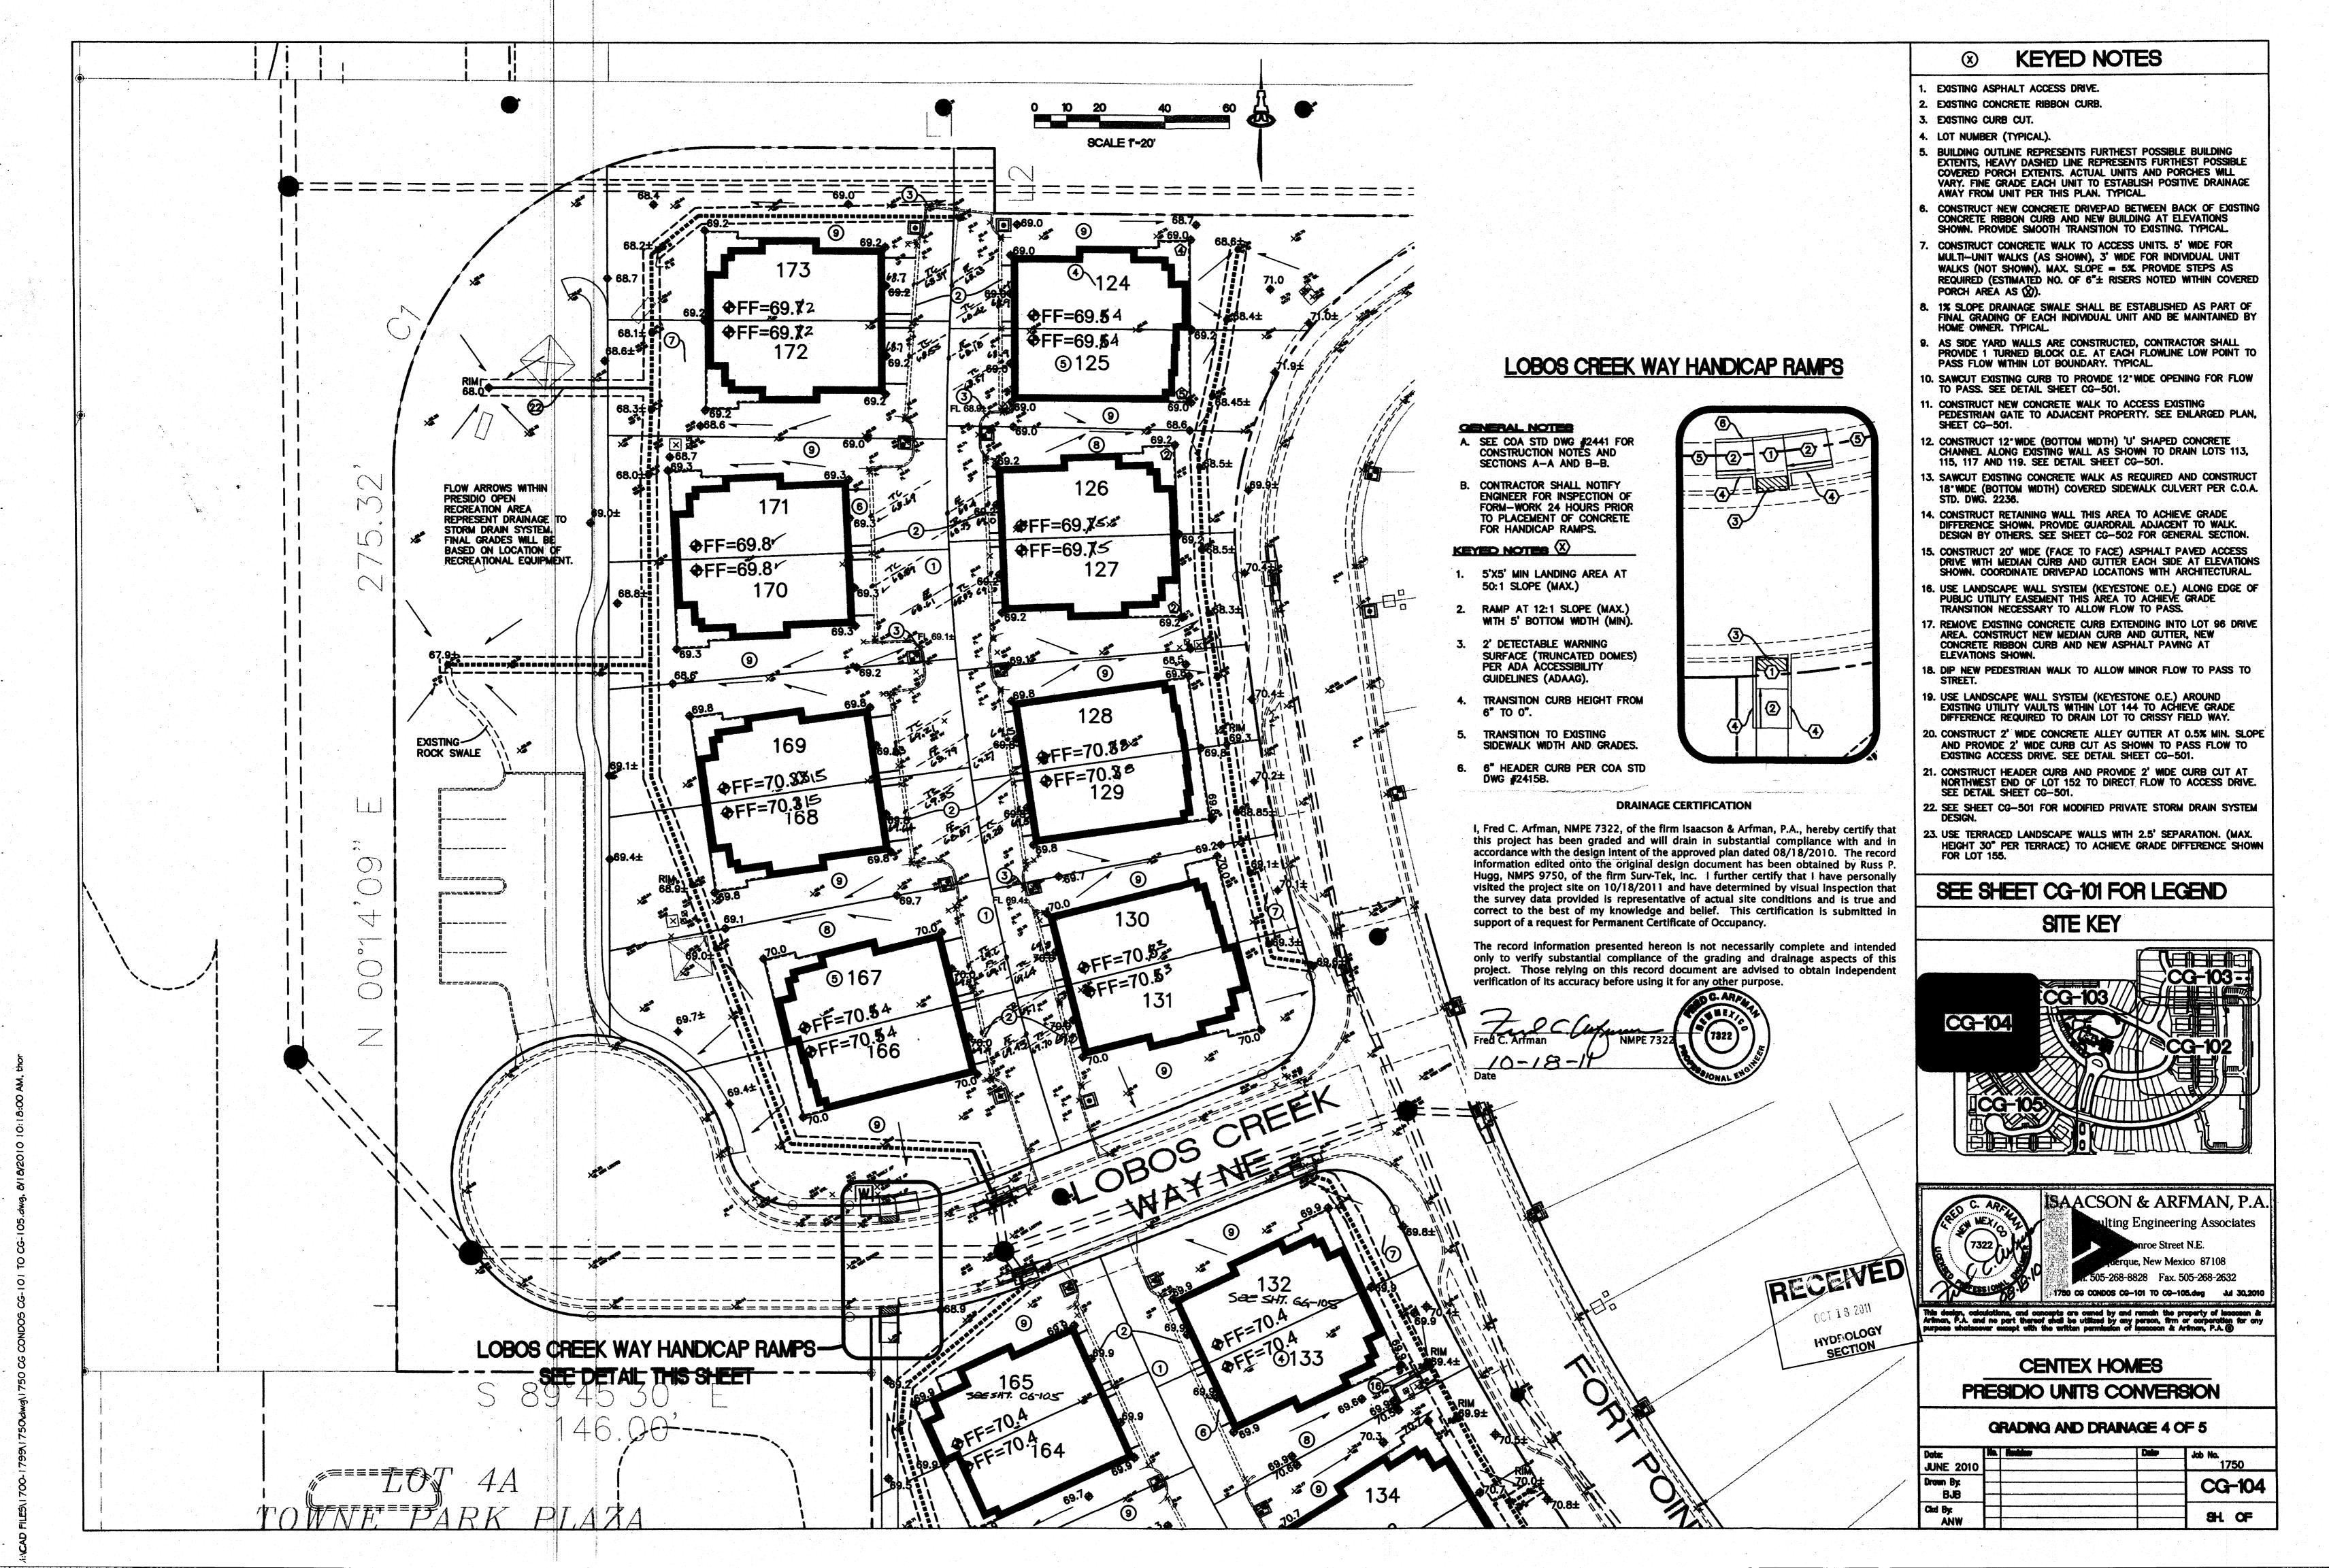

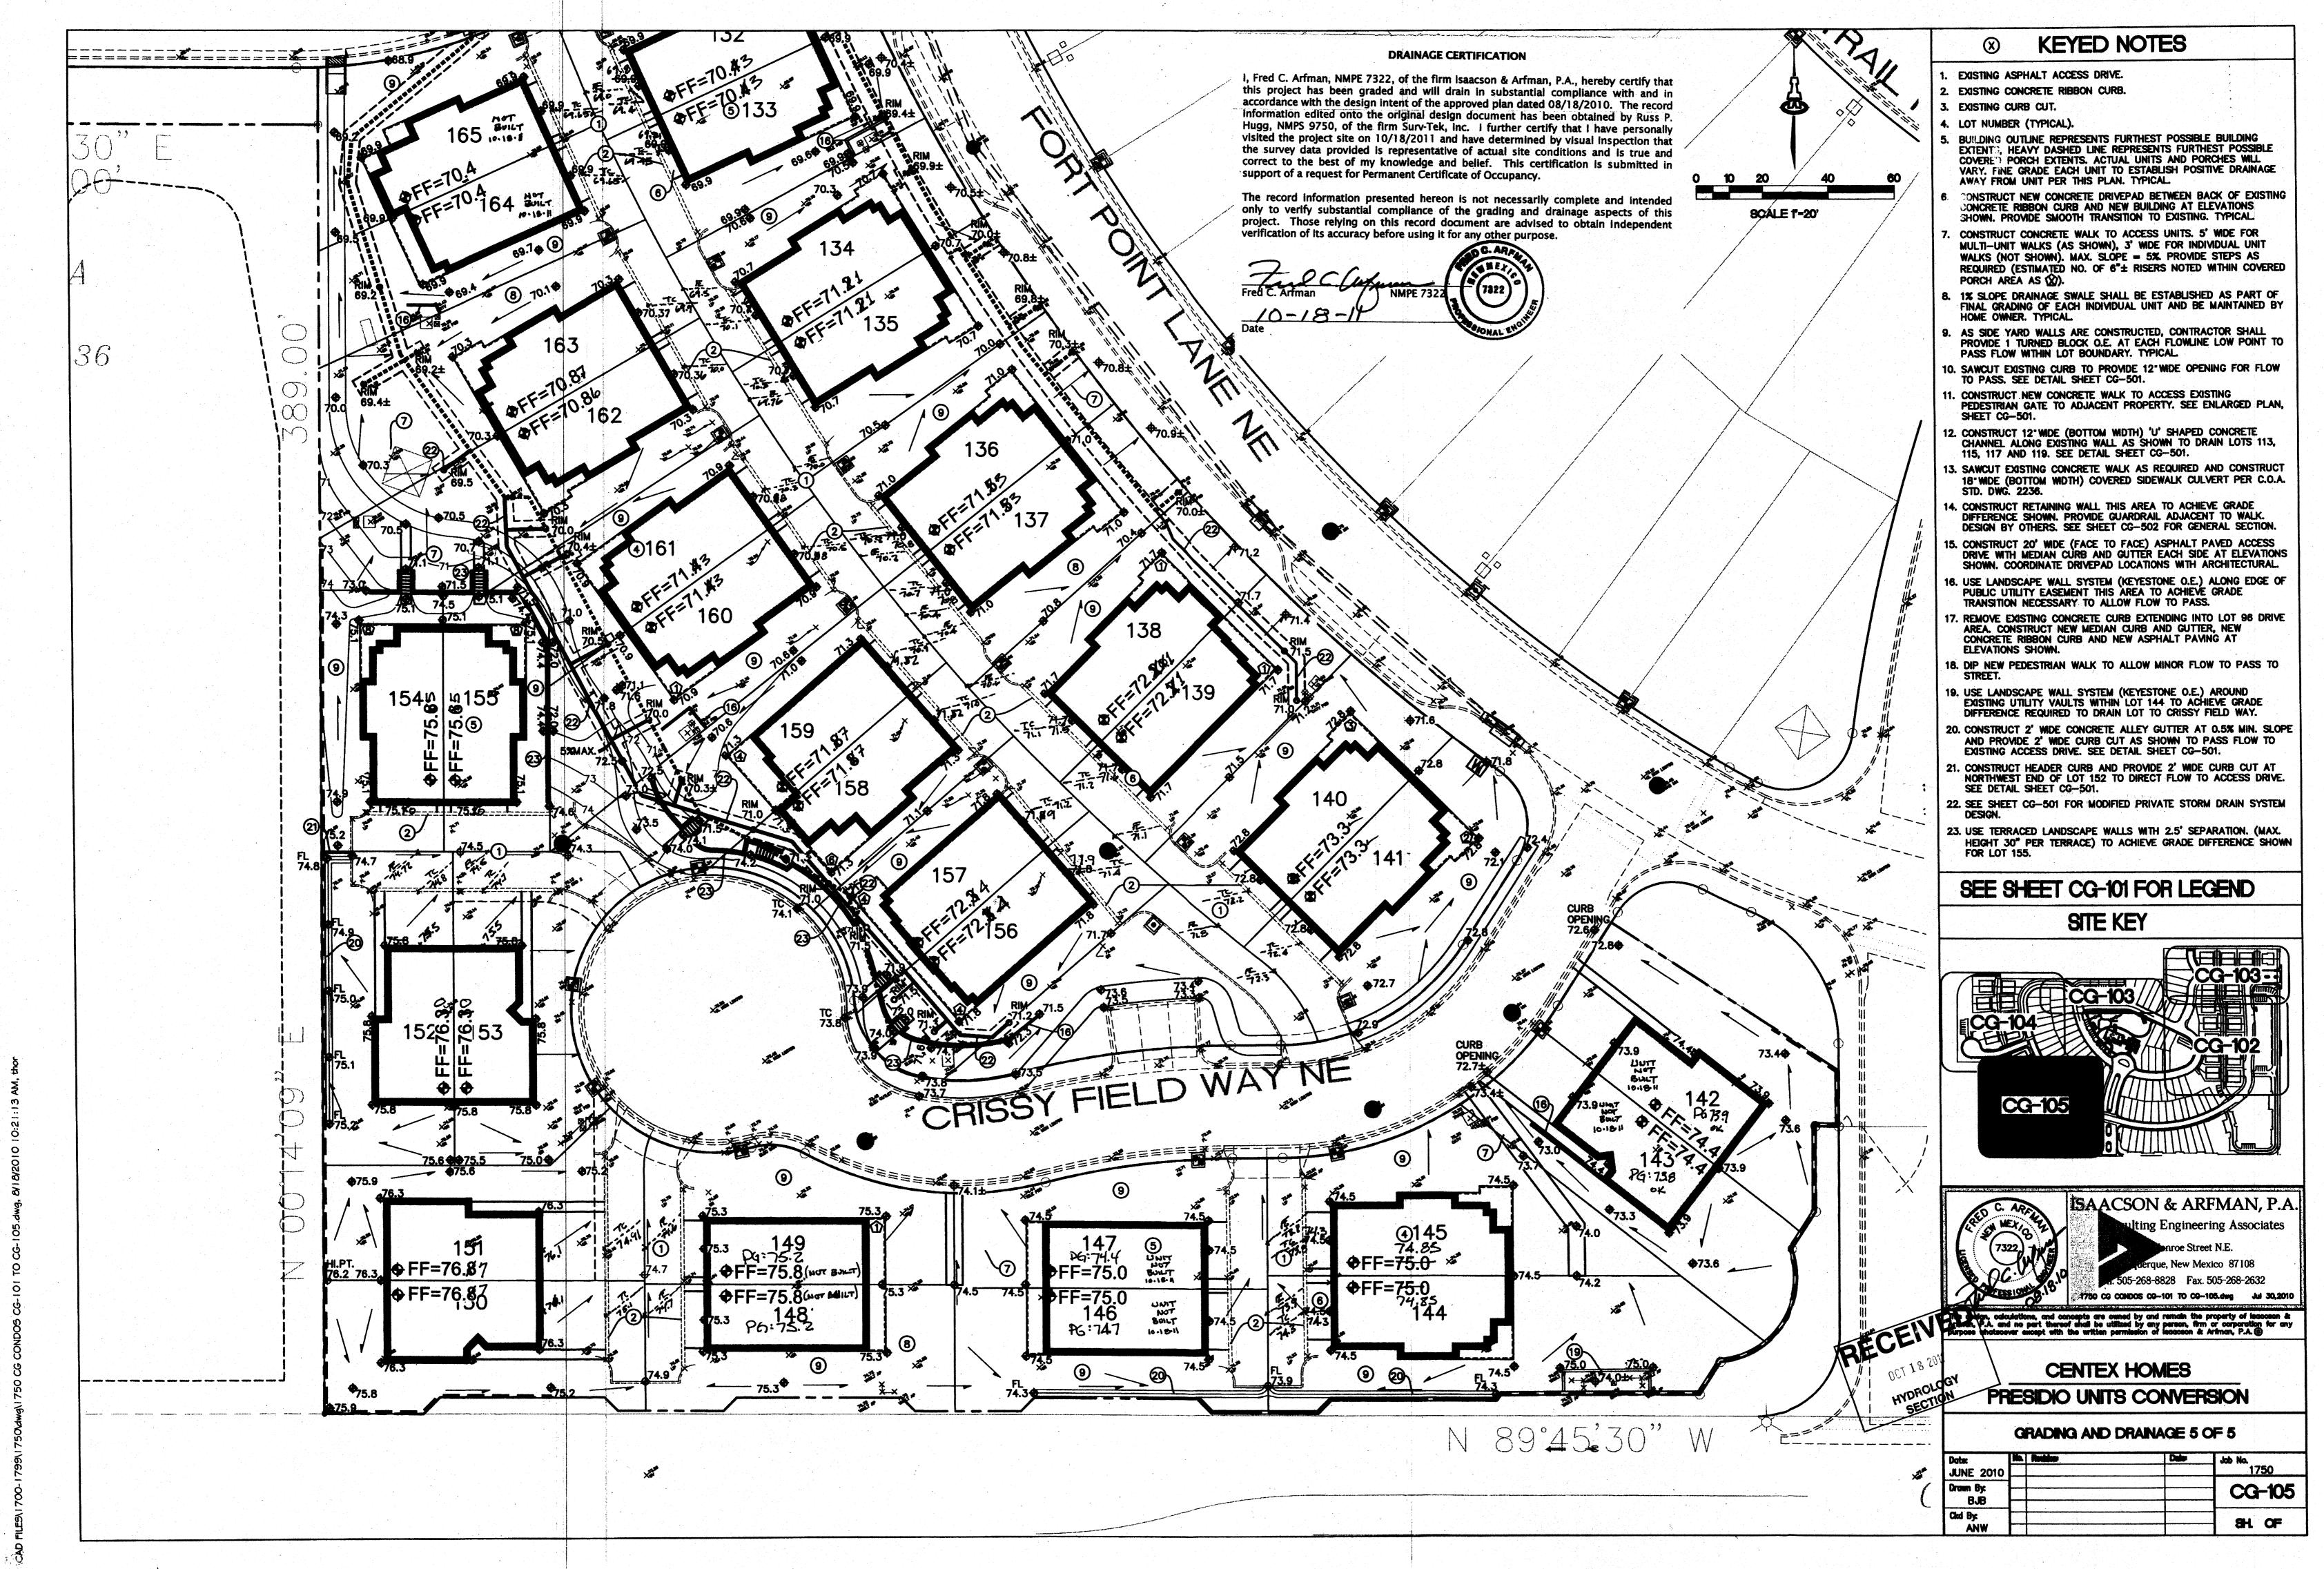

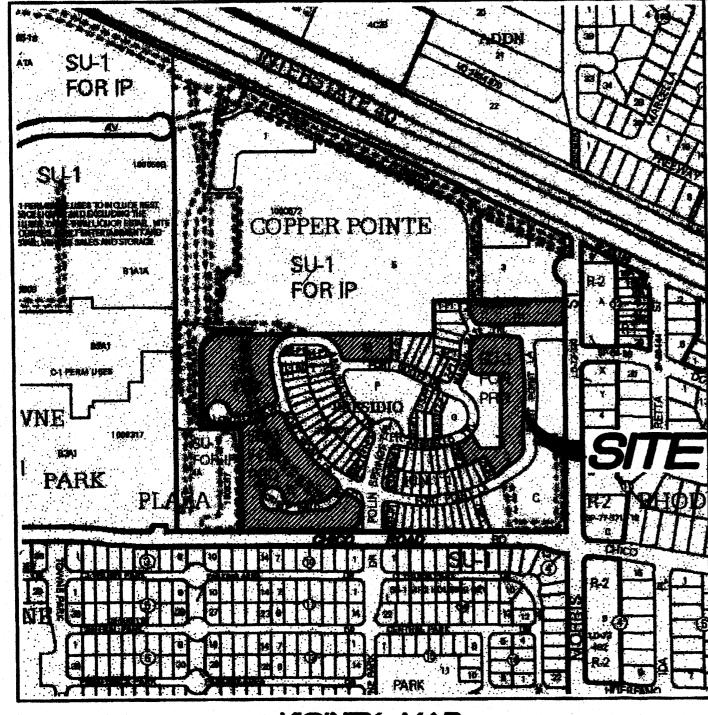

<u>YICINTY MAP</u>

Not To Scale

#### GENERAL NOTES

- 1. Bearings are New Mexico State Plane Grid Bearings, Central Zone NAD83.
- 2. Distances are ground.
- Distances along curved lines are arc lengths.
- 4. Record Plat or Deed bearings and distances, where they differ from those established by this field survey, are shown in parenthesis ( ).
- 5. All corners found in place and held were tagged with a brass disk stamped "HUGG L.S. 9750" unless otherwise indicated hereon.
- 6. All corners that were set are either a 5/8" rebar with cap stamped "HUGG L.S. 9750" or a concrete nall with brass disk stamped "HUGG L.S. 9750" unless otherwise indicated hereon.
- 7. U.C.L.S. Log Number 2010094718.
- 8. City of Albuquerque Zone Atlas Page: K-21-Z

#### SUBDIMBION DATA

Total number of existing Tracts: 5

Total number of new lots created: 78

Total number of new Tracts created: 4

Gross Subdivision acreage: 7.4820 acres.

#### SHEET NOEX

SHEET 1 - General Notes, Approvals, Surveyor Certification

SHEET 2 - Legal Descriptions

SHEET 3 - Legal Descriptions, Free Consent and Dedication

SHEET 4 - Overall Plat, Existing Tracts

SHEETS 5 & 6 - New Lots and Tracts created and Portion of Existing Easements VACATED by 10DRB 70160.

SHEETS 7 & 8 - New Easements created.

SHEET 9 - New Easement Legend and Lot/Tract Acreages.

SHEET 10 - Curve and Line Tables.

#### TREASURERS CERTIFICATION

This is to certify that taxes are current and paid on the following:

Centex Homes
08-11-10

Bernalillo County Treasurer

#### PUBLIC UTILITY EASEMENTS

PUBLIC UTILITY EASEMENTS shown on this plat are granted for the common and joint use of:

- A. Public Service Company of New Mexico (PNM), a New Mexico corporation, (PNM Electric) for installation, maintenance, and service of overhead and underground electrical lines, transformers, and other equipment and related facilities reasonably necessary to provide electrical services.
- B. New Mexico Gas Company for installation, maintenance, and service of natural gas lines, valves and other equipment and facilities reasonably necessary to provide natural gas.
- C. QWest Corporation for the installation, maintenance, and service of such lines, cable, and other related equipment and facilities reasonably necessary to provide communication services.
- D. Comcast Cable for the installation, maintenance, and service of such lines, cable, and other related equipment and facilities reasonably necessary to provide Cable TV service.

Included, is the right to build, rebuild, construct, reconstruct, locate, relocate, change, remove, modify, renew, operate, and maintain facilities for the purposes described above, together with free access to, from, and over said easements, with the right and privilege of going upon, over and across adjoining lands of Grantor for the purposes set forth herein and with the right to utilize the right of way and easement to extend services to customers of Grantee, including sufficient working area space for electric transformers, with the right and privilege to trim and remove trees, shrubs or bushes which interfere with the purposes set forth herein. No building, sign, pool (aboveground or subsurface), hot tub, concrete or wood pool decking, or other structure shall be erected or constructed on said easements, nor shall any well be drilled or operated thereon. Property owners shall be solely responsible for correcting any violations of National Electrical Safety Code by construction of pools, decking, or any structures adjacent to or near easements shown on this plat.

Easements for electric transformers/switchgears, as installed, shall extend ten feet (10') in front of transformer/switchgear doors and five feet (5') on each side.

#### DISCLAIMER

In approving this plat, Public Service Company of New Mexico (PNM) and New Mexico Gas Company (NMGC) did not conduct a Title Search of the properties shown hereon. Consequently, PNM and NMGC do not waive nor release any easement or easement rights to which it may have been granted by prior plat, replat or other document and which are not shown on this plat.

#### PURPOSE OF PLAT:

The Purpose of this plat is to:

- 1. Create new Lots 96 thru 173 and Tracts D-1, E-1A, J-2A-1 and R-1A as shown hereon.
- 2. Show the Vacation of Portions of Public Utility Easements VACATED by 10DRB 70160
- 3. Grant additional easements as shown hereon.

#### SURVEYOR'S CERTIFICATION

I, Russ P. Hugg, New Mexico Professional Surveyor Number 9750, hereby certify that this plat of survey was prepared from field notes of an actual ground survey performed by me or under my direct supervision; that it meets the Standards for Land Surveys in the State of New Mexico as adopted by the New Mexico State Board of Registration for Professional Engineers and Professional Surveyor's; that it meets the minimum requirements for surveys and monumentation of the Albuquerque Subdivision Ordinance; that it shows all easements of record; and that it is true and correct to the best of my knowledge and belief.

Russ P. Huga NMPS No. 9750 June 1, 2010



# PLAT OF LOTS 96 THRU 173 AND TRACTS D-1, E-1A, J-2A-1 AND R-1A THE PRESIDIO. UNIT 2A

(BEING A REPLAT OF TRACTS D AND J-2A, THE PRESIDIO, UNIT 1 (AND TRACTS E-1, H-1 AND R-1, THE PRESIDIO, UNIT 2)

#### SITUATE WITHIN

SECTION 21, TOWNSHIP 10 NORTH, RANGE 4 EAST NEW MEXICO PRINCIPAL MERIDIAN CITY OF ALBUQUERQUE BERNALILLO COUNTY, NEW MEXICO

JUNE , 2010

PROJECT NUMBER	1000572	
	10DRB-7010	

#### PLAT APPROVAL

Utility Approvals

Pulling Service Compnay of New Mexico (PNM)	7-21-2010
Pullic Service Compnay of New Mexico (PNM)	Date
M-A	7. 22.200
New Mexido Gde Company (NMGC)	Date
Mest Corporation Ramus	07.26-16
QWest Corporation	Date
Robert Monding	7.22.10
Comcast	Date

City Approveis	
ILB Jan	6-3-10
City Surveyor  Department of Municipal Development	Date
<b>N/</b>	
Real Property Division	Date
NA	
Environmental Health Department	Date
115/5/15	08-11-10
Traffic Engineering, Transportation Division	Date
allon Viter	08/11/10
A.B.C.W.O.A.	Date
Parks and Recreation Department	8-11-10 Date
Bradle & Binghan	8/11/10 Date
AMAFCA	
Bradley S. Bighan	8/11/10
City Engineer	Date
Cal Chi	8-11-10
DRE Chairperson, Planning Department	Date

DOCH 2010081179

99/11/2010 03:44 PM Page: 1 of 10 tyPLRT R:\$52.00 B: 2010C P: 0099 M. Toulous Olivere, Bernalillo Cour

SHEET 1 OF 10

SURV OTEK, INC.


Consulting Surveyors Phone: 505-897-3866 9364 Valley View Drive, N.W. Albuquerque, New Mexico 87114 Fax: 505-897-3877

TRACT 3

PLAT OF

LOTS 96 THPU 173

FILES/2010 06-10 FINAL PLAT/100 FILES\1700-1799\1750DOWNLOADED FILES/2010 08-10 FINAL INCAD FILES (1700-1799) (1750) TOWNLOADED

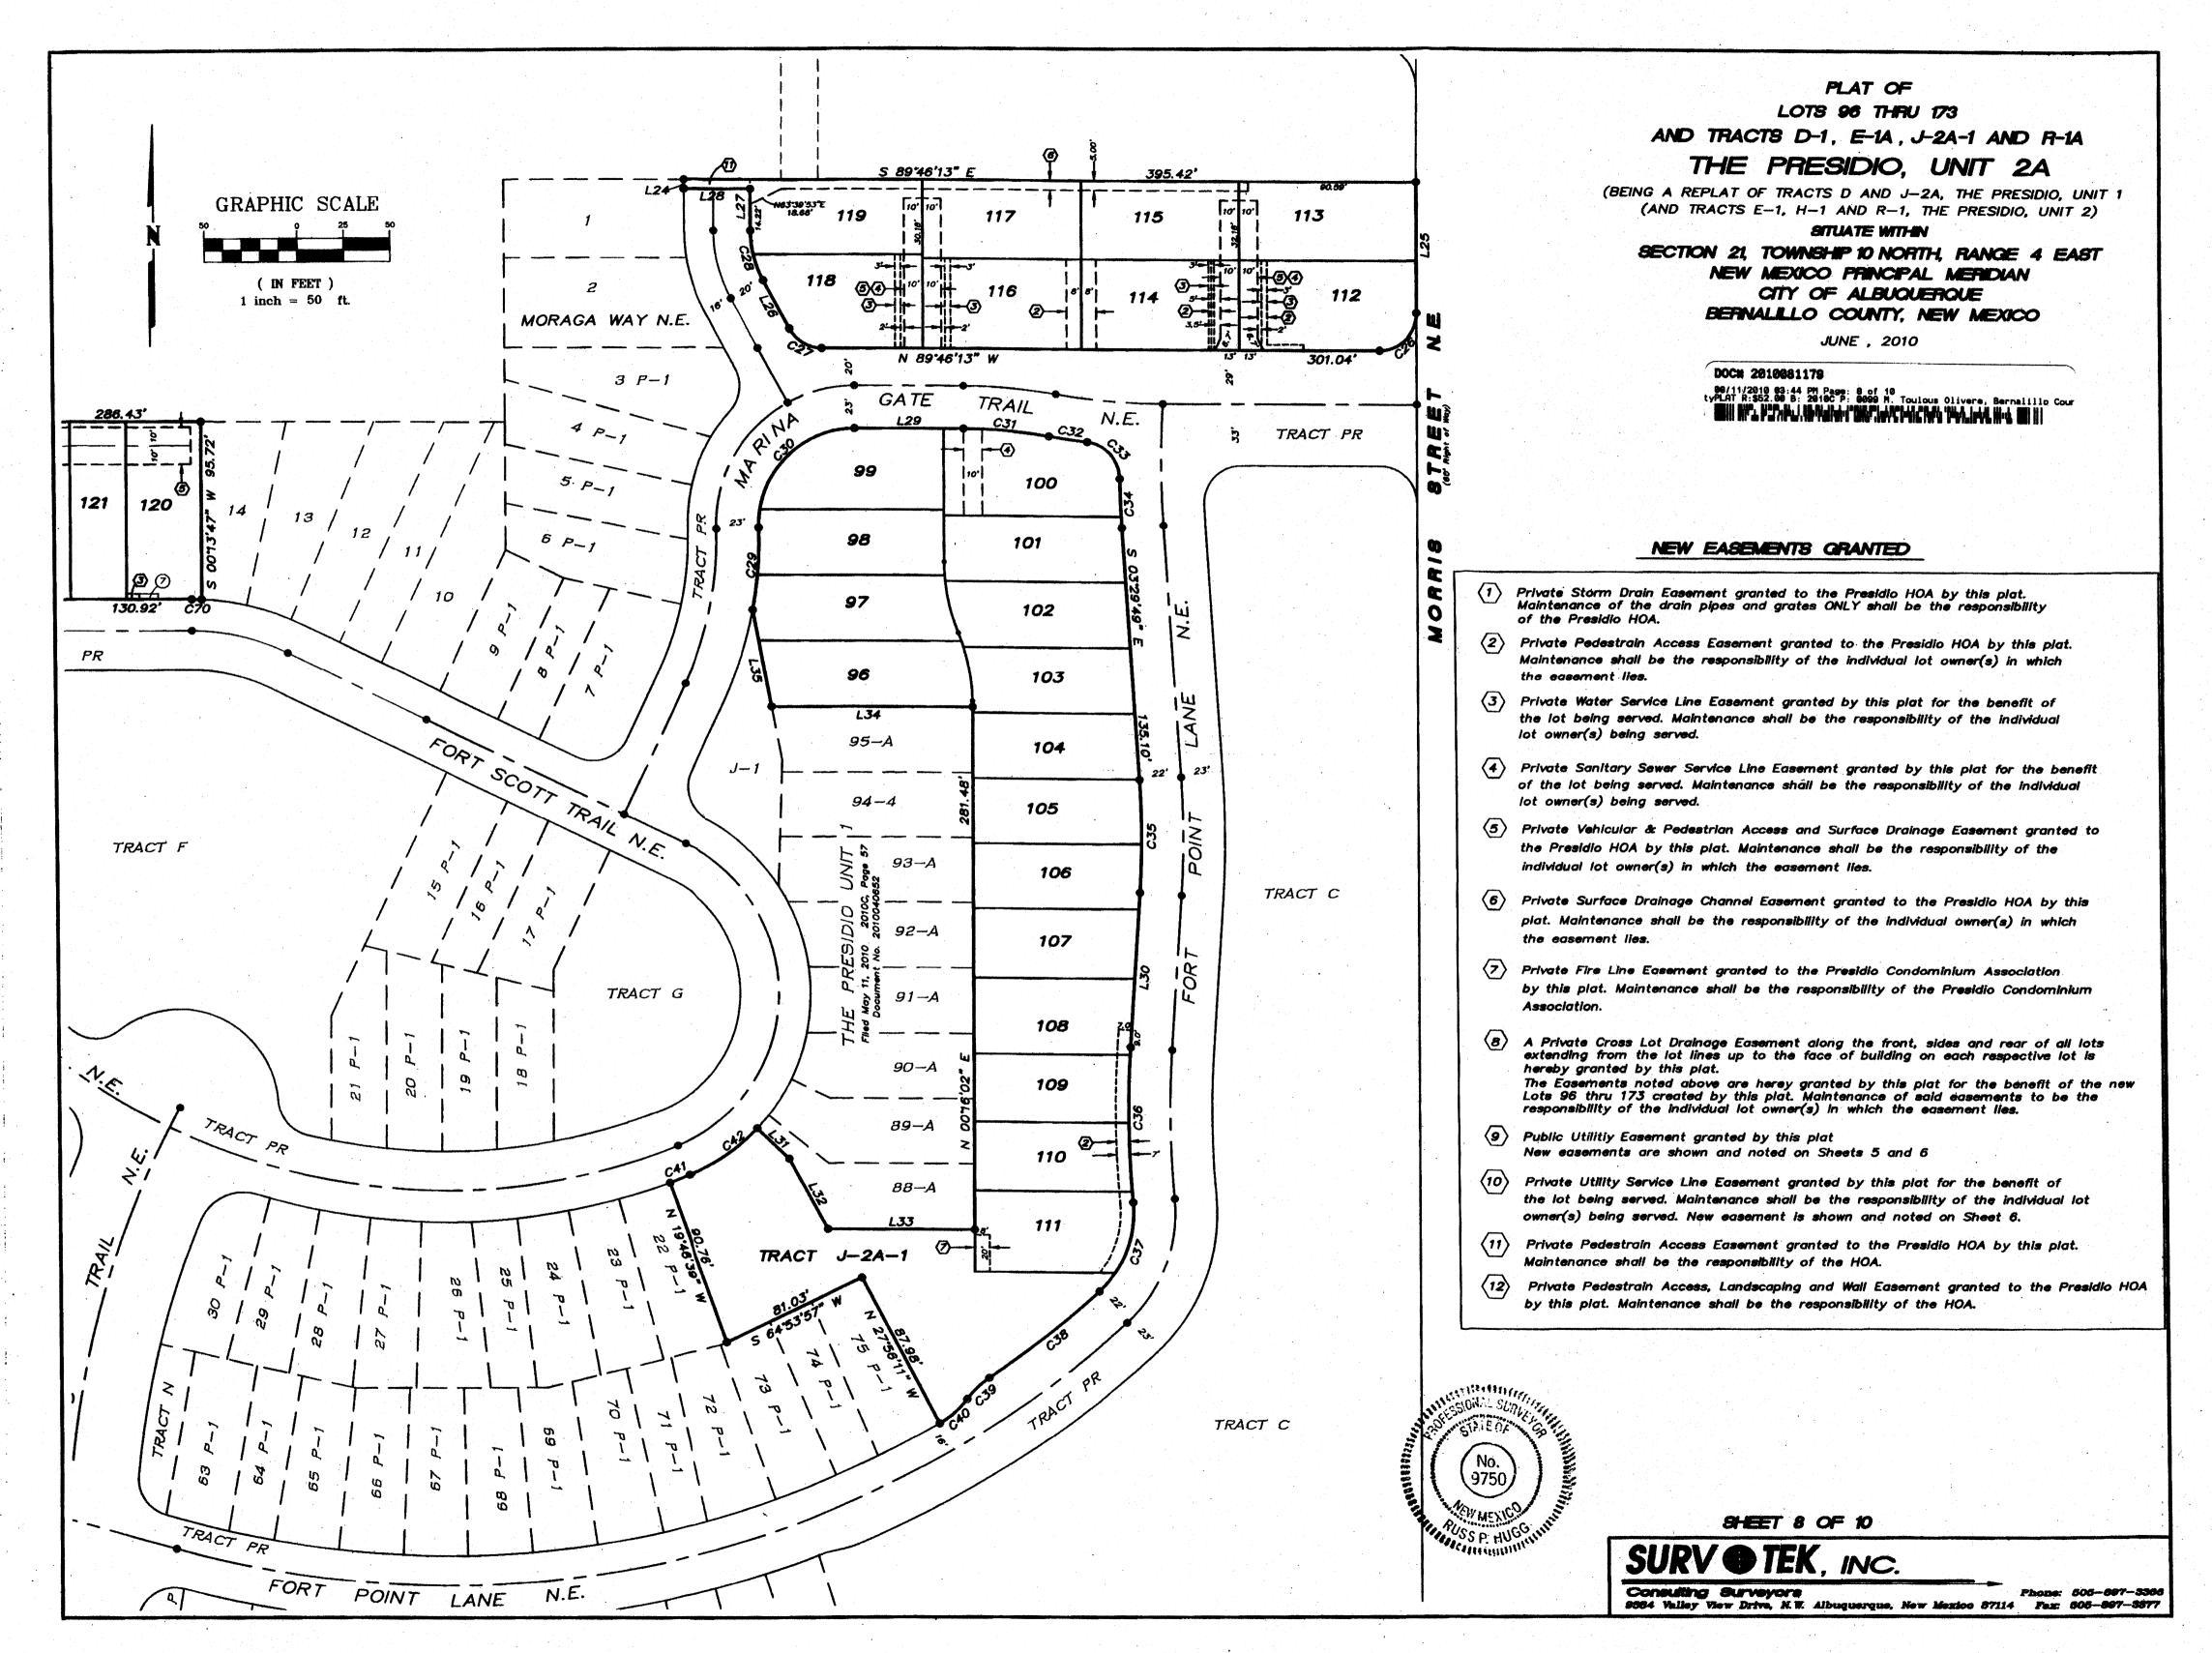

	LINE TA			
LINE L1	LENGTH 16.87	BEARING		
L2	7.00			
L3	25.82	S0014'09"W		
L4	13.53	\$33°05'29"W		
L5 L6		\$33705'29"W		
<u> </u>		N90°00'00"W S45°00'00"W		
L8	50.00	N89"45'30"W		
<u>L9</u>				
L11		N89'45'30"W N44'45'30"W		
L12	50.00	N89'45'30"W		
L13				
L14 L15		N89'45'30"W N44'45'30"W		
L16	50.00	N89'45'30"W		
L17	5.66	S4574'30"W		
L18 L19		N89°45'30"W N44°45'30"W		
L20		N89'45'30"W		
L21		S45'14'30"W		
L22 L23	30.00 20.00	N89°45'30"W		
L24		S00'13'47"W N00'13'47"E		
L25	70.00	500°14'24"W		
L26	29.18	N28'33'27"W		
L27 L28	22.57 36.00	N00'13'47"E N89'46'13"W		
L29	58.80	S89°46'13"E		
L30	83.13	\$04°00'33"W		
L31 L32	23.62 43.04	S46,16'21"E		
L33	79.02	\$28*52'40"E \$89*43'58"E		
L34	108.45	N89'43'58"W		
L35		N10'40'27"W		
L36 L37	90.14 17.44	S68°55'06"W N89°45'30"W		
L38	79.47	S89'45'30"E		
L39	92.62	N68'55'06"E		
L40 L41	30.39 30.07	\$33.05'29"W		
L42	81.98	N33*05'29"E \$56*54'31"E		
L43	15.24	<b>\$89</b> *39'12"W		
L44 L45	15.24 38.28	N89'39'12"E		
L46	27.92	507°04'08"E N00°16'02"E		
L47	24.92	N0016'02"E		
L48 L49	43.71	N0076'02"E		
L50	46.71 3.00	N0076'02"E N0076'04"E		
L51	3.32	NO0'01'27"E		
L52 L53	22.84	N0016'02"E		
L54	35.84 16.90	N10'40'27"W N10'40'27"W		
L55	49.81	N0013'47"E		
L56	40.18	N0073'47"E		
L57 L58	47.82 42.18	N0073'47"E N0073'47"E		
L59	47.82	NO013'47"E		
L60	42.18	NQ013'47"E		
L61 L62	47.82 42.18	N0013'47"E N0013'47"E		
L63	12.50	S89'46'13"E		
L64	19.73	S00°13'47"W		
L65 L66	33.22 35.49	S02'42'27"W		
L67	11.77	S02'42'27"W S02'42'27"W		
L68	9.51	S02'42'27"W S89'45'51"E		
L69 L70	17.00 5.67	<u>S89°45'51"E</u> S33°05'30"W		
L71	7. <b>8</b> 5	N33'05'30"E		
L72	37.12	N0014'09"E		
L73 L74	39.57 41.18	N00°14'09"E		
L75	35.51	N00°14'09"E N00°14'09"E		
L76	10.39	N89'39'12"E		
L77	4.85	N89'39'12"E		
L78 L79	17.05 14.95	\$89'45'30"E \$89'45'30"E \$89'45'30"E		
L80	12.11	S89'45'30"E		
L81	19.89	S89'45'30"E		
L82 L83	38.11 27.66	N0074'30"E N0074'30"E		
L84	8.35	S89'45'30"E		
L85	23.65	S89°45'30"E		
L86 L87	39.14	N00'06'56"E		
L87	33.90 38.10	N00°06'56"E N00°06'56"E		
180		N000000E		

34.94 N00°06'56"E 68.67 S89°50'38"E

		•	
		LINE TA	
	LINE	LENGTH	BEARING
	L91	25.35	
	L92	<i>39.78</i>	S89'50'38"E
ŀ	L93 L94	28.89 <b>3</b> 9.78	\$89°50'38"E
1	L95	50.59	\$89*45*51"E \$89*45*51"E
	L96	37.10	S89'45'51"E
1	L97	32.10	S89'45'51"E
I	L98	0.10	S89*45'51"E
	L99	21.07	S89°45'51"E
	£100	12.18	\$3012'33 <b>"</b> E
- 1	L101	37.10	S89*45'51"E
ı	4102	25.15	S89°45'51"E
- 1	L103	12.26	S3418'47"E
ł	L104 L105	<i>59.00 51.38</i>	S0014'09"W
ŀ	L106	10.86	\$89°45'51"E \$89°45'51"E
Ì	L107	18.69	S0074'09"W
	L108	50.31	S00'14'09"W
	L109	0.15	S03'29'49"E
	L110	175.17	\$89°45'21"E
	L111	4.00	N48'02'30"E
	L112	78.65	58978'16"W
}	L113	18.72	S50°38'48"W
ł	L114 L115	23.82 23.54	S00'05'54"W
1	L115	20.09	500°54'28"W S02°58'21"W
1	L117	58.44	S02'58 21 W S00'08'42"E
ľ	L118	64.79	N89'45'51"W
	L119	34.49	S00'08'42"E
	L120	120.09	\$20°28'56"E
	L121	56.19	S87'44'13"E
	L122	9.86	\$23'29'02"E
- 1	L123	47.07	S50'45'26"W
ŀ	L124 L125	14.26	S05'45'26"W
ŀ	L125	53.83 2.09	
ŀ	L127	16.88	S35°48'04"E S59°21'55"W
ı	L128	33.68	\$35.48'04"E
- 1	L129	12.50	S54"11'56"W
	L130	<b>52.50</b>	N89°45'51"W
	L131	17.50	S35'48'04"E
1	L132	9.86	S02°03'04"E
	L133	14.84	N87'56'56"E
ŀ	L134 L135	5.14 10.42	502°03'04"E
ŀ	L136	18.71	S27°58'15"E N62°01'45"E
t	L137	29.83	S27'58'15"E
	L138	5.91	S70'58'37"E
	L139	15.50	N62'01'45"E
	L140	25.85	S27"28"53"E
-	L141	15.50	N62'01'45"E
-	L142 L143	19.28	\$27.58.15"E
-	L143 L144	10.29 10.66	\$72°58'15"E
1	L145	38.18	N17*01'45"E S72*58'15"E
1	L146	55.47	S40:43'42"E
Ī	L147	11.09	S49'16'18"W
	L148	15.17	540°43'42"E
	L149	8.21	54976'18"W
	L150	6.37	\$40'43'42"E
-	L151	9.08	\$85.43'42"E
, F	L152 L153	8.75 13.50	N4916'18"E
ŀ	L154	3.41	S33°27'54"E N62°31'30"E
ŀ	L155	11.26	N48*24'01"E
Ī	L156	10.86	N81°55'23"W
	L157	37.72	N14'25'23"W
I.	L158	79.65	NO7"45'30"W
J	L159	39.42	NO1"58"51"W
-	L160	27.52	N13'39'22"E
1	L161	38.72	N09'51'03"E
ŀ	L162 L163	50.84 16.44	\$36*41'10"E
	L164	56.34	\$00°00'00"E \$89°45'51"E
-	L165	15.24	N89'45'30"W
ŀ			N57'46'41"E
	L166	12.50	THUS TO TE
		12.50	N55'07'57"E
	L166 L167 L168		
	L166 L167 L168 L169	12.49 28.19 10.49	N55'07'57"E S00'13'47"W S28'28'15"E
	L166 L167 L168 L169 L170	12.49 28.19 10.49 6.23	N55'07'57"E S00'13'47"W S28'28'15"E S00'13'47"W
	L166 L167 L168 L169 L170 L171	12.49 28.19 10.49 6.23 14.43	N55'07'57"E S00'13'47"W S28'28'15"E S00'13'47"W S28'33'27"E
	L166 L167 L168 L169 L170	12.49 28.19 10.49 6.23	N55'07'57"E S00'13'47"W S28'28'15"E S00'13'47"W

6.00 S0074'09"W

45.69 S0074'09"W

12.44 N5017'03"E

12.49 N48"24'01"E

23.69 N45'02'03"E

50.49 NOO'06'56"E

500'02'03"W

15.05

L175

L176

L177

L178

L179

L180

٠.								
	LINE TABLE							
	LINE	LENGTH	BEARING					
	L181	13.61	N53'39'25"E					
-	L182	28.79	N49'48'43"E					
	L183	23.42	N00°06'56"E					
	L184	12.52	N45'02'03"E					
	L185	1.71	S48'04'47"E					
	L186	3.00	N41'24'52"E					
-	. L187	12.62	S4976'18"W					
	L188	4.29	S48'47'11"E					
	L189	3.00	S40°49'37"W					
	L190	51.08	\$89°45'51"E					
	L191	<i>38.52</i>	S59°03'09"E					
	L192	12.50	N55°07'57"E					
	L193	0.50	\$34'53'20"E					
	L194	3.00	N54'39'29"E					
	L195	31.84	\$89'45'51"E					
	L196	34.65	S05*58'16"E					
1	L197	25.39	S89°45'51"E					

Lot No.	Acres
Lot 96	0.0889
Lot 97	0.0853
Lot 98	0.0809
Lot 99	0.0871
Lot 100 Lot 101	0.0936
Lot 102	0.0782
Lot 103	0.0765
Lot 104	0.0710
Lot 105	0.0718
Lot 106	
Lot 107	0.0730
Lot 108	0.0761
Lot 109	0.0796
Lot 110	0.0711
Lot 111	0.0715
Tract J-2A-1	0.0837
Lot 112	0.3165 0.1029
Lot 113	
Lot 114	0.0926
Lot 115	0.0938
Lot 116	0.0827
Lot 117	0.0938
Lot 118	0.0827
Lot 119	0.0909
Lot 120	0.0898
Lot 121	0.0884
	0.0707
Lot 122 Lot 123	0.0772
	0.1317
Lot 124	0.1128
Lot 125 Lot 126	0.0707
	0.0686
Lot 127	0.0754
Lot 128	0.0653
Lot 129	0.0654
Lot 130	0.0654
Lot 131	0.0867
Lot 132	0.0815
Lot 133	0.0763
Lot 134	0.0762
Lot 135	0.0762
Lot 136	0.0762
Lot 137	0.0762
Lot 138	0.0762
Lot 139	0.0723
Lot 140 Lot 141	0.0808
Lot 142	0.0917
Lot 143	0.0898
Lot 144	0.0832
	0.1174
Lot 145 Lot 146	0.0939
Lot 147	0.0759
Lot 148	0.0764
	0.0771
	0.0789
Lot 150 Lot 151	0.0832
Lot 152	0.0844 0.0864
Lot 153	
Lot 154	0.0903
Lot 155	0.0674
Lot 156	0.0575
Lot 157	0.0708
Lot 158	0.0626
	0.0591
	0.0837
Lot 160 Lot 161	0.0978
	0.0665
Lot 162	0.1079
Lot 163	0.1102
Lot 164	0.0746
Lot 165	0.0815
Tract D-1	0.0699
Lot 166	0.1177
Lot 167	0.1031
Lot 168	0.0993
Lot 169	0.0916
Lot 170	0.0883
Lot 171	0.0868
Lot 172	0.0859
Lot 173	0.1275
Tract R-1A	0.4737
Tract E-1A	0.0927

Tract E-1A

0.0927

#### PLAT OF LOTS 96 THPU 173 AND TRACTS D-1, E-1A, J-2A-1 AND R-1A THE PRESIDIO, UNIT 2A


(BEING A REPLAT OF TRACTS D AND J-2A, THE PRESIDIO, UNIT 1 (AND TRACTS E-1, H-1 AND R-1, THE PRESIDIO, UNIT 2) SITUATE WITHIN

SECTION 21, TOWNSHIP 10 NORTH, RANGE 4 EAST NEW MEXICO PRINCIPAL MERIDIAN CITY OF ALBUQUERQUE BERNALILLO COUNTY, NEW MEXICO

JUNE , 2010

DOC# 2010081179

08/11/2018 03:44 PM Page: 9 of 10 tyPLAT R:\$52.00 B: 2018C P: 0009 M. Toulous Olivere, Bernalillo Cour

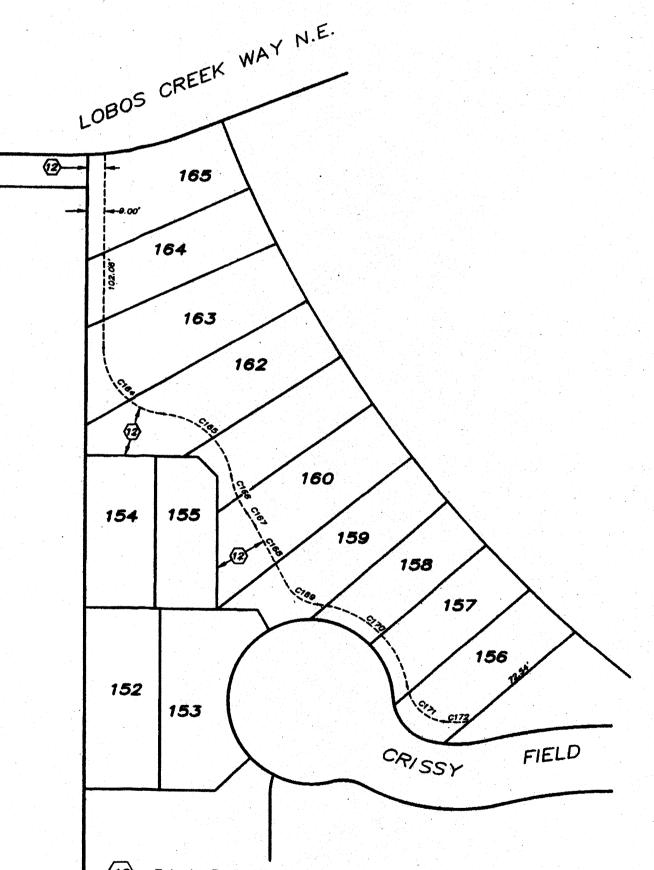


Private Pedestrian Access, Landscaping and Wall Easement granted to the Presidio HOA by this plat. Maintenance shall be the responsibility of the HOA.


SHEET 9 OF 10

Consulting Surveyors
9384 Valley View Drive, N.W. Albuquerque, New Mexico 87114 Fax: 606-897-3377

### GENERAL NOTES


- 1. ALL TRASH, DEBRIS, & SURFACE VEGETATION SHALL BE CLEARED AND LEGALLY DISPOSED OF OFFSITE.
- 2. ALL SUBGRADE, OVEREXCAVATION, AND FILL SHALL BE PLACED AND / OR COMPACTED PER THE GEOTECHNICAL REPORT AND CITY OF ALBUQUERQUE SPECIFICATIONS.
- 3. EXCAVATION IS UNCLASSIFIED AND INCLUDES EXCAVATION TO SUBGRADE ELEVATIONS INDICATED BY GEOTECHNICAL REPORT, REGARDLESS OF CHARACTER OF MATERIALS ENCOUNTERED.
- 4. PAD AND ROUGH GRADING ELEVATIONS SHALL CONFORM TO ELEVATIONS SHOWN ON PLANS.
- 5. FINAL GRADES SHOWN REPRESENT TOP OF FINISH MATERIAL (I.E. TOP OF CONCRETE, TOP OF PAVEMENT MATERIAL TOP OF LANDSCAPING MATERIAL, ETC.). CONTRACTOR SHALL GRADE, COMPACT SUBGRADE AND DETERMINE EARTHWORK ESTIMATES BASED ON ELEVATIONS SHOWN MINUS MATERIAL THICKNESSES.
- 6. MAXIMUM SLOPES SHALL BE 3:1. MINIMUM SLOPES SHALL BE 1% UNLESS OTHERWISE NOTED.
- 7. FIVE (5) WORKING DAYS PRIOR TO ANY EXCAVATION, CONTRACTOR MUST CONTACT NEW MEXICO ONE CALL SYSTEM, 260-1990, FOR LOCATION OF EXISTING UTILITIES.
- 8. IF ANY UTILITY LINES, PIPELINES, OR UNDERGROUND UTILITY LINES ARE SHOWN ON THESE DRAWINGS, THEY ARE SHOWN IN AN APPROXIMATE MANNER ONLY, AND SUCH LINES MAY EXIST WHERE NONE ARE SHOWN. IF ANY SUCH EXISTING LINES ARE SHOWN, THE LOCATION IS BASED UPON INFORMATION PROVIDED BY THE OWNER OF SAID UTILITY, AND THE INFORMATION MAY BE INCOMPLETE, OR MAY BE OBSOLETE BY THE TIME CONSTRUCTION COMMENCES. THE ENGINEER HAS CONDUCTED ONLY PRELIMINARY INVESTIGATION OF THE LOCATION, DEPTH, SIZE OR TYPE OF EXISTING UTILITY LINES, PIPELINES, OR UNDERGROUND UTILITY LINES. THIS INVESTIGATIONS IS NOT CONCLUSIVE, AND MAY NOT BE COMPLETE, THEREFORE, MAKES NO REPRESENTATION PERTAINING THERETO, AND ASSUMES NO RESPONSIBILITY OR LIABILITY THEREFORE. THE CONTRACTOR SHALL INFORM ITSELF OF THE LOCATION OF ANY UTILITY LINE, PIPELINE, OR UNDERGROUND UTILITY LINE IN OR NEAR THE AREA OF THE WORK IN ADVANCE OF AND DURING EXCAVATION WORK. THE CONTRACTOR IS FULLY RESPONSIBLE FOR ANY AND ALL DAMAGE CAUSED BY ITS FAILURE TO LOCATE, IDENTIFY AND PRESERVE ANY AND ALL EXISTING UTILITIES, PIPELINES, AND UNDERGROUND UTILITY LINES. IN PLANNING AND CONDUCTING EXCAVATION, THE CONTRACTOR SHALL COMPLY WITH STATE STATUES, MUNICIPAL AND LOCAL ORDINANCES, RULES AND REGULATIONS, IF ANY, PERTAINING TO THE LOCATION OF THESE LINES AND FACILITIES.
- 9. OWNER WILL PROVIDE SOIL TESTING AND INSPECTION SERVICES DURING EARTHWORK OPERATIONS. CONTRACTOR SHALL ALLOW TESTING LABS TO INSPECT AND APPROVE COMPACTED SUBGRADES AND FILL LAYERS BEFORE FURTHER CONSTRUCTION WORK IS DONE. SHOULD COMPACTION TESTS INDICATE INADEQUATE DENSITY, CONTRACTOR SHALL PROVIDE ADDITIONAL COMPACTION AND TESTING AT THE CONTRACTOR'S SOLE EXPENSE.
- 10. OWNER HAS ESTABLISHED SUBDIVISION BOUNDARY CORNERS. CONTRACTOR SHALL PROVIDE ALL OTHER CONSTRUCTION STAKING INCLUDING TRACT CORNERS, CONTRACTOR SHALL LOCATE AND PRESERVE ALL BOUNDARY CORNERS AND REPLACE ANY LOST OR DISTURBED CORNERS AT THE CONTRACTOR'S SOLE
- 11. IT IS THE CONTRACTOR'S RESPONSIBILITY TO FIELD VERIFY EXISTING CONDITIONS PRIOR TO CONSTRUCTION. REPORT ALL DISCREPANCIES TO THE ENGINEER AND VERIFY THE ENGINEER'S INTENT BEFORE PROCEEDING.
- 12. ALL NEW PAVEMENT GRADES SHOWN AS 'MATCH' OR '±' REPRESENT TRANSITIONS TO EXISTING. TRANSITIONS SHALL BE SMOOTH AND LEVEL. ANY NEW PAVING SURFACE HOLDING WATER (BIRDBATH) SHALL BE REMOVED AND REPLACED AT THE CONTRACTOR'S SOLE EXPENSE.

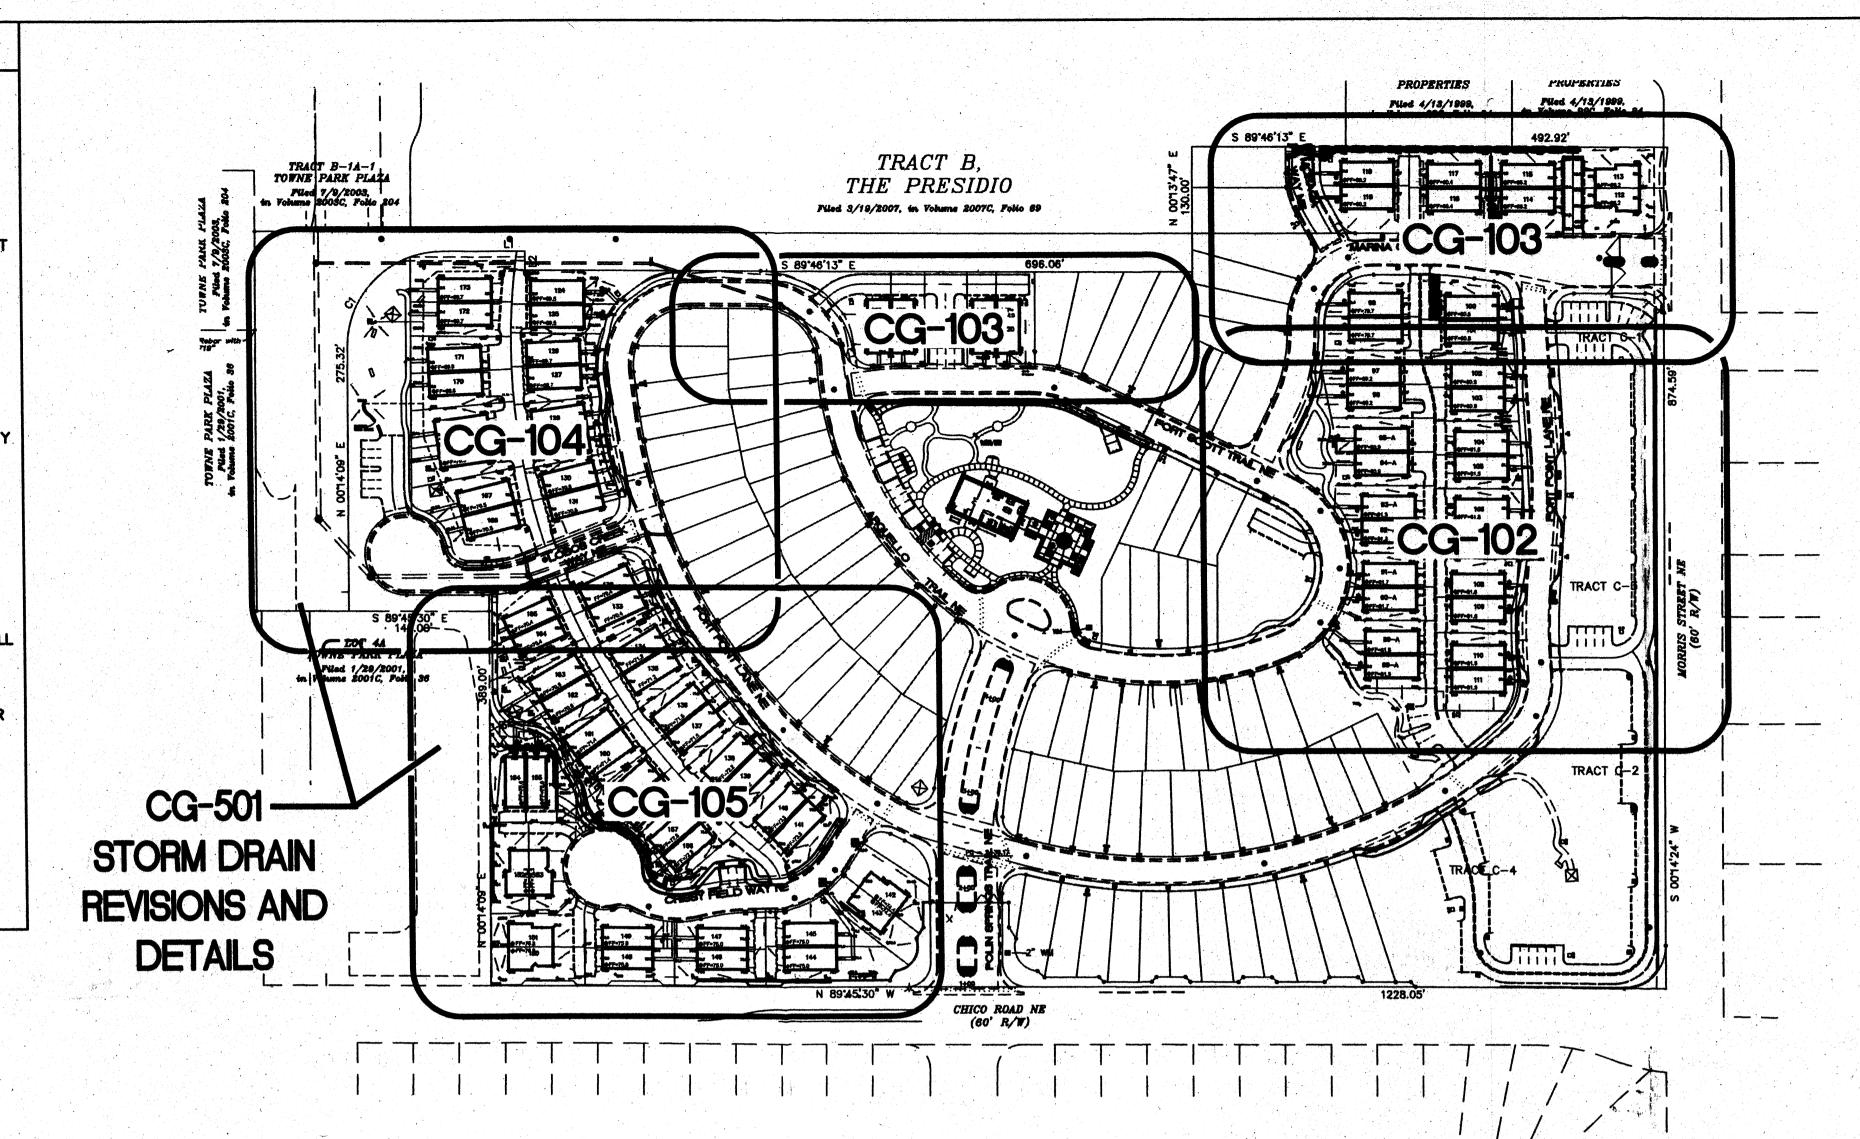

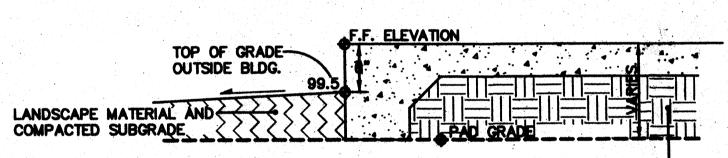


TYPICAL SECTION AT BUILDING

COMPACTED FILL PER THE GEOTECHNICAL REPORT AND CITY OF ALBUQUERQUE SPECIFICATIONS.

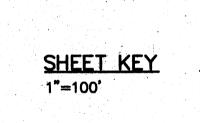

# **TYPICAL LOT GRADING PLAN** 1"=20' **(1) ◆**FF=80.9 TYPICAL LOT GRADING PLAN



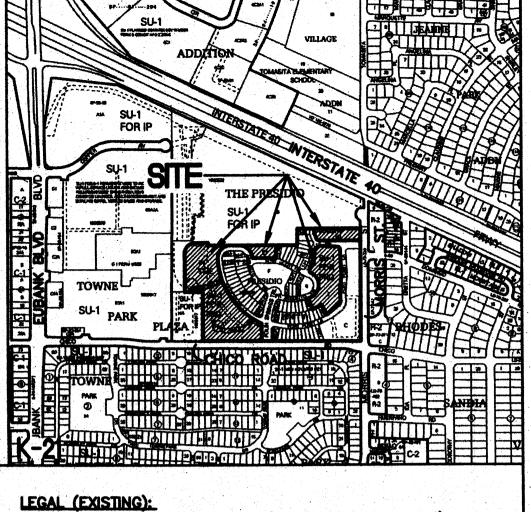

VICINITY MAP K-21

TRACT D. THE PRESIDIO, UNIT 1 (04-13-07, 2007C-81); TRACT J-2A, THE PRESIDIO UNIT 1 (05-11-10, 2010C-57); TRACTS E-1, H-1 AND R-1, THE PRESIDIO, UNIT 2.

TEMPORARY BENCHMARK: STREET CENTERLINE MONUMENTS HAVE BEEN PROVIDED AS PART OF PHASE I. SEE CG-102 THROUGH CG-105 FOR LOCATIONS AND ELEVATIONS TO NAVD 1988 DATUM.

#### PROJECT NOTES:

THE PAVING, CURB AND GUTTER (PRIVATE STREETS AND ALLEYS), WATER AND SANITARY SEWER WERE INSTALLED WITH THE PRESIDIO, UNIT 1 PLANS (CPN 797481) AND UNIT 2 PLANS (CPN 797482).

THIS PLAN SET SHOWS REVISED GRADES FOR EACH AREA TO

DRAINAGE PATTERNS SHALL FOLLOW THE APPROVED PLAN FOR THE CONDOMINIUM UNITS, AND THE EXISTING CONDOMINIUM PADS SHALL BE RESHAPED TO ACCOMMODATE THE SINGLE-DETACHED LOTS.

CHANGE IN DISCHARGE RATE: IN GENERAL, EACH PREVIOUSLY PROPOSED CONDO UNIT (3045 SF FOOTPRINT) WILL BE REPLACED BY A MAXIMUM FOOTPRINT OF 2860 SE (DEPENDING ON WHICH MODEL IS CHOSEN) - A REDUCTION OF 115 SF LAND TREATMENT 'D' PER UNIT (MINIMUM). ADDITIONAL IMPERMEABLE FOR DRIVEPAD EXTENSIONS WILL ACCOUNT FOR SOME OF THE SAVINGS. THE CHANGE IN THE SITE DISCHARGE RATE DUE TO THIS PROPOSED CONVERSION WILL BE NEGLIGIBLE.

#### LEGEND


PROPOSED SPOT ELEVATION EXISTING DESIGN SPOT ELEVATION (ADJUSTED TO NEW DATUM)

FLOW ARROW

FINISH FLOOR ELEVATION

AS-BUILT SPOT ELEVATION (NAVD 1988)

TBM: AS-BUILT SPOT ELEVATION AT CENTERLINE MONUMENT (NAVD 1988)

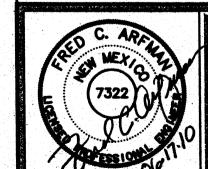

RECEIVE

# ACSON & ARFMAN, P.A. ing Engineering Associates


### **CENTEX HOMES** PRESIDIO UNITS CONVERSION


#### GRADING AND DRAINAGE 1 OF 5


Date:	Job No.
JUNE 2010	1750
Drawn By:	00 404
BJB	CG-101
Ckd By:	SHL OF
ANW	


# **KEYED NOTES**

- 1. EXISTING ASPHALT ACCESS DRIVE.
- 2. EXISTING CONCRETE RIBBON CURB.
- 3. BUILDING OUTLINE REPRESENTS LARGEST UNIT. ACTUAL UNITS AND PATIOS WILL VARY. FINE GRADE EACH UNIT TO ESTABLISH POSITIVE DRAINAGE AWAY FROM UNIT PER THIS PLAN. TYPICAL.
- 4. CONSTRUCT NEW CONCRETE DRIVEPAD BETWEEN BACK OF EXISTING CONCRETE RIBBON CURB AND NEW BUILDING AT ELEVATIONS SHOWN (ACTUAL DEPTH WILL VARY BASED ON UNIT SELECTED). PROVIDE SMOOTH TRANSITION TO EXISTING. TYPICAL.
- 5. ELEVATION AT GARAGE DOOR IS SET 6" BELOW FINISH FLOOR ELEVATION (FF) TO ACCOMMODATE 2" SLOPE IN GARAGE FLOOR AND 4" WHEEL STOP. SEE ARCHITECTURAL FOR INTERIOR GRADE TRANSITIONS.
- 6. ELEVATION AT EXTERIOR DOORS ARE SET 4"BELOW FF ELEVATION TO ACCOMMODATE 4" STOOP. SEE ARCHITECTURAL, MAXIMUM SLOPE = 2% OVER FIRST 5' AT LANDING.
- . CONSTRUCT CONCRETE WALK TO ACCESS UNITS. 5' WIDE FOR MULTI-UNIT WALKS, 3' WIDE FOR INDIVIDUAL UNIT WALKS. MAX. SLOPE = 5%. PROVIDE STEPS AS REQUIRED. NUMBER OF STEPS REQUIRED PROVIDED . SEE ARCHITECTURAL FOR DETAILS.
- 8. 1% SLOPE DRAINAGE SWALE SHALL BE ESTABLISHED AS PART OF FINAL GRADING OF EACH INDIVIDUAL UNIT AND BE MAINTAINED BY HOME OWNER. TYPICAL.
- . USE LANDSCAPE WALL SYSTEM (KEYESTONE O.E.) ALONG EDGE OF ELECTRIC EASEMENT THIS AREA TO ACHIEVE GRADE TRANSITION NECESSARY TO ALLOW FLOW TO PASS.

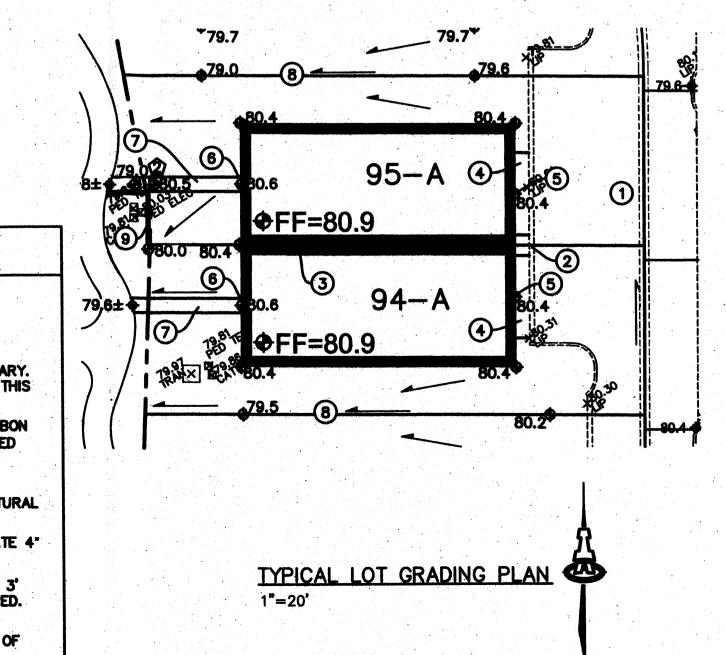


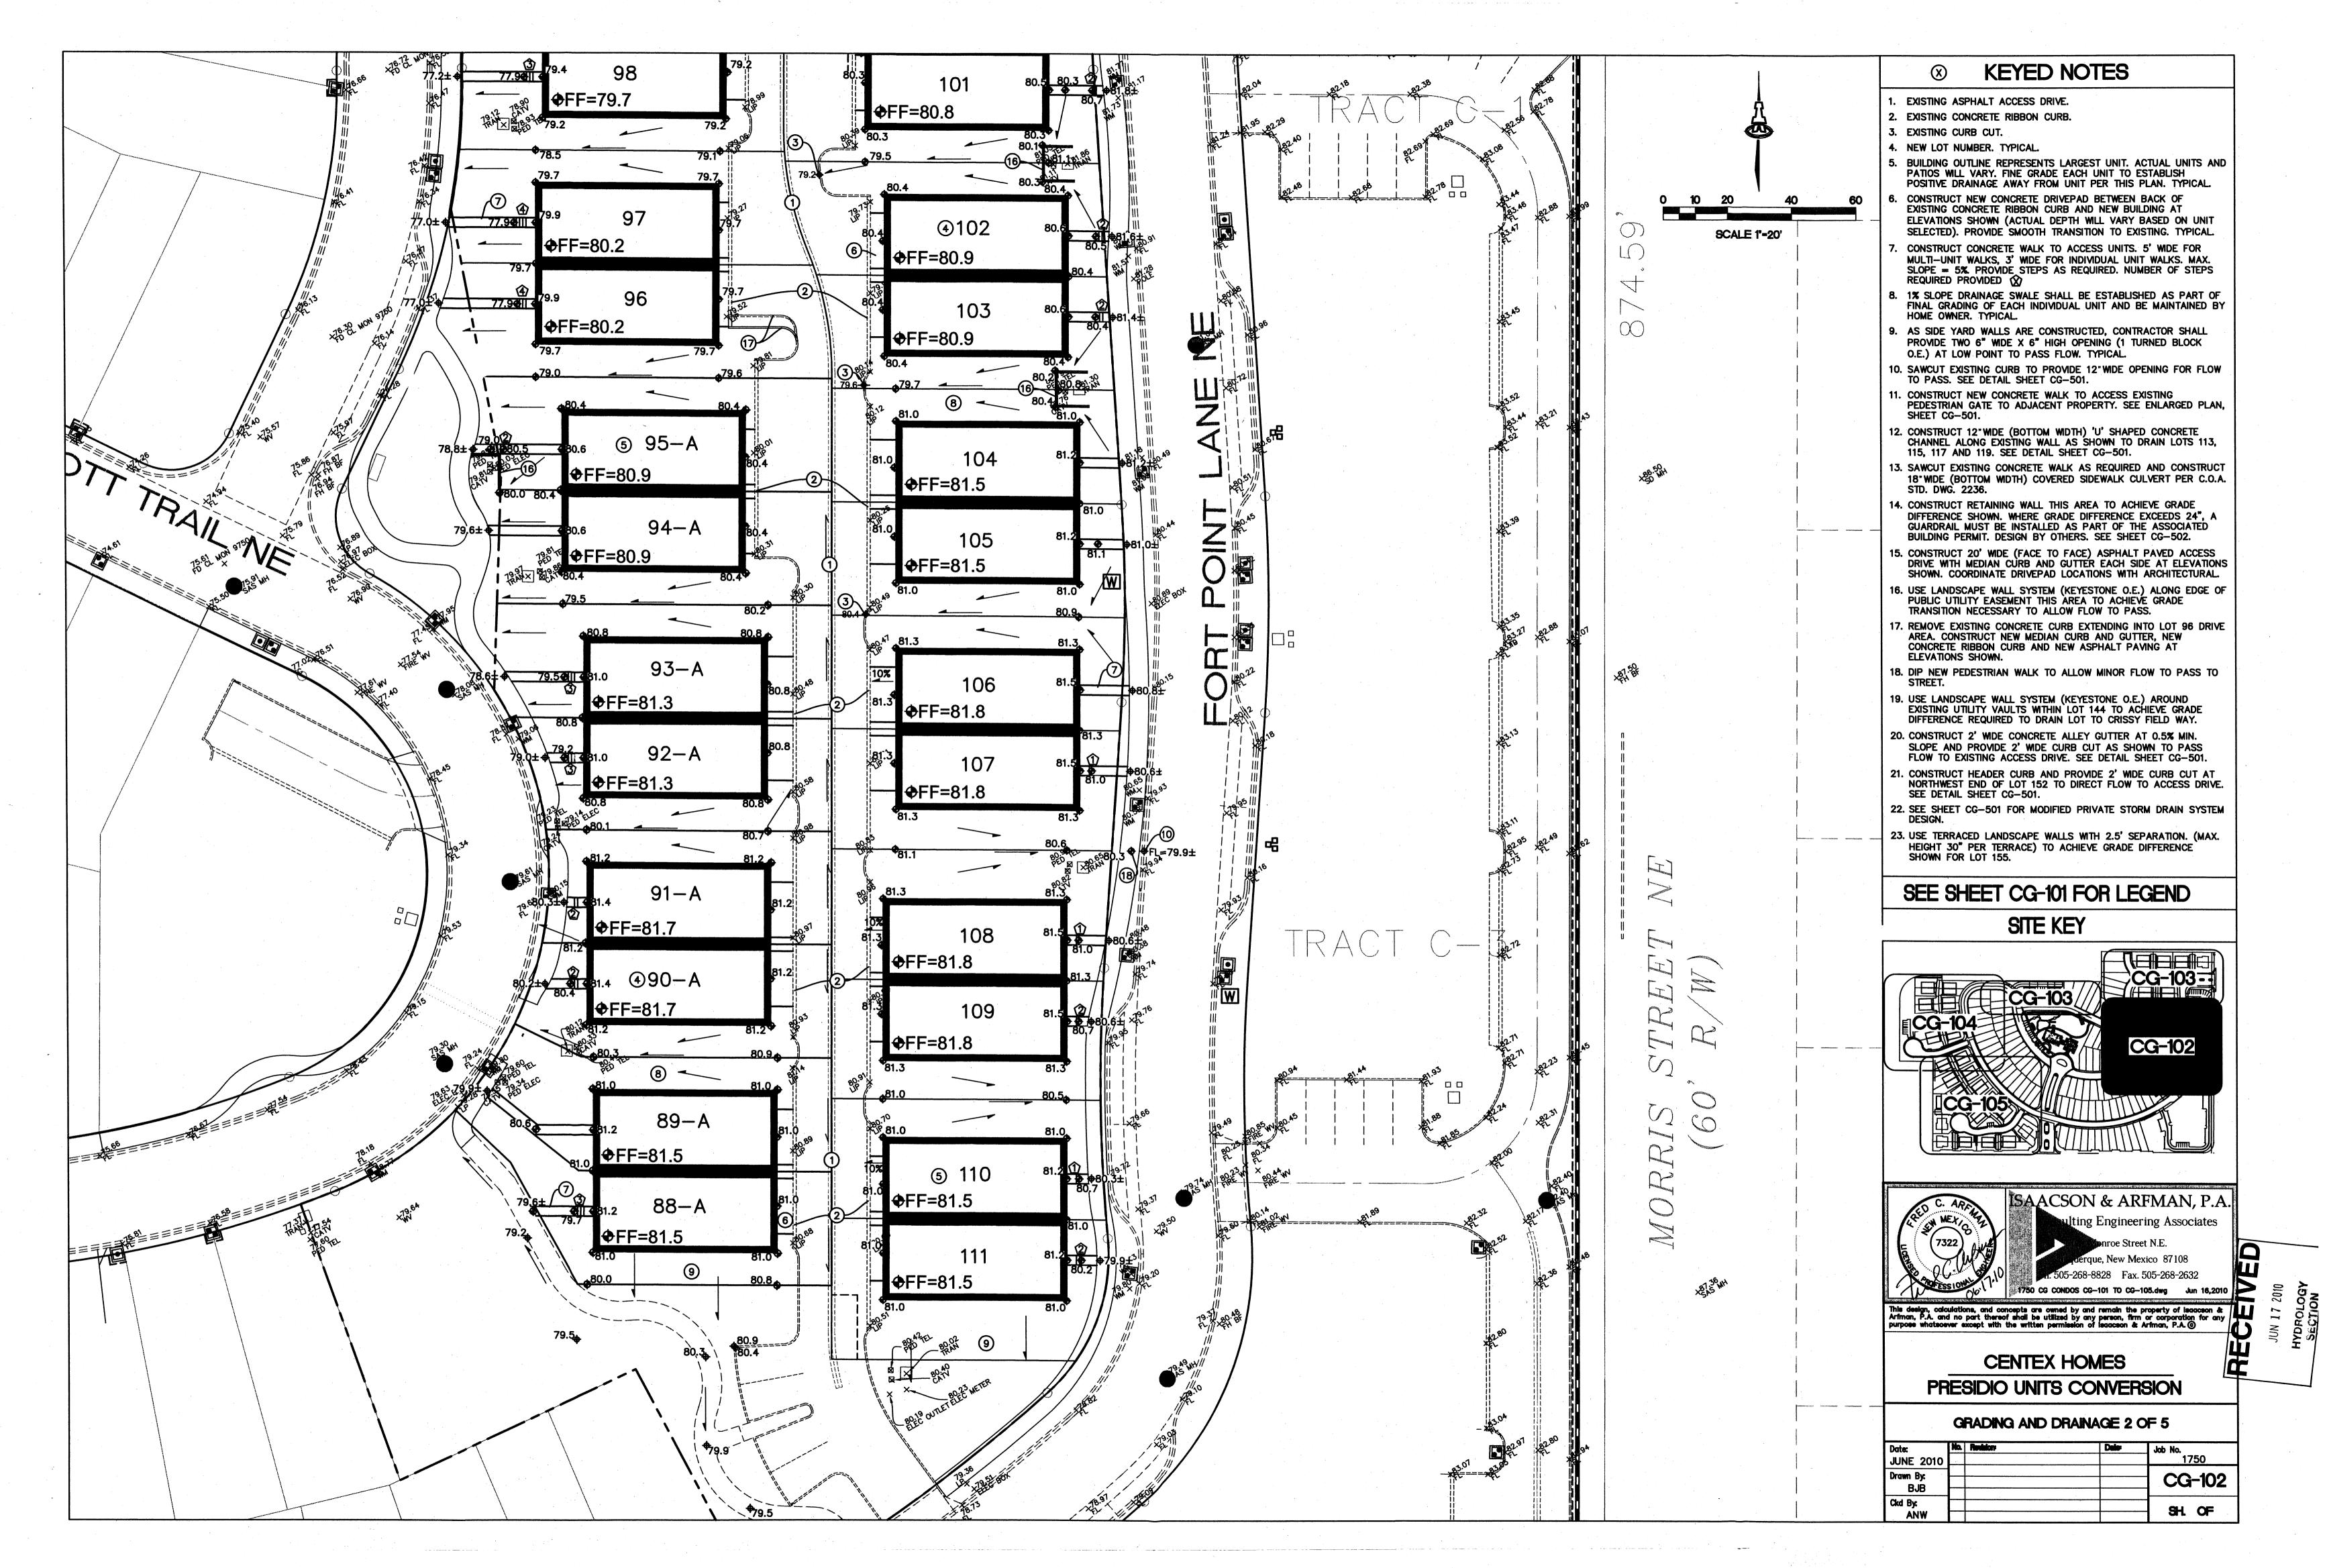


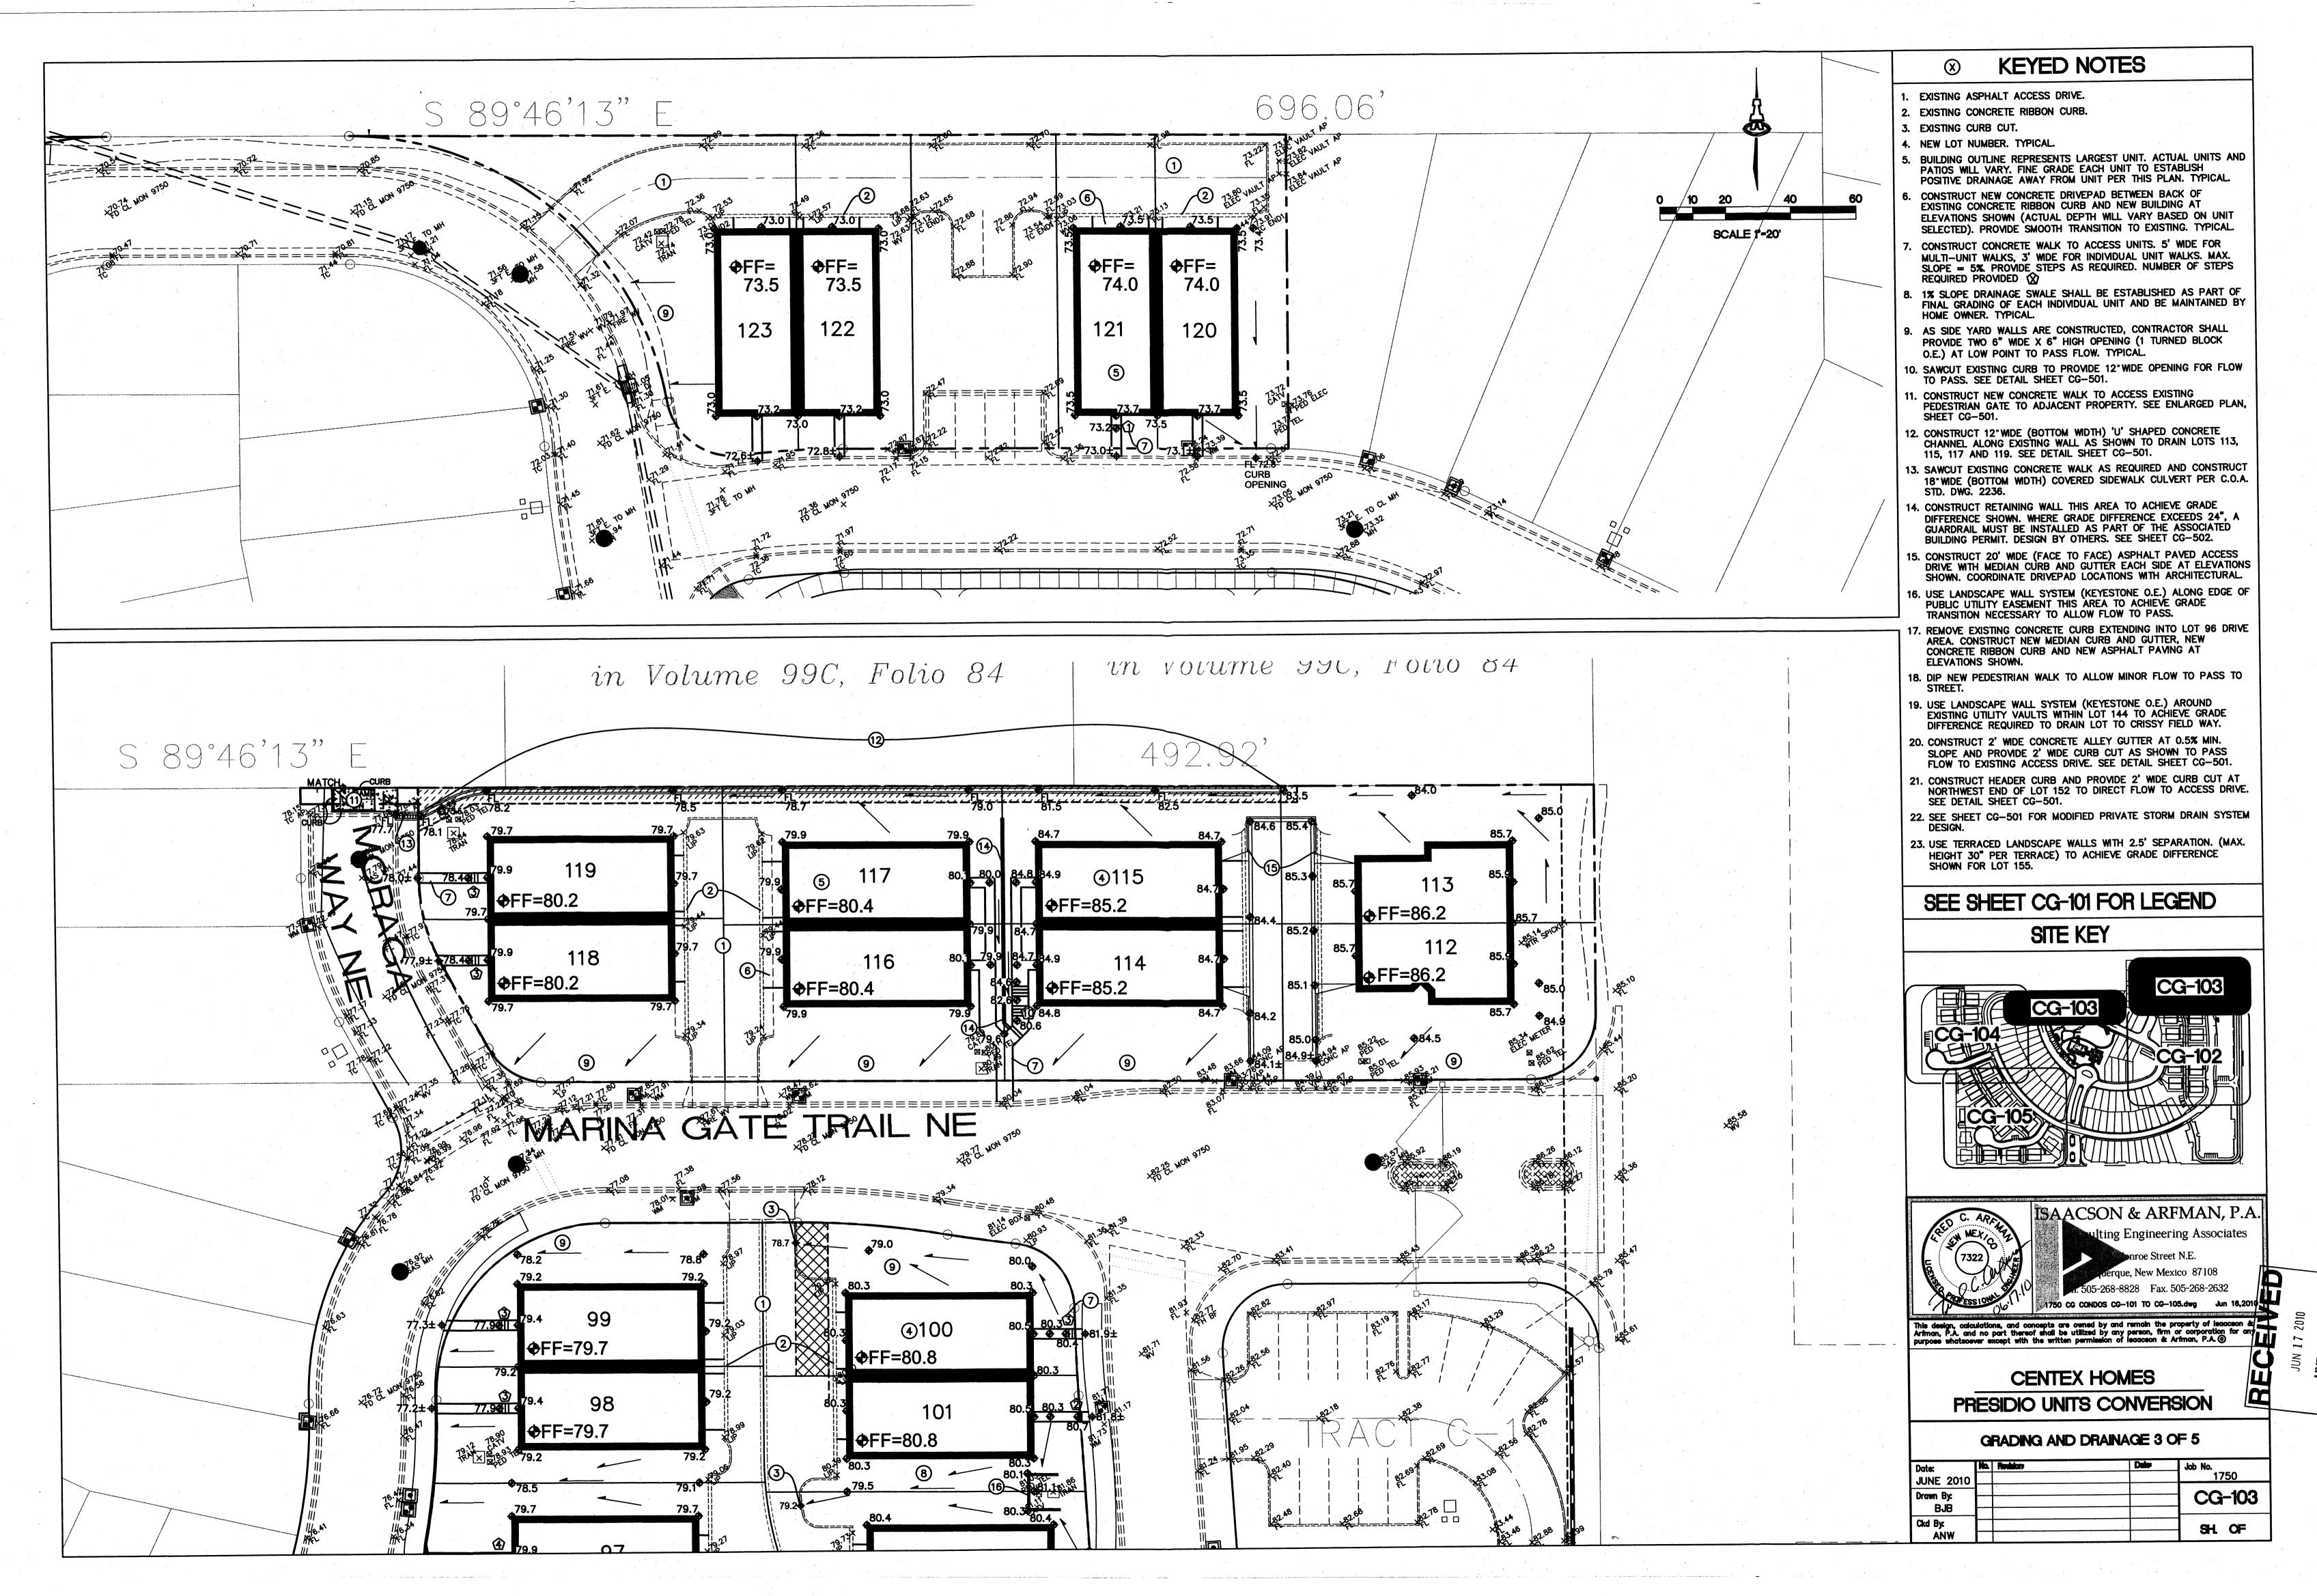

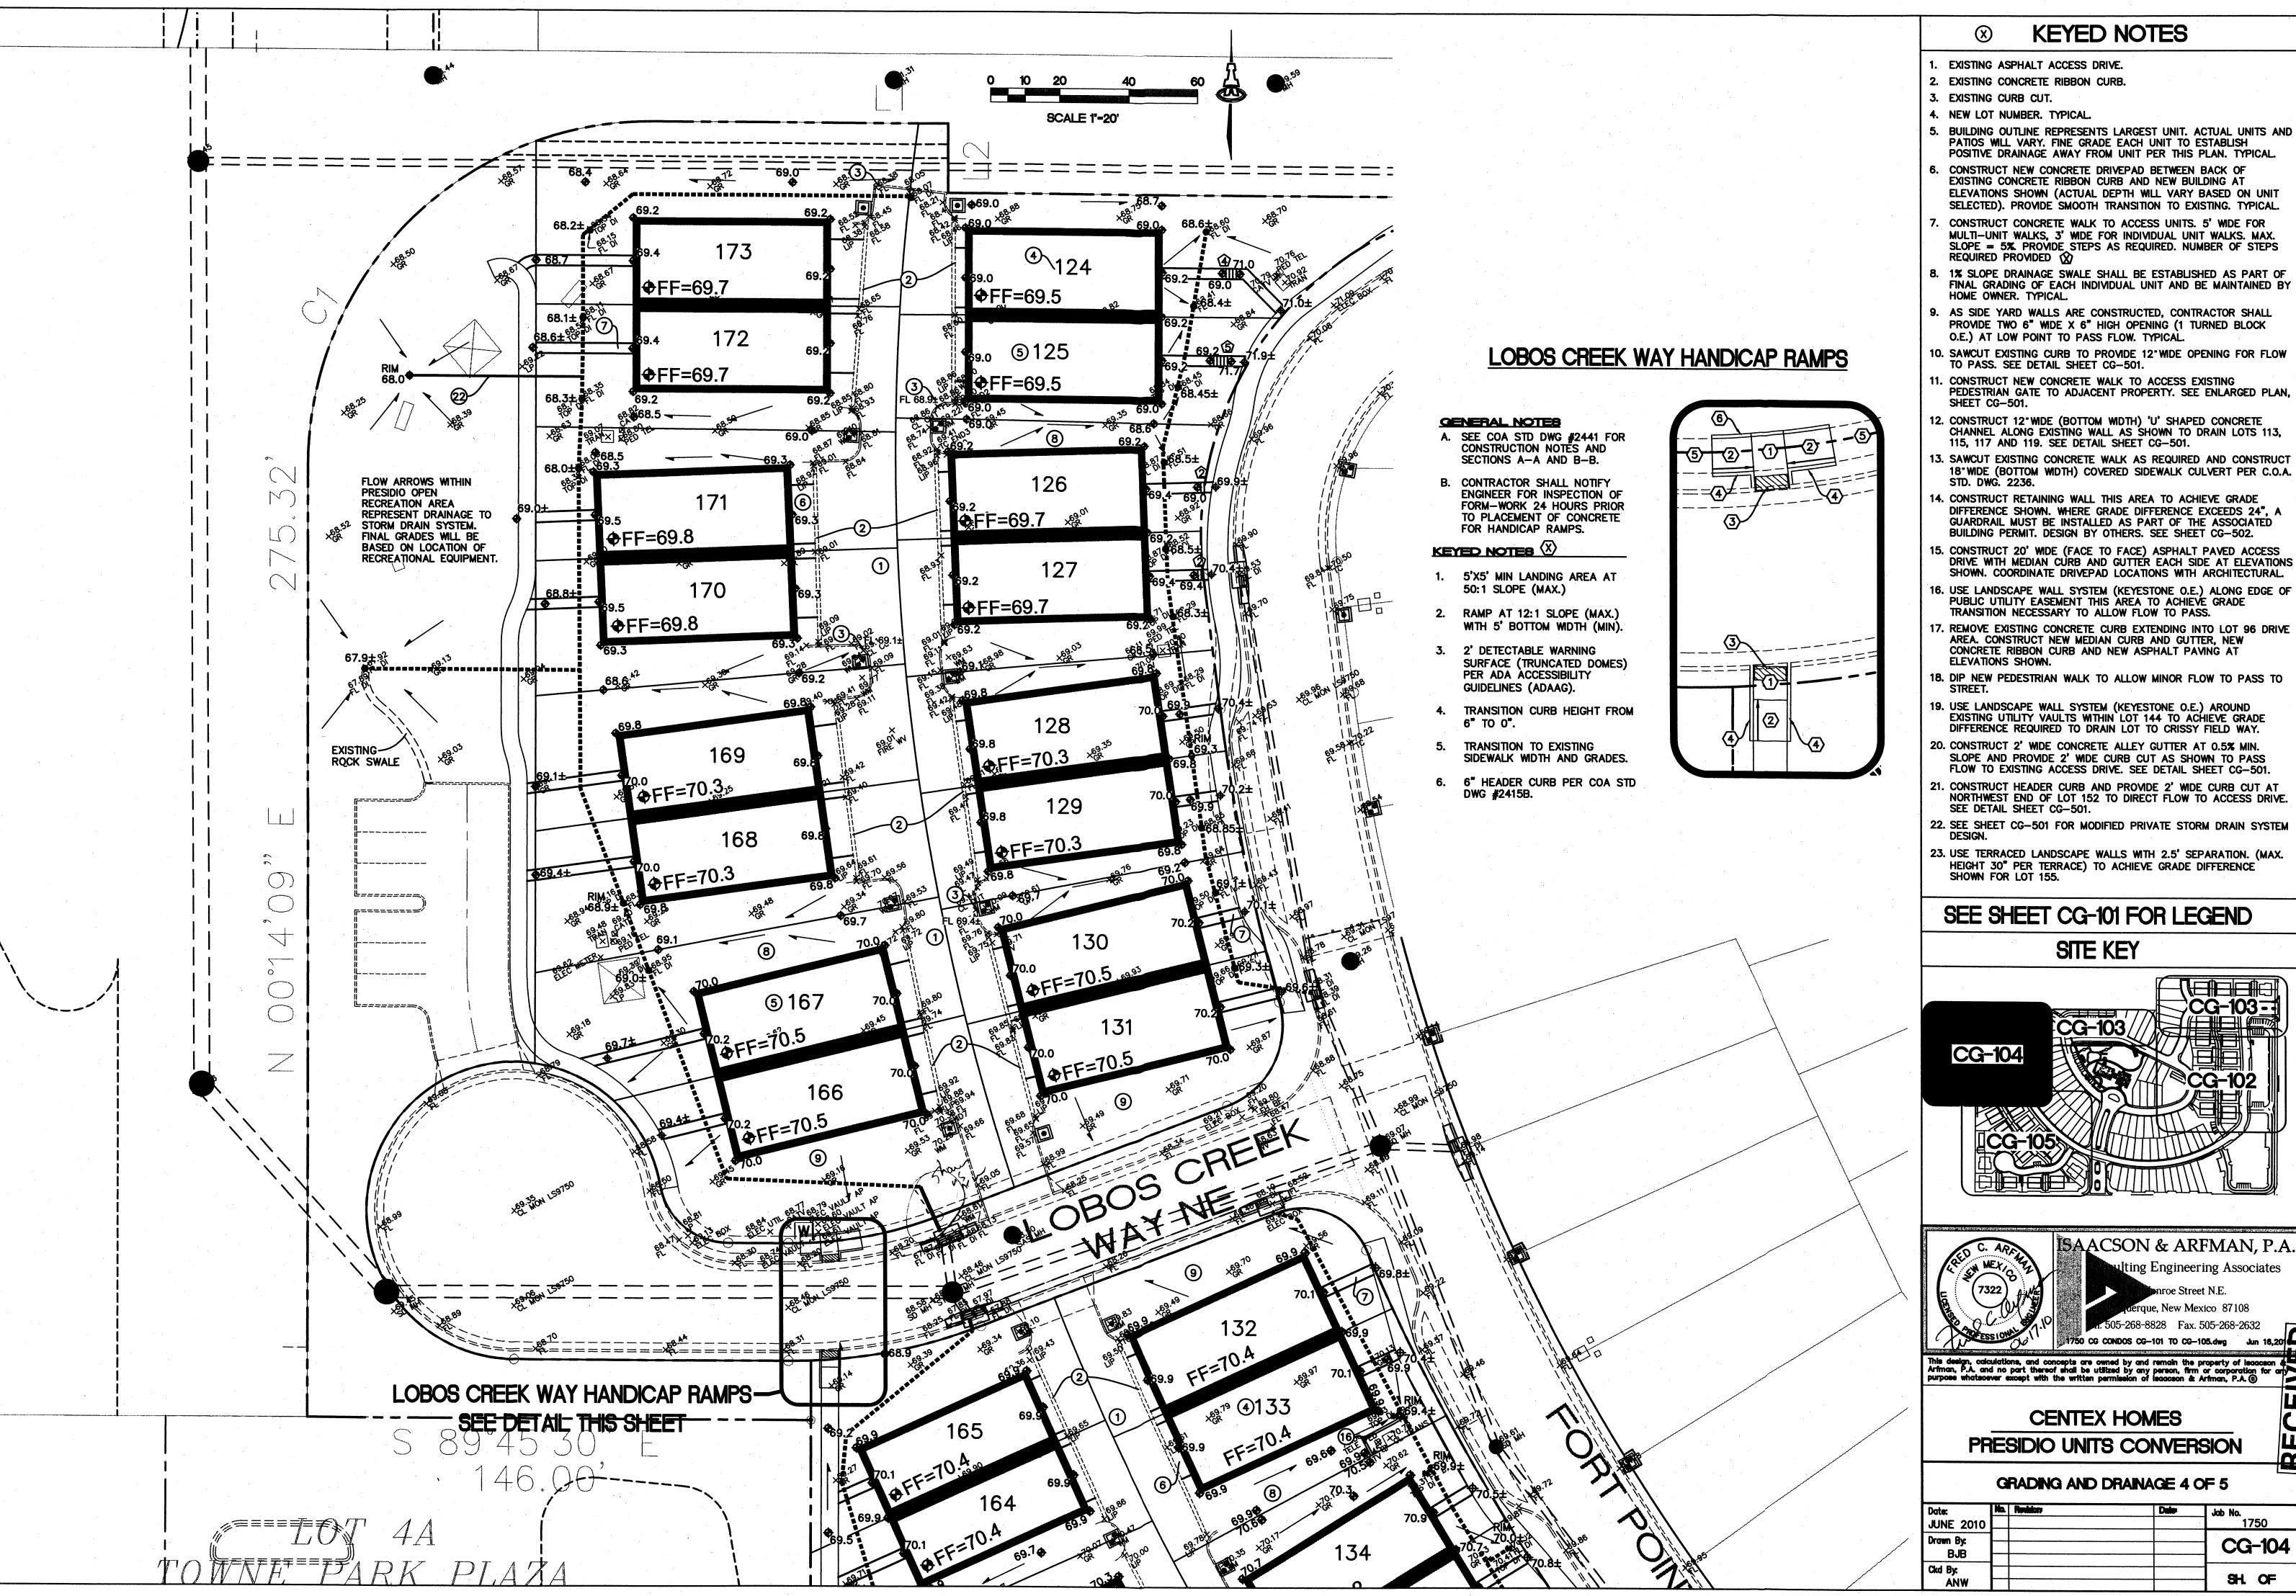


- 5. BUILDING OUTLINE REPRESENTS LARGEST UNIT. ACTUAL UNITS AND PATIOS WILL VARY. FINE GRADE EACH UNIT TO ESTABLISH
- EXISTING CONCRETE RIBBON CURB AND NEW BUILDING AT ELEVATIONS SHOWN (ACTUAL DEPTH WILL VARY BASED ON UNIT SELECTED). PROVIDE SMOOTH TRANSITION TO EXISTING. TYPICAL.
- CONSTRUCT CONCRETE WALK TO ACCESS UNITS. 5' WIDE FOR MULTI-UNIT WALKS, 3' WIDE FOR INDIVIDUAL UNIT WALKS. MAX. SLOPE = 5% PROVIDE STEPS AS REQUIRED. NUMBER OF STEPS
- 8. 1% SLOPE DRAINAGE SWALE SHALL BE ESTABLISHED AS PART OF FINAL GRADING OF EACH INDIVIDUAL UNIT AND BE MAINTAINED BY
- PROVIDE TWO 6" WIDE X 6" HIGH OPENING (1 TURNED BLOCK
- PEDESTRIAN GATE TO ADJACENT PROPERTY. SEE ENLARGED PLAN,
- 18" WIDE (BOTTOM WIDTH) COVERED SIDEWALK CULVERT PER C.O.A.
- DIFFERENCE SHOWN. WHERE GRADE DIFFERENCE EXCEEDS 24", A GUARDRAIL MUST BE INSTALLED AS PART OF THE ASSOCIATED BUILDING PERMIT. DESIGN BY OTHERS. SEE SHEET CG-502.
- SHOWN. COORDINATE DRIVEPAD LOCATIONS WITH ARCHITECTURAL.
- 17. REMOVE EXISTING CONCRETE CURB EXTENDING INTO LOT 96 DRIVE
- 18. DIP NEW PEDESTRIAN WALK TO ALLOW MINOR FLOW TO PASS TO
- EXISTING UTILITY VAULTS WITHIN LOT 144 TO ACHIEVE GRADE
- SLOPE AND PROVIDE 2' WIDE CURB CUT AS SHOWN TO PASS FLOW TO EXISTING ACCESS DRIVE. SEE DETAIL SHEET CG-501.
- NORTHWEST END OF LOT 152 TO DIRECT FLOW TO ACCESS DRIVE.
- 23. USE TERRACED LANDSCAPE WALLS WITH 2.5' SEPARATION. (MAX.
- HEIGHT 30" PER TERRACE) TO ACHIEVE GRADE DIFFERENCE SHOWN FOR LOT 155.

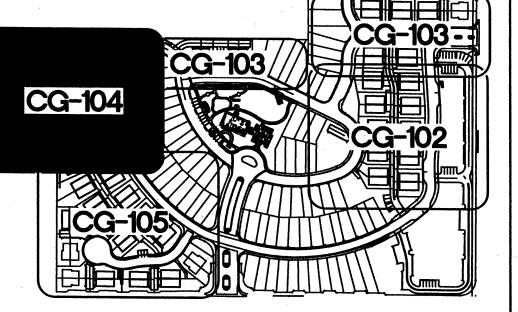


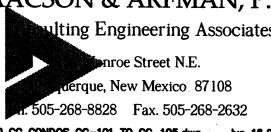


	Date:	No.	Revisions	Dale	Job No.
	JUNE 2010				1750
, .	Drawn By:				00.404
	BJB				CG-104
	Ckd By:				<b>—</b>
	ANW	-			- I SHL OF

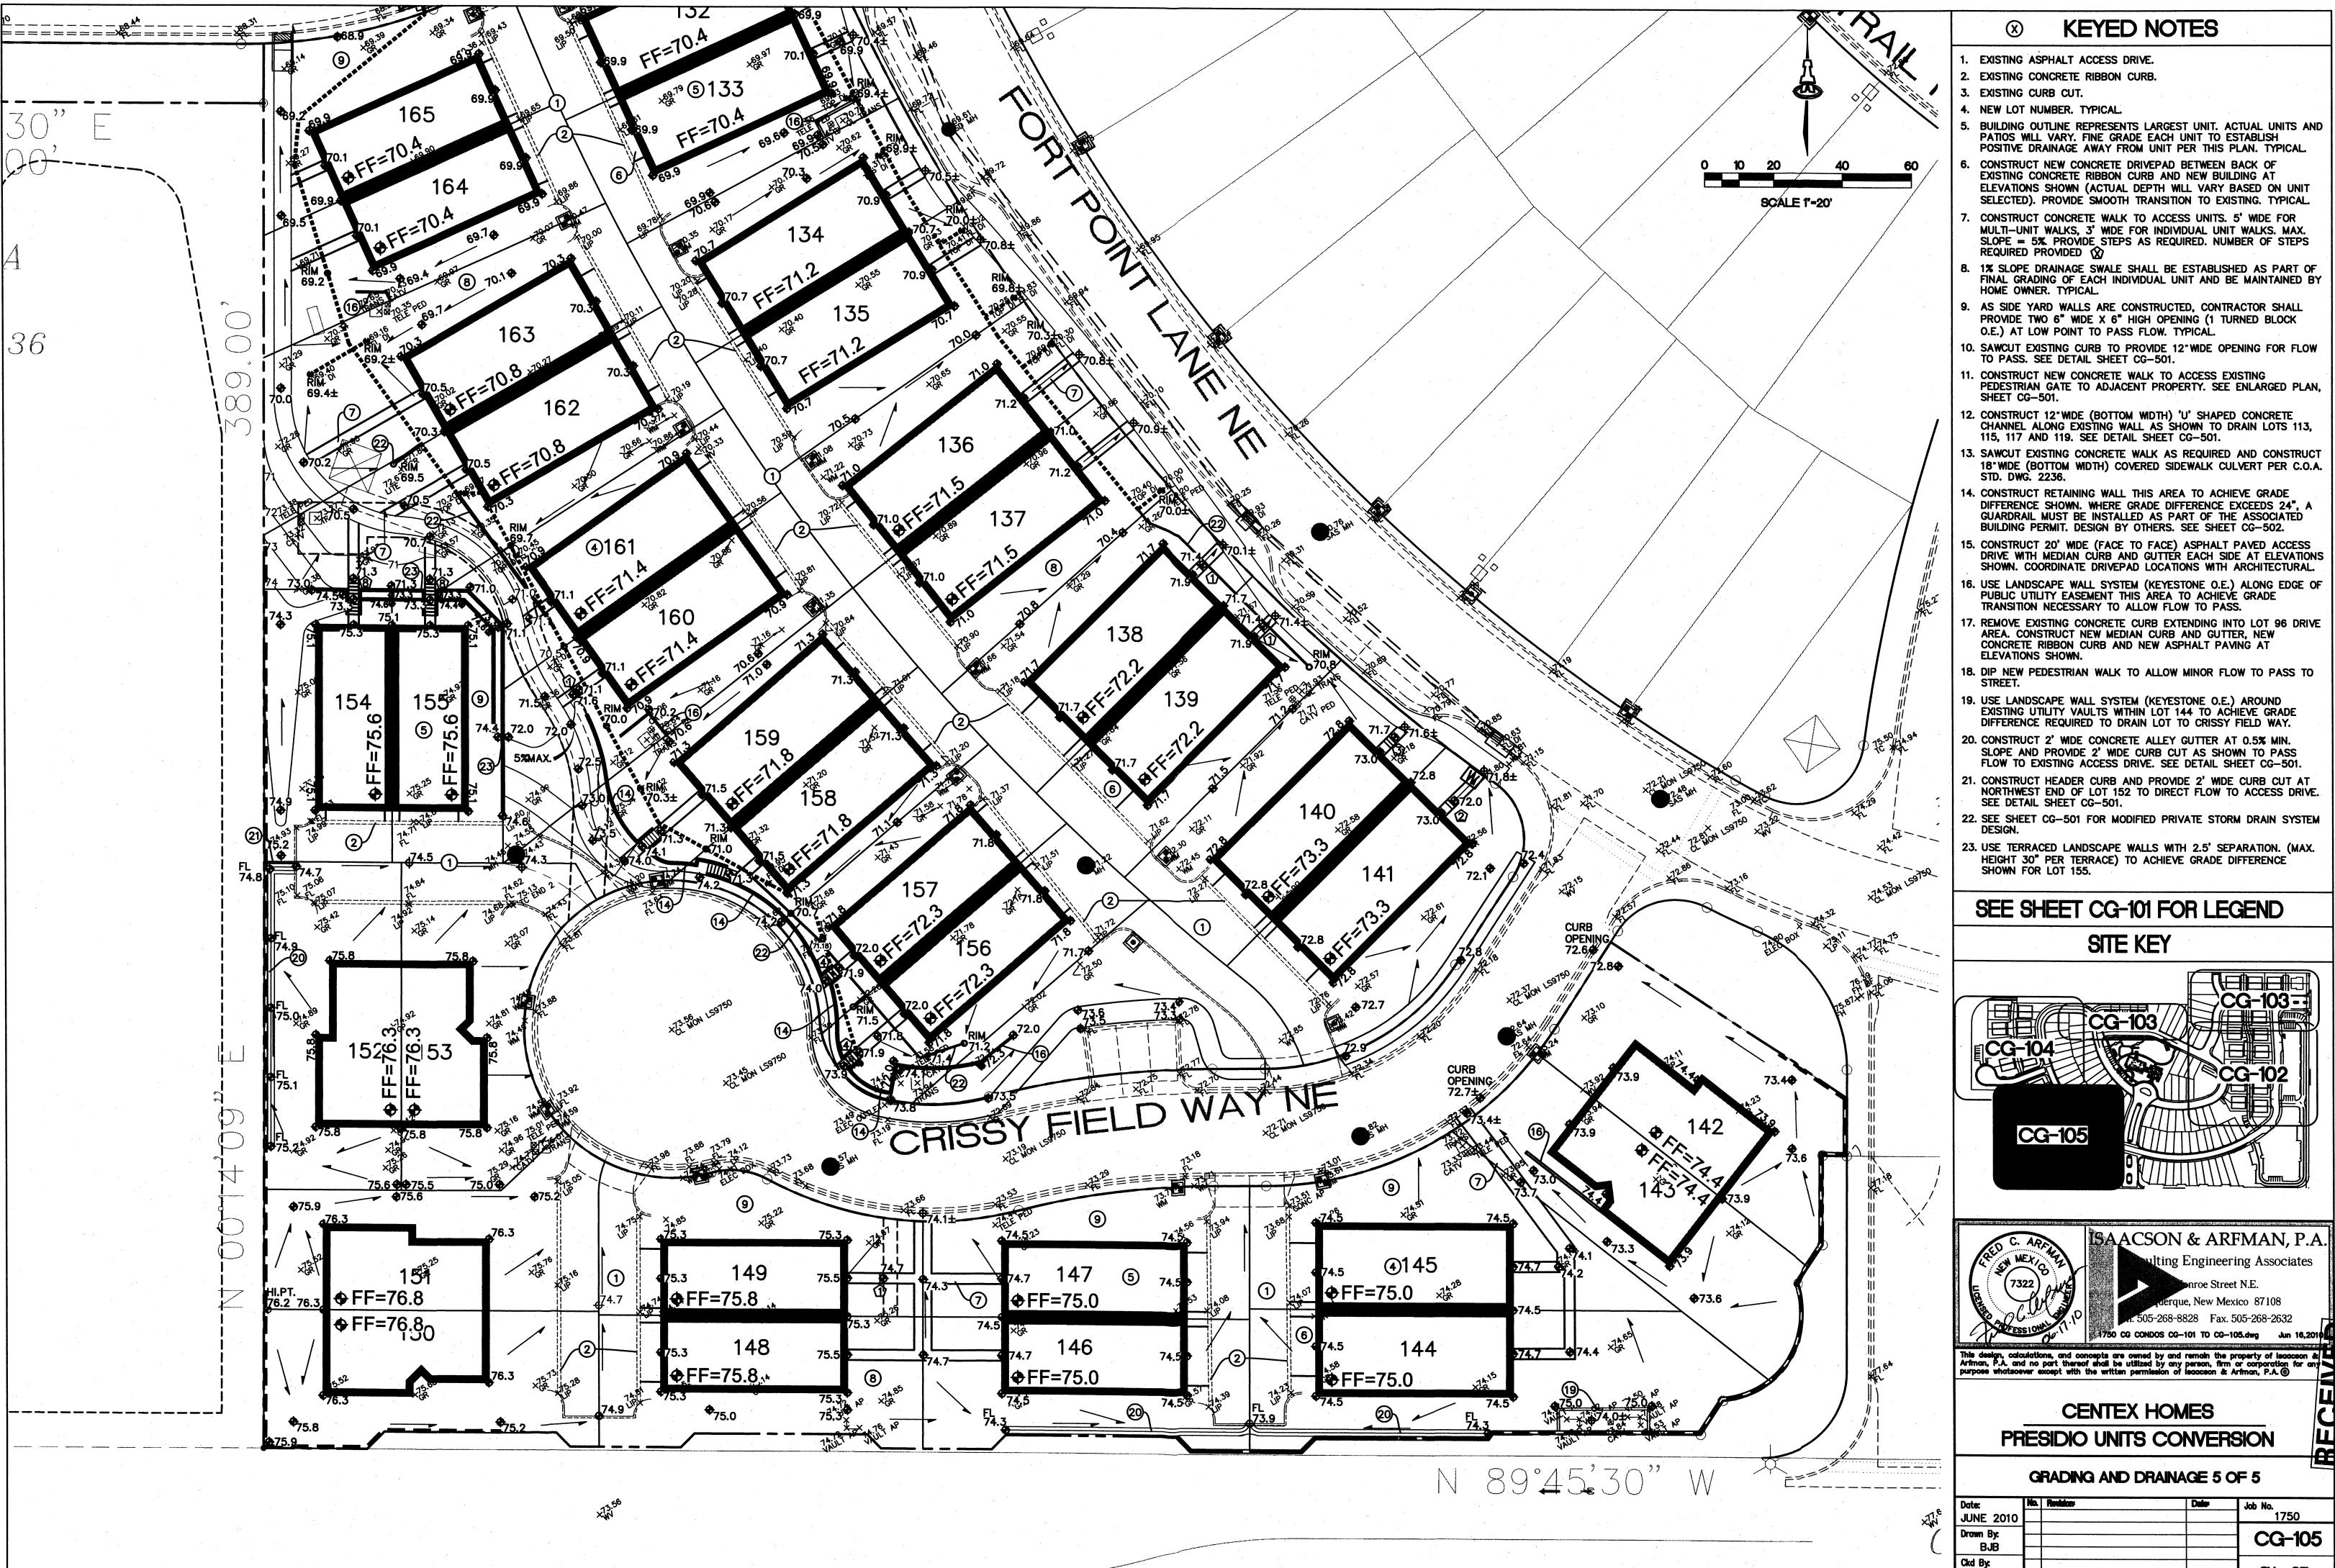


Date:	No.	Reddon	Date	Job No.
JUNE 2010				1750
Drawn By:	$\square$			CG-105
BJB	$\vdash$			
Ckd By:			<u></u>	
ANW				- SH. OF

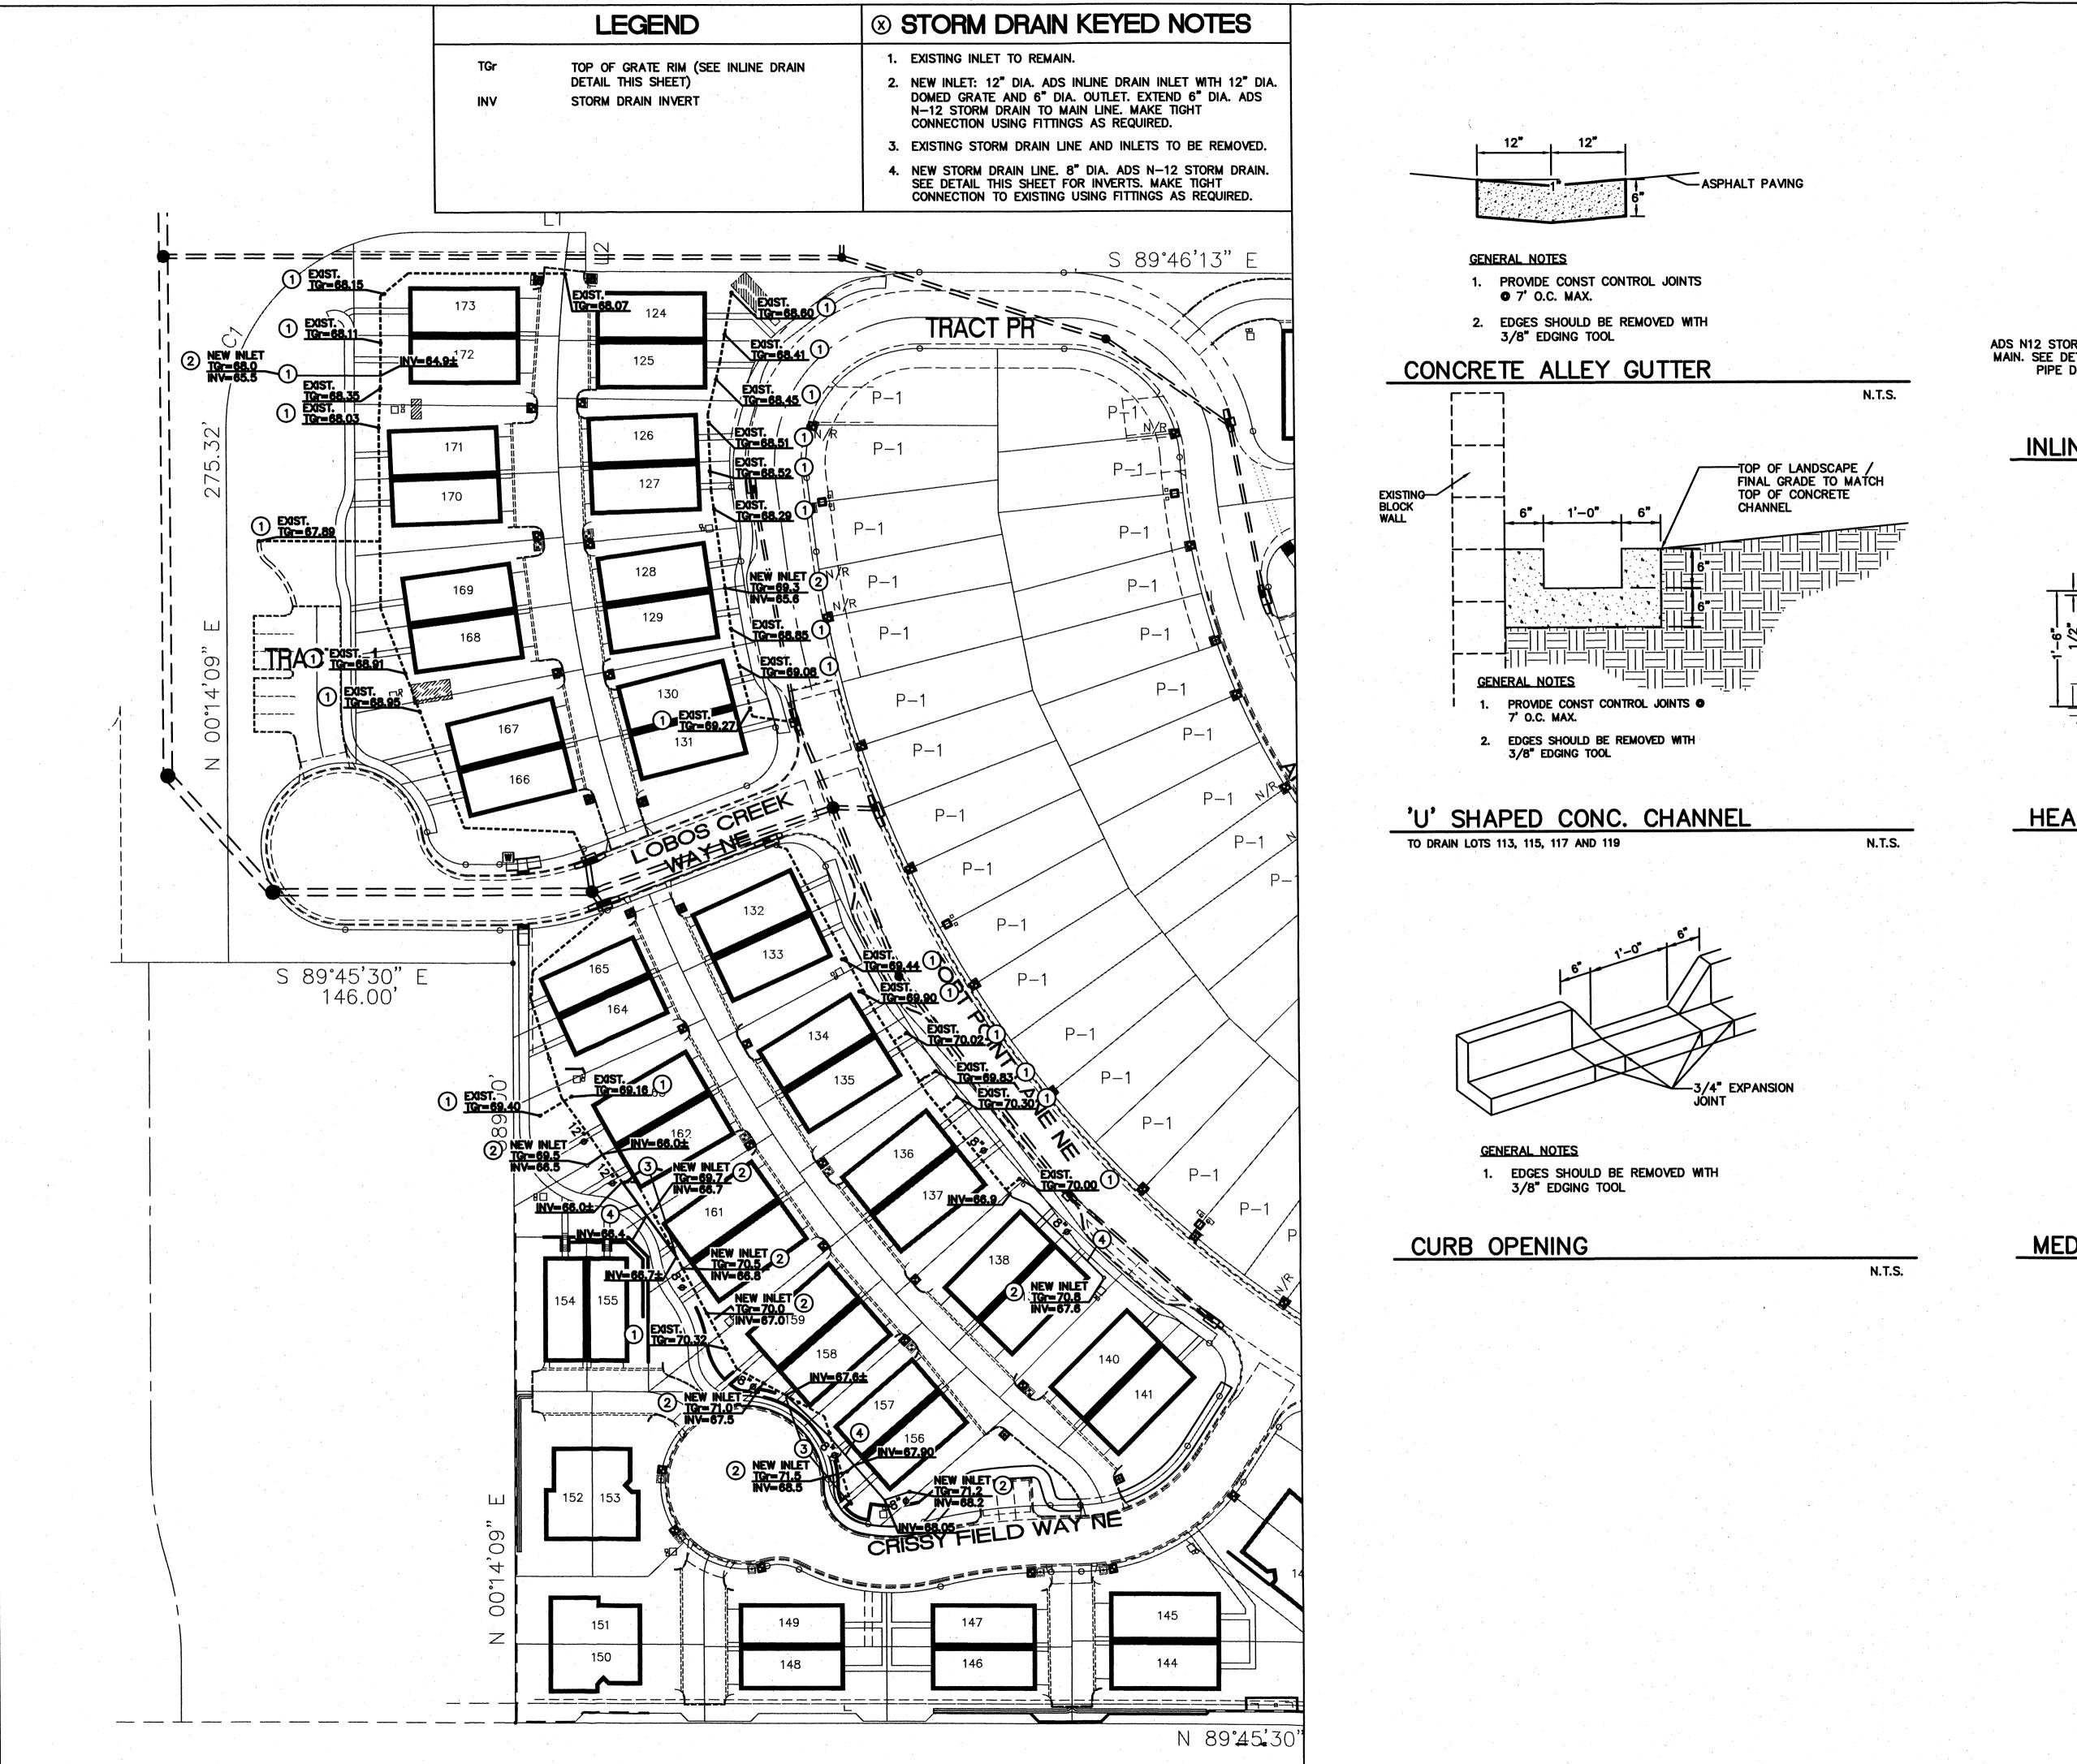

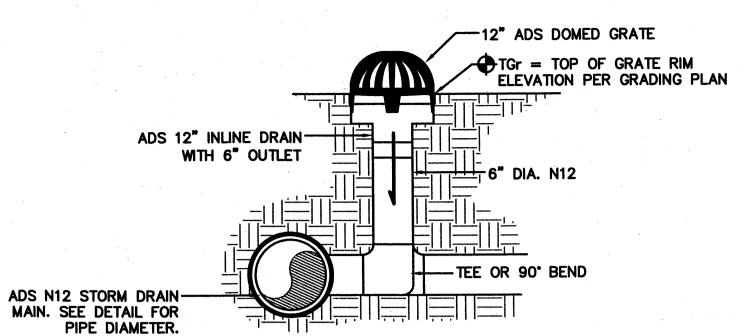

INLINE DRAIN

N.T.S.

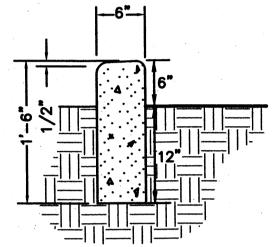

GENERAL NOTES

PROVIDE CONST CONTROL JOINTS • 7' O.C. MAX.


2. EDGES SHOULD BE REMOVED WITH 3/8" EDGING TOOL

HEADER CURB

N.T.S.

MEDIAN CURB

N.T.S.

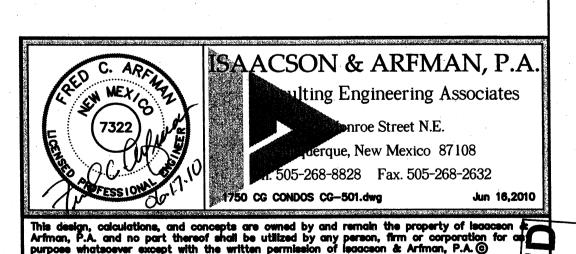


CENTEX HOMES PRESIDIO UNITS CONVERSION

STORM DRAIN, GRADING AND DRAINAGE DETAIL

Date:	No.	Reddon	Date	Job No.
JUNE 2010				1750
Drawn By:				- CC-501
BJB	<u> </u>			CG-501
Ckd By:	$\vdash$			SH OF
FCA				


1"=20'

WALL #2 ELEVATIONS

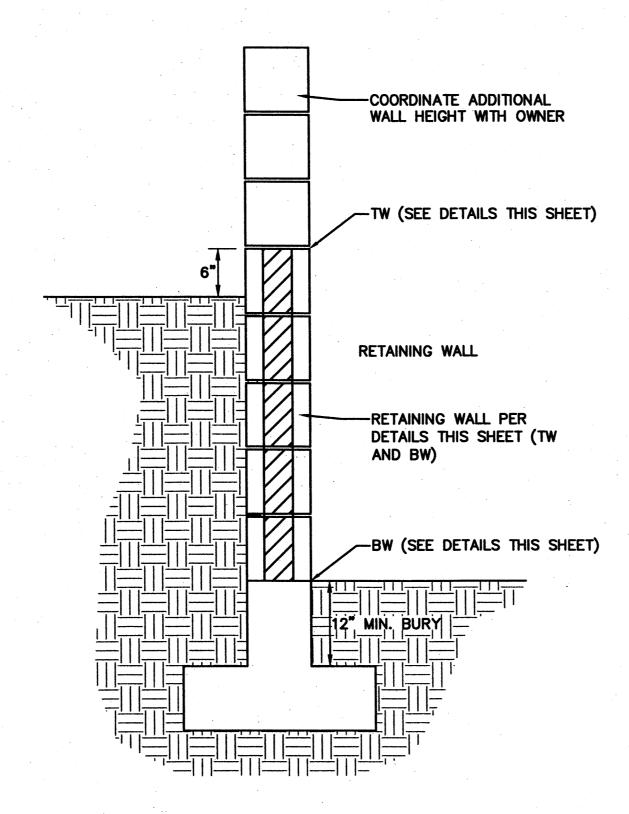


TYPICAL RETAINING WALL SECTION

1"=20"

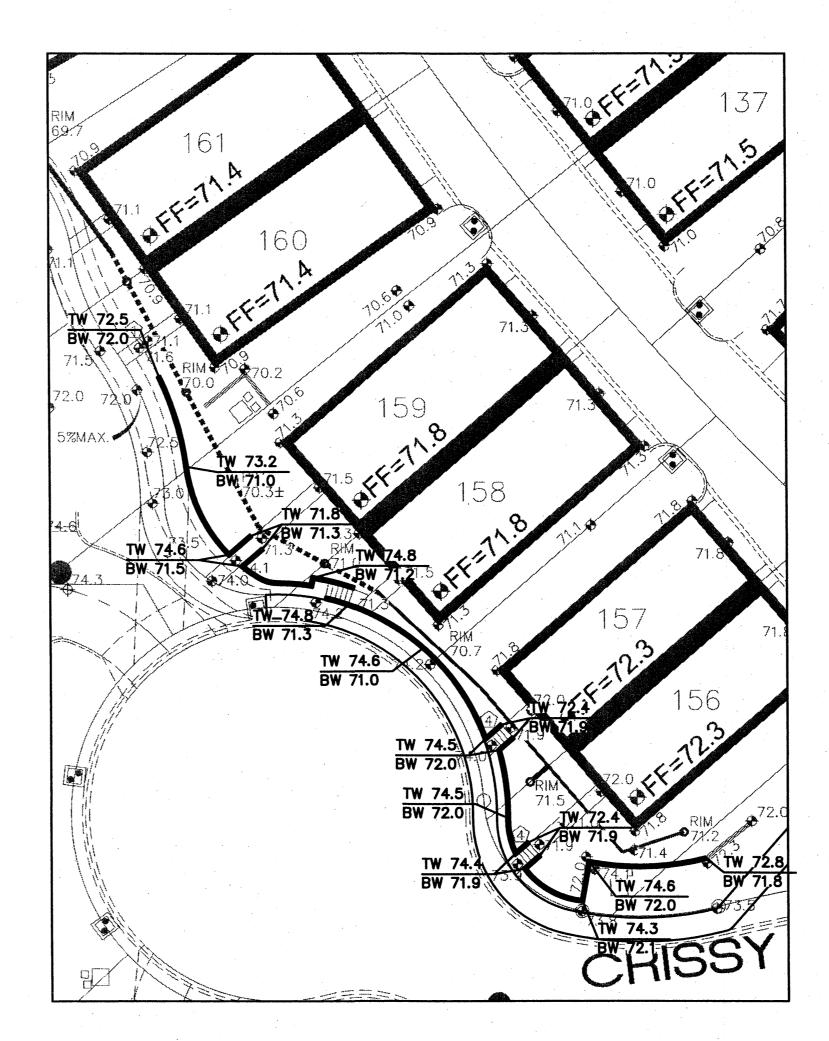

## WALL #2 ELEVATIONS

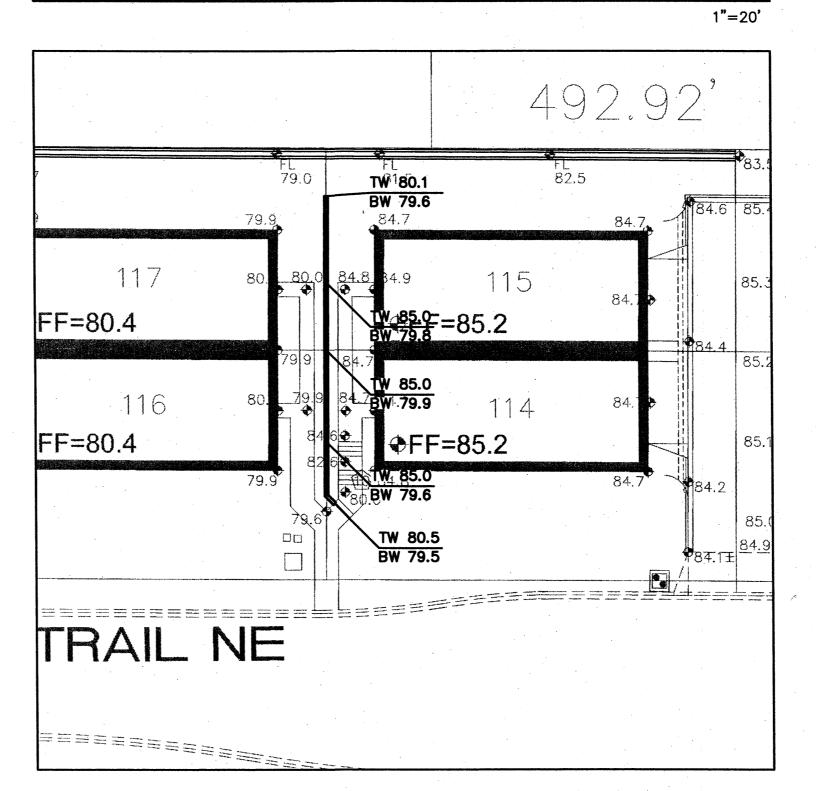


1"=20'


WALL #3 ELEVATIONS

## WALL NOTES

- 1. OWNER'S OPTION: RETAINING HEIGHTS LESS THAN 30" MAY RETAIN AGAINST STACKED LANDSCAPE WALL SYSTEM INSTALLED PER MANUFACTURER'S SPECIFICATIONS AND DETAILS.
- 2. RETAINING HEIGHTS GREATER THAN 30" REQUIRE RETAINING WALL (STRUCTURAL DESIGN BY OTHERS).
- 3. WALLS SHALL NOT BE BACKFILLED UNTIL AT LEAST 7 DAYS
  AFTER PLACING OF FINAL GROUT LEVEL. WHERE HEAVY
  EQUIPMENT IS USED NEAR RETAINING WALLS, SUCH EQUIPMENT
  SHOULD NOT APPROACH CLOSER TO THE TOP OF THE WALL
  THAN A DISTANCE EQUAL TO THE HEIGHT OF THE WALL. CARE
  SHOULD BE TAKEN TO AVOID EXERTING IMPACT FORCES ON THE
  WALL AS COULD BE CAUSED BY A LARGE MASS OF MOVING
  EARTH OR EQUIPMENT.
- 4. VERTICAL EXPANSION JOINTS WITH CLOSED CELL INSERTS SHALL BE PLACED AT INTERVALS NOT TO EXCEED 20'-0" ON CENTER.
- 5. OMISSION OF A VERTICAL MORTAR JOINT ON FIRST COURSE AT 32" O.C. SHALL BE USED FOR WEEP HOLES.

## RETAINING WALL KEY

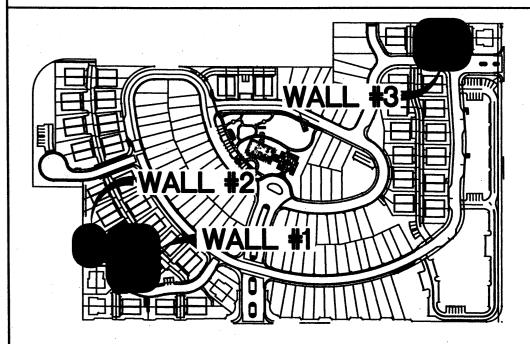

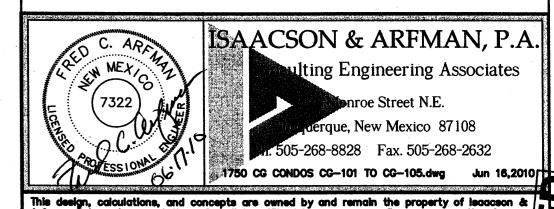

CENTEX HOMES

PRESIDIO UNITS CONVERSION

RETAINING AND GARDEN WALL ELEVATIONS

Date:	No.	Provision:		Date	Job No.
MAY 2010					1750
Drawn By:	1				G-502
BJB	$\vdash$		·		_ CG-302
Ckd By: ANW	1-				SH. OF
	$\vdash$				