CITY OF ALBUQUERQUE



Planning Department Transportation Development Services

November 9, 2015

Jeffrey Wooten, PE Wooten Engineering 1368 Reynosa Lp., SE Rio Rancho, NM 87124

Re: Weck's Restaurant 730 Juan Tabo NE

Traffic Circulation Layout

Engineer's/Architect's Stamp dated 11-2-15 (K22-D006A)

Dear Mr. Wooten,

PO Box 1293

Based upon the information provided in your submittal received 10-3-15, the above referenced plan cannot be approved for Building Permit until the following comments are addressed:

1. Identify and dimension the medians and curb cuts on Juan Tabo Blvd.

Albuquerque

2. The ADA accessible parking sign must have the required language per 66-7-352.4C NMSA 1978 "Violators Are Subject to a Fine and/or Towing." Please show detail of ADA parking sign language.

NM 87103


3. Per the DPM, a 6 ft. wide ADA accessible pedestrian pathway is required from the public sidewalk to the building entrances. Please clearly show this pathway from Juan Tabo Blvd. and provide details.

www.cabq.gov

- 4. Service vehicle and/or refuse vehicle maneuvering must be contained on-site; provide a copy of refuse approval.
- 5. Please provide a sight distance exhibit (see the *Development Process Manual*, *Chapter 23, Section 3, Part D.5 Intersection Sight Distance*). Please provide this detail for entrance/exits on Juan Tabo Blvd.

CITY OF ALBUQUERQUE



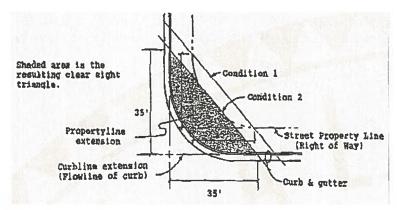

- 6. Please add the following note to the clear sight triangle: "Landscaping and signage will not interfere with clear sight requirements. Therefore, signs, walls, trees, and shrubbery between 3 and 8 feet tall (as measured from the gutter pan) will not be acceptable in this area."
- 7. Please include a copy of your shared access agreement with the adjacent property owner.

PO Box 1293

- 8. Unused curb cuts must be replaced with sidewalk and curb & gutter. A build note must be provided referring to the appropriate City Standard drawing.
- 9. Please include two copies of the traffic circulation layout at the next submittal.

Albuquerque

Resubmit acceptable package along with fully completed Drainage Transportation Information Sheet to front counter personnel for log in and evaluation by Transportation. If you have any questions, please contact Gary Sandoval (505) 924-3675 or me at 924-3991.

www.cabq.gov

NM 87103

Sincerely,

Racquel M. Michel, P.E.

Traffic Engineer, Planning Dept. Development Review Services

\gs via: email C: CO Clerk, File



City of Albuquerque


Planning Department


Development & Building Services Division

DRAINAGE AND TRANSPORTATION INFORMATION SHEET (REV 09/2015)

Project Title: Weck's Restaurant		Building Permit #:	City	Drainage #: K22D006A		
DRB#:	EPC#:		Work Order#:			
Legal Description: Monarch Village, Parcel 1-B						
City Address: 730 Juan Tabo Blvd NE						
Engineering Firm: Wooten Engineering			Contact: Jeffrey T	. Wooten, P.E.		
Address: 1368 Reynosa Loop SE, Rio Rancho, N		***				
	en o bita		E-mail: jeffwooter	n.pe@gmail.com		
Owner:			Contact			
Address		••••	Contact.			
Charles to the control of the contro	Fax#:		E-mail:			
1 Holler.	Ι'αλπ.		-			
Architect: Bill Burk III, Architect			Contact: Bill Burk			
Address: 9617 La Playa NE, Albuquerque, NM 8			<u> </u>			
Phone#: 505-292-6566	Fax#: N/A		E-mail: billburk@	qwestoffice.net		
Other Contact:			Contact:			
Address:						
Phone#:	Fax#:		E-mail:			
Check all that Apply: DEPARTMENT: HYDROLOGY/ DRAINAGE X TRAFFIC/ TRANSPORTATION MS4/ EROSION & SEDIMENT CONTROL	L	X BUILDING P	CHECK TYPE OF APPROVAL/ACCEPTANCE SOUGHT: **EDILDING PERMIT APPROVAL** CERTIFICATE OF OCCUPANCY			
TYPE OF SUBMITTAL:		PRELIMINA	RY PLAT APPROV	JAI.		
ENGINEER/ ARCHITECT CERTIFICATIO	N		FOR SUB'D APPRO			
CONCEPTUAL G & D PLAN GRADING PLAN DRAINAGE MASTER PLAN DRAINAGE REPORT CLOMR/LOMR		FOUNDATIO	APPROVAL SE OF FINANCIAL ON PERMIT APPROVAL	GUARANTEE OVAL		
X TRAFFIC CIRCULATION LAYOUT (TCL TRAFFIC IMPACT STUDY (TIS) EROSION & SEDIMENT CONTROL PLA	,	SO-19 APPR PAVING PEI GRADING/ P WORK ORDE CLOMR/LON	RMIT APPROVAL AD CERTIFICAT R APPROVAL	ECEIVE NEV 0 3 2015		
OTHER (SPECIFY)		PRE-DESIGN OTHER (SPI	MEETING ECIFY)	LAND DEVELOPMENT SECTION		
IS THIS A RESUBMITTAL?:Yes X	No					
DATE SUBMITTED: <u>11/3/2015</u>	By: Jeffrey T.	Wooten, P.E.				
				77.77.77.77.77.77.77.77.77.77.77.77.77.		

COA STAFF: ELECTRONIC SUBMITTAL RECEIVED: ____

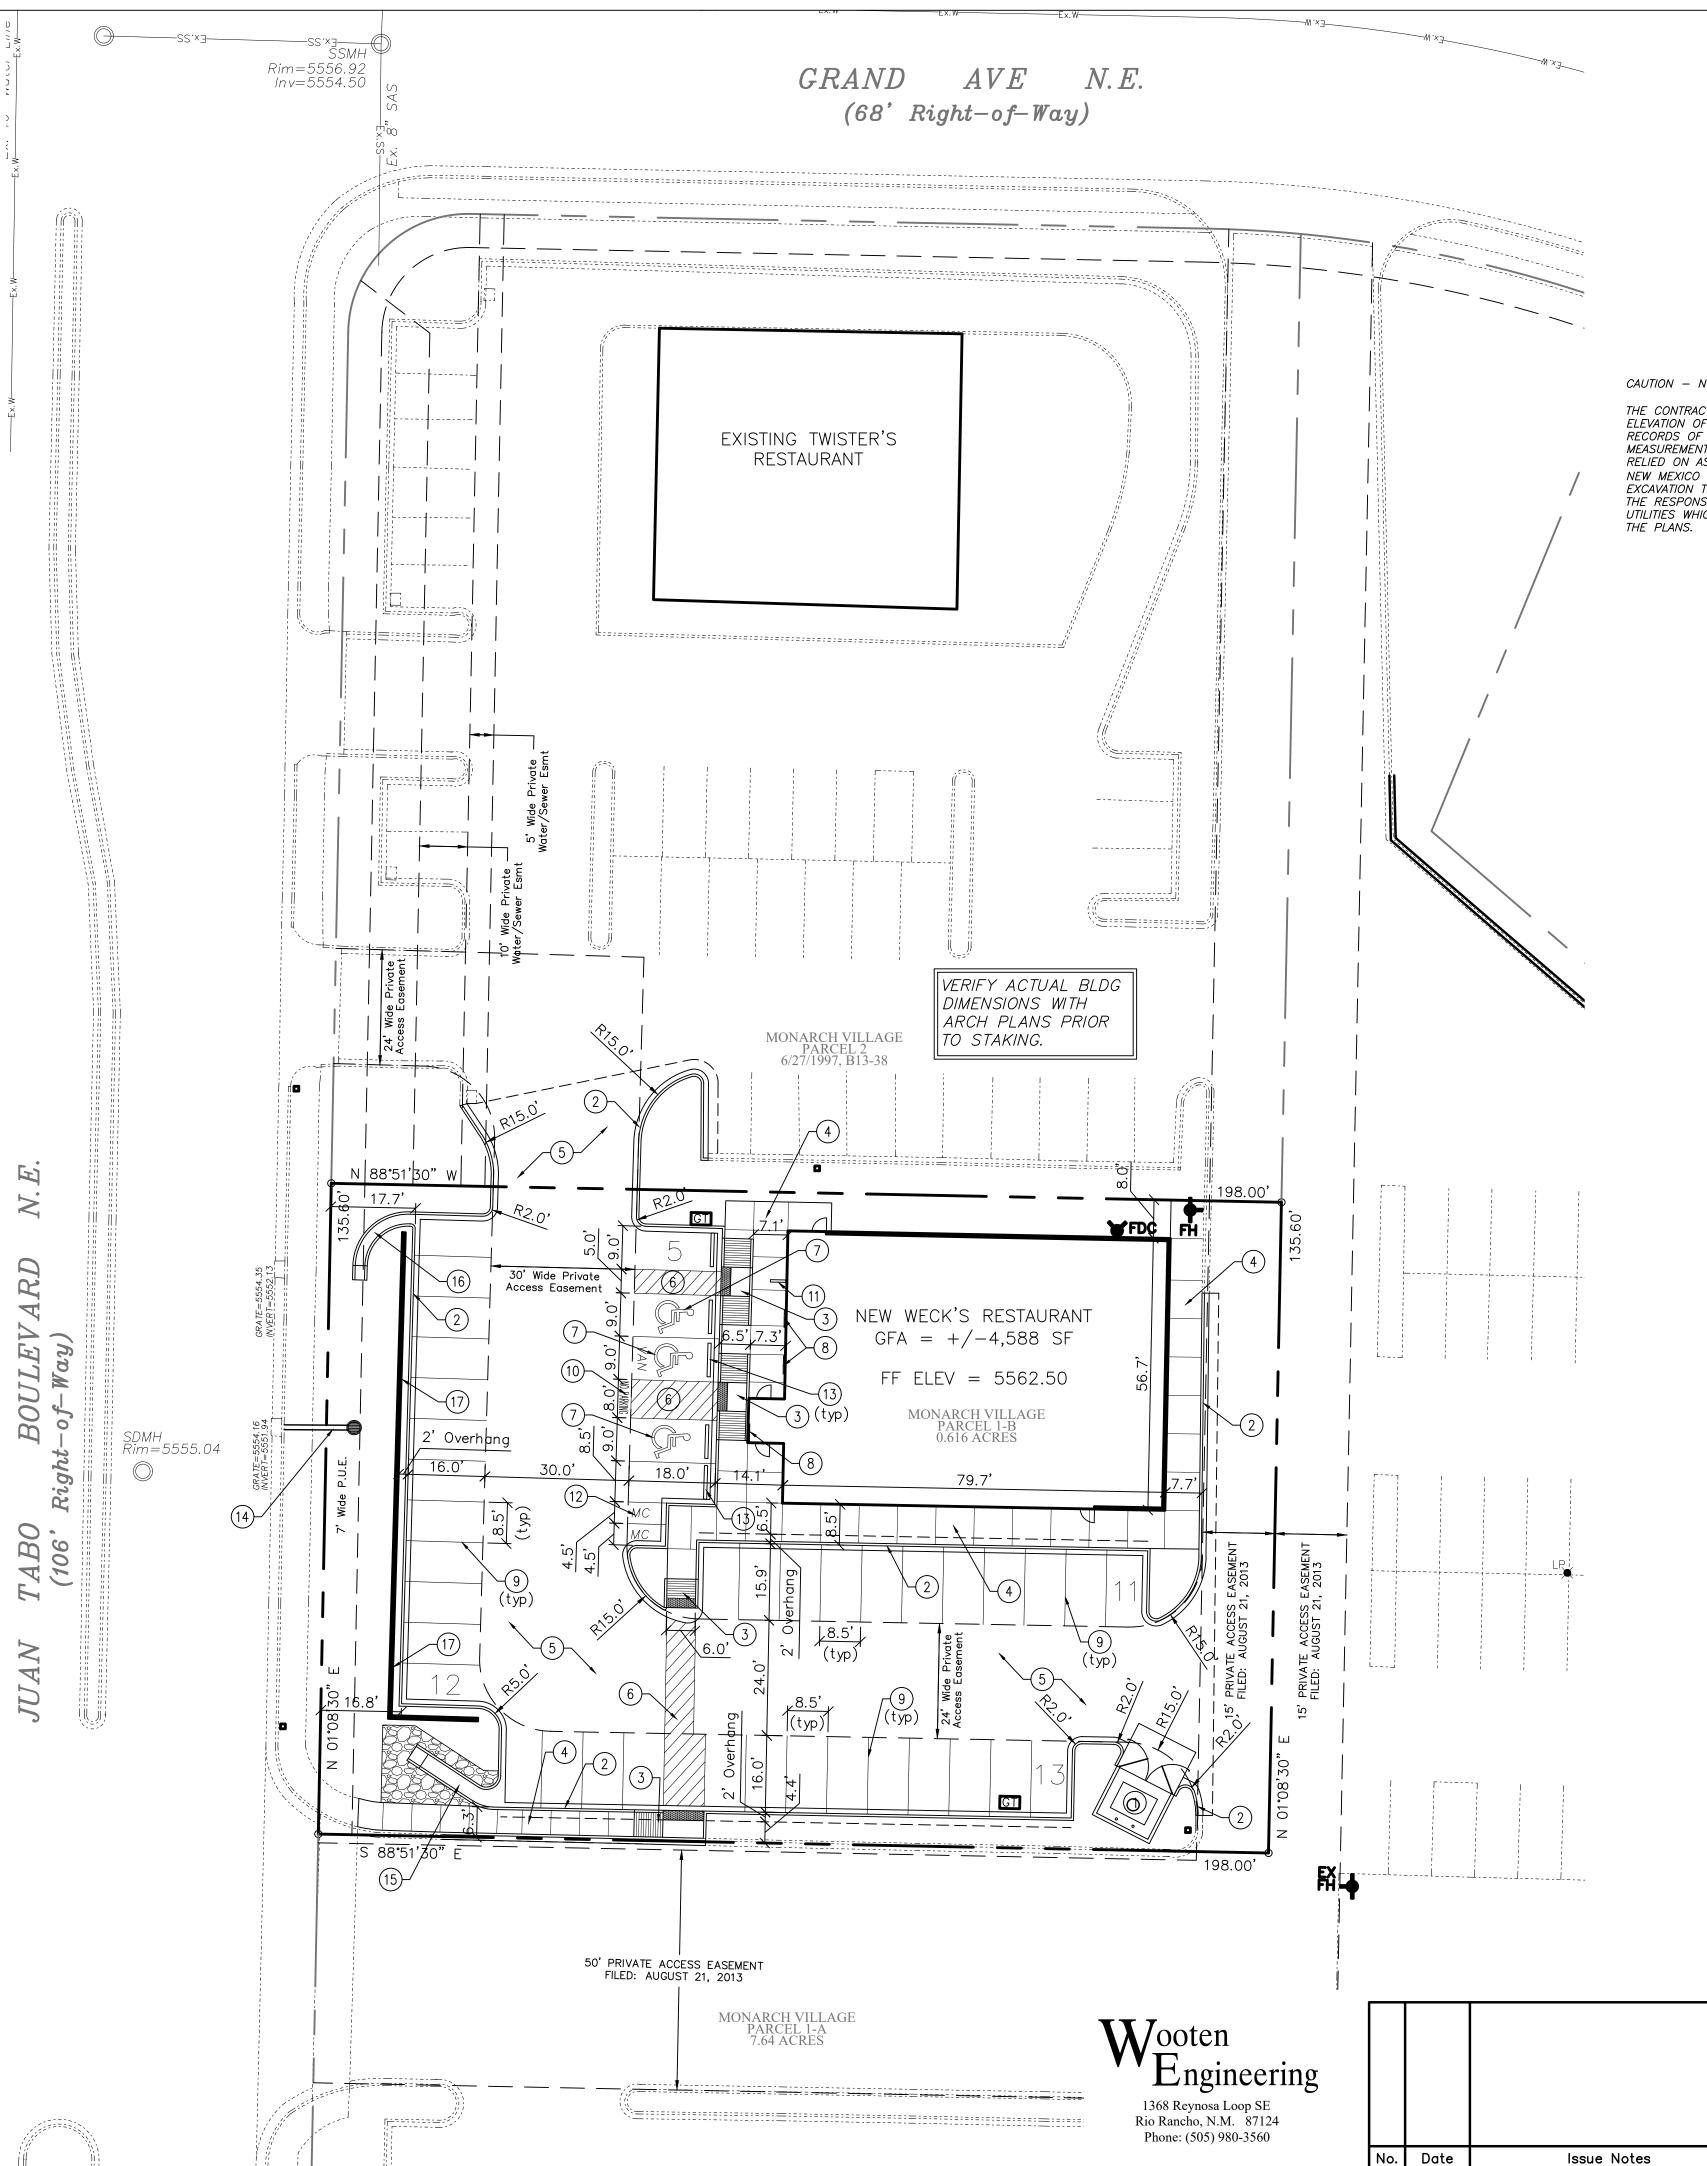

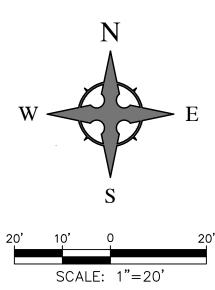

CAUTION - NOTICE TO CONTRACTOR

THE CONTRACTOR IS SPECIFICALLY CAUTIONED THAT THE LOCATION AND/OR ELEVATION OF EXISTING UTILITIES AS SHOWN ON THESE PLANS IS BASED ON RECORDS OF THE VARIOUS UTILITY COMPANIES AND, WHERE POSSIBLE, MEASUREMENTS TAKEN IN THE FIELD. THE INFORMATION IS NOT TO BE RELIED ON AS BEING EXACT OR COMPLETE. THE CONTRACTOR MUST CALL NEW MEXICO ONE CALL (811) AT LEAST 48 HOURS BEFORE ANY EXCAVATION TO REQUEST EXACT FIELD LOCATION OF UTILITIES. IT SHALL BE THE RESPONSIBILITY OF THE CONTRACTOR TO RELOCATE ALL EXISTING UTILITIES WHICH CONFLICT WITH THE PROPOSED IMPROVEMENTS SHOWN ON

PARKING CAL	CULATIONS			
BUILDING AREA:	# SEATS	# SEATS AREA (SQUARE FEET)		
WECK'S RESTAURANT	160	4,588 SF		
PARKING REQUIREMENTS:	RATIO	REQUIRED	PROVIDE	
WECK'S RESTAURANT	1/4 SEATS	40 spaces	41 spaces	
TOTAL		40 spaces	41 spac	
		REQUIRED	PROVIDED	
HANDICAP PARKING	3 spaces	3 spaces		
MOTORCYCLE PARKING	2 spaces	2 spaces		
BICYCLE PARKING	2 spaces	3 spaces		



VICINITY MAP ZONE ATLAS PAGE: K-22

LEGAL DESCRIPTION:MONARCH VILLAGE, PARCEL 1-B

BENCHMARK:

CITY OF ALBUQUERQUE STATION NO. "10-K21". ELEVATION 5557.514

SITE INFORMATION


CONTRACTOR SHALL REFER TO ARCHITECTURAL PLANS FOR EXACT LOCATIONS AND DIMENSIONS OF EXIT PORCHES, PRECISE BUILDING DIMENSIONS, AND EXACT BUILDING UTILITY ENTRANCE LOCATIONS.

CONTRACTOR TO PROVIDE PARKING LOT STRIPING, FIRELANE AND HANDICAP STRIPING PER THESE PLANS AND CITY OF ALBUQUERQUE REQUIREMENTS.

TO PRESERVE THE PAINTING / STRIPING WITHIN PARKING AREAS, DO NOT APPLY PAINT UNTIL ALL OTHER POTENTIALLY DAMAGING CONSTRUCTION HAS BEEN

KEYED NOTES


- 1. DUMPSTER ENCLOSURE PER DETAIL ON SHEET C6.
- 2. INSTALL MEDIAN CURB/GUTTER (6" HIGH) PER COA STD DWG 2415B.
- 3. INSTALL CURB RAMP WITH TRUNCATED DOMES PER DETAILS ON SHEET C6. MATCH ADJACENT SIDEWALK WIDTH.
- 4. INSTALL CONCRETE SIDEWALK PER COA STD DWG 2430.
- 5. ASPHALT PAVEMENT, SEE PAVING DETAILS ON DETAIL SHEET. FOR MAIN DRIVES, USE HEAVY DUTY PAVEMENT. FOR PARKING SPACES, USE STANDARD DUTY ASPHALT PAVEMENT.
- 6. INSTALL 4" WIDE PAINT STRIPES AT 45° ANGLE TO PARKING STRIPES, SPACED AT 1'-6" (WHITE PAINT IN PARKING LOT, BLUE PAINT IN ACCESSIBLE PARKING AREAS). TWO COATS MINIMUM.
- 7. PAINTED WHEELCHAIR SYMBOL (BLUE) TO MEET ADA STANDARDS. TWO COATS
- 8. INSTALL H/C SIGNAGE PER DETAIL ON DETAIL SHEET. ADD VAN ACCESSIBLE SIGNAGE WHERE NOTED. WHEN A POLE MOUNTED SIGN WILL NOT FIT WITHIN DESIGNATED AREA, SIGN SHALL BE BOLTED TO BUILDING. H/C SIGN MUST INCLUDE LANGUAGE PER 66-7-352.4C NMSA 1978 "VIOLATORS ARE SUBJECT TO A FINE AND/OR TOWING."
- 9. INSTALL 4" WIDE PAINT STRIPES (WHITE) FOR ALL PARKING MINIMUM TWO COATS.
- 10. PAINT WORDS 'NO PARKING' WITH LETTERS AT LEAST ONE FOOT HIGH AND 2 INCHES WIDE. TWO COATS MINIMUM.
- 11. INSTALL BIKE RACK WITH THREE (3) SPACES PER DETAIL ON SHEET C6.
- 12. MOTORCYCLE PARKING. ADD PAINT LABELS PER COA STDS. TWO COATS MINIMUM.
- 13. INSTALL PRE-CAST WHEEL STOP PER DETAIL ON SHEET C6.
- 14. STORM DRAIN INLET AND PIPE. REF. SHEET C3.
- 15. INSTALL 3' WIDE CONCRETE FLUME PER DETAIL ON SHEET C6.
- 16. INSTALL 2' WIDE CONCRETE FLUME PER DETAIL ON SHEET C6.
- 17. PROPOSED RETAINING WALL. REFERENCE STRUCTURAL PLANS FOR DETAILS.

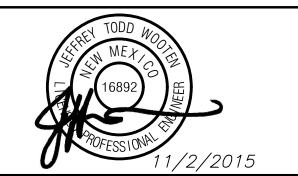



Design FBILL BURK, THIRD, ARCHITECT 9617 La Playa NE, ABQ NM 87111 505-292-6566 / Fax 505-294-7232 Email — billburk@qwestoffice.net

WECK'S RESTAURANT 730 Juan Tabo Blvd NE Albuquerque, NM 87123


SITE PLAN

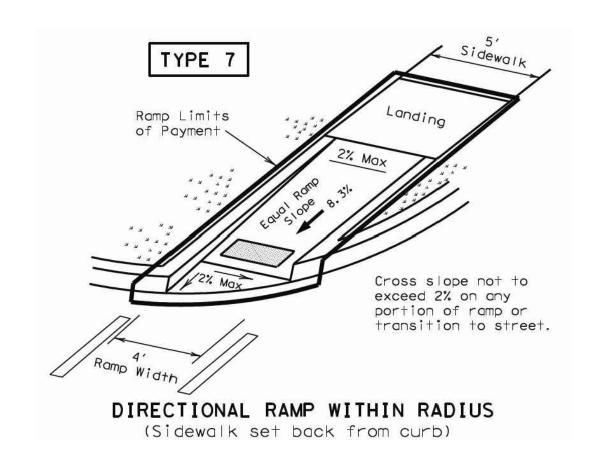

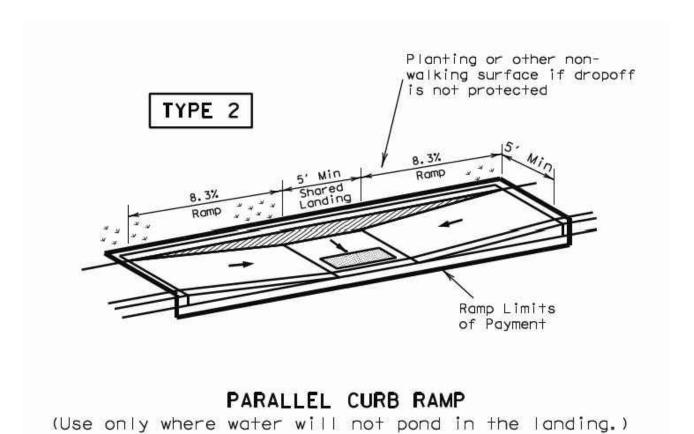


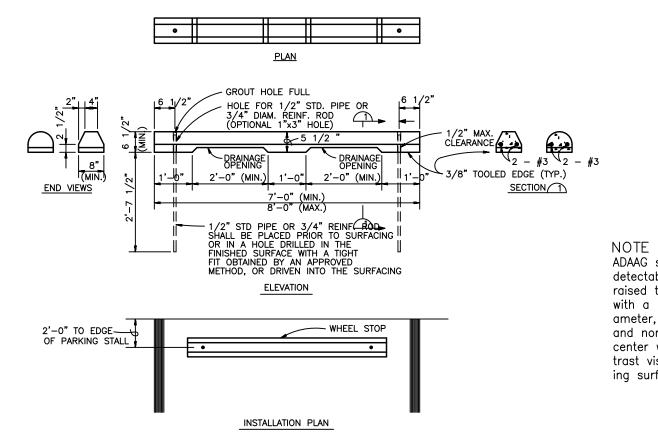




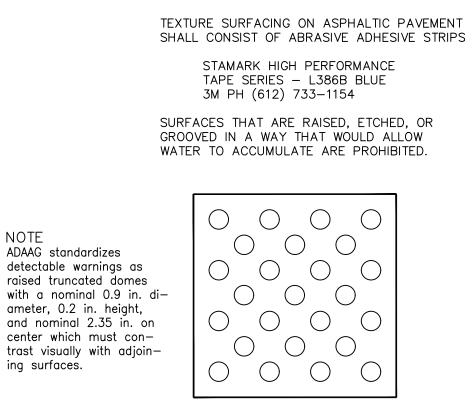


Truncated Domes Detail

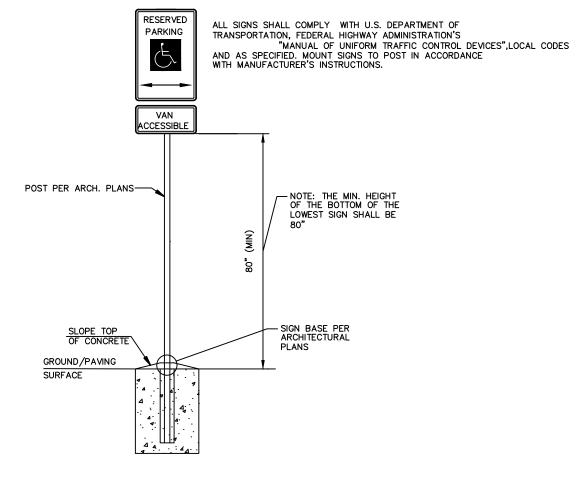


H/C Sign Detail

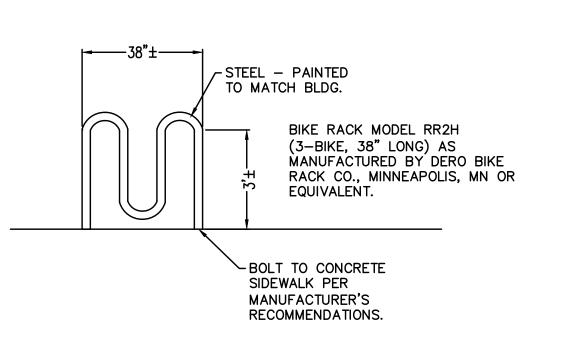


Bike Rack Detail

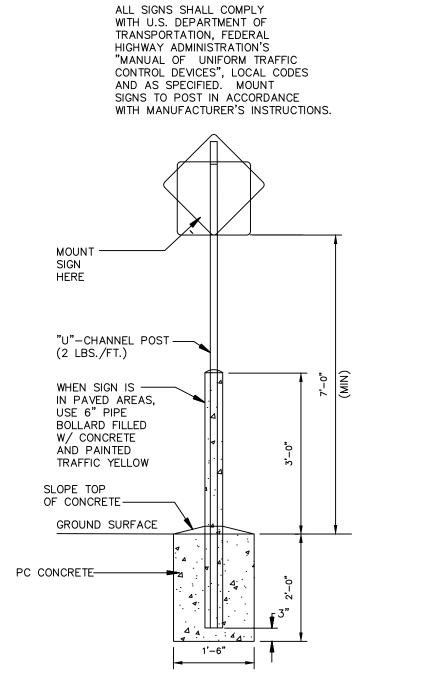


Standard Sign Base

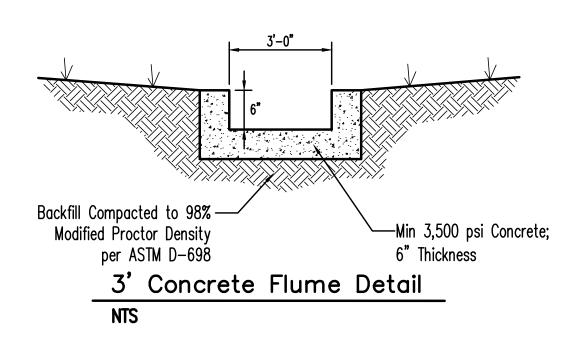

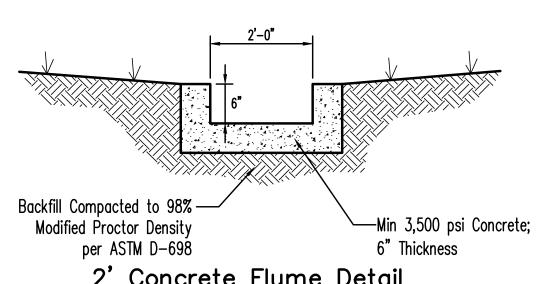

2' Concrete Flume Detail NTS

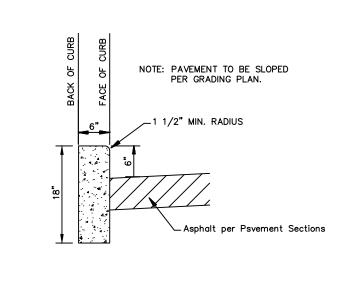


6"x18" Concrete Curb

AUTOMOBILE PARKING AREA PAVEMENT (PARKING SPACES ONLY)

2.5" ASPHALTIC CONCRETE 6" AGGREGATE BASE COURSE MIN. 12" COMPACTED SUBGRADE

INTERNAL DRIVEWAYS AND HEAVY DUTY PAVEMENT

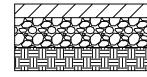


3.5" ASPHALTIC CONCRETE 6" AGGREGATE BASE COURSE MIN. 12" COMPACTED SUBGRADE

TRASH ENCLOSURE CONCRETE PAD


6" PORTLAND CEMENT CONCRETE MIN. 12" COMPACTED SUBGRADE

NOTE: REFERENCE GEOTECHNICAL REPORT BY TERRACON DATED 5/26/2015 FOR ADDITIONAL DETAILS AND SPECIFICATIONS OF PAVEMENT.

Pavement Sections

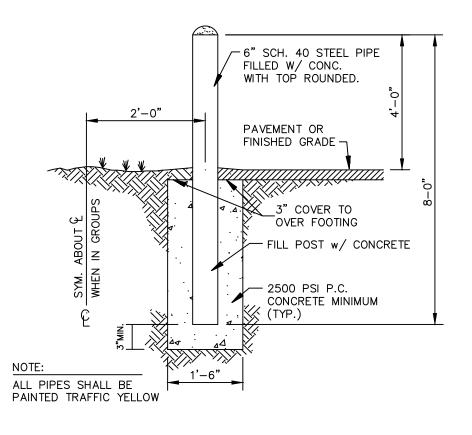


Pipe Bollard Detail

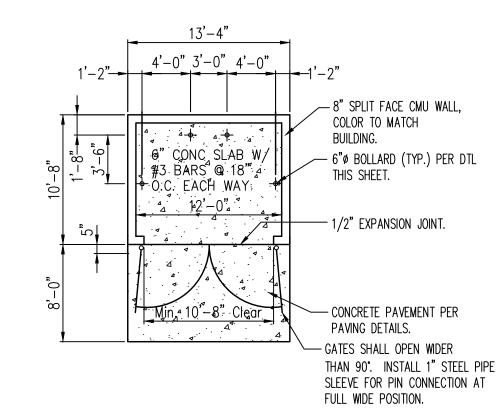


Dumpster Enclosure Plan

NOTE: ALL EXPOSED STEEL SHALL BE PAINTED TO MATCH BUILDING WITH RUST RESISTANT PAINT.

Engineering 1368 Reynosa Loop SE Rio Rancho, N.M. 87124 Phone: (505) 980-3560

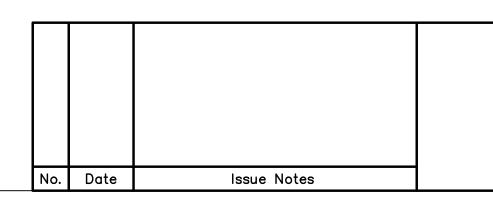

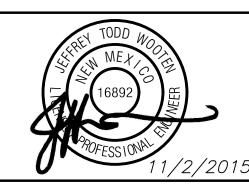

Design Fimilia BURK, THIRD, ARCHITECT 9617 La Playa NE, ABQ NM 87111 505-292-6566 / Fax 505-294-7232 Email — billburk@qwestoffice.net	730	WECK'S RESTAURANT 730 Juan Tabo Blvd NE Albuquerque, NM 87123		Project ID Scale Sheet No.	2015008 Scale As Shown	
Consultant	Sheet Title	SITE DETAILS	10/20/15 CAD File Name	_	C-006 — of ——	