NOTE: PRIOR TO BEGINNING ANY SITE WORK & ORDERING OF MATERIALS, CONTRACTOR SHALL FIELD VERIFY ALL UTILITY & DRAINAGE CONNECTIONS TO EXISTING SYSTEMS BY POT HOLING AND SHALL NOTIFY ENGINEER OF NEEDED CHANGES: FAILURE TO DO SO WILL RESULT IN THE CONTRACTOR BEING RESPONSIBLE FOR ALL REVISION COSTS AND DELAYS.

EROSION CONTROL & MAINTENANCE PLAN NOTES:


CONSTRUCTION EGRESS NOTES:

SCALE: 1" = 20'


- GEOTEXTILE UNDERLINER. REFER TO THE CITY OR STATE FOR ANY ADDITIONAL REQUIREMENTS.
- 2. THE EXIT SHALL BE MAINTAINED IN A CONDITION WHICH WILL PREVENT TRACKING OR FLOW OF MUD ONTO PUBLIC RIGHT-OF-WAY, THIS MAY REQUIRE PERIODIC TOP DRESSING WITH 1.5-3.5 INCH STONE, AS CONDITIONS DEMAND, AND REPAIR AND/OR CLEAN OUT OF ANY STRUCTURE USED TO TRAP


RIP-RAP NOTE:


HAND PLACE RIP-RAP IN ALL PLACES AS INDICATED ON THE PLAN. THE STONE FOR RIP-RAP

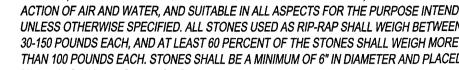



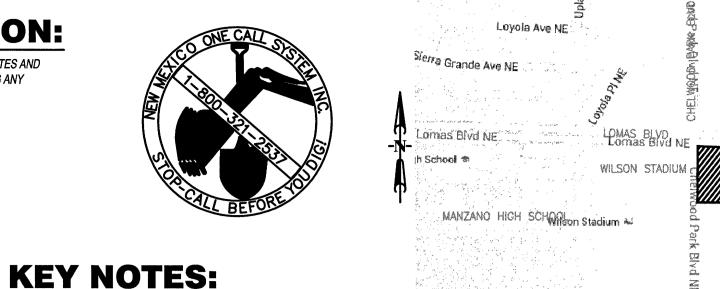

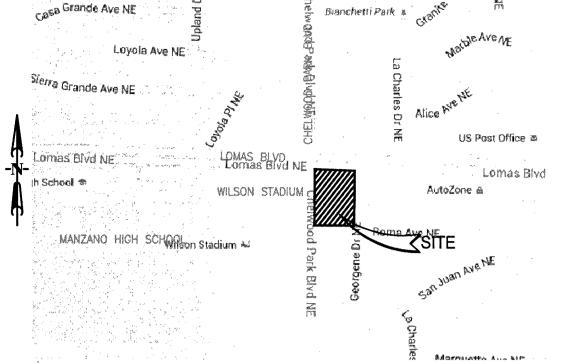

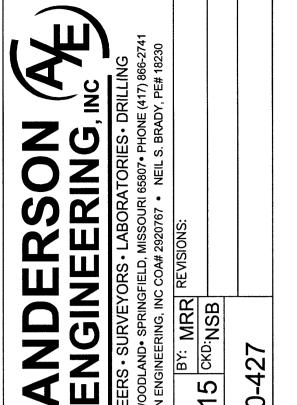

PROJECT MANAGERS

10877 Watson Road

St. Louis, MO 63127

REVISIONS:

CODE / ADD #1 12/11/15

CODE / ADD #2 2/1/16

Phone: (314) 821-1100

ENTION

MRR

NSB

12-11-2015

315621

DRAWN:

JOB NO.:

CHECKED:

(NOT TO SCALE) ZONE ATLAS PAGE: K-22-Z

STREET IN THE AREA TO BE SWEPT DAILY WHEN WORKING IN THE CITY ROW IF SEDIMENT IS

STAGES OF CONSTRUCTION:

5. REMOVAL OF EXISTING PAVEMENT ON THE SITE. MONTH 1

8. CONSTRUCTION OF NEW SITE IMPROVEMENTS. MONTH 2

11. REMOVAL OF EROSION CONTROL FENCE. MONTH 3

10. PLACEMENT OF FINAL LANDSCAPING ITEMS AND SOD. MONTH 3

7. ROUGH GRADING. MONTH 1 & MONTH 2

9. FINAL GRADING, MONTH 3

6. INSTALLATION OF ALL STORM WATER DRAINAGE IMPROVEMENTS, MONTH 1


(E6) INSTALL CURB INLET PROTECTION PER DETAIL 3/C4.

LIMITS OF TEMPORARY EROSION CONTROL FENCE: REFER TO DETAIL 10/C3.

(E2) INSTALL CONSTRUCTION EGRESS PER NOTE.


DROP INLET WITH GRATE SEE DETAIL 10/C3.


SEE DETAIL 10/C3.

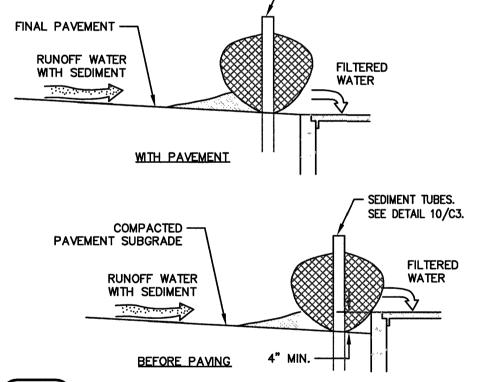



TYPE "A" INLET PROTECTION

SCALE: NOT TO SCALE

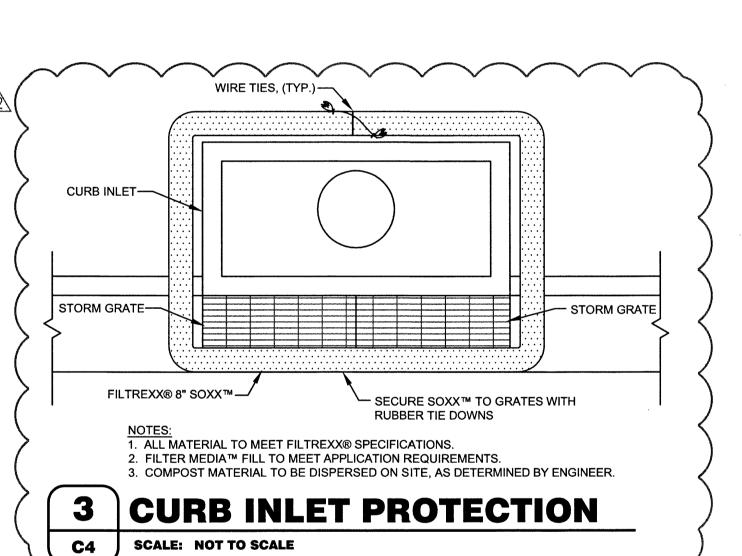

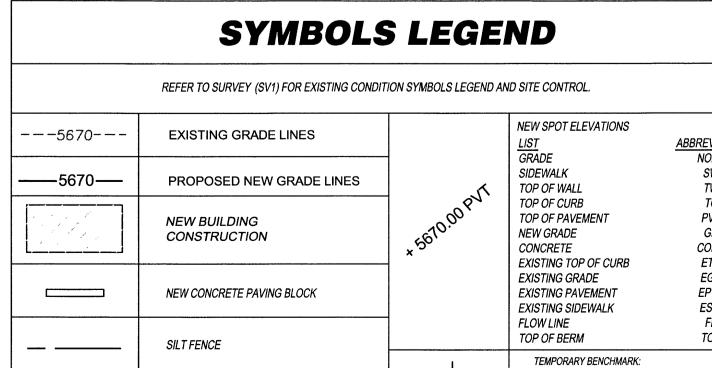

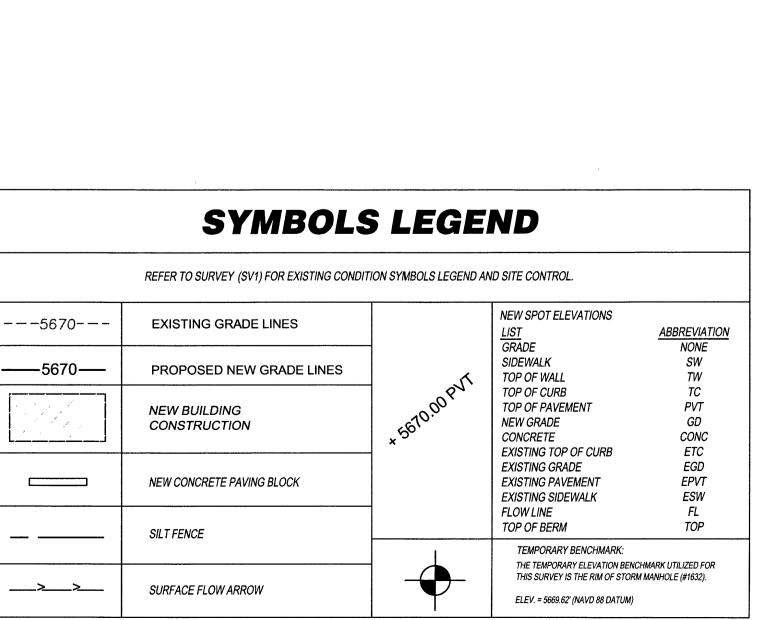

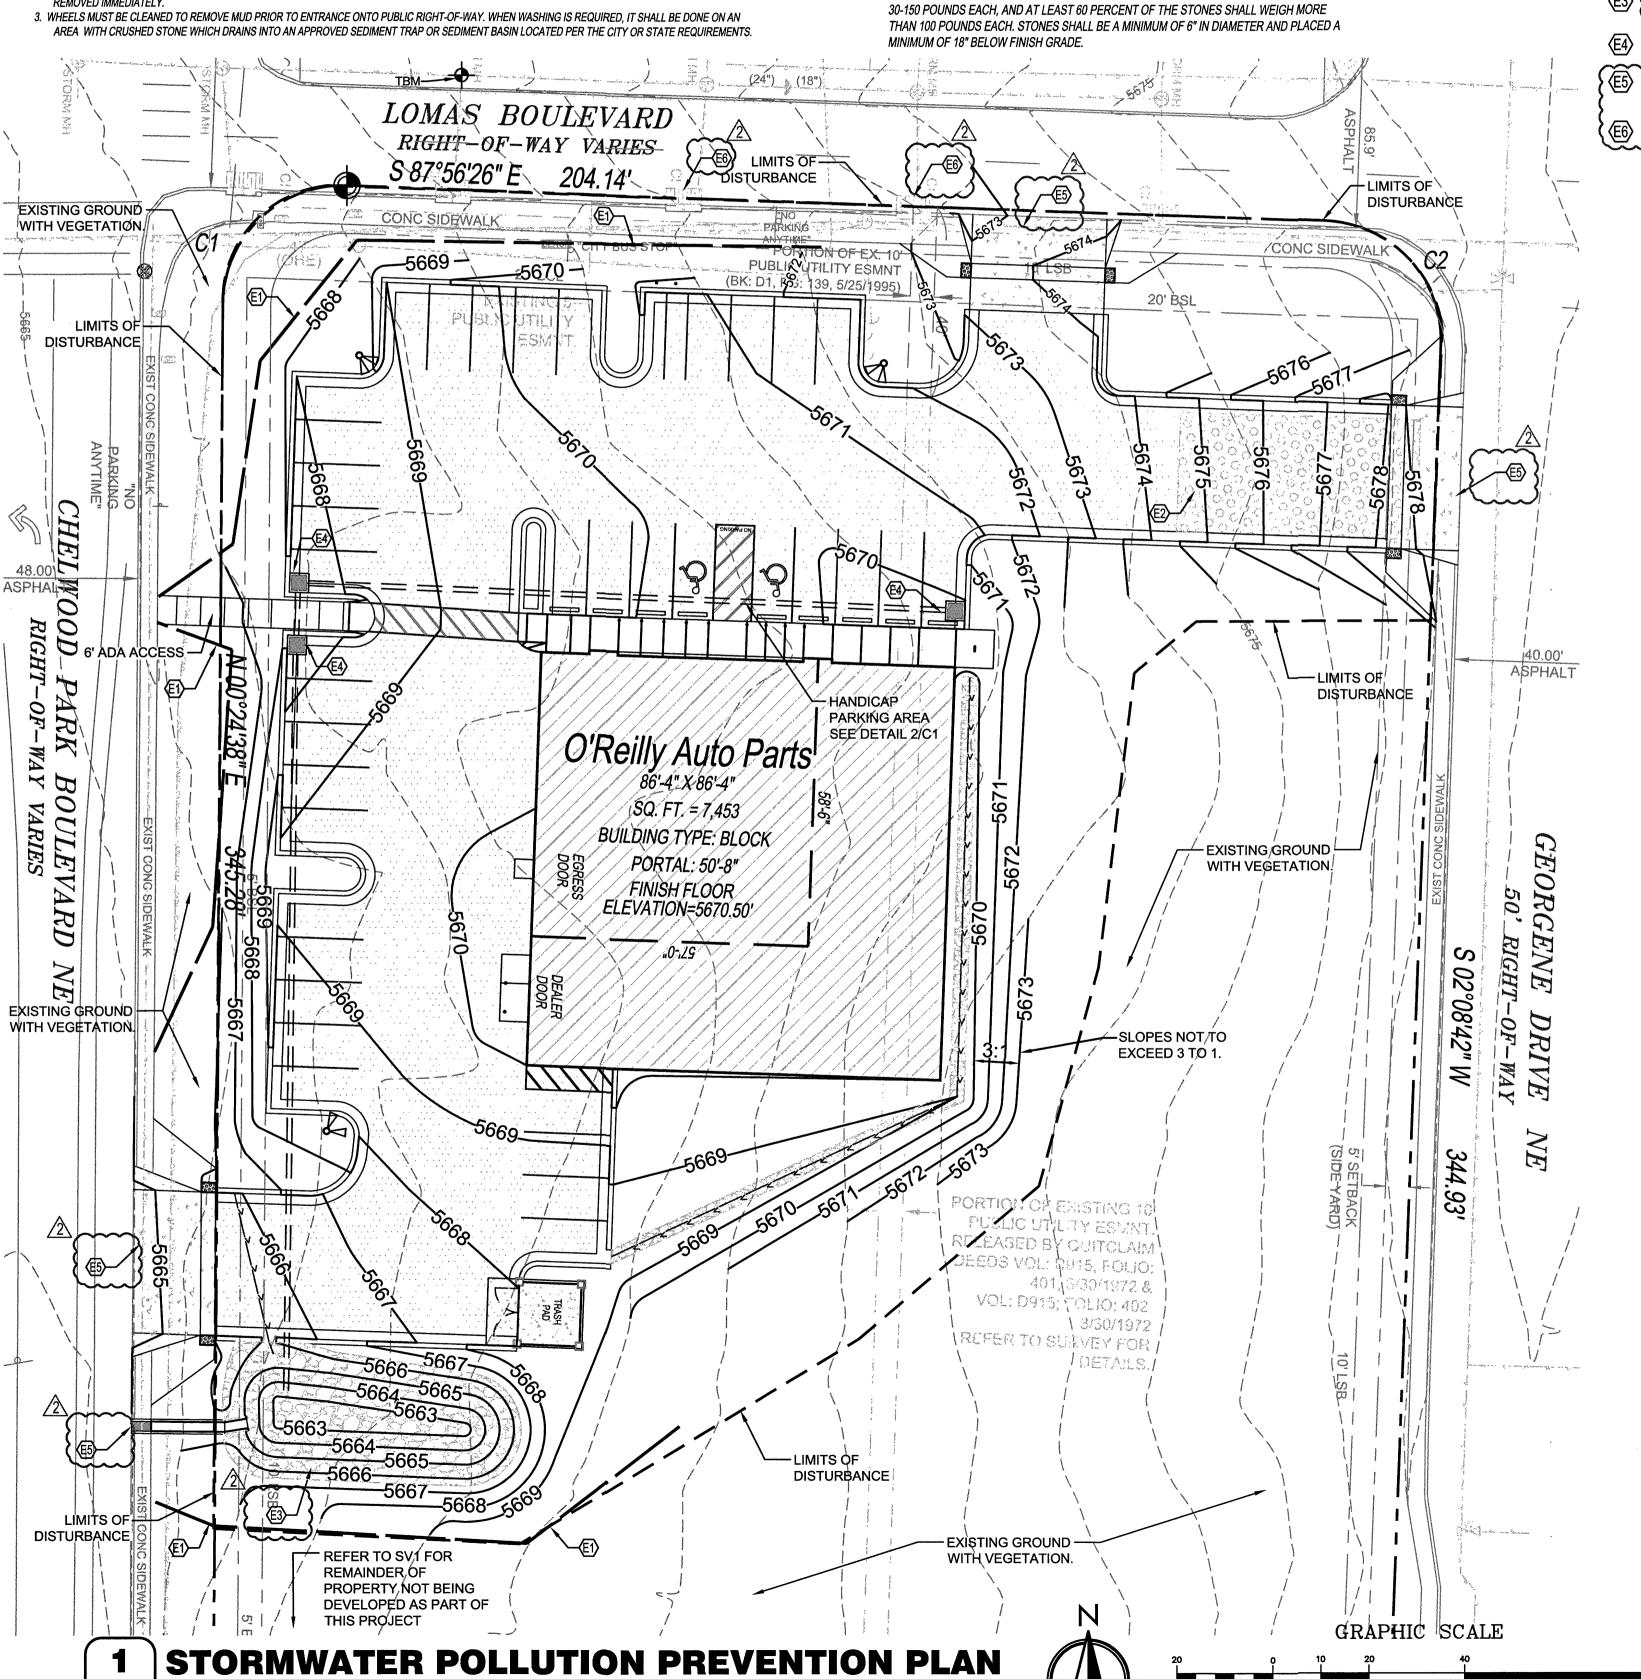



1 inch = 20 ft.