CITY OF ALBUQUERQUE

Planning Department
David Campbell, Director



December 21, 2018

Åsa Nilsson-Weber, P.E. Isaacson & Arfman, P.A. 128 Monroe St. N.E Albuquerque, NM 87108

RE: Manzano High School Gym
12200 Lomas Blvd NE
Request for Certificate of Occupancy – Permanent
Hydrology Final Inspection - Approved
Engineer's Stamp Date 6/8/16 (K22D020)
Certification Dated: 12/17/18

Dear Ms. Nilsson-Weber:

PO Box 1293 Based on the submittal received on 12/18/18, this certification is approved in support of

Certificate of Occupancy by Hydrology.

Albuquerque If you have any questions, you can contact me at 924-3695 or dpeterson@cabq.gov.

NM 87103 Sincerely,

www.cabq.gov

Dana Peterson, P.E.

Senior Engineer, Planning Dept. Development and Review Services

C: Email Fox, Debi; Tena, Victoria; Sandoval, Darlene; Costilla, Michelle




City of Albuquerque


Planning Department


Development & Building Services Division

DRAINAGE AND TRANSPORTATION INFORMATION SHEET (REV 6/2018)

Manzano High School Gymnasium Project Title: Gymnasium Building Permit #:		Hydrology File #: K22D020	
DRB#: F			
Legal Description: Unplatted Lands of APS a			
City Address: 12200 Lomas Blvd. NE - Albud	querque, NM 87112		
Applicant: Isaacson & Arfman, PA		Contact: Åsa Nilsson-Weber	
Address: 128 Monroe Street NE - Albuquerq			
Phone#:(505) 268-8828 F	'ax#:	E-mail: asaw@iacivil.com	
Other Contact: Studio Southwest Architects,	Inc.	Contact: Richard Braun	
Address: 2101 Mountain Road NW - Albuque	erque, NM 87104		
Phone#: <u>(505)</u> 843-9639 F	ax#:	_ E-mail:	
TYPE OF DEVELOPMENT: PLAT	RESIDENCE DRB	SITE X ADMIN SITE	
Check all that Apply:			
DEPARTMENT: X HYDROLOGY/ DRAINAGE TRAFFIC/ TRANSPORTATION TYPE OF SUBMITTAL: X ENGINEER ARCHITECT CERTIFICATION PAD CERTIFICATION CONCEPTUAL G & D PLAN GRADING PLAN DRAINAGE REPORT DRAINAGE MASTER PLAN FLOODPLAIN DEVELOPMENT PERMIT API ELEVATION CERTIFICATE CLOMR/LOMR TRAFFIC CIRCULATION LAYOUT (TCL) TRAFFIC IMPACT STUDY (TIS) STREET LIGHT LAYOUT OTHER (SPECIFY) PRE-DESIGN MEETING?	BUILDING PER X CERTIFICATE PRELIMINARY SITE PLAN FOR FINAL PLAT A SIA/ RELEASE FOUNDATION GRADING PER SO-19 APPROV PAVING PERM GRADING/ PAI WORK ORDER A CLOMR/LOMR FLOODPLAIN I	PLAT APPROVAL R SUB'D APPROVAL R BLDG. PERMIT APPROVAL APPROVAL OF FINANCIAL GUARANTEE PERMIT APPROVAL AMIT APPROVAL JAL IIT APPROVAL O CERTIFICATION APPROVAL	
DATE SUBMITTED: <u>December 18, 2018</u>			
COA STAFF:	ELECTRONIC SUBMITTAL RECEIVED:		
1	FEE PAID:		

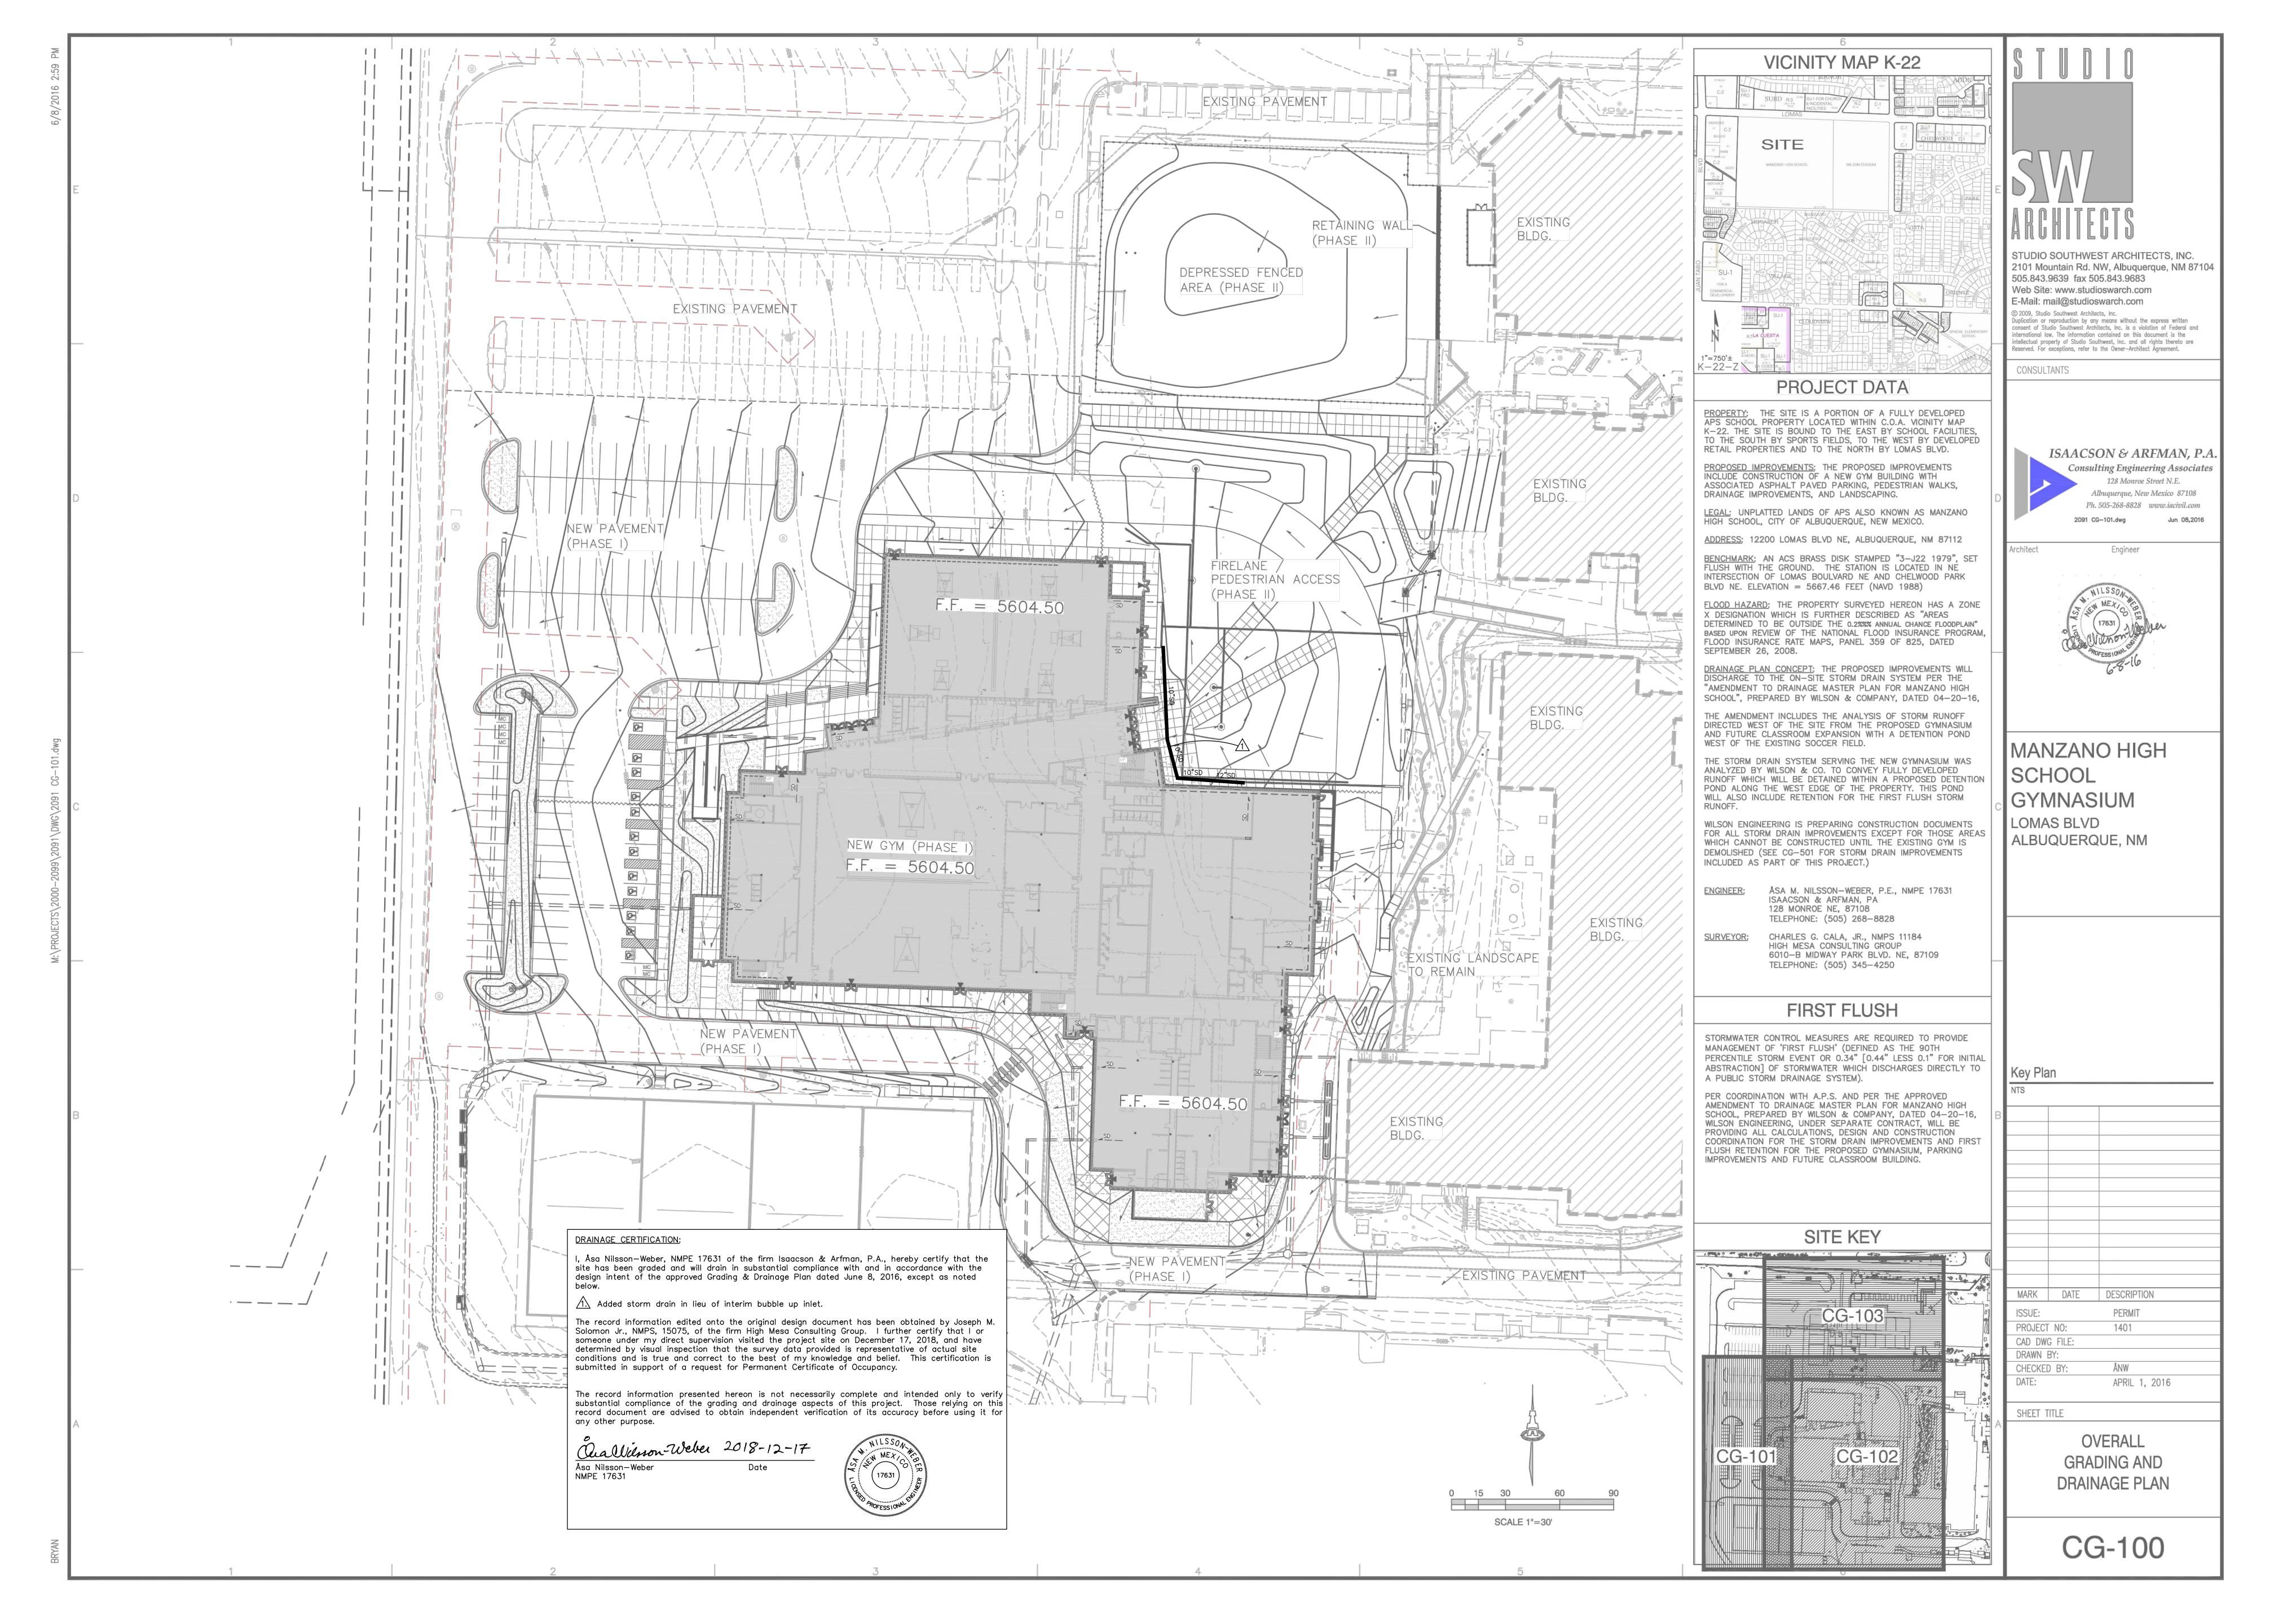

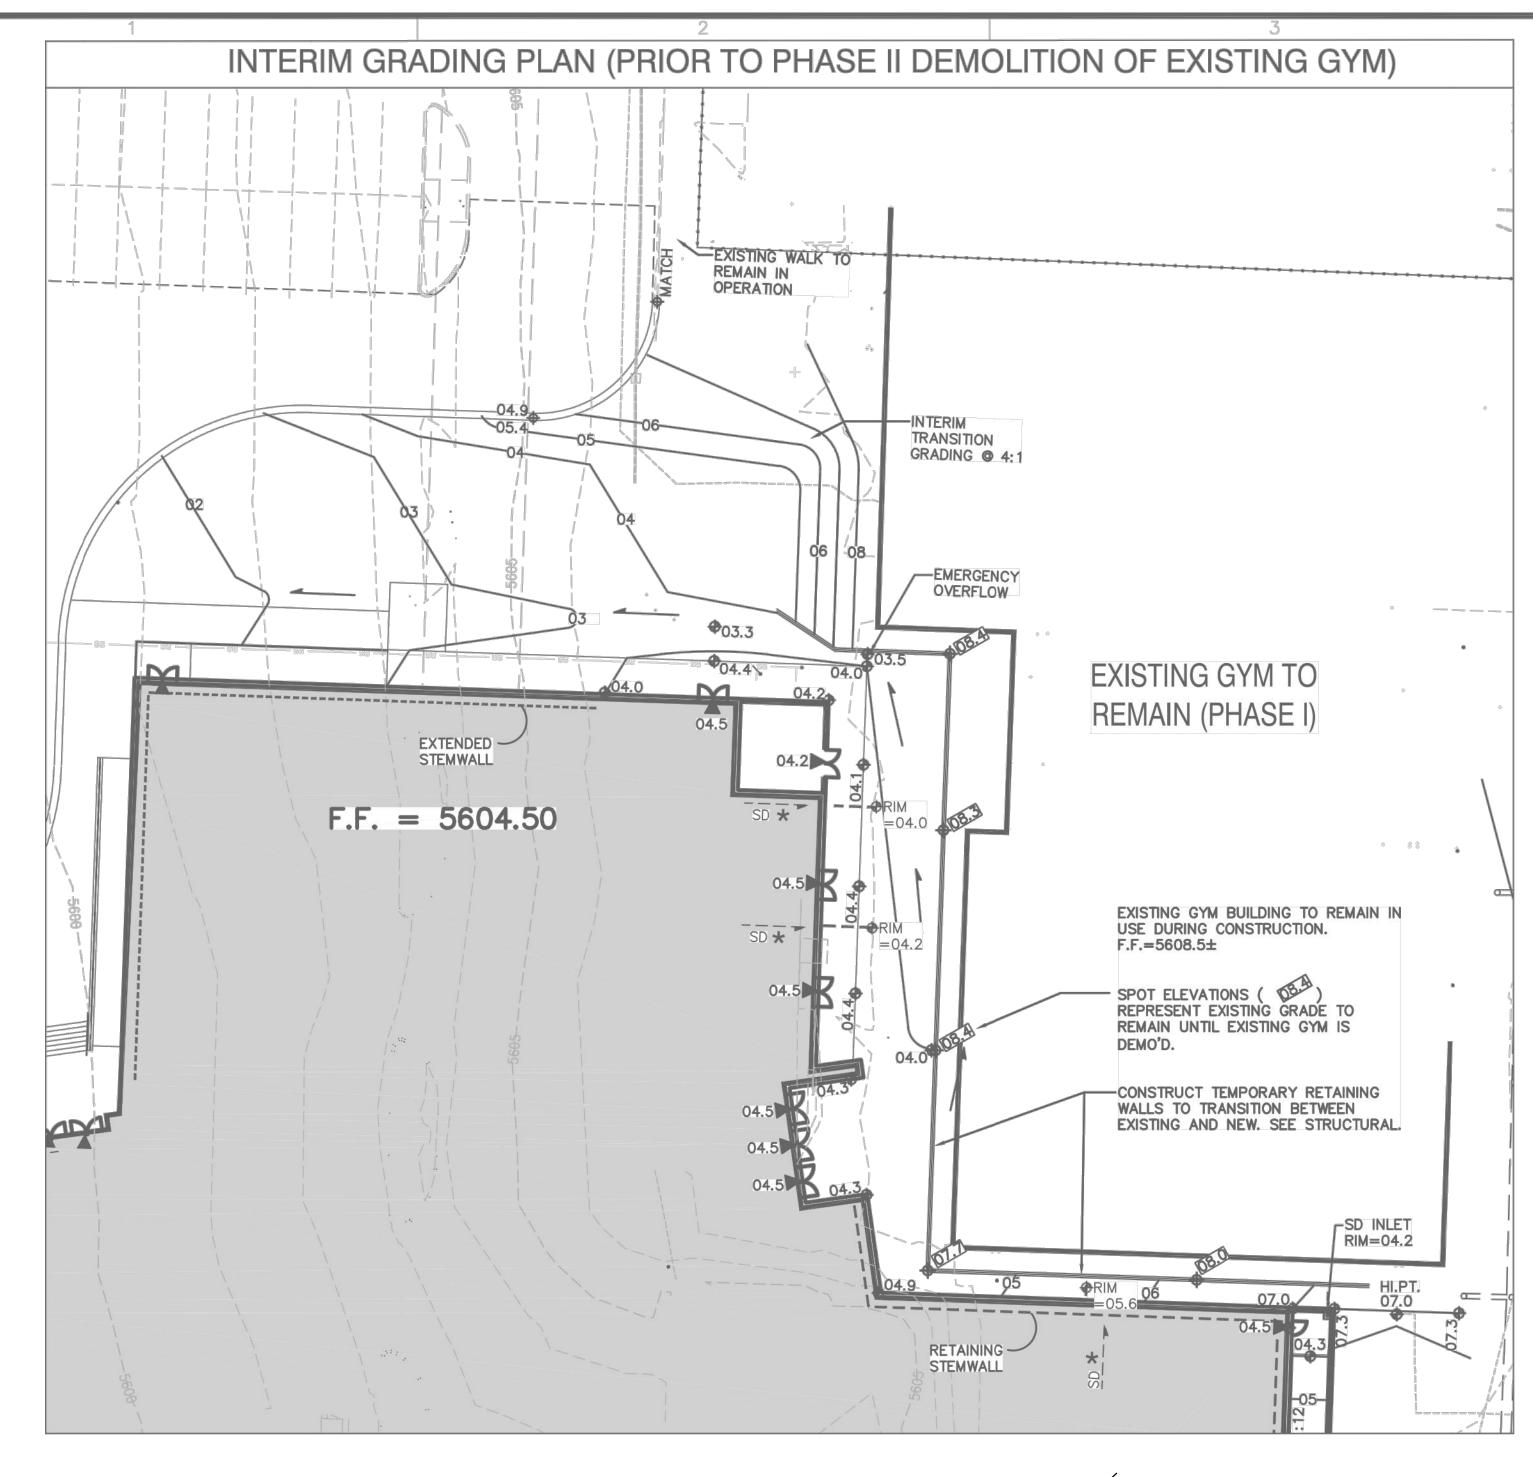

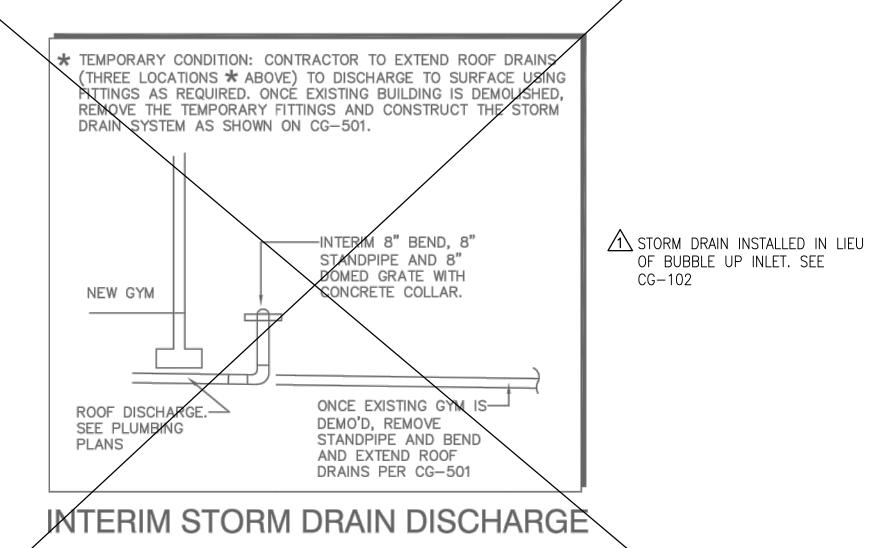

DRAINAGE CERTIFICATION:

NMPE 17631

I, Åsa Nilsson—Weber, NMPE 17631 of the firm Isaacson & Arfman, P.A., hereby certify that the site has been graded and will drain in substantial compliance with and in accordance with the design intent of the approved Grading & Drainage Plan dated June 8, 2016, except as noted

1. Added storm drain in lieu of interim bubble up inlet.

The record information edited onto the original design document has been obtained by Joseph M. Solomon Jr., NMPS, 15075, of the firm High Mesa Consulting Group. I further certify that I or someone under my direct supervision visited the project site on December 17, 2018, and have determined by visual inspection that the survey data provided is representative of actual site conditions and is true and correct to the best of my knowledge and belief. This certification is submitted in support of a request for Permanent Certificate of Occupancy.

The record information presented hereon is not necessarily complete and intended only to verify substantial compliance of the grading and drainage aspects of this project. Those relying on this record document are advised to obtain independent verification of its accuracy before using it for any other purpose.

Quallesson-Weber 2018-12-17 Åsa Nilsson-Weber



KEYED NOTES

~____

SCALE 1"=20'

- CONSTRUCT NEW PAVEMENT, CURB AND GUTTER, SIDEWALKS AT ELEVATIONS SHOWN. SEE PAVING PLAN (CP-101) FOR
 - TO ENSURE READABILITY, NOT ALL PAVEMENT SPOT ELEVATIONS SHOW ADJACENT TOP OF CURB / TOP OF WALK
- ADJACENT CURB OR WALK ELEVATIONS UNLESS NOTED. TRANSITIONS BETWEEN NEW AND EXISTING PAVEMENT SHALL B
- REQUIREMENTS. MAX. SLOPE = 2% IN ANY DIRECTION.
- . CONSTRUCT 1:12 (MAX.) SIDEWALK RAMP. SEE SHEET CP-501 PAVING DETAILS. TOP OF ASPHALT TO BE FLUSH WITH TOP OF CONCRETE EDGE FOR ADA COMPLIANCE.


- PRIOR TO THIS PROJECT UNDER SEPARATE CONTRACT (BY OTHERS) SEE CG-501 FOR ADDITIONAL INFORMATION.
- DIFFERENCE. SEE ARCHITECTURAL.
- 11. CONSTRUCT RETAINING STEM WALL TO ACHIEVE GRADE DIFFERENCE, SEE ARCHITECTURAL.
- 13. INSTALL COBBLE EROSION PROTECTION THIS AREA, NOTE: PER
- 4. TYPICAL FOR LANDSCAPE: DEPRESS LANDSCAPING TO PROVIDE SHALLOW WATER HARVESTING BASIN. NOTE: NO WATER
- 5. CONSTRUCT SITE STORM DRAIN SYSTEM THIS AREA AS PART OF PHASE II (FOLLOWING THE REMOVAL OF THE EXISTING GYM BUILDING.) SEE CG-501 FOR ADDITIONAL INFORMATION.
- 16. PROVIDE 18" WIDE OPENING IN CURB AT FLOWLINE ELEVATION SHOWN. SEE CG-501 FOR DETAIL.
- 18. CONSTRUCT 2' WIDE CONCRETE ALLEY GUTTER AT ELEVATIONS

EXTENDED STEMWALL

FLOW SOUTH TO PROPOSED POND, SEE ENLARGED DETAIL THIS SHEET FOR ADDITIONAL INFORMATION.

THE FOLLOWING KEYED NOTES ARE FOR USE ON SHEETS CG-101, CG-102 AND CG-103. NOT ALL NOTES ARE REFERENCED ON EACH

- ELEVATION. TEXT SHOWN WITHIN FLOWLINE RÉPRESENTS FLOWLINE ELEVATION. ADD 0.5' TYPICAL FOR TOP OF
- SLOPE WITHIN HANDICAP PARKING AREA TO MEET ADA
- . SITE PEDESTRIAN ACCESS RAMP (1:12 MAX.) WITH RETAINING WALLS. SEE ARCHITECTURAL.
- SITE EXTERIOR STAIRS/STEPS. SEE ARCHITECTURAL. PORTION OF SITE STORM DRAIN SYSTEM TO BE INSTALLED
- PROPOSED ROOF DISCHARGE LOCATION. SEE CG-501 FOR
- 10. CONSTRUCT EXTENDED STEM WALL TO ACHIEVE GRADE
- 2. ONE-HALF FOOT DESIGN CONTOURS (0.5' INCREMENTS) SHOWN DASHED TO CLARIFY GRADING CONCEPT. SEE LEGEND FOR ADDITIONAL INFORMATION.
- A.P.S. STANDARDS, ALL ROCK EROSION PROTECTION WITHIN THE SCHOOL SITE IS TO BE 6" AVG. DIA. ROUNDED ROCK EMBEDDED IN CONCRETE. NO LOOSE COBBLE SWALES OR EROSION PROTECTION SHALL BE ALLOWED ON A.P.S. DISTRICT PROPERTIES.
- HARVESTING SHALL OCCUR WITHIN 10' OF BUILDINGS.
- 17. CONSTRUCT SITE RETAINING WALL TO ACHIEVE REQUIRED GRADE DIFFERENCE AT ELEVATIONS SHOWN. SEE ARCHITECTURAL FOR ADDITIONAL INFORMATION INCLUDING GUARDRAILS WHERE
- 19. CONSTRUCT 8" HIGH HEADER CURB TO DEFLECT UPSTREAM

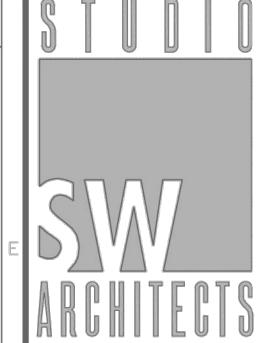

STUDIO SOUTHWEST ARCHITECTS, INC. 2101 Mountain Rd. NW, Albuquerque, NM 87104 505.843.9639 fax 505.843.9683 Web Site: www.studioswarch.com E-Mail: mail@studioswarch.com

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CONSULTANTS

ISAACSON & ARFMAN, P.A. Consulting Engineering Associates 128 Monroe Street N.E. Albuquerque, New Mexico 87108 Ph. 505-268-8828 www.iacivil.com

2091 CG-101.dwg



MANZANO HIGH SCHOOL GYMNASIUM LOMAS BLVD ALBUQUERQUE, NM


LEGEND

---- EXISTING CONTOUR

02	PROPOSED 1' CONTOUR
02.5	PROPOSED 0.5' CONTOUR
4 03.8	PROPOSED SPOT ELEVATION
	FLOW ARROW
FF = 5604.50	FINISH FLOOR ELEVATION
INV=	INVERT ELEVATION
FL=	FLOWLINE ELEVATION
**********	PROPOSED STORM DRAIN

~~~~~~ PROPOSED GRADE BREAK

# SITE KEY

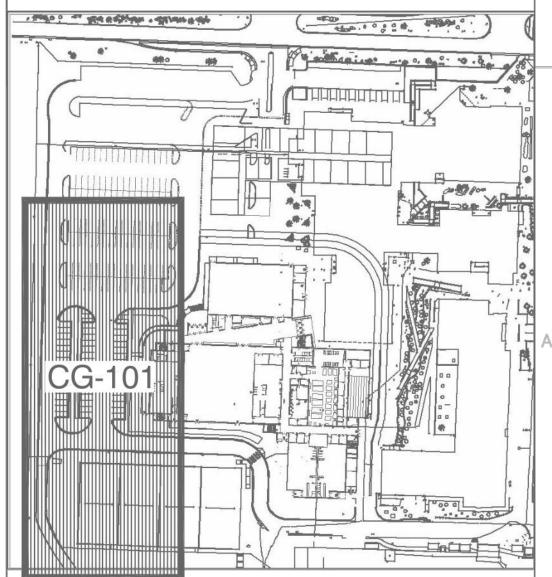

MARK | DATE | DESCRIPTION PERMIT DRAWN BY: CHECKED BY: APRIL 1, 2016

SHEET TITLE

**GRADING AND** DRAINAGE PLAN 1 OF 3

CG-101

