CITY OF ALBUQUERQUE

Planning Department Alan Varela, Director



Mayor Timothy M. Keller

September 7, 2022

David Soule, P.E. Rio Grande Engineering P.O. Box 93924 Albuquerque, NM 87199

RE: 12016 Copper Townhomes Grading and Drainage Plan Engineer's Stamp Date: 07/09/22 Hydrology File: K22D065

Dear Mr. Soule:

Based upon the information provided in your submittal received 07/11/2022, the Grading & Drainage Plan is approved for Building Permit and SO-19 Permit. Please attach a copy of this approved plan in the construction sets for Building Permit processing along with a copy of this letter.

PRIOR TO CERTIFICATE OF OCCUPANCY:

Albuquerque

PO Box 1293

1. Engineer's Certification, per the DPM Part 6-14 (F): *Engineer's Certification Checklist For Non-Subdivision* is required.

NM 87103
Please provide the Drainage Covenant with Exhibit A for the stormwater quality ponds per Article 6-15(C) of the DPM prior to Permanent Release of Occupancy. Please submit the original copies along with the \$25.00 recording fee check made payable to Bernalillo County to Carrie Compton (cacompton@cabg.gov) on the 4th floor of Plaza de Sol.

www.cabq.gov

As a reminder, if the project total area of disturbance (including the staging area and any work within the adjacent Right-of-Way) is 1 acre or more, then an Erosion and Sediment Control (ESC) Plan and Owner's certified Notice of Intent (NOI) is required to be submitted to the Stormwater Quality Engineer (Doug Hughes, PE, <u>jhughes@cabq.gov</u>, 924-3420) 14 days prior to any earth disturbance.

If you have any questions, please contact me at 924-3995 or <u>rbrissette@cabq.gov</u>.

Sincerely,


Renée C. Brissette

Renée C. Brissette, P.E. CFM Senior Engineer, Hydrology Planning Department

City	of Albuquer	que	
	Planning Department		
E Developm	ent & Building Services I	Division	
DRAINAGE AND	TRANSPORTATION INF	ORMATION SHEET (REV 6/2018)	
Project Title:	Building Permit #:	Hydrology File #:	
DRB#:	A LA CUESTA SUBDI	VISION	
12016 Copper			
Applicant:			
Address:			
Phone#:	Fax#:	E-mail:	
Other Contact: RIO GRANDE ENGINE	ERING	Contact: DAVID SOULE	
Address: PO BOX 93924 ALB NM			
Phone#: 505.321.9099	Fax#: ^{505.872.0999}	E-mail:E-mail:	сm
TYPE OF DEVELOPMENT: PLAT			
Check all that Apply:			
DEPARTMENT: X HYDROLOGY/ DRAINAGE TRAFFIC/ TRANSPORTATION TYPE OF SUBMITTAL: ENGINEER/ARCHITECT CERTIFICATION PAD CERTIFICATION CONCEPTUAL G & D PLAN XX GRADING PLAN DRAINAGE REPORT DRAINAGE MASTER PLAN FLOODPLAIN DEVELOPMENT PERMIT A ELEVATION CERTIFICATE CLOMR/LOMR TRAFFIC CIRCULATION LAYOUT (TCL) TRAFFIC IMPACT STUDY (TIS) STREET LIGHT LAYOUT OTHER (SPECIFY) PRE-DESIGN MEETING? IS THIS A RESUBMITTAL?:YesXX No	X BUILI CERT PRELI SITE I SITE I SITE I FINAI PPLIC	APPROVAL/ACCEPTANCE SOUGHT: DING PERMIT APPROVAL IFICATE OF OCCUPANCY MINARY PLAT APPROVAL PLAN FOR SUB'D APPROVAL PLAN FOR BLDG. PERMIT APPROVAL L PLAT APPROVAL RELEASE OF FINANCIAL GUARANTEE DATION PERMIT APPROVAL DING PERMIT APPROVAL APPROVAL NG PERMIT APPROVAL DING/ PAD CERTIFICATION CORDER APPROVAL MR/LOMR DPLAIN DEVELOPMENT PERMIT R (SPECIFY)	
IS THIS A KESUBMITTAL?: Yes No)		
DATE SUBMITTED:			
COA STAFF:	ELECTRONIC SUBMITTAL RECE	SIVED:	

CAUTION

EXISTING UTILITIES ARE NOT SHOWN. IT SHALL BE THE SOLE RESPONSIBILITY OF THE CONTRACTOR TO CONDUCT ALL NECESSARY FIELD INVESTIGATIONS PRIOR TO ANY EXCAVATION TO DETERMINE THE ACTUAL LOCATION OF UTILITIES & OTHER

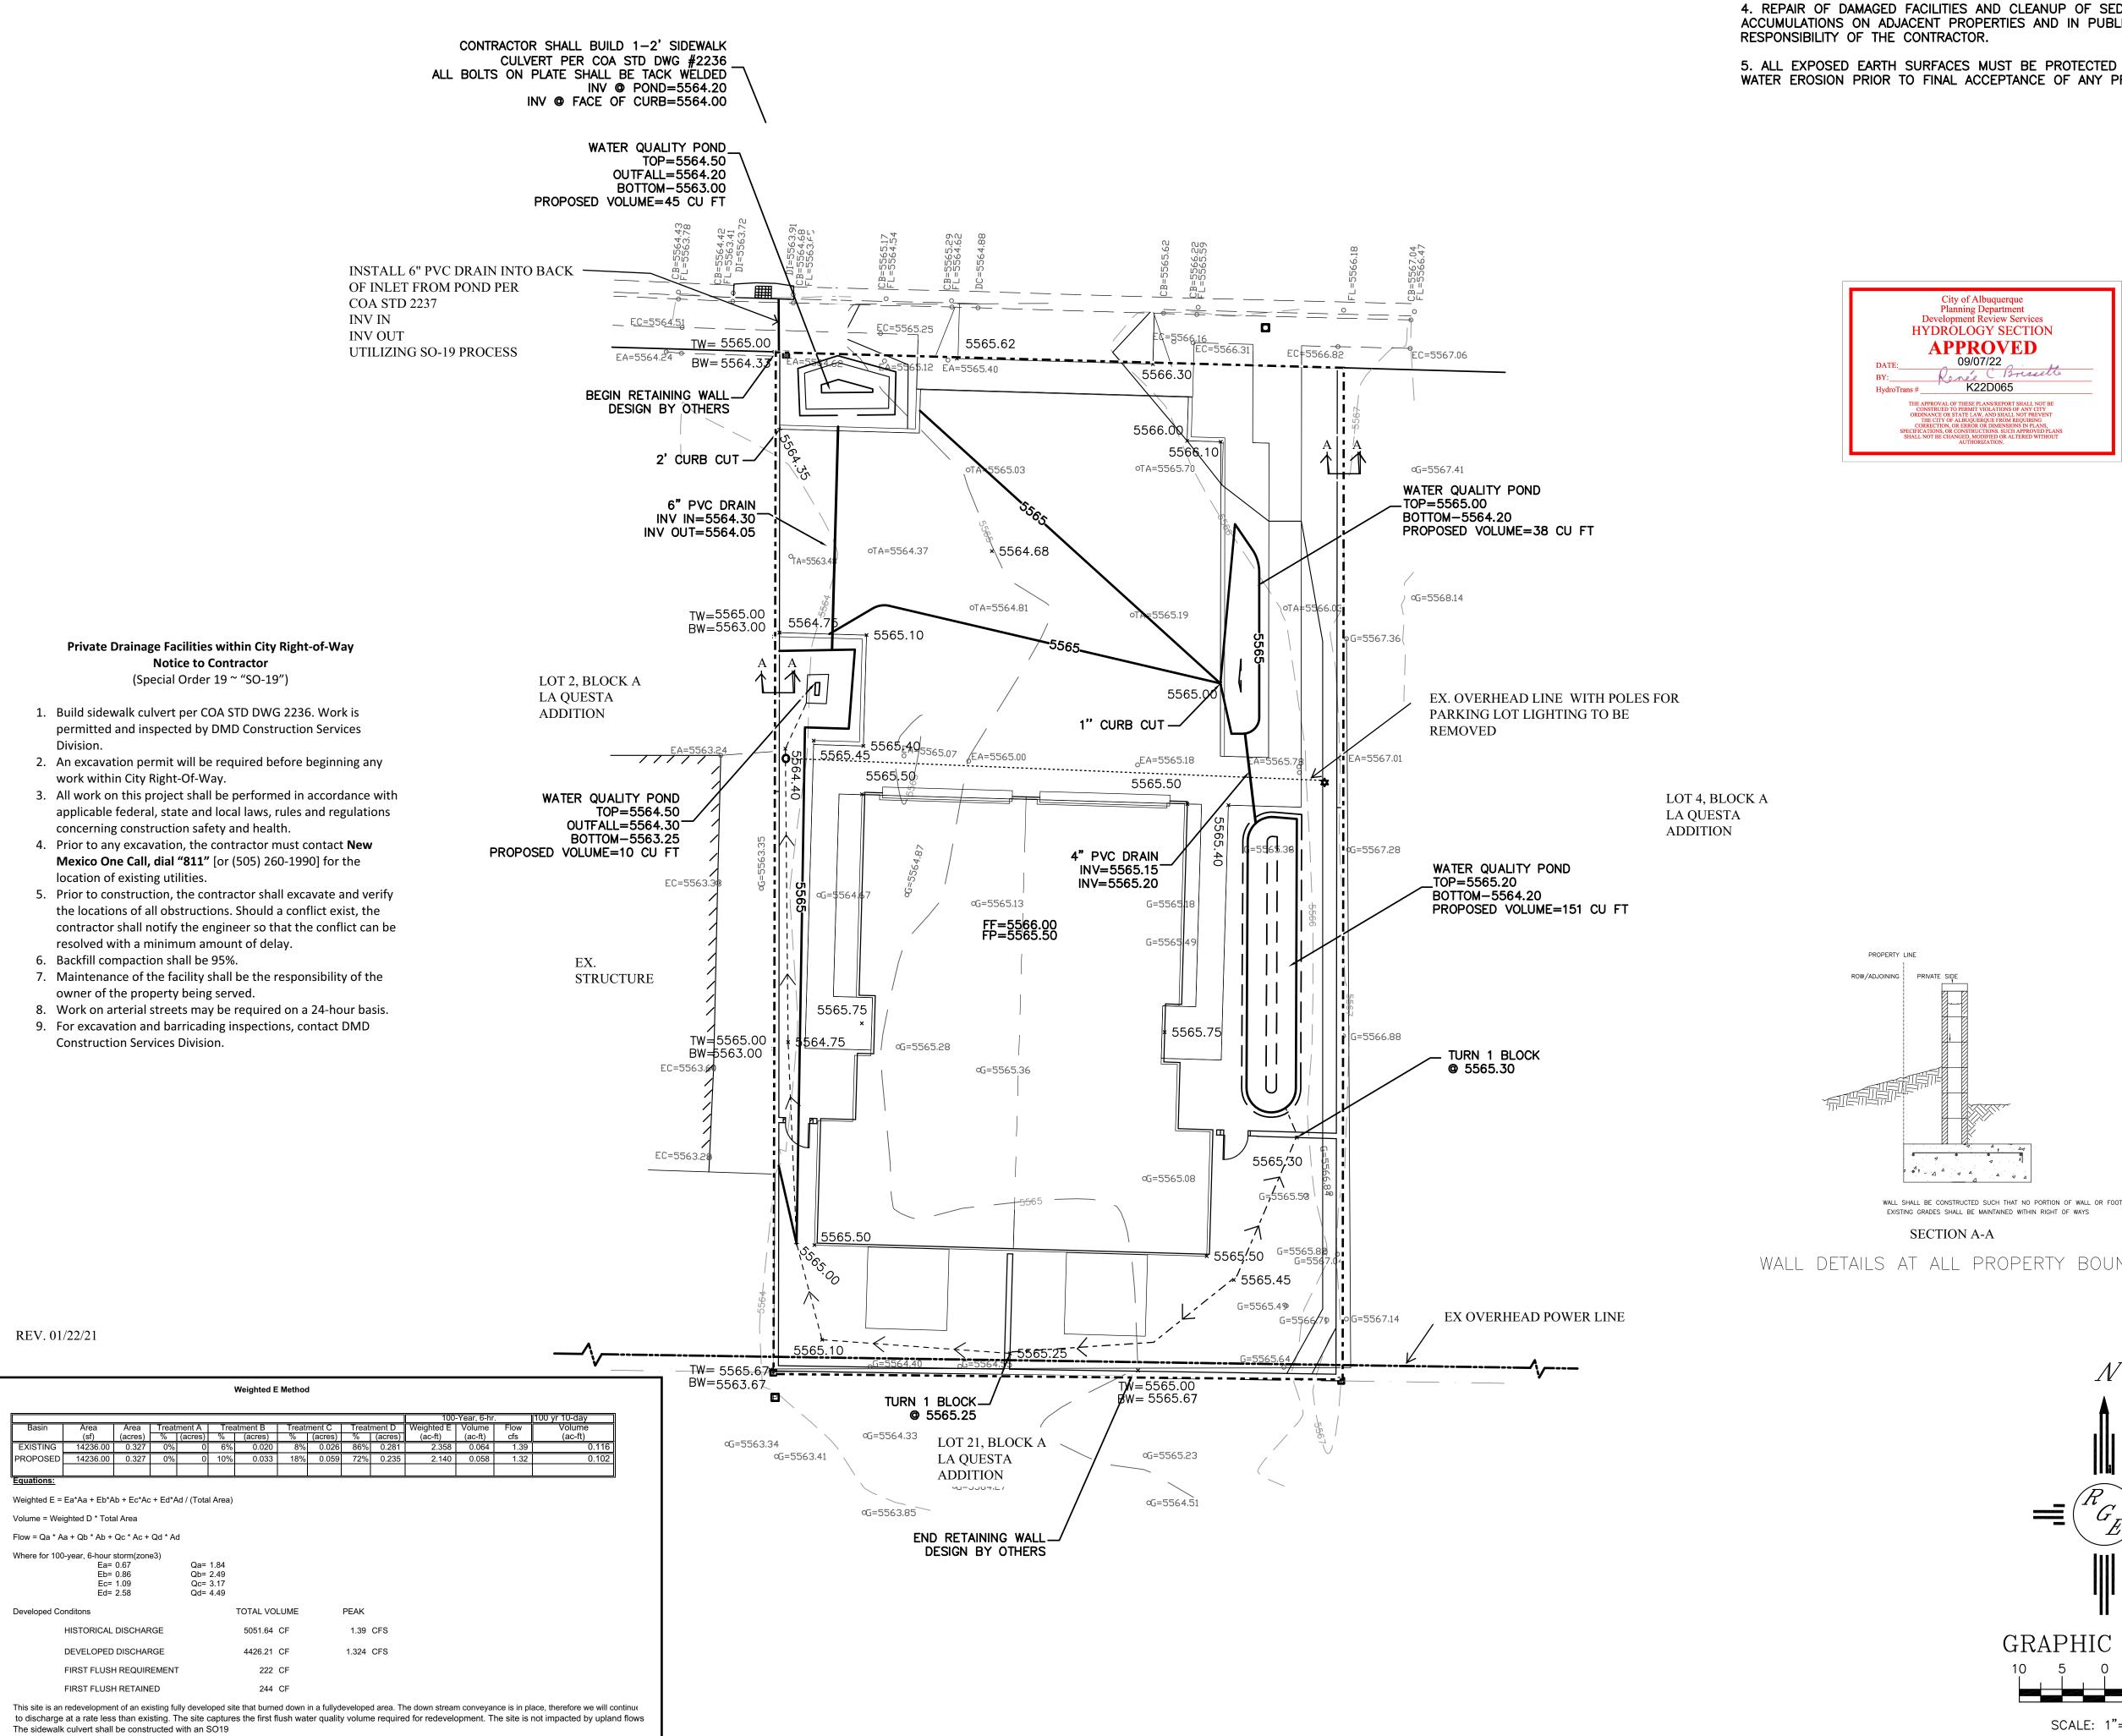

EROSION CONTROL NOTES: 1. CONTRACTOR IS RESPONSIBLE FOR OBTAINING A TOPSOIL DISTURBANCE


PERMIT PRIOR TO BEGINNING WORK. 2. CONTRACTOR IS RESPONSIBLE FOR MAINTAINING RUN-OFF ON SITE DURING

CONSTRUCTION. 3. CONTRACTOR IS RESPONSIBLE FOR CLEANING ALL SEDIMENT THAT GETS

INTO EXISTING RIGHT-OF-WAY.

4. REPAIR OF DAMAGED FACILITIES AND CLEANUP OF SEDIMENT ACCUMULATIONS ON ADJACENT PROPERTIES AND IN PUBLIC FACILITIES IS THE

5. ALL EXPOSED EARTH SURFACES MUST BE PROTECTED FROM WIND AND WATER EROSION PRIOR TO FINAL ACCEPTANCE OF ANY PROJECT.

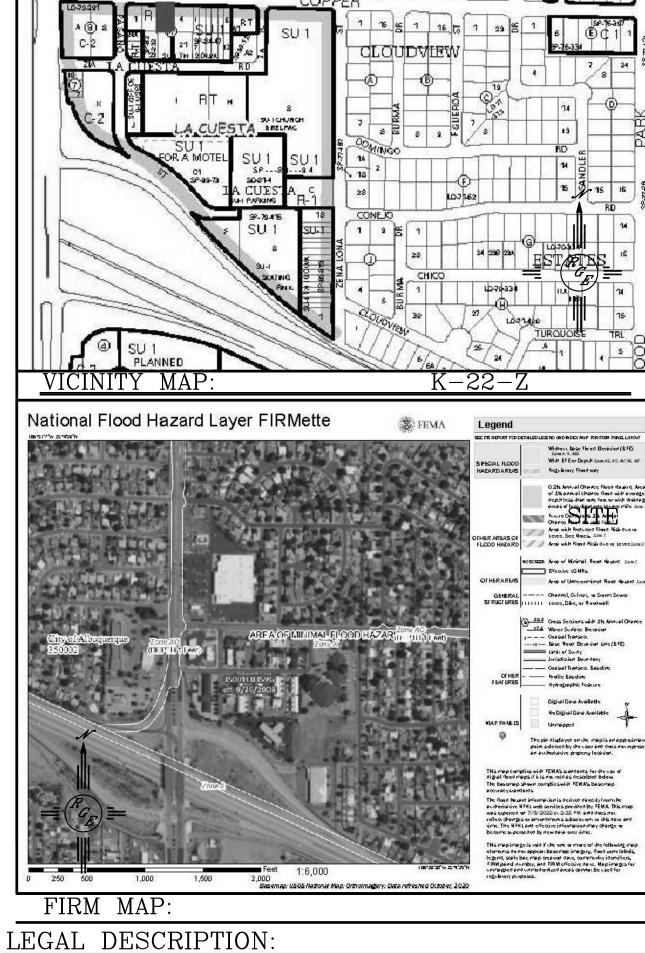

LOT 3, BLOCK "A", LA CUESTA ADDITION

SU-FORA

OMMÉRONI DEVELOPM

NOTES:

1. ALL SPOT ELEVATIONS REPRESENT FLOWLINE ELEVATION UNLESS OTHERWISE NOTED.

2. GARAGE UNITS SHALL HAVE 6" CURB AT PERIMETER EXCEPT AT GARAGE DOOR, GARAGE DOOR SHALL HAVE 1/2" LIP AT DOOR.

- 3. ALL DRIVEPADS SHALL BE BUILT PER COA STD DWG #2425.
- 4. ALL PADS SHALL BE CERTIFIED PRIOR TO CO.
- 5. ALL EX. ONSITE C&G AND PAVING SHALL BE REMOVED AND DISPOSED OF

LEGEND

	LEGEND	LEGEND		
XXX.	5414	EXISTING CONTOUR		
	5415	EXISTING INDEX CONTOUR		
	5414	PROPOSED CONTOUR		
<u> 4</u> <i>4</i> <u>4</u>		PROPOSED INDEX CONTOUR		
SUCH THAT NO PORTION OF WALL OR FOOTING SHALL ENCROACH.	►	SLOPE TIE		
aantained within right of ways -A	- 4045.00 1	EXISTING SPOT ELEVATION		
	4048.25	PROPOSED SPOT ELEVATION	PROPOSED SPOT ELEVATION	
PROPERTY BOUNDARIES	••	BOUNDARY		
		CENTERLINE		
		RIGHT-OF-WAY		
		PROPOSED CURB AND GUTTER		
Λ	========	= $=$ $=$ $=$ $=$ existing curb and gutter		
▲		PROPOSED SIDEWALK		
	— — — — — PROPOSED SETBACK			
	·	- PROPOSED LOT LINE		
-	ENGINEER'S SEAL	12016 COPPER	DRAWN BY _{WCWJ}	
=		TOWNHOMES	DATE	
	VIID SO		7-08-22	
	OP IN MET OF	GRADING AND		
	R (14522) 또 또	DRAINAGE PLAN	20220051–LAYOUT–7–08–22	
"	AROFESSIONAL	Rio Grande	SHEET #	
GRAPHIC SCALE	TOFESSION			
	7/9/22	Engineering		
			JOB #	
SCALE: 1"=10'	DAVID SOULE P.E. #14522	(505) 321–9099	20220051	
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