CITY OF ALBUQUERQUE

Planning Department Alan Varela, Director



January 29, 2024

Ronald Bohannan, P.E. Tierra West, LLC 5571 Midway Park Place NE Albuquerque, NM 87109

RE: SAFStor Storage

Permanent C.O. - Accepted

Engineer's Certification Date: 01/23/24

Engineer's Stamp Date: 09/22/22

Hydrology File: L08D013

Dear Mr. Bohannan:

PO Box 1293 Based on the Certification received 01/24/2024 and site visit on 01/26/2024, this letter serves as

a "green tag" from Hydrology Section for a Permanent Certificate of Occupancy to be issued by

the Building and Safety Division.

Renée C. Brissette

Albuquerque If you have any questions, please contact me at 924-3995 or rbrissette@cabq.gov.

Sincerely,

NM 87103

www.cabq.gov Renée C. Brissette, P.E. CFM

Senior Engineer, Hydrology

Planning Department





City of Albuquerque

Planning Department
Development & Building Services Division

DRAINAGE AND TRANSPORTATION INFORMATION SHEET (DTIS)

Project Title:		Hydrology File #		
Legal Description:				
City Address, UPC, OR Parcel	:			
Applicant/Agent:		Contact:		
		Phone:		
Email:				
Applicant/Owner:		Contact:		
		Phone:		
Email:				
(Please note that a DFT SITE is or	ne that needs Site Plan A	pproval & ADMIN SITE is one that does not need it.)		
TYPE OF DEVELOPMENT:	PLAT (#of lots)	RESIDENCE		
	DFT SITE	ADMIN SITE		
RE-SUBMITTAL: YES	NO			
DEPARTMENT: TRANS	SPORTATION	HYDROLOGY/DRAINAGE		
Cheek all that apply under Dath	the Type of Submittel	and the Type of Approval Sought:		
TYPE OF SUBMITTAL:	the Type of Submittal	TYPE OF APPROVAL SOUGHT:		
ENGINEER/ARCHITECT CERTIFICATION		BUILDING PERMIT APPROVAL		
PAD CERTIFICATION		CERTIFICATE OF OCCUPANCY		
CONCEPTUAL G&D PLAN		CONCEPTUAL TCL DFT APPROVAL		
GRADING & DRAINAGE PLAN		PRELIMINARY PLAT APPROVAL		
DRAINAGE REPORT		FINAL PLAT APPROVAL		
DRAINAGE MASTER PLAN		SITE PLAN FOR BLDG PERMIT DFT		
CLOMR/LOMR		APPROVAL		
TRAFFIC CIRCULATION LAYOUT (TCL) ADMINISTRATIVE		SIA/RELEASE OF FINANCIAL GUARANTEE		
		FOUNDATION PERMIT APPROVAL		
TRAFFIC CIRCULATION LAYOUT FOR DFT APPROVAL		GRADING PERMIT APPROVAL		
TRAFFIC IMPACT STUDY (TIS) STREET LIGHT LAYOUT		SO-19 APPROVAL PAVING PERMIT APPROVAL		
				OTHER (SPECIFY)
WORK ORDER APPROVAL				
		CLOMR/LOMR		
		OTHER (SPECIFY)		
DATE SUBMITTED:				

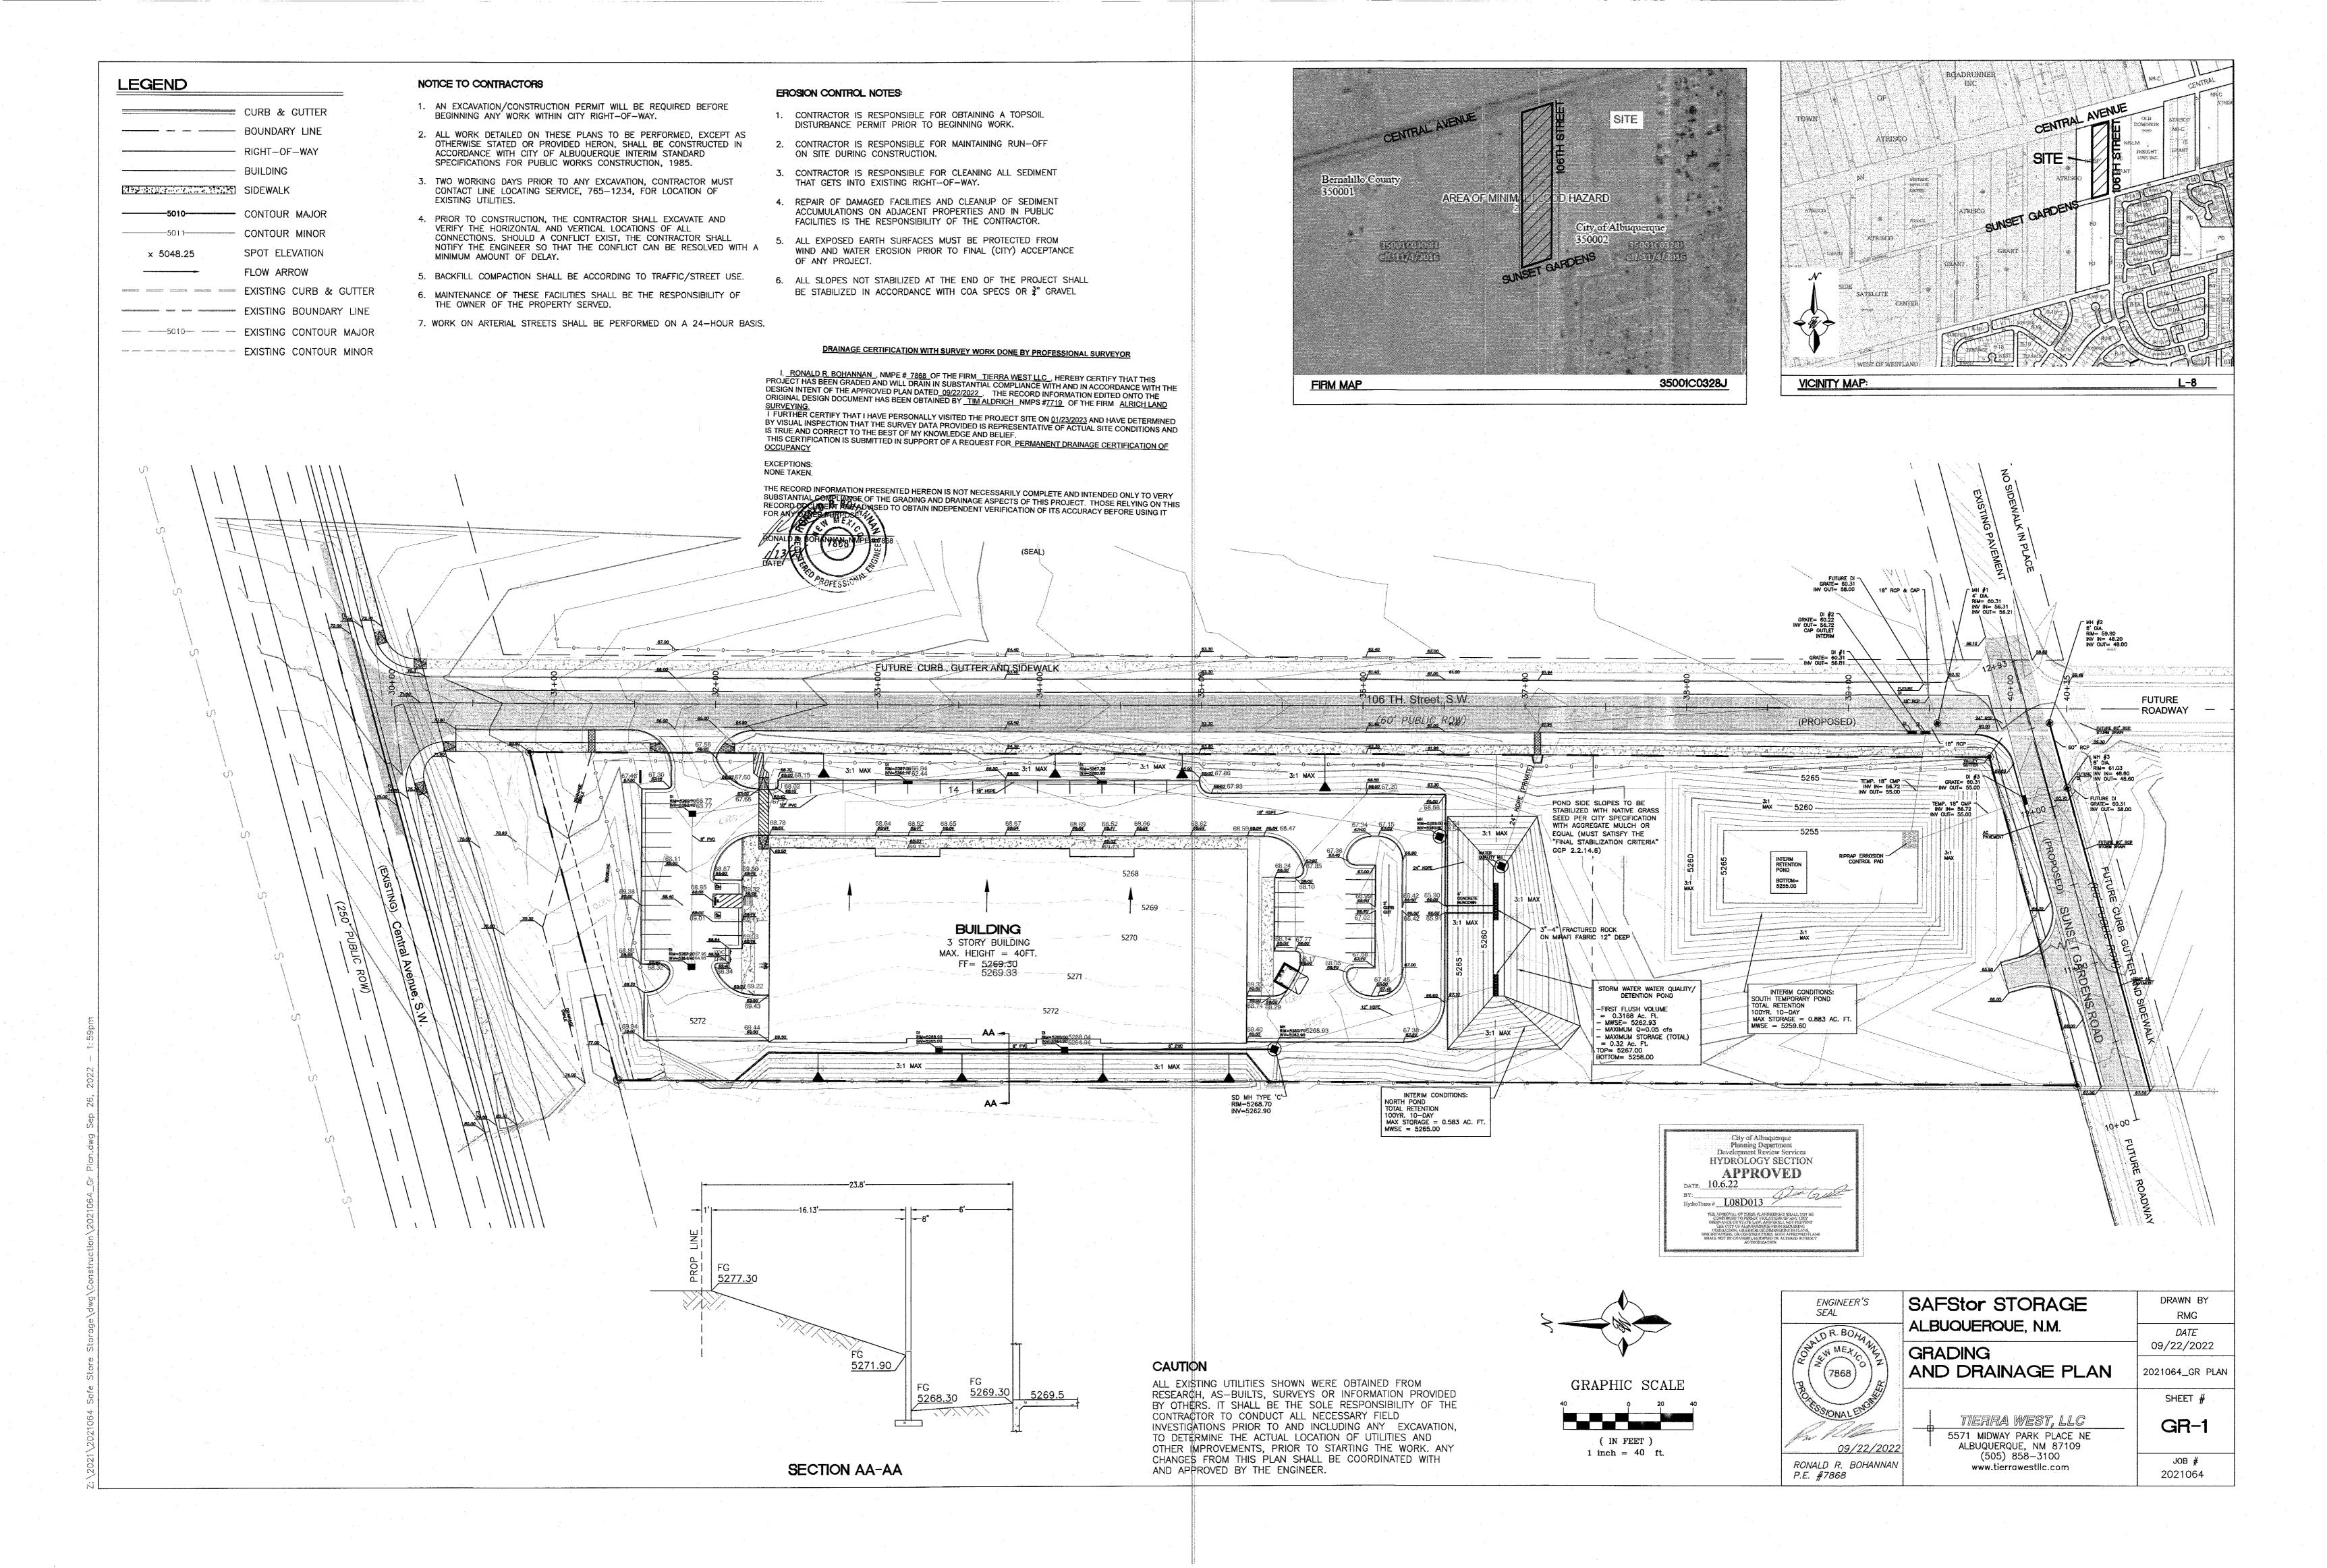

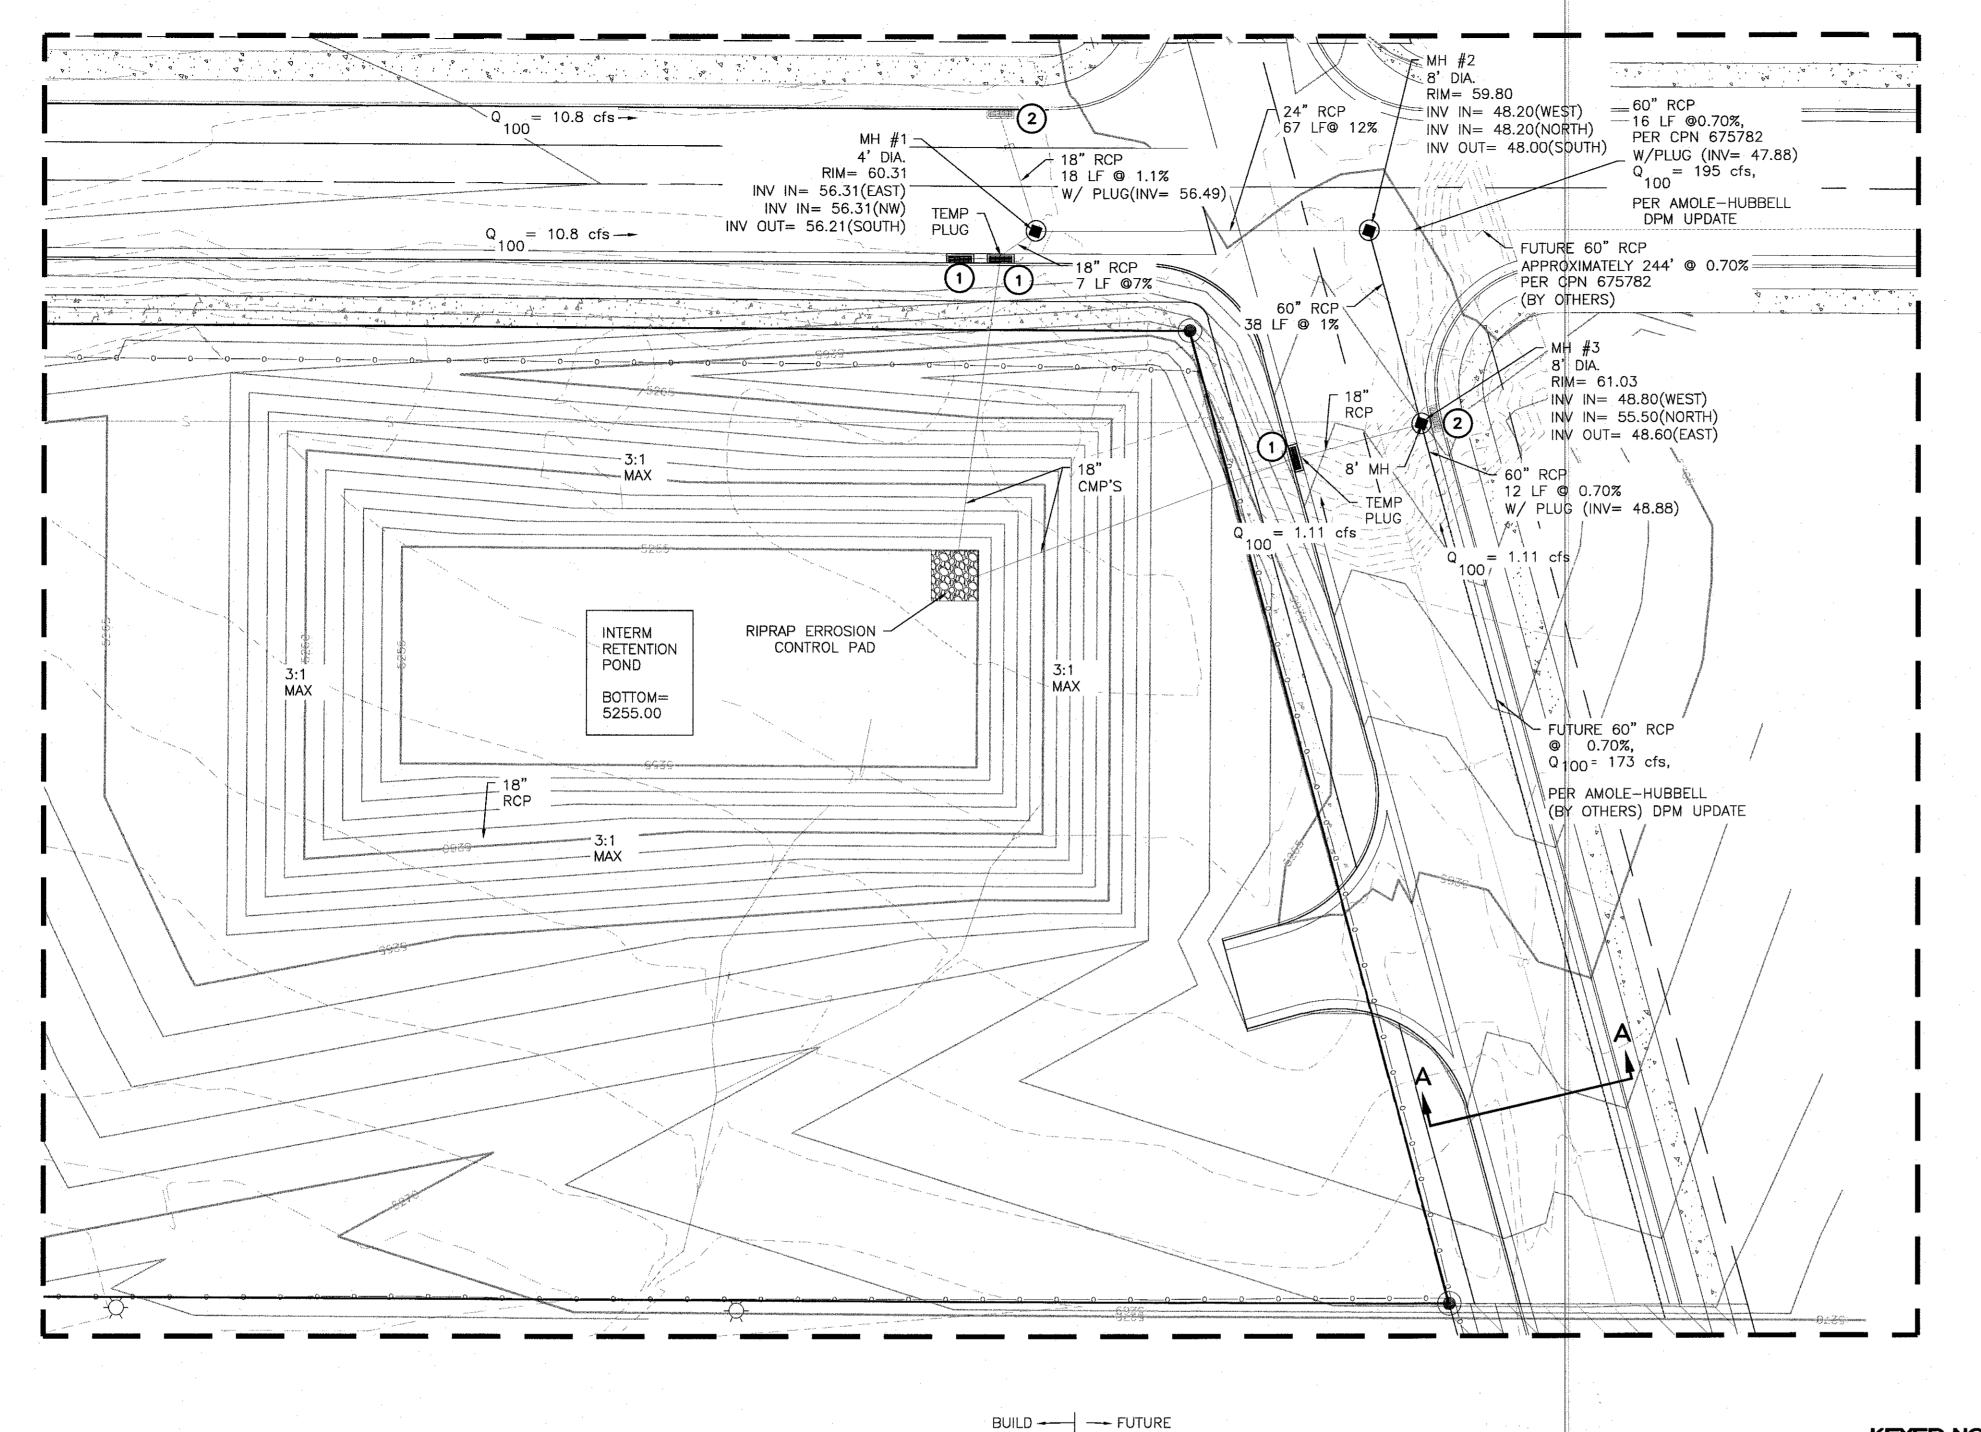

32' F.-F.

8.0' **TEMPORARY**

PAVEMENT

24' F.-E.

SUNSET GARDENS RD. SECTION A-A SCALE: NTS



GRAPHIC SCALE

(IN FEET) 1 inch = 20 ft.

DRAINAGE CERTIFICATION WITH SURVEY WORK DONE BY PROFESSIONAL SURVEYOR

I, <u>RONALD R. BOHANNAN</u>, NMPE # <u>7868</u> OF THE FIRM <u>TIERRA WEST LLC</u>, HEREBY CERTIFY THAT THIS PROJECT HAS BEEN GRADED AND WILL DRAIN IN SUBSTANTIAL COMPLIANCE WITH AND IN ACCORDANCE WITH THE DESIGN INTENT OF THE APPROVED PLAN DATED 09/22/2022 THE RECORD INFORMATION EDITED ONTO THE ORIGINAL DESIGN DOCUMENT HAS BEEN OBTAINED BY TIM ALDRICH NMPS #7719 OF THE FIRM ALRICH LAND SURVEYING.

I FURTHER CERTIFY THAT I HAVE PERSONALLY VISITED THE PROJECT SITE ON 01/23/2023 AND HAVE DETERMINED BY VISUAL INSPECTION THAT THE SURVEY DATA PROVIDED IS REPRESENTATIVE OF ACTUAL SITE CONDITIONS AND IS TRUE AND CORRECT TO THE BEST OF MY KNOWLEDGE AND BELIEF.

THIS CERTIFICATION IS SUBMITTED IN SUPPORT OF A REQUEST FOR PERMANENT DRAINAGE CERTIFICATION OF **OCCUPANCY**

EXCEPTIONS: NONE TAKEN.

THE RECORD INFORMATION PRESENTED HEREON IS NOT NECESSARILY COMPLETE AND INTENDED ONLY TO VERY SUBSTANTIAL COMPLIANCE OF THE GRADING AND DRAINAGE ASPECTS OF THIS PROJECT. THOSE RELYING ON THIS ADVISED TO OBTAIN INDEPENDENT VERIFICATION OF ITS ACCURACY BEFORE USING IT



(SEAL)

		Pipe Capacity			
e transmi attikas eka estesti.	History and the Manager		garjer defficie jamentelæ nemeses ske		digrama o oryanosmicze w o arangija :
D	Slope	Area	R	Q Provided	Velocity
(in)	(%)	(ft^2)		(cfs)	(ft/s)
60	0.7	19.63	125	218.49	11.13
60	1	19.63	1.25	261.14	13.30
24	12	3.14	0.5	78.58	25.01
18	1.1	1.77	0.375	11.05	6.25
18	7	1.77	0.375	27.87	15.77



5.0'


SIDEWALK

5.0'

-FUTURE 60" RCP

1) TYPE "A" DBL INLET

2 FUTURE TYPE "A" DBL INLET (BY OTHERS)

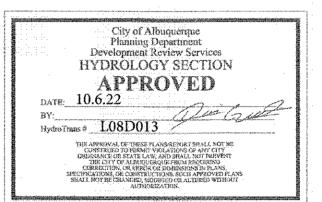

P.E. #7868

CAUTION

ALL EXISTING UTILITIES SHOWN WERE OBTAINED FROM RESEARCH, AS-BUILTS, SURVEYS OR INFORMATION PROVIDED BY OTHERS. IT SHALL BE THE SOLE RESPONSIBILITY OF THE CONTRACTOR TO CONDUCT ALL NECESSARY FIELD INVESTIGATIONS PRIOR TO AND INCLUDING ANY EXCAVATION, TO DETERMINE THE ACTUAL LOCATION OF UTILITIES AND OTHER IMPROVEMENTS, PRIOR TO STARTING THE WORK. ANY CHANGES FROM THIS PLAN SHALL BE COORDINATED WITH AND APPROVED BY THE ENGINEER.

ENGINEER'S SEAL	SAFStor STORAGE
OR. BOHA	ALBUQUERQUE, N.M.
TREE TREE TO TREE TO TREE TO TREE TREE T	GRADING AND DRAINAGE PL
ERSONAL ENGIN	TIERRA WEST, LLO
09/22/2022	5571 MIDWAY PARK PLACE ALBUQUERQUE, NM 87109
RONALD R. BOHANNAN	(505) 858-3100 www.tierrawestllc.com

	SAFStor STORAGE	DRAWN BY
		RMG
	ALBUQUERQUE, N.M.	DATE
到	GRADING	09/22/2022
7 413	AND DRAINAGE PLAN	2021064_GR PLA
		SHEET #
er _{Similar} and similar in the	TIERRA WEST, LLC 5571 MIDWAY PARK PLACE NE	GR-2
/2022	ALBUQUERQUE, NM 87109	
A IA IA A I	(505) 858-3100	JOB #

2021064

10.0'

STANDARD C&G PER COA STD DWG

SIDEWALK -7

2415A