CITY OF ALBUQUERQUE

Planning Department Alan Varela, Director



July 31, 2024

Bryan Bobrick Isaacson & Arfman, P.A. 128 Monroe St. N.E Albuquerque, NM 87108

RE: Mercado El Milagro - Building D 30-Day Temporary CO - Approved Engineer's Stamp Date: 06/30/22

Engineer's Certification Date: 7/29/2024

Hydrology File: L09D042A

Dear Mr. Bobrick:

Based on the Engineer's Drainage Certification received 07/31/2024 and site visit on 7/31/2024, this letter serves as a "green tag" from Hydrology Section for a <u>30-day Temporary Certificate</u> <u>of Occupancy</u> for the Mercado El Milagro Building D located at 10000 Central SW to be issued by the Building and Safety Division. The following comment needs to be addressed prior to acceptance for Permanent C.O. of the above referenced project:

PO Box 1293

Albuquerque

1. Please provide the executed paper Drainage Covenant (latest revision) printed on one-side only with Exhibit A and a check for \$25.00 made out to "Bernalillo County" for the stormwater quality ponds per Article 6-15(C) of the DPM to Hydrology.

NM 87103

Please resubmit for a request for permanent release of Certificate of Occupancy once the above item is complete.

www.cabq.gov

If you have any questions, please contact me at 505-924-3314 or <u>amontoya@cabq.gov</u>.

Sincerely,

Anthony Montoya, Jr., P.E.

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Senior Engineer, Hydrology

Planning Department, Development Review Services



City of Albuquerque Planning Department


Development & Building Services Division

DRAINAGE AND TRANSPORTATION INFORMATION SHEET (DTIS)

Project Title:	Hydrology File #
Legal Description:	
City Address, UPC, OR Parcel:	
Applicant/Agent:	Contact:
Address:	
Email:	
Applicant/Owner:	
Address:	
Email:	
TYPE OF DEVELOPMENT: Plat (# of lots)	
RE-SUBMITTAL:	: YES NO
DEPARTMENT: TRANSPORTATION	HYDROLOGY/DRAINAGE
Check all that apply under Both the Type of Submittal	and the Type of Approval Sought:
ГҮРЕ OF SUBMITTAL:	TYPE OF APPROVAL SOUGHT:
Engineering / Architect Certification	Pad Certification
Conceptual Grading & Drainage Plan	Building Permit
Grading & Drainage Plan, and/or Drainage	Grading Permit
Report	Paving Permit
Drainage Report (Work Order)	SO-19 Permit
Drainage Master Plan	Foundation Permit
Conditional Letter of Map Revision (CLOMR)	Certificate of Occupancy - Temp Perm
Letter of Map Revision (LOMR)	Preliminary / Final Plat
Floodplain Development Permit	Site Plan for Building Permit - DFT
Traffic Circulation Layout (TCL) – Administrative	Work Order (DRC)
Traffic Circulation Layout (TCL) – DFT Approval	Release of Financial Guarantee (ROFG) CLOMR / LOMR
Traffic Impact Study (TIS)	Conceptual TCL - DFT
Street Light Layout	<u>.</u>
·	OTHER (SPECIFY)
OTHER (SPECIFY)	

REV. 04/03/24

DATE SUBMITTED:

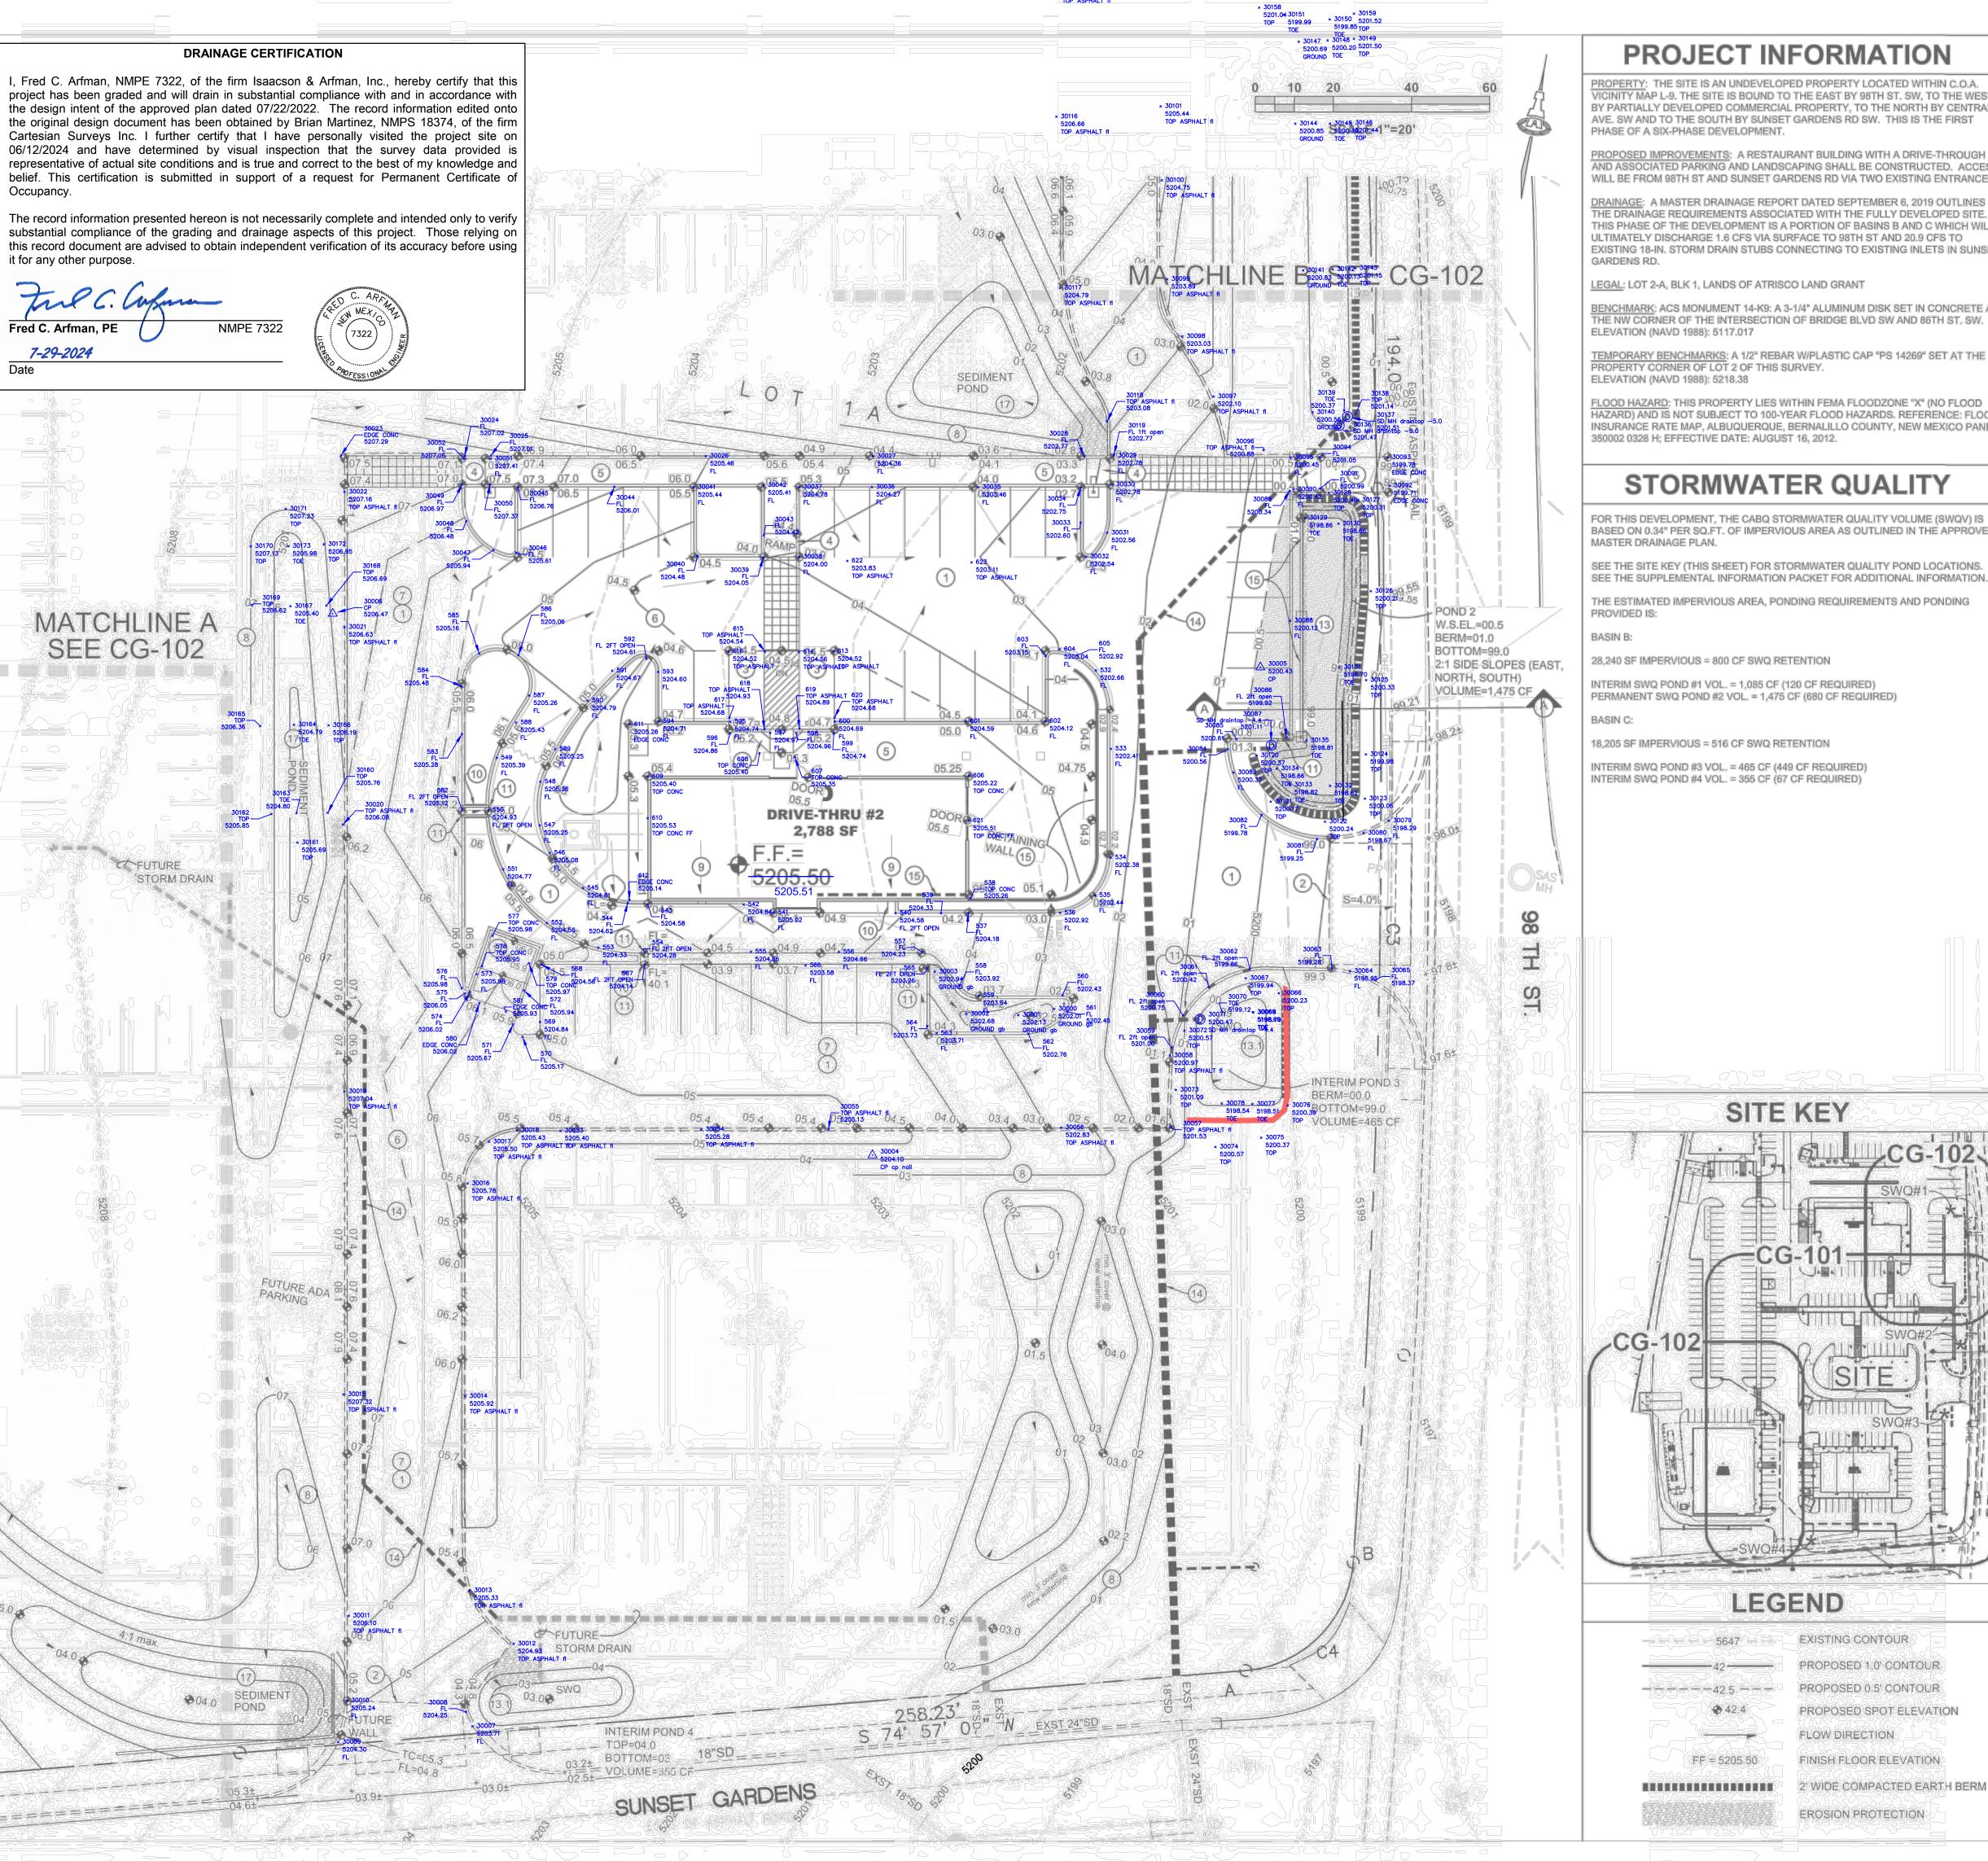

PROJECT INFORMATION

VICINITY MAP L-9. THE SITE IS BOUND TO THE EAST BY 98TH ST, SW, TO THE WEST BY PARTIALLY DEVELOPED COMMERCIAL PROPERTY, TO THE NORTH BY CENTRAL AVE. SW AND TO THE SOUTH BY SUNSET GARDENS RD SW. THIS IS THE FIRST

PROPOSED IMPROVEMENTS: A RESTAURANT BUILDING WITH A DRIVE-THROUGH AND ASSOCIATED PARKING AND LANDSCAPING SHALL BE CONSTRUCTED. ACCESS WILL BE FROM 98TH ST AND SUNSET GARDENS RD VIA TWO EXISTING ENTRANCES.

HE DRAINAGE REQUIREMENTS ASSOCIATED WITH THE FULLY DEVELOPED SITE. THIS PHASE OF THE DEVELOPMENT IS A PORTION OF BASINS B AND C WHICH WILL ULTIMATELY DISCHARGE 1.6 CFS VIA SURFACE TO 98TH ST AND 20.9 CFS TO EXISTING 18-IN, STORM DRAIN STUBS CONNECTING TO EXISTING INLETS IN SUNSET

LEGAL: LOT 2-A, BLK 1, LANDS OF ATRISCO LAND GRANT

BENCHMARK: ACS MONUMENT 14-K9: A 3-1/4" ALUMINUM DISK SET IN CONCRETE AT HE NW CORNER OF THE INTERSECTION OF BRIDGE BLVD SW AND 86TH ST., SW,

EMPORARY BENCHMARKS: A 1/2" REBAR W/PLASTIC CAP "PS 14269" SET AT THE NW ROPERTY CORNER OF LOT 2 OF THIS SURVEY.

LOOD HAZARD: THIS PROPERTY LIES WITHIN FEMA FLOODZONE "X" (NO FLOOD AZARD) AND IS NOT SUBJECT TO 100-YEAR FLOOD HAZARDS. REFERENCE: FLOOD INSURANCE RATE MAP, ALBUQUERQUE, BERNALILLO COUNTY, NEW MEXICO PANEL

STORMWATER QUALITY

FOR THIS DEVELOPMENT, THE CABO STORMWATER QUALITY VOLUME (SWQV) IS BASED ON 0.34" PER SQ.FT. OF IMPERVIOUS AREA AS OUTLINED IN THE APPROVED

SEE THE SITE KEY (THIS SHEET) FOR STORMWATER QUALITY POND LOCATIONS.

THE ESTIMATED IMPERVIOUS AREA, PONDING REQUIREMENTS AND PONDING

PROPOSED 10 CONTOUR

PROPOSED 0.5' CONTOUR

FINISH FLOOR ELEVATION

2' WIDE COMPACTED EARTH BERM

FLOW DIRECTION

PROPOSED SPOT ELEVATION

INTERIM SWQ POND #1 VOL. = 1,085 CF (120 CF REQUIRED)

18,205 SF IMPERVIOUS = 516 CF SWQ RETENTION

INTERIM SWQ POND #3 VOL. = 465 CF (449 CF REQUIRED) INTERIM SWQ POND #4 VOL. = 355 CF (67 CF REQUIRED)

THESE NOTES ARE REFERENCED ON SHEETS CG-101 AND CG-102. NOT ALL NOTES ARE USED ON EACH SHEET.

KEYED NOTES

- CONSTRUCT NEW PAVING AT ELEVATIONS SHOWN. SEE PAVING PLANT FOR MATERIAL, EXTENTS, JOINTS AND PAVING SECTIONS. NOTE: TO !! ADJACENT TOP OF CURB / TOP OF WALK ELEVATIONS. TEXT SHOWN WITHIN FLOWLINE INDICATES FLOWLINE ELEVATION. ADD 0.5' TYPICAL FOR TOP OF CURB / TOP OF ADJACENT WALK ELEVATIONS.
- 2. PROVIDE SMOOTH TRANSITION TO EXISTING PAVEMENT.
- ADA COMPLIANT PARKING.

1"=750'± L - 09 - Z

- 4. ADA COMPLIANT ACCESS RAMP.
- 5. ADA COMPLIANT PEDESTRIAN WALK.
- 6. 0.5' DESIGN CONTOURS ARE SHOWN DASHED WHERE NECESSARY TO CLARIFY GRADING CONCEPT.
- 7. PROPOSED ASPHALT PAVEMENT GRADES / SLOPES ARE NOT UNIFORM DUE TO FUTURE CONSTRUCTION TO ACHIEVE OVERALL GRADING PLAN. CONTRACTOR SHALL ADHERE TO GRADES SHOWN TO PROVIDE FOR FUTURE IMPROVEMENTS. TYPICAL.
- 8. TEMPORARY GRADING TO TRANSITION @ 4:1 MAX. SIDE SLOPE (SAME
- 9. ROOF DISCHARGE TO BE RELEASED TO SOUTH SIDE. 2' WIDE CURB CUT/RUNDOWN AT EACH ROOF DISCHARGE LOCATION. INSTALL SPLASH BLOCK OR ROCK EROSION PROTECTION. SEE ARCHITECTURAL FOR SPECIFIC ROOF DRAIN LOCATIONS.
- 10. 24" WIDE (BOTTOM WIDTH) 'U' SHAPED CHANNEL THROUGH PARKING MISLAND, SEE DETAIL ON SHEET CG-501
- PROVIDE 24" WIDE CURB OPENING TO PASS FLOW. SEE DETAIL ON SHEET
- 12. CONCRETE DUMPSTER PAD SLOPED TO SAS DRAIN INLET. SEE UTILITY
- CERTIFICATION. PONDS WHICH DO NOT PROVIDE THE REQUIRED
- EROSION PROTECTION TO EXTENTS SHOWN.
- PRIVATE STORM DRAIN SYSTEM. SEE SHEET CG-103 FOR SIZES / SLOPES
- GARDEN RETAINING WALL(S) (RETAINING < 30") TO ACHIEVE GRADE DIFFERENCE SHOWN. GRADE ON HIGH SIDE OF WALL AND GRADE ON ARCHITECTURAL FOR DETAILS INCLUDING ADDITIONAL FENCE/WALL HEIGHT ABOVE RETAINING, FOOTING, GUARDRAIL, WEEPHOLES, REINFORCING, ETC.
- BUILDING EXTENDED STEMWALL REQUIRED TO ACHIEVE GRADES SHOWN, SEE ARCHITECTURAL / STRUCTURAL PLANS.
- TEMPORARY SEDIMENT POND AT ELEVATIONS SHOWN. MAX. 4:1 SIDE OVERFLOW TO EXTENTS SHOWN.



ADA COMPLIANCE

SIDEWALK(S) AND RAMP(S): TARGET CROSS SLOPE = 1% TO 1.5%. CROSS SLOPE SHALL NOT EXCEED 2%

ACCESSIBLE RAMP(S): TARGET LONGITUDINAL SLOPE = 7% LONGITUDINAL SLOPE SHALL NOT EXCEED 12:1 (8.3%). ACCESSIBLE PARKING: TARGET SLOPE = 1% TO 1.5%. SLOPE SHALL NOT

EXCEED 2% SLOPE IN ANY DIRECTION







GRADING & DRAINAGE PLAN 1 OF 2

30 JUNE 2022 O DRAWN BY: ÅNW/BJB CHECKED BY:

VERIFIED BY:

REVISIONS

SHEET NO: **CG-101**