

DECIDUOL	DECIDUOUS TREE			
	8	ACER NEGUNDO 'SENSATION' / SENSATION BOX ELDER MAPLE	2" B&B	
	1	CERCIS RENIFORMIS 'OKLAHOMA' / OKLAHOMA RED BUD	2" B&B	
	4	MALUS X 'SPRING SNOW' / SPRING SNOW CRABAPPLE	2" B&B	
	24	QUERCUS BUCKLEYI / BUCKLEY OAK	2" B&B	
	4	ULMUS PARVIFOLIA `ALLEE` / ALLEE® LACEBARK ELM	2" B&B	
	6	ULMUS PROPINQUA 'EMERALD SUNSHINE' / EMERALD SUNSHINE ELM	2" B&B	
EVERGRE	EN TRE	<u>:E</u>		
EVERGRE ONE OF THE PROPERTY O	6	PINUS ELDARICA / AFGHAN PINE	6`	
DESERT A	CCENT			
<u></u>	34	HESPERALOE PARVIFLORA / RED YUCCA	5 GAL	
**************************************	17	NOLINA MICROCARPA / BEARGRASS	5 GAL	
DECIDUOL	DECIDUOUS SHRUBS			
<u></u>	20	AMORPHA CANESCENS / LEADPLANT	5 GAL	
67. M	29	CARYOPTERIS X CLANDONENSIS 'DARK KNIGHT' / BLUE MIST SPIREA	1 GAL	
	4	LEUCOPHYLLUM FRUTESCENS / TEXAS SAGE	5 GAL	
	4	PEROVSKIA ATRIPLICIFOLIA / RUSSIAN SAGE	5 GAL	
+	15	SALVIA GREGGII / AUTUMN SAGE CHERRY	1 GAL	
EVERGRE	EVERGREEN SHRUBS			
	23	ARTEMISIA FILIFOLIA / SAND SAGEBRUSH	5 GAL	

- 2. POSITIVE DRAINAGE AWAY FROM ALL STRUCTURES SHALL BE PROVIDED TO THE LANDSCAPE CONTRACTOR AND SHALL BE MAINTAINED BY THE LANDSCAPE CONTRACTOR THROUGHOUT THE DURATION OF THE PROJECT. 3. GRADING OF THE SITE PER THE GRADING PLAN IS NOT INCLUDED IN THE
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- 8. PURSUANT TO 5-6(C)(5)(e), BARK MULCH AREAS CLEARLY DELINEATED ON PLANS FOR LANDSCAPE AREAS AND 5' RADIUS RINGS AROUND TREES.

MANHOLES, HYDRANTS AND FIRE DEPARTMENT CONNECTIONS.

- 9. PURSUANT TO 5-6(C)(7)(a), ALL VEGETATION HAS BEEN LOCATED A MINIMUM OF 3' IN ANY DIRECTION FROM FIRE HYDRANTS, VALVE VAULTS, HOSE BIBS,
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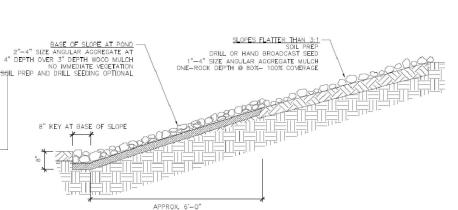
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WATER WASTE REDUCTION ORDINANCE) AS APPLICABLE*."


WATER AUTHORITY (ABCWUA) LEGISLATION AND ORDINANCES (WATER

IRRIGATION NOTES


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- 7. PER 5-6(C)(14)(c), ALL NON-RESIDENTIAL LANDSCAPE IRRIGATION SHALL HAVE AUTOMATIC TIMERS AND/OR PROGRAMMABLE SETTINGS TO AVOID OVERWATERING.
- 8. PER 5-6(C)(14)(d), THE IRRIGATION SYSTEM SHALL NOT SPRAY OR IRRIGATE IMPERVIOUS SURFACES, INCLUDING SIDEWALKS, DRIVEWAYS, DRIVE AISLES, STREETS, AND PARKING AND LOADING AREAS.






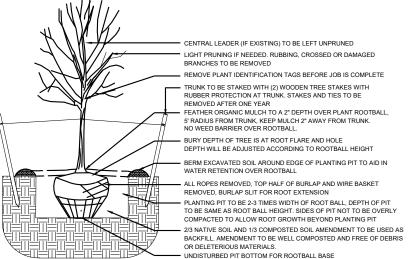

TREE PLANTING DETAIL

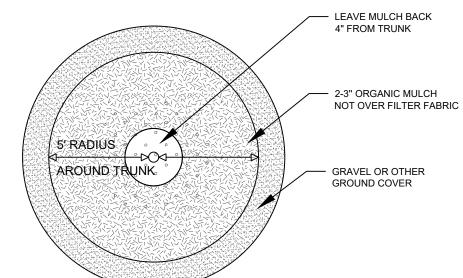

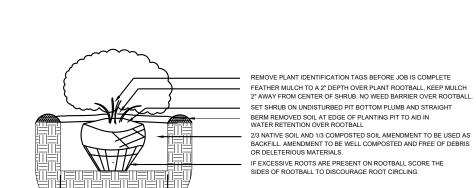

SHRUB PLANTING DETAIL

7 TREE DETAIL

YELLOWSTONE

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04/16//2025


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08/09/2024 Date: Revisions: 09/30/2024 02/11/2025

Drawn by: CC


Reviewed by: CM

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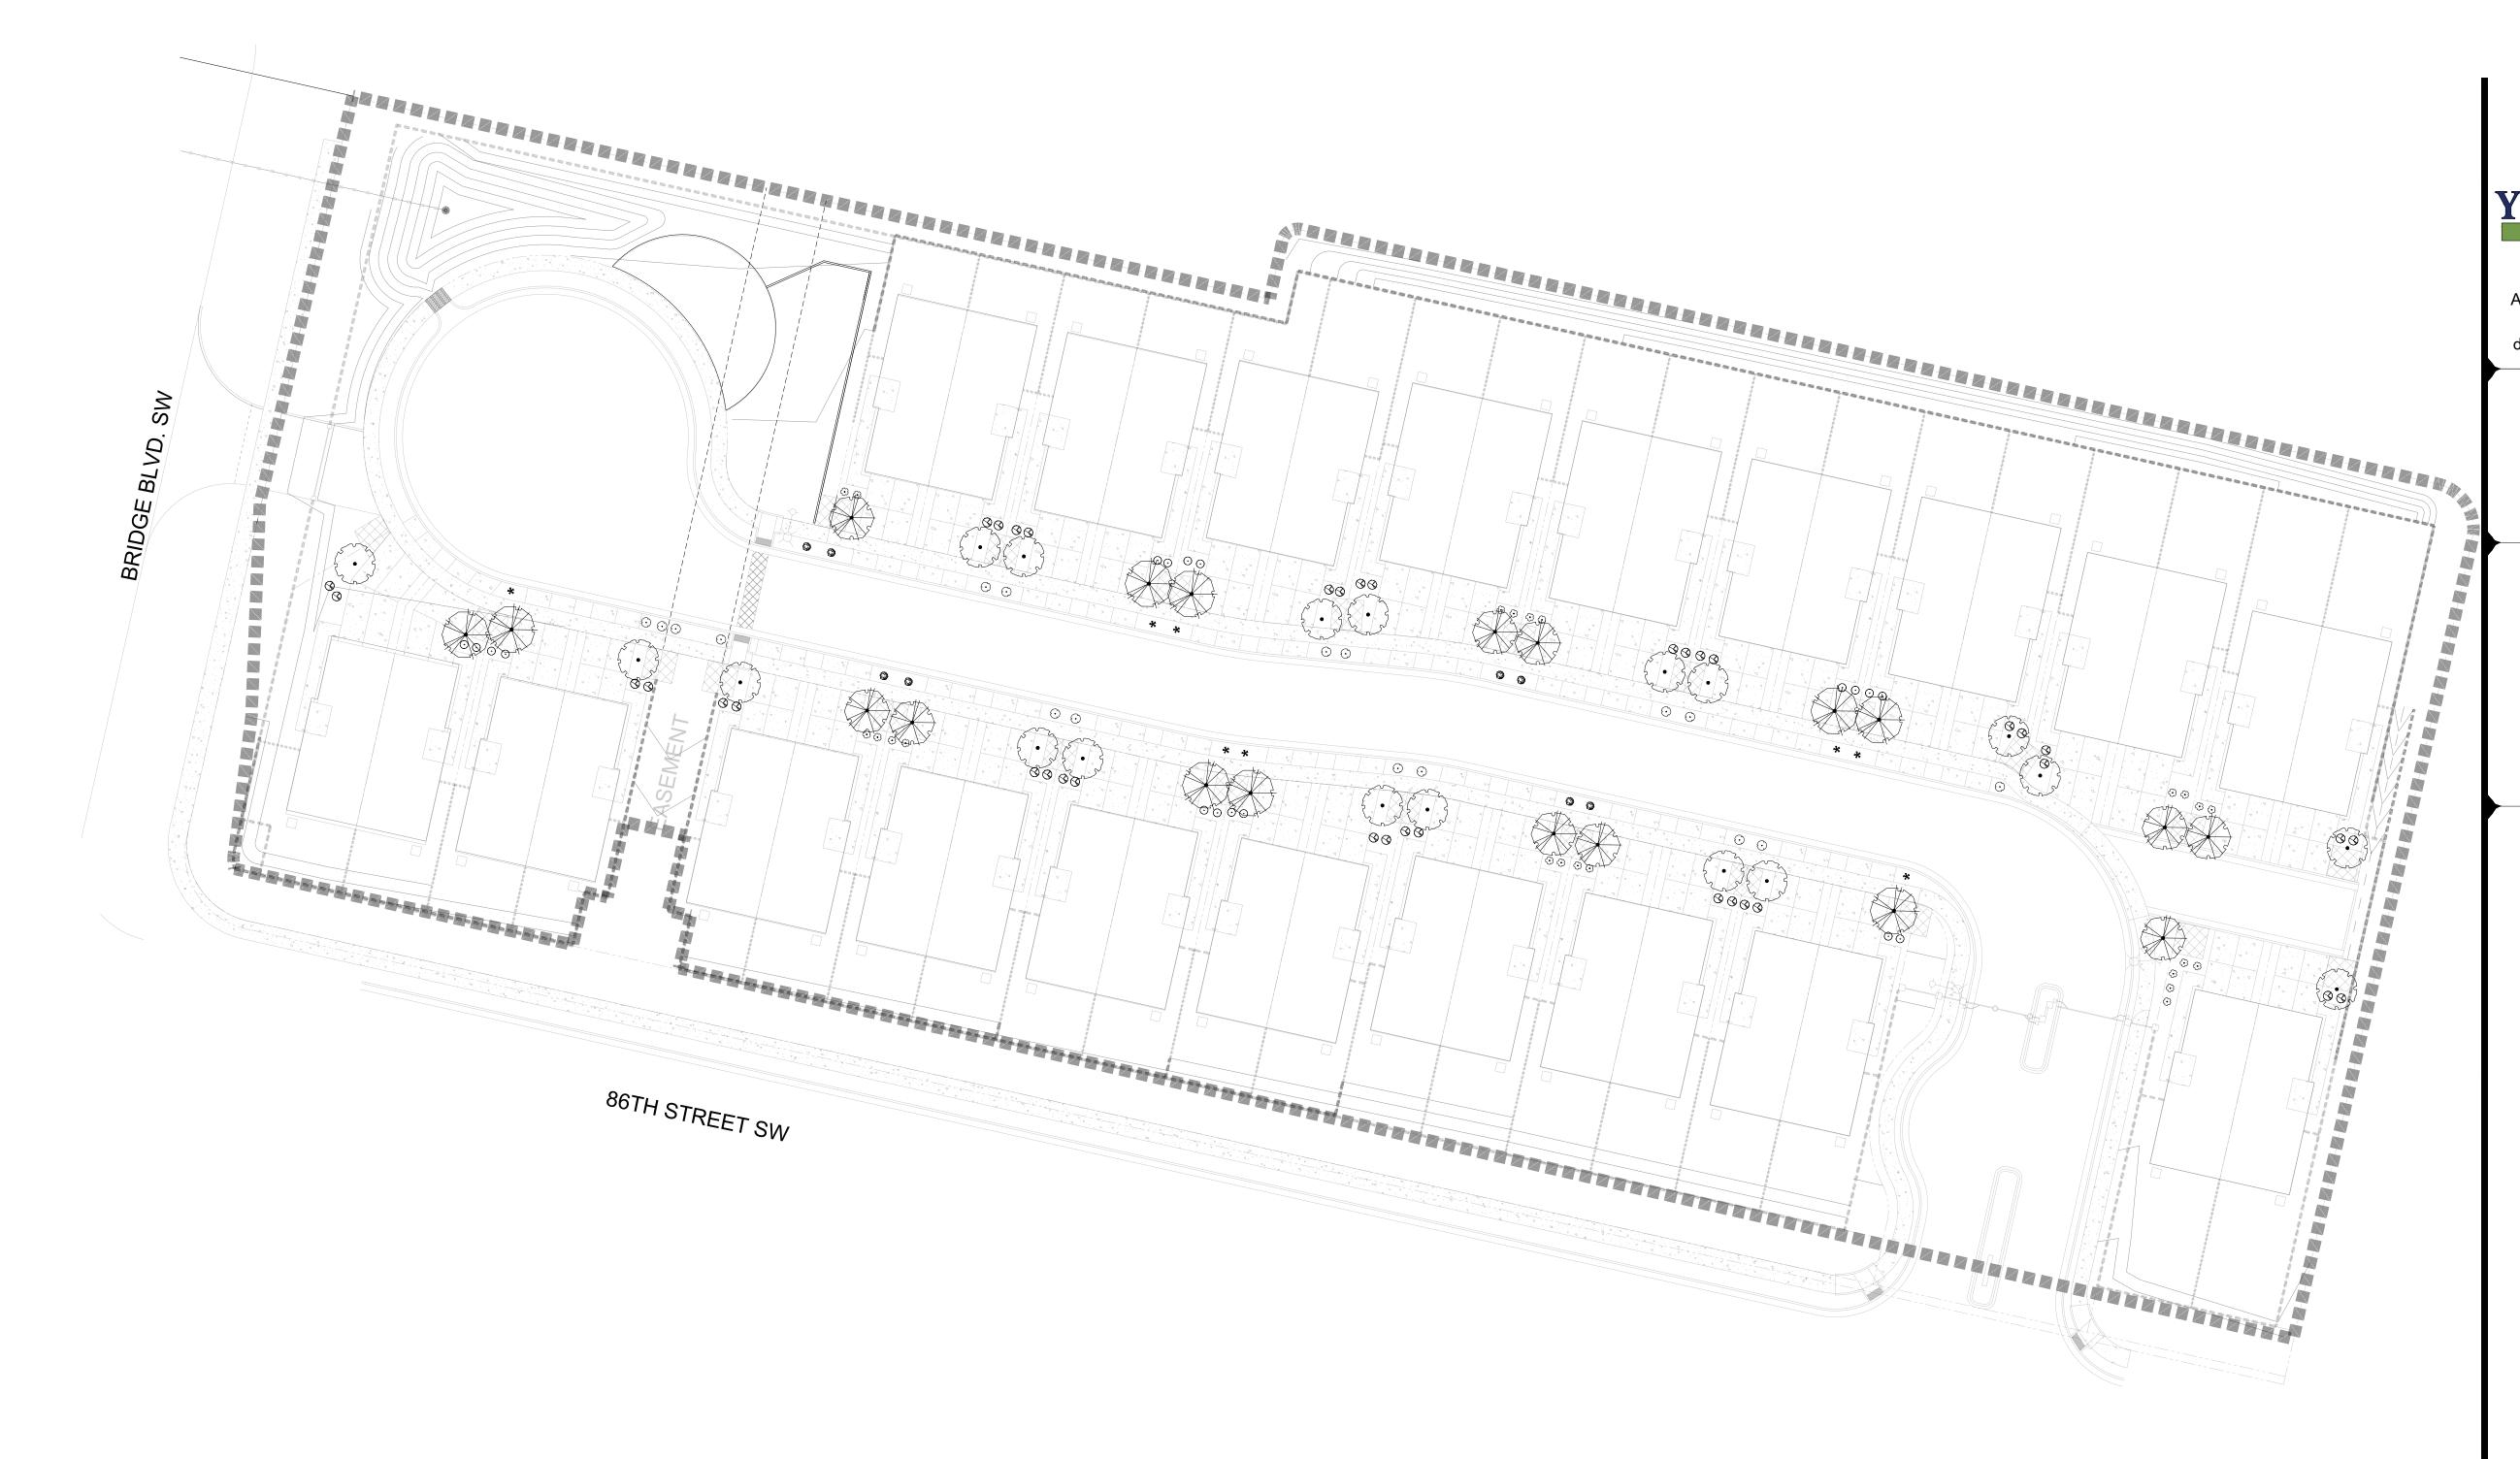
Albuquerq

Scale: 1" = 30'

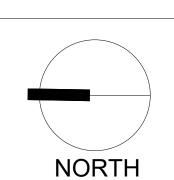

Sheet Title: **Planting** Plan

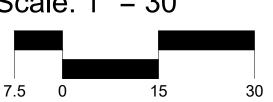Sheet Number:



PLANT SCHEDULE

· L/ \	• •	OOTILDOLL	
SYMBOL	QTY	BOTANICAL / COMMON NAME	SIZE
DECIDUOL	JS TRE	<u>E</u>	
	10	CRATAEGUS CRUS-GALLI 'INERMIS' / THORNLESS HAWTHORN	2" B&B
	9	KOELREUTERIA PANICULATA / GOLDEN RAIN TREE	2" B&B
	19	PYRUS CALLERYANA 'CLEVELAND SELECT' / CLEVELAND SELECT PEAR	2" B&B
DECIDUOL	DECIDUOUS SHRUBS		
(·)	17	AMORPHA CANESCENS / LEADPLANT	5 GAL
	8	BERBERIS THUNBERGII 'CRIMSON PYGMY' / CRIMSON PYGMY BARBERRY	5 GAL
+	18	SALVIA GREGGII / AUTUMN SAGE CHERRY	1 GAL
	8	SALVIA GREGGII `ULTRAVIOLET` / ULTRAVIOLET AUTUMN SAGE	1 GAL
EVERGREEN SHRUBS			
	38	RHAPHIOLEPIS INDICA / INDIAN HAWTHORN	5 GAL

SANTOLINA CHAMAECYPARISSUS / LAVENDER COTTON

GENERAL NOTES

- 1. IN CASE OF DISCREPANCIES IN PLANT QUANTITIES SHOWN ON THE PLANT SCHEDULE AND THOSE SHOWN ON THE PLAN, THE QUANTITIES SHOWN ON THE PLAN SHALL PREVAIL. CONTRACTOR SHALL VERIFY ALL QUANTITIES PRIOR TO BID AND INSTALLATION.
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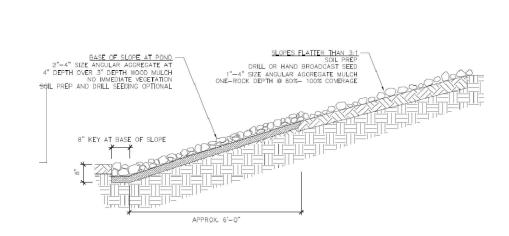
GENERAL NOTES CONT.

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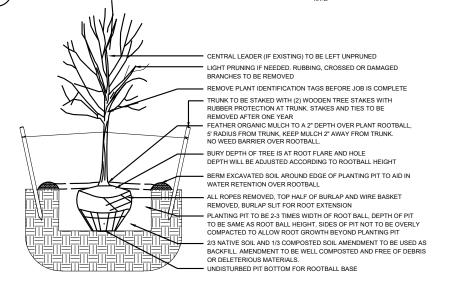
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IRRIGATION NOTES


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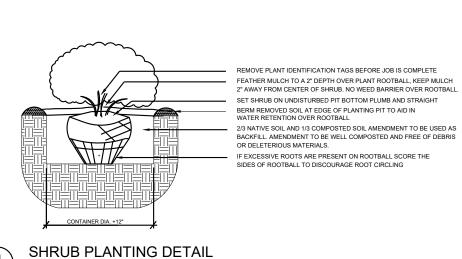
1013-SKL-1: POND SLOPES FLATTER THAN 3:1



(3) TREE PLANTING DETAIL



TREE DETAIL

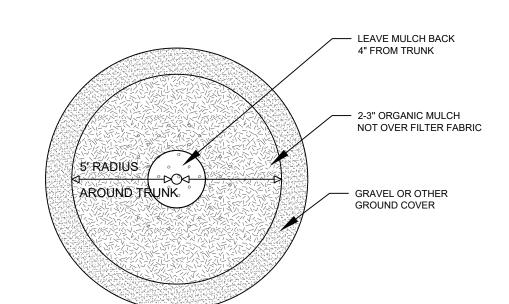

Officer Number

LP-02

Gallo Partnel 86th & Bridge

YELLOWSTONE

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08/09/2024

09/30/2024 02/11/2025 04/16//2025

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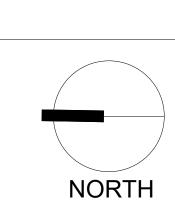
New Mexico

Albuquerque


Revisions:

Drawn by: CC

Reviewed by: CM




Scale: 1" = 30

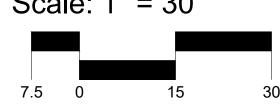

Sheet Title:
Interior
Planting Plan

Sheet Number:

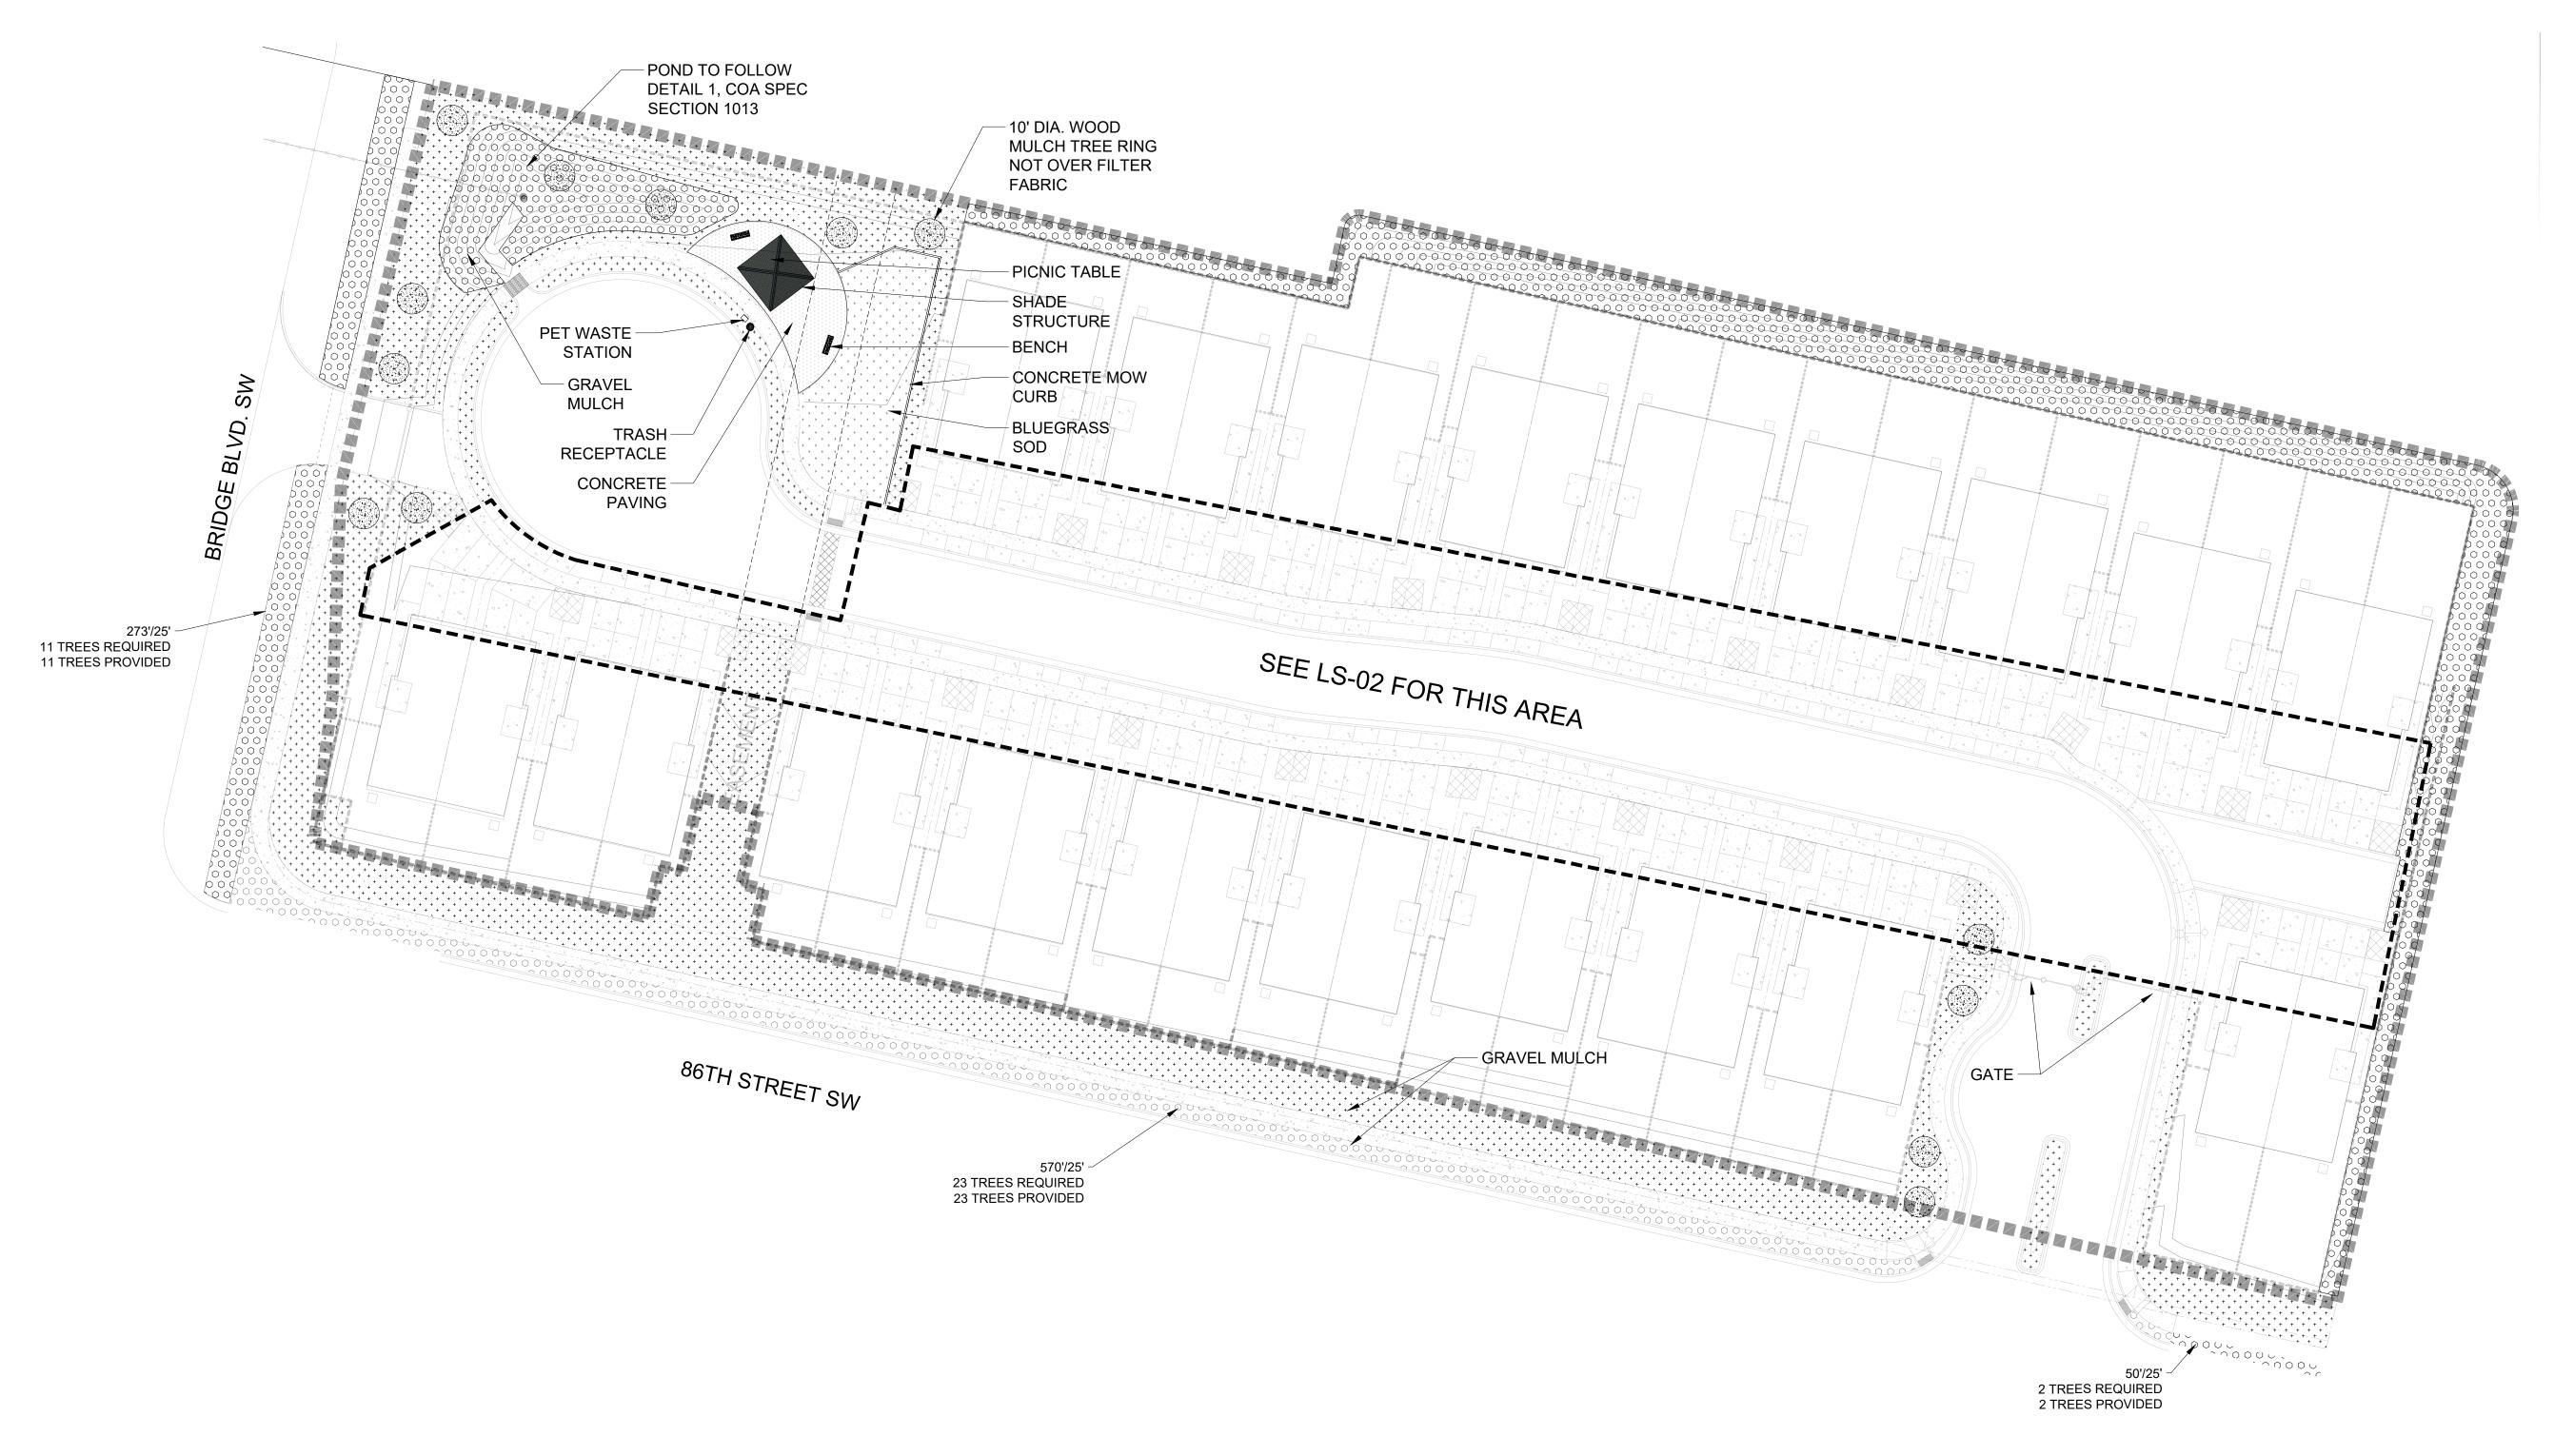

MATERIAL SCHEDULE

SYMBOL	DESCRIPTION	
* * * * * * * * * * * * * * * * * * *	1.5" AMARETTO GRAVEL MULCH 3" DEPTH OVER FILTER FABRIC	
	2"-4" MOUNTAINAIR BLUSH/NATIVE MULCH 4" DEPTH OVER FILTER FABRIC	
,	BLUEGRASS SOD 9 % OF LANDSCAPE AREA	
	WOOD MULCH WITH NO FILTER FABRIC	
	CONCRETE PAVING LIGHT BROOM FINISH	
	ANOVA LI441 - 6 FT CONTOUR BENCH WITH STEEL SLAT SEAT AND CAST IRON PORTABLE / SURFACE MOUNT LEGS FRAME: BRONZE TEXTURE COATED SEAT: SAGE GLOSS, TEXTURE COATED	
	ANOVA L1448 - 46IN DIAMETER STEEL TABLE WITH FOUR FLAT SEATS. PORTABLE / SURFACE MOUNT FRAME: SAGE GLOSS TABLE TOP: BRONZE TEXTURE COATED SEAT: BRONZE TEXTURE	2
	ANOVA L2040AT-40 GALLON STEEL SLAT RECEPTACLE WITH FRENCH DOORS. BONNET ASH TOP, PLASTIC LINER AND RUBBER FEET. RECEPTACLE: BRONZE TEXTURE COATED	1
	PET WASTE STATION	1

18'X18' SHADE STRUCTURE

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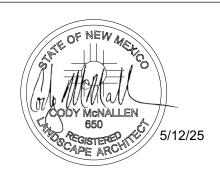
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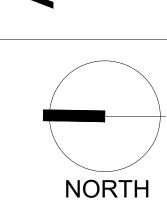


Date: 09/30/2024
Revisions: 04/18/2025

05/12/2025


Drawn by: <u>CC</u>
Reviewed by: <u>CM</u>

land Developmer 86th & Bridge



Albuquerque

2--1-- 4" - 2

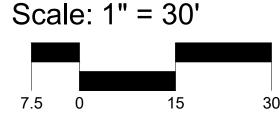


Sheet Title:

Materials

Plan

Sheet Number:

LS-01

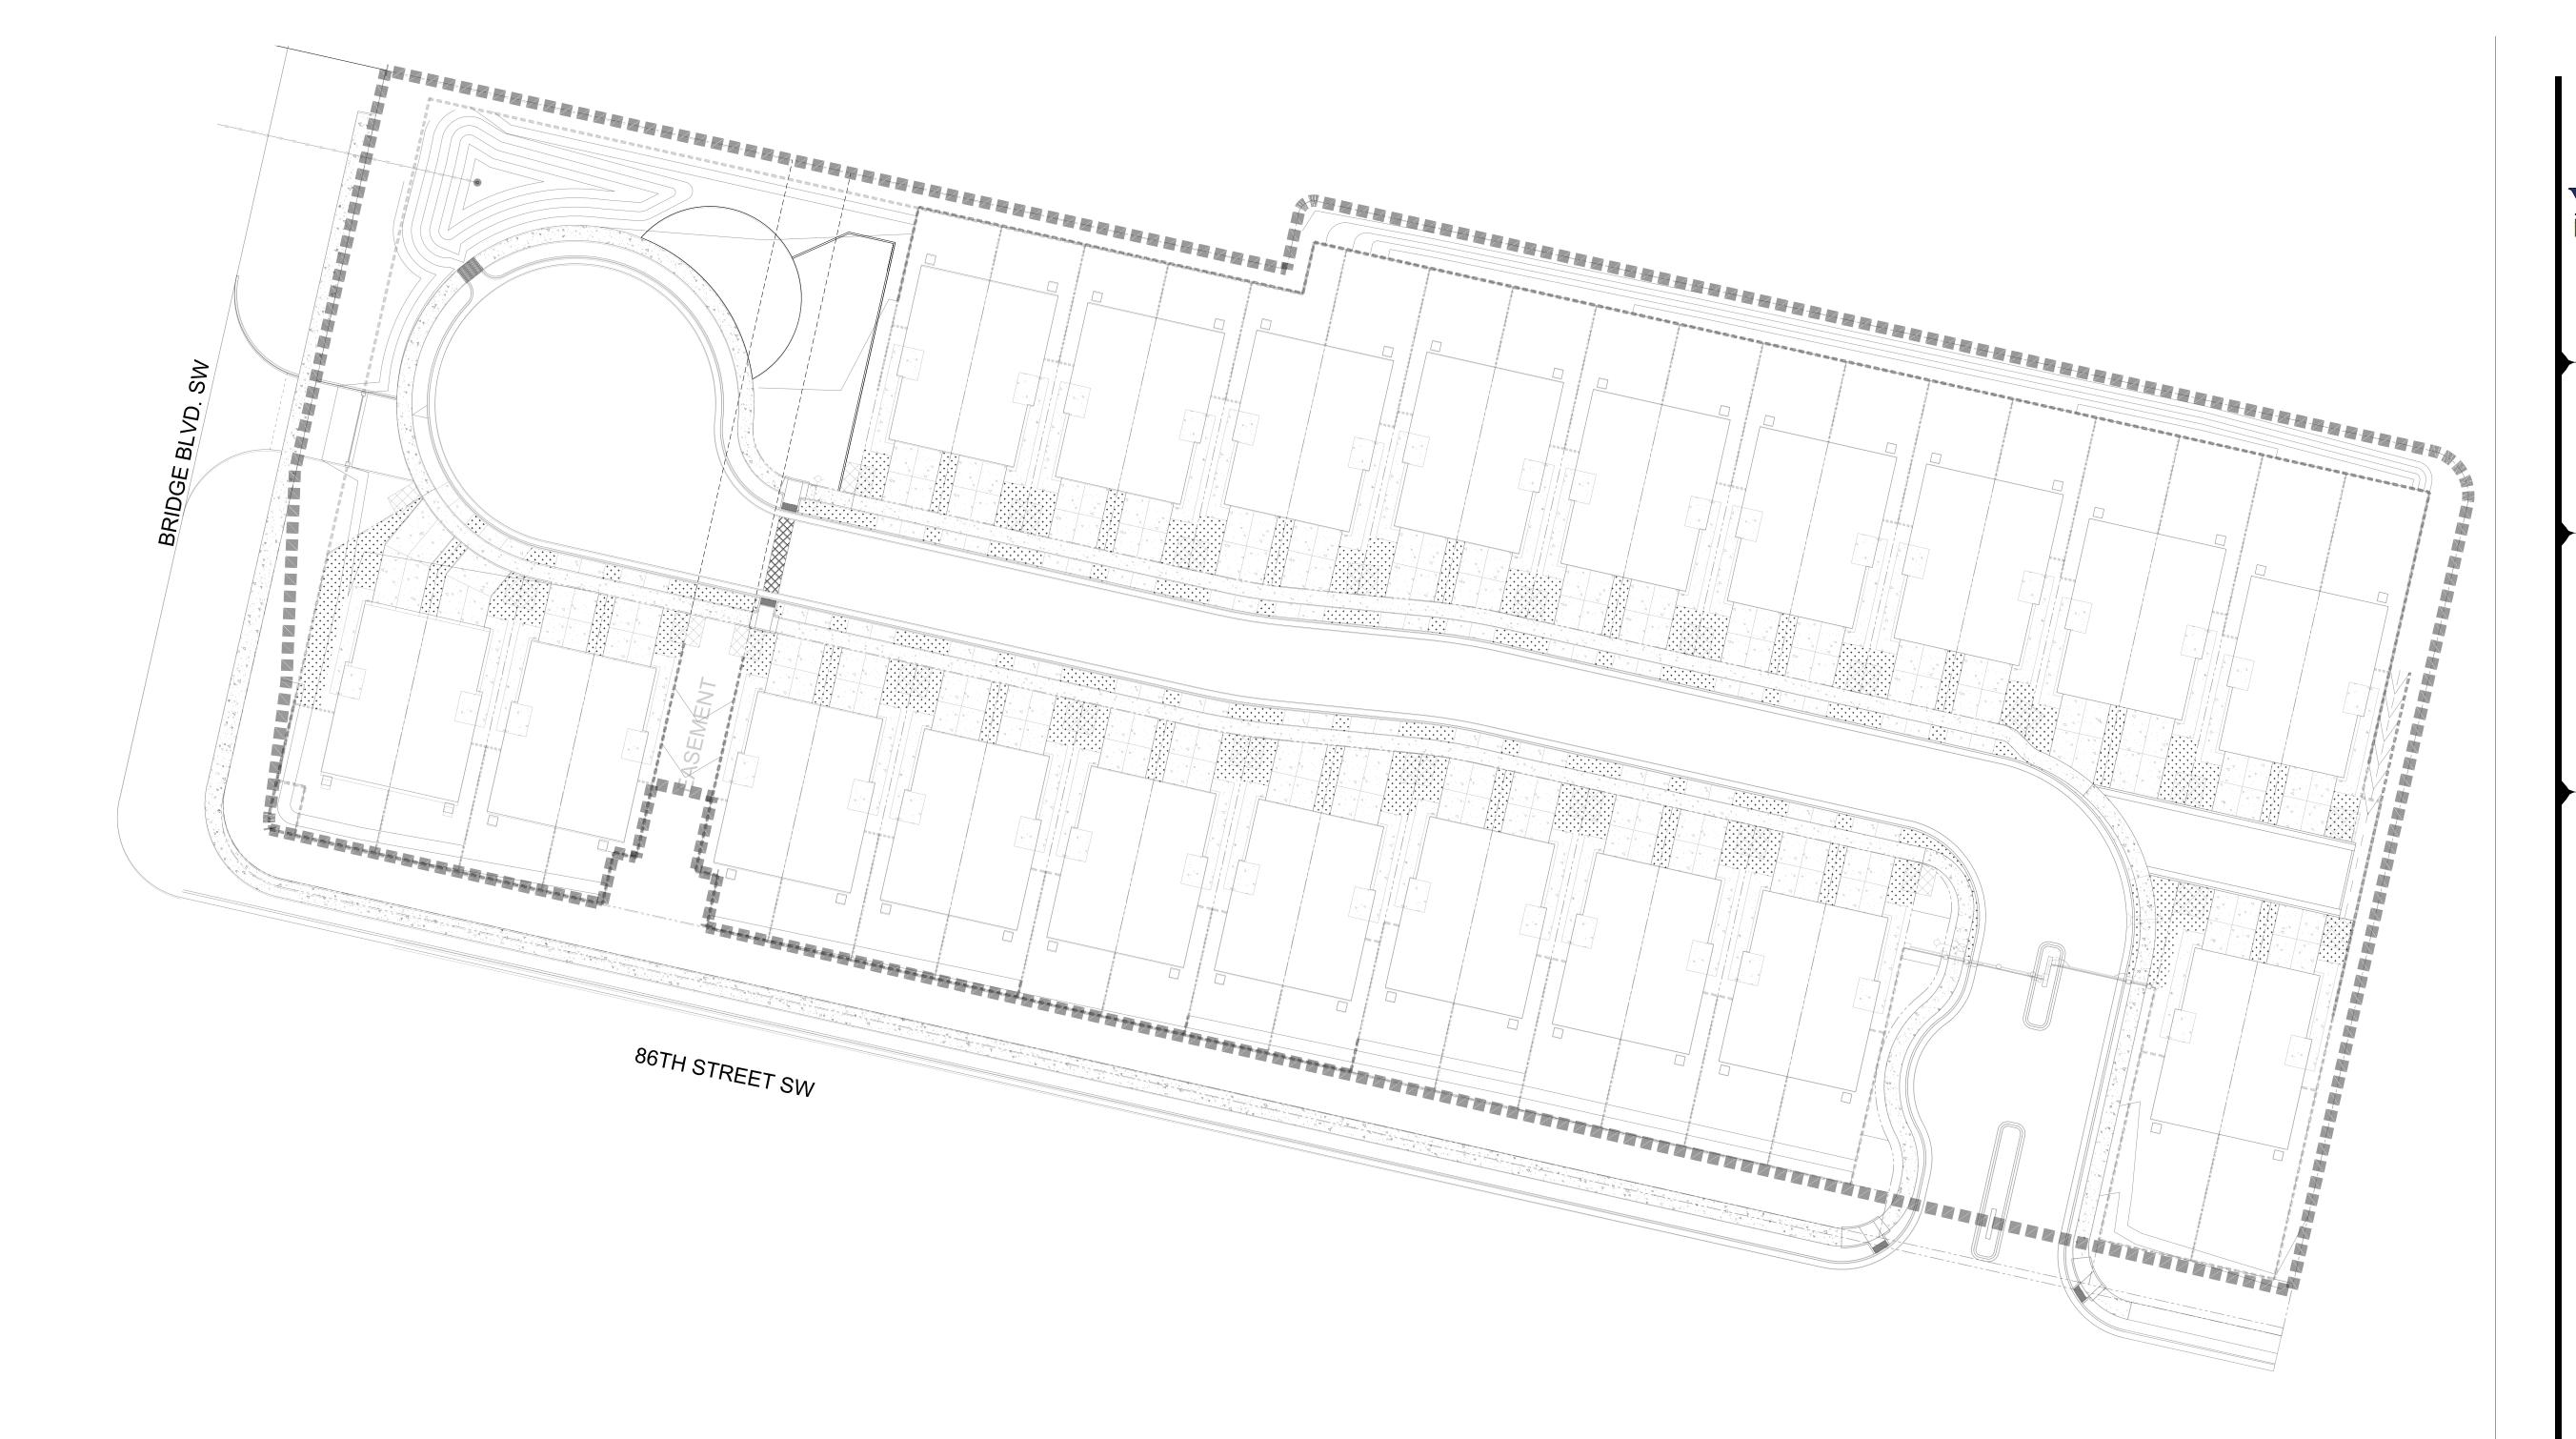

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- 8. PER 5-6(C)(14)(d), THE IRRIGATION SYSTEM SHALL NOT SPRAY OR IRRIGATE IMPERVIOUS SURFACES, INCLUDING SIDEWALKS, DRIVEWAYS, DRIVE AISLES, STREETS, AND PARKING AND LOADING AREAS.

GENERAL NOTES

- IN CASE OF DISCREPANCIES IN PLANT QUANTITIES SHOWN ON THE PLANT SCHEDULE AND THOSE SHOWN ON THE PLAN, THE QUANTITIES SHOWN ON THE PLAN SHALL PREVAIL. CONTRACTOR SHALL VERIFY ALL QUANTITIES PRIOR TO BID AND INSTALLATION.
- POSITIVE DRAINAGE AWAY FROM ALL STRUCTURES SHALL BE PROVIDED TO THE LANDSCAPE CONTRACTOR AND SHALL BE MAINTAINED BY THE LANDSCAPE CONTRACTOR THROUGHOUT THE DURATION OF THE PROJECT.
- 3. GRADING OF THE SITE PER THE GRADING PLAN IS NOT INCLUDED IN THE SCOPE OF WORK OF THE LANDSCAPE CONTRACTOR. GRADES PER THE GRADING PLAN SHALL BE PROVIDED TO THE LANDSCAPE CONTRACTOR +/-1/10TH OF A FOOT, BY OTHERS.
- 4. ALL MAINTENANCE OF THE LANDSCAPE AND IRRIGATION SYSTEMS SHALL BE PROVIDED BY OWNER. NO CONTRACTUAL MAINTENANCE SHALL BE
- INCLUDED UNLESS OTHERWISE SPECIFIED IN THE BIDDING DOCUMENTS.

 5. WATER MANAGEMENT IS THE SOLE RESPONSIBILITY OF THE PROPERTY OWNER. THE LANDSCAPE ARCHITECT IS NOT RESPONSIBLE FOR ANY RESTRICTIONS OF IRRIGATION WATER USE BY ANY GOVERNING BODY.
- 6. PER 5-6(C)(9)(a), ALL PLANTING OF VEGETATED MATERIAL OR INSTALLATION OF ANY LANDSCAPING, BUFFERING, OR SCREENING MATERIAL IN THE PUBLIC RIGHT-OF-WAY SHALL REQUIRE THE PRIOR APPROVAL OF THE CITY. THE PROPERTY OWNER SHALL BE RESPONSIBLE FOR THE MAINTENANCE, REPAIRS, OR LIABILITY FOR ALL THE LANDSCAPING PLACED IN OR OVER
- THE PUBLIC RIGHT-OF-WAY.

 7. PER 5-6(C)(9)(b), ANY TREES THAT OVERHANG A PUBLIC SIDEWALK OR MAJOR PUBLIC OPEN SPACE SHALL BE TRIMMED TO MAINTAIN AN 8 FOOT CLEARANCE OVER THE SIDEWALK. ANY TREES THAT OVERHANG A PUBLIC STREET SHALL BE TRIMMED TO MAINTAIN A 9' CLEARANCE OVER THE STREET SURFACE.
- 8. PURSUANT TO 5-6(C)(5)(e), BARK MULCH AREAS CLEARLY DELINEATED ON
- PLANS FOR LANDSCAPE AREAS AND 5' RADIUS RINGS AROUND TREES.

 9. PURSUANT TO 5-6(C)(7)(a), ALL VEGETATION HAS BEEN LOCATED A MINIMUM OF 3' IN ANY DIRECTION FROM FIRE HYDRANTS, VALVE VAULTS, HOSE BIBS,
- MANHOLES, HYDRANTS AND FIRE DEPARTMENT CONNECTIONS.

 10. PURSUANT TO 5-6(C)(10)(a), TREES AND SHRUBS SHALL NOT BE PLANTED IN UTILITY EASEMENTS UNLESS THERE IS NO OTHER PRACTICABLE LOCATION ON THE LOT WHERE THE LANDSCAPING WOULD ACHIEVE ITS INTENDED PURPOSE.
- 11. PURSUANT TO 5-6(C)(10)(b), TREES SHALL NOT BE PLANTED WITHIN 10' IN ANY DIRECTION OF THE CENTERLINE OF A SEWER OR WATER LINE.
- ANY DIRECTION OF THE CENTERLINE OF A SEWER OR WATER LINE.

 12. CLEAR SIGHT TRIANGLE NOTE: LANDSCAPING, SIGNAGE, WALLS, FENCES, TREES, AND SHRUBBERIES BETWEEN 3' AND 8' TALL (AS MEASURED FROM THE GUTTER PAN) ARE NOT ALLOWED WITHIN THE CLEAR SIGHT TRIANGLE.

GENERAL NOTES CONT


- 13. ALL PLANTS CHOSEN ARE PART OF THE ABQ PLANT PALLET LIST..
- 14. POLLEN CONTROL, WATER CONSERVATION AND STREET TREES:
 PURSUANT TO IDO 5-6 (C)(4)(G) ALL VEGITATION SHALL COMPLY WITH
 ARTICLE 9-12 AND PARTS 6-1-1 AND 6-6-2 OF ROA 1994 (POLLEN CONTROL,
 WATER CONSERVATION, LANDSCAPING AND WATER WASTE, AND STREET
 TREES) AND SECTION 4 OF THE ALBUQUERQUE BERNALILLO COUNTY
 WATER AUTHORITY (ABCWUA) LEGISLATION AND ORDINANCES (WATER
 WATER WASTE REDUCTION ORDINANCE) AS APPLICABLE*."

MATERIAL SCHEDULE

1.5" AMARETTO GRAVEL MULCH



5 0 5 . 8 9 8 . 9 6 1 5 design@yellowstonelandscape. com

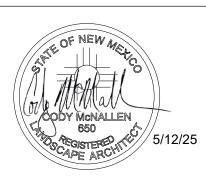


Date: 09/30/2024
Revisions: 05/12/2025


Drawn by: CC

Drawn by: <u>CC</u> Reviewed by: <u>CM</u>

Ashland Developmer 86th & Bridge

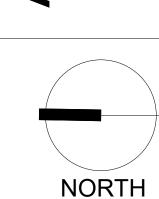

Albuquerq

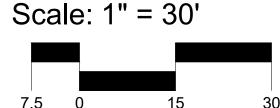

Sheet Title:

Interior Materials Plan

Sheet Number:

LS-02

-		
SYMBOL	MANUFACTURER/MODEL/DESCRIPTION	<u>QTY</u>
2000	HUNTER MP2000 - TURF ROTATOR PROS-04-PRS40-CV, 4IN. POP-UP WITH FACTORY INSTALLED CHECK VALVE, PRESSURE REGULATED TO 40 PSI, MP ROTATOR NOZZLE ON PRS40 BODY.	13
3000	HUNTER MP3000 - TURF ROTATOR PROS-04-PRS40-CV, 4IN. POP-UP WITH FACTORY INSTALLED CHECK VALVE, PRESSURE REGULATED TO 40 PSI, MP ROTATOR NOZZLE ON PRS40 BODY.	1
→ → → 40 402 404	RAIN BIRD 1800-1400 FLOOD FIXED FLOW RATE 0.25 GPM - 2.0 GPM, FULL CIRCLE BUBBLER, 1/2IN. FIPT.	108
SYMBOL	MANUFACTURER/MODEL/DESCRIPTION	QTY
×	DRIP CONTROL VALVE - SHRUB RAIN BIRD XCZ-100-PRF, MEDIUM FLOW DRIP CONTROL KIT, 1IN. DV VALVE, 1IN. PRESSURE REGULATING FILTER, 40PSI PRESSURE REGULATOR. 5 GPM-20 GPM.	2
	DRIP CONTROL VALVE - TREE RAIN BIRD XCZ-100-PRF. MEDIUM FLOW DRIP CONTROL KIT, 1IN. DV VALVE, 1IN. PRESSURE REGULATING FILTER, 40PSI PRESSURE REGULATOR. 3 GPM-15 GPM.	1
⟨ F ⟩	FLUSH CAP NDS CEP900	12
	DRIP EMITTER - SHRUB (2) NDS TAE 20 DRIP EMITTERS	146
٥	DRIP EMITTER - TREE (6) NDS TAE 20 DRIP EMITTERS	17
SYMBOL	MANUFACTURER/MODEL/DESCRIPTION	QTY
•	CONTROL VALVE RAIN BIRD PEB. 1IN., 1-1/2IN., 2IN. PLASTIC INDUSTRIAL VALVES. LOW FLOW OPERATING CAPABILITY, GLOBE CONFIGURATION.	3
×	ISOLATION VALVE SPEARS STANDARD BALL VALVE	1
	MASTER VALVE 1" RAIN BIRD PEB. 1IN., 1-1/2IN., 2IN. PLASTIC INDUSTRIAL MASTER VALVES. LOW FLOW OPERATING CAPABILITY, GLOBE CONFIGURATION.	1
BF	REDUCED PRESSURE BACKFLOW PREVENTER 1" FEBCO 825Y	1
C	CONTROLLER - RAIN BIRD ESPLXME2-LXMMPED 12-48 STATION TRADITIONALLY-WIRED, COMMERCIAL CONTROLLER. INCLUDES METAL CABINET AND PEDESTAL FOR CONTROLLER.	1
M	WATER METER 1"	1
	IRRIGATION LATERAL LINE: PVC SCHEDULE 40	
	IRRIGATION LATERAL LINE: A940 DRIP POLYLINE	
	IRRIGATION LATERAL LINE: A940RDS DRIP POLYLINE	
	IRRIGATION MAINLINE: PVC SCHEDULE 40	
	PIPE SLEEVE: PVC CLASS 200 SDR 21	
	/alve Callout	
# # # •	——Valve Number ——Valve Flow	

IRRIGATION NOTES

- 1. ALL PLANTS WITHIN PUBLIC RIGHT-OF-WAY SHALL BE IRRIGATED BY BUBBLER IRRIGATION SYSTEM PER COA SPEC. ALL PLANTS WITHIN THE PUBLIC RIGHT-OF-WAY SHALL BE ZONED SEPARATELY FROM THE PLANTS WITHIN THE PROPERTY LINE.
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- 4. ALL IRRIGATION SHALL BE PERMANENT AND SHALL BE CONTROLLED BY AN AUTOMATIC IRRIGATION CONTROLLER.
- 5. PER 5-6(C)(14)(a), IRRIGATION SYSTEMS SHALL COMPLY WITH SECTION 8 OF THE ABCWUA LEGISLATION AND ORDINANCES (CROSS CONNECTION
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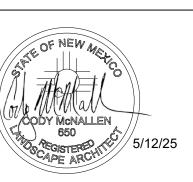
 7. PER 5-6(C)(14)(c), ALL NON-RESIDENTIAL LANDSCAPE IRRIGATION SHALL HAVE AUTOMATIC TIMERS AND/OR PROGRAMMABLE SETTINGS TO AVOID
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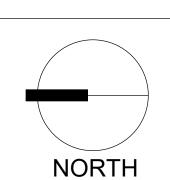


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Drawn by: <u>CC</u> Reviewed by: <u>CM</u>

> Gallo Partners 86th & Bridge



Scale: 1" = 20'



Sheet Title:

Irrigation
Plan


Sheet Number:

IKKIGATION	SCHEDULE	
SYMBOL	MANUFACTURER/MODEL/DESCRIPTION	QT\
2000	HUNTER MP2000 - TURF ROTATOR PROS-04-PRS40-CV, 4IN. POP-UP WITH FACTORY INSTALLED CHECK VALVE, PRESSURE REGULATED TO 40 PSI, MP ROTATOR NOZZLE ON PRS40 BODY.	13
3000	HUNTER MP3000 - TURF ROTATOR PROS-04-PRS40-CV, 4IN. POP-UP WITH FACTORY INSTALLED CHECK VALVE, PRESSURE REGULATED TO 40 PSI, MP ROTATOR NOZZLE ON PRS40 BODY.	1
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SYMBOL	MANUFACTURER/MODEL/DESCRIPTION	QT\
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	DRIP CONTROL VALVE - TREE RAIN BIRD XCZ-100-PRF. MEDIUM FLOW DRIP CONTROL KIT, 1IN. DV VALVE, 1IN. PRESSURE REGULATING FILTER, 40PSI PRESSURE REGULATOR. 3 GPM-15 GPM.	1
⟨F ⟩	FLUSH CAP NDS CEP900	12
②	DRIP EMITTER - SHRUB (2) NDS TAE 20 DRIP EMITTERS	146
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SYMBOL	MANUFACTURER/MODEL/DESCRIPTION	QT'
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BF	REDUCED PRESSURE BACKFLOW PREVENTER 1" FEBCO 825Y	1
C	CONTROLLER - RAIN BIRD ESPLXME2-LXMMPED 12-48 STATION TRADITIONALLY-WIRED, COMMERCIAL CONTROLLER. INCLUDES METAL CABINET AND PEDESTAL FOR CONTROLLER.	1
M	WATER METER 1"	1
	IRRIGATION LATERAL LINE: PVC SCHEDULE 40	
	IRRIGATION LATERAL LINE: A940 DRIP POLYLINE	
	IRRIGATION LATERAL LINE: A940RDS DRIP POLYLINE	
	IRRIGATION MAINLINE: PVC SCHEDULE 40	
	PIPE SLEEVE: PVC CLASS 200 SDR 21	
	Valve Callout ——— Valve Number	
# # # •	Valve Flom	
#"•	──── Valve Size	

IRRIGATION NOTES


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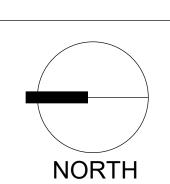


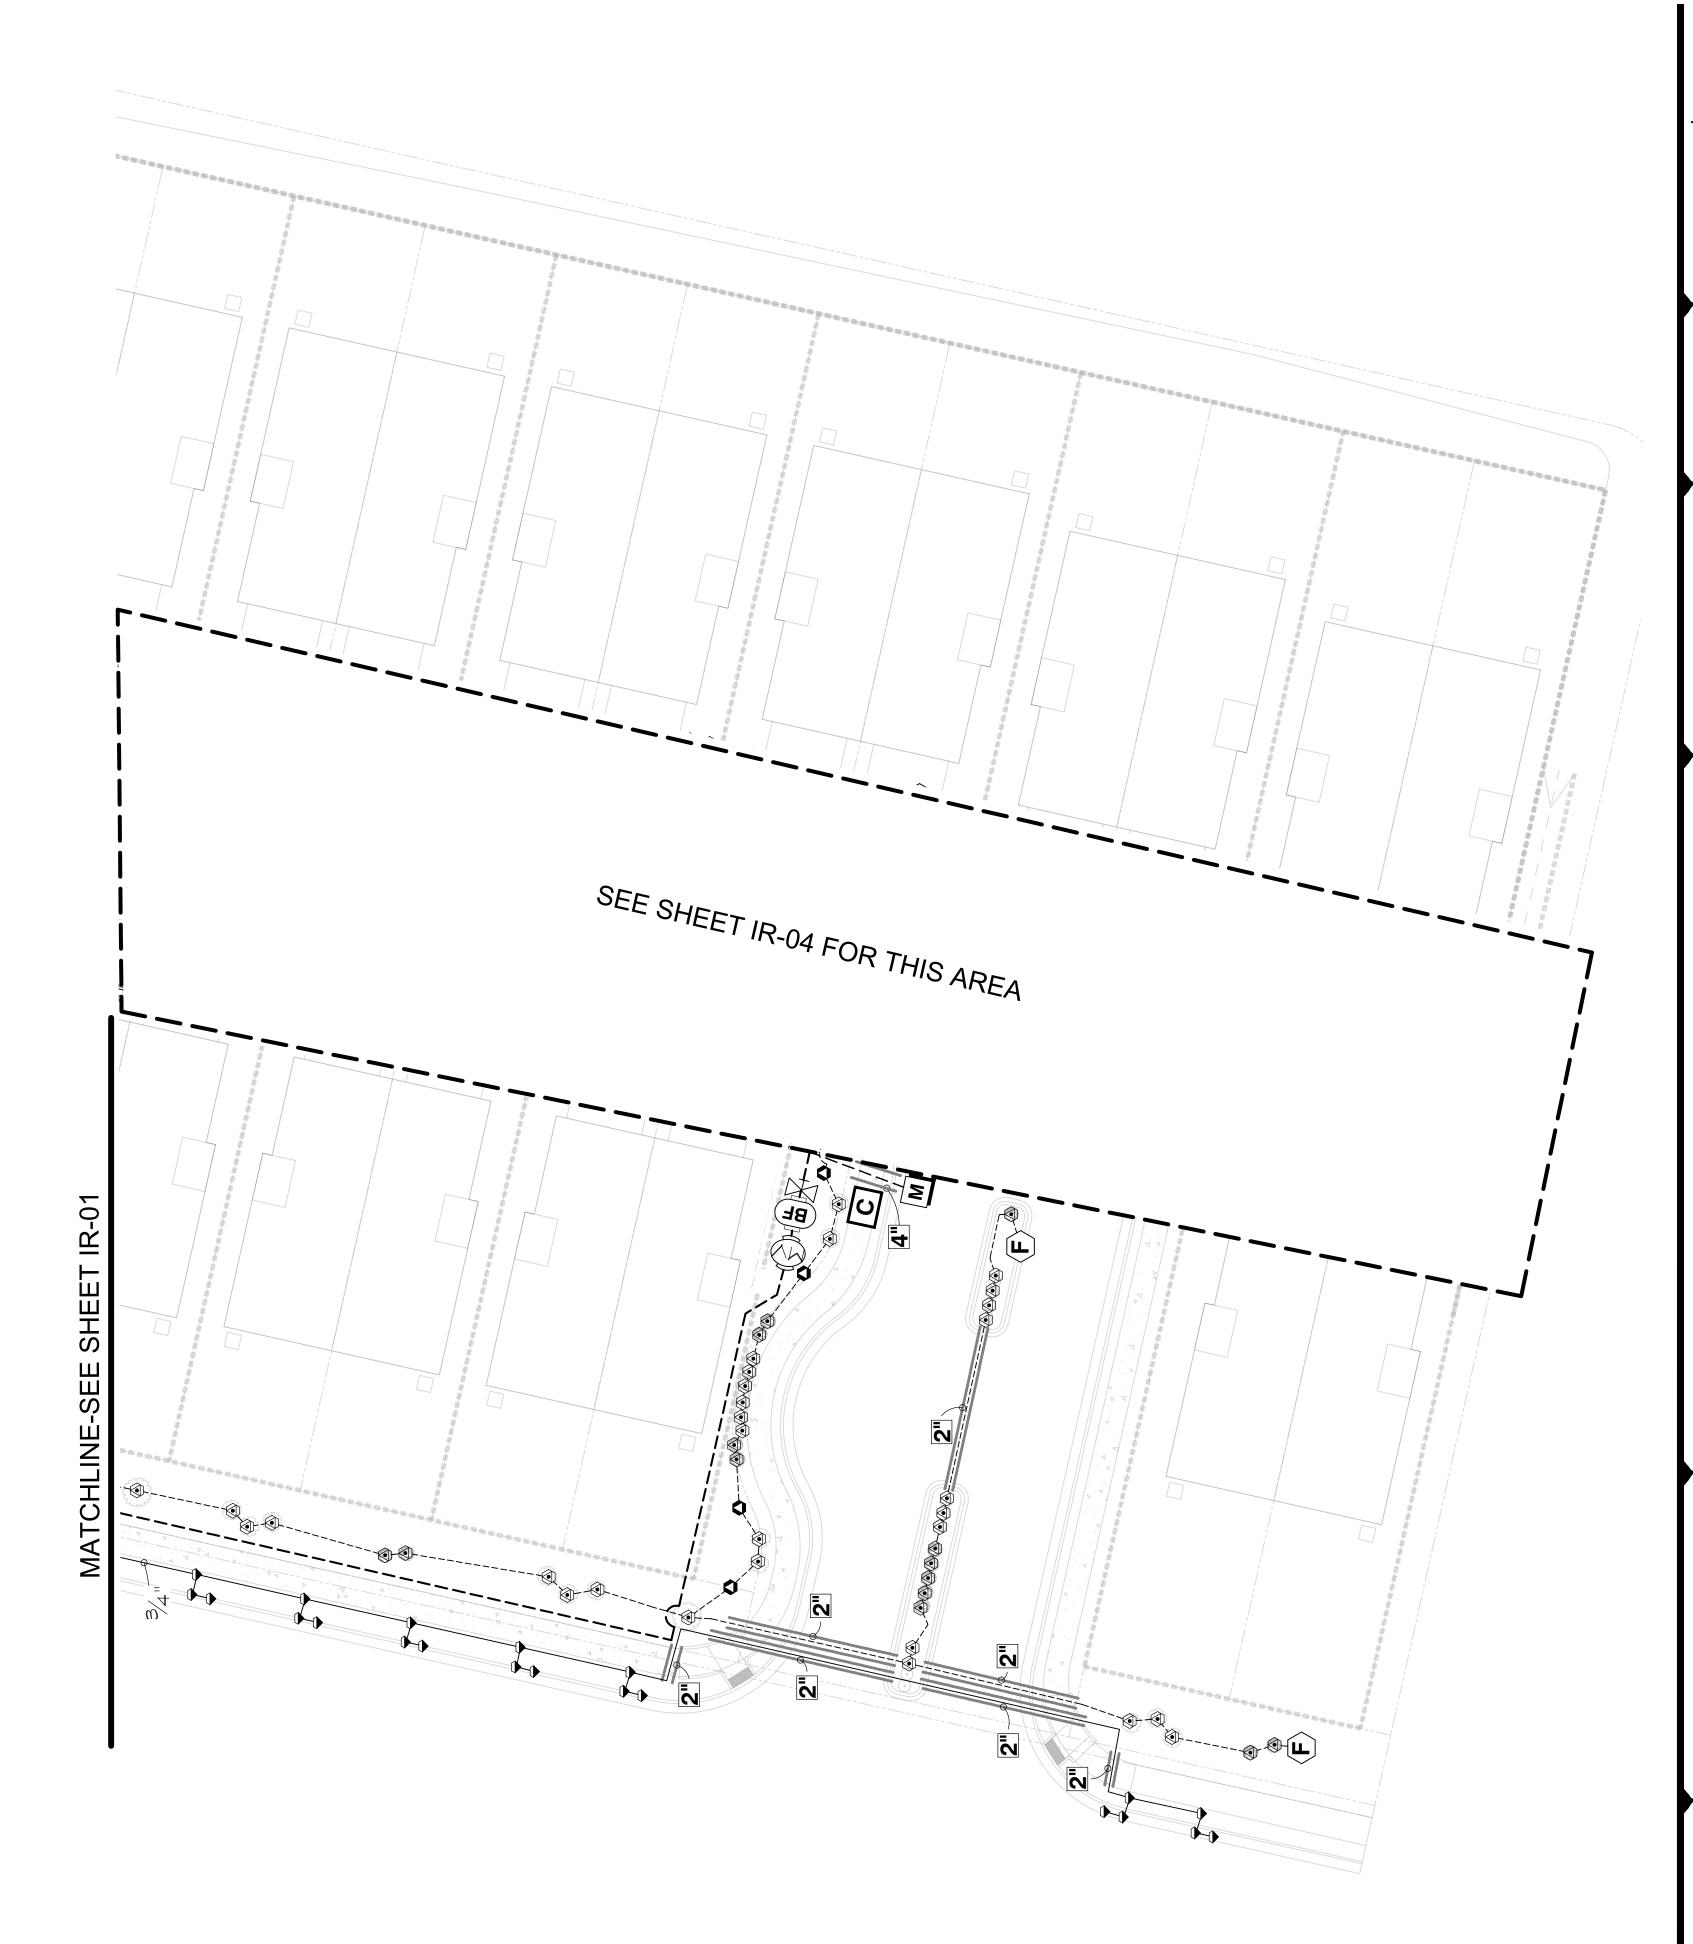


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Gallo Partners 86th & Bridge



Scale: 1" = 20'

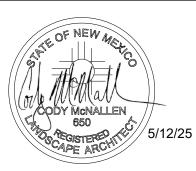

Sheet Title:

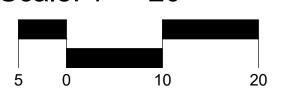Irrigation
Plan

Sheet Number:

SYMBOL	MANUFACTURER/MODEL/DESCRIPTION	QTY
M	DRIP CONTROL VALVE - SHRUB RAIN BIRD XCZ-100-PRF, MEDIUM FLOW DRIP CONTROL KIT, 1IN. DV VALVE, 1IN. PRESSURE REGULATING FILTER, 40PSI PRESSURE REGULATOR. 5 GPM-20 GPM.	1
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②	TRANSITION FITTING PIPE TRANSITION POINT FROM PVC LATERAL TO DRIP TUBING WITH RISER IN 6IN. DRIP BOX.	46
F	FLUSH CAP NDS CEP900	47
®	DRIP EMITTER - SHRUB (2) NDS TAE 20 DRIP EMITTERS	111
٥	DRIP EMITTER - TREE (6) NDS TAE 20 DRIP EMITTERS	38
SYMBOL	MANUFACTURER/MODEL/DESCRIPTION	
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	IRRIGATION LATERAL LINE: A940 DRIP POLYLINE	
	IRRIGATION LATERAL LINE: A940RDS DRIP POLYLINE	
	IRRIGATION MAINLINE: PVC SCHEDULE 40	
	PIPE SLEEVE: PVC CLASS 200 SDR 21	
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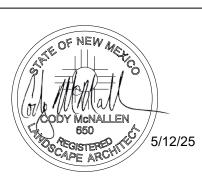
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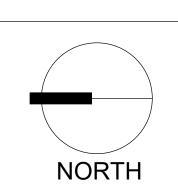
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Date: 05/12/2025 Revisions: Drawn by: CC

Reviewed by: CM

 $\Box \infty$ Gallo 86th



Scale: 1" = 20'




Sheet Title: Interior Irrigation Plan

Sheet Number:

SYMBOL	MANUFACTURER/MODEL/DESCRIPTION	QTY
×	DRIP CONTROL VALVE - SHRUB RAIN BIRD XCZ-100-PRF, MEDIUM FLOW DRIP CONTROL KIT, 1IN. DV VALVE, 1IN. PRESSURE REGULATING FILTER, 40PSI PRESSURE REGULATOR. 5 GPM-20 GPM.	1
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	IRRIGATION MAINLINE: PVC SCHEDULE 40	
	PIPE SLEEVE: PVC CLASS 200 SDR 21	
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#"•	Valve Size	


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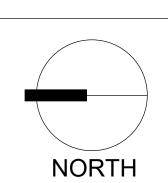
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Date: 05/12/2025
Revisions:

Reviewed by: CM
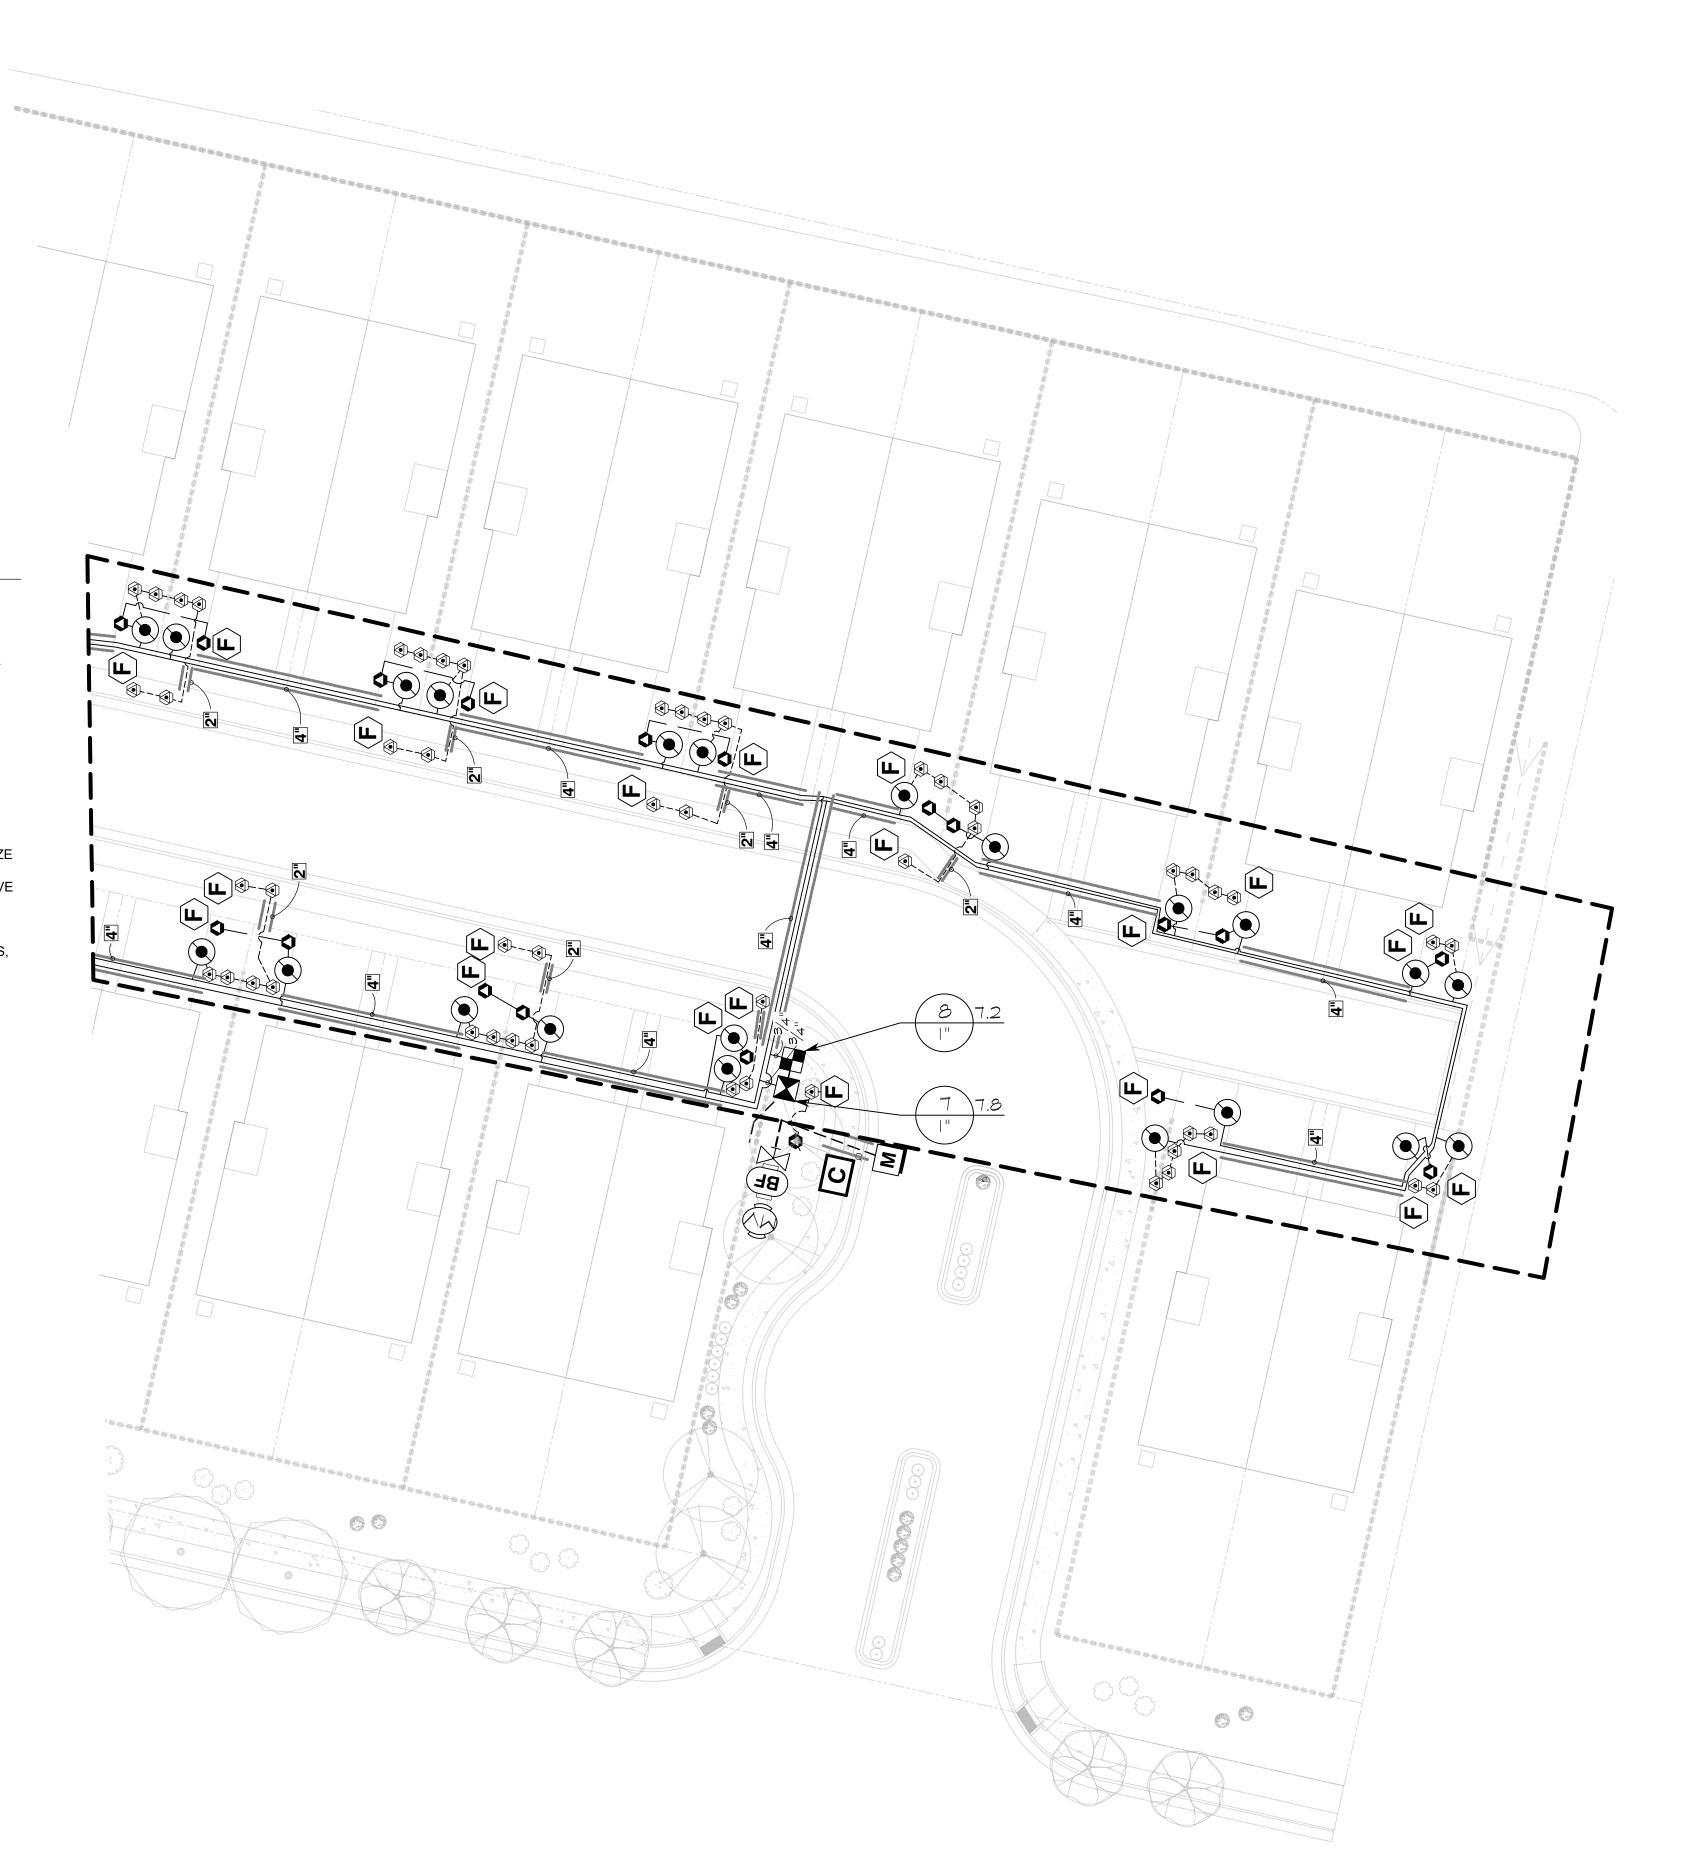
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Sheet Title:
Interior
Irrigation Plan


Sheet Number:

- IRRIGATION SUPPLY LINE
- SCH. 80 UTILITY BALL VALVE APPLIED ENGINEERING PRODUCTS 910 ROUND VALVE BOX WITH EXTENSIONS AS NEEDED
- FINISH GRADE SCH. 80 NIPPLE
- GAL. 90°
- GAL. 30" NIPPLE 4" THICK CONCRETE PAD (6" WIDER THAN ASSEMBLY ON ALL SIDES)
- OUTLET FOR HEAT TAPE PROVIDED BY OTHERS HOT BOX (HEATED ENCLOSURE)
- REDUCED PRESSURE BACKFLOW PREVENTER GAL. STREET 90°
- M. GAL. NIPPLE (TYP.)
- GAL. UNION (TYP.) PVC SLEEVE THROUGH CONCRETE (TYP.)
- SCH. 80 UTILITY BALL VALVE MASTER VALVE

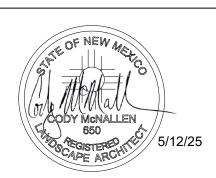SCH. 80 NIPPLE


- SLIP X THREAD MALE ADAPTER SCH. 40 PVC MASTERLINE APPLIED ENGINEERING PRODUCTS 1015
- NOTE: INSTALL BACKFLOW PREVENTER AS REQUIRED BY LOCAL CODES AND HEALTH DEPARTMENT. VERIFY LOCAL REQUIREMENTS PRIOR TO INSTALLATION.

VALVE BOX WITH EXTENSIONS AS NEEDED

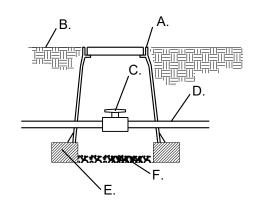

MAINLINE ISOLATION VALVE DETAIL

- APPLIED ENGINEERING PRODUCTS 910 ROUND VALVE BOX WITH EXTENSIONS AS NEEDED
- FINISH GRADE SCH. 80 UTILITY BALL VALVE MAINLINE/24" BURY
- 8" X 8" X 16" CMU CONCRETE BLOCK F. 4" LAYER OF 3/4" GRAVEL

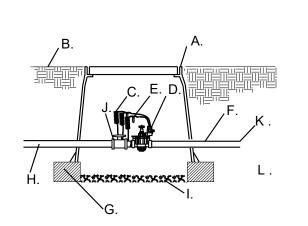


CONTROL VALVE

- A. APPLIED ENGINEERING PRODUCTS 1320 VALVE BOX WITH EXTENSIONS AS NEEDED
- B. FINISH GRADE
- 24" WIRE LOOP AUTOMATIC VALVE, SEE IRRIGATION LEGEND
- DRY SPLICE CONNECTOR OR EQUAL
- LATERAL LINE/24" BURY 8" X 8" X 16" CMU CONCRETE BLOCK
- MASTERLINE/24" BURY
- 4" LAYER OF 3/4" GRAVEL

N.T.S.

- SCH. 80 UTILITY BALL VALVE
- SCH. 40 PVC LATERAL LINE SCH. 80 UNION

RP BACKFLOW/MASTER VALVE DETAIL

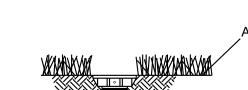

A. APPLIED ENGINEERING PRODUCTS 1320 VALVE BOX WITH EXTENSIONS AS NEEDED FINISH GRADE C. 24" WIRE LOOP D. RAIN BIRD XCZ CONTROL ZONE KIT WITH BASKET FILTER, SEE LEGEND DRY SPLICE CONNECTOR OR EQUAL

N.T.S.

- F. 8" X 8" X 16" CMU CONCRETE BLOCK G. MASTERLINE/24" BURY H. 4" LAYER OF 3/4" GRAVEL SCH. 80 TRUE UNION BALL VALVE
- J. LATERAL LINE. SEE PLAN. K. SCH. 80 UNION
- DRIP VALVE WITH FILTER & PRESSURE REGULATOR FOR TRADITIONAL WIRE IRRIGATION



HUNTER SJ-512 SWING JOINT PVC SCH.40 TEE/ELL E. PVC LATERAL LINE

FINISH GRADE


POP-UP SPRAY SPRINKLER:

NOZZLE PER SCHEDULE

HUNTER PROS-04-PRS40-CV

N.T.S.

N.T.S.

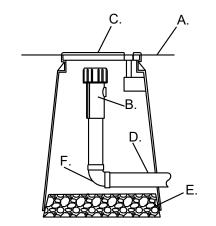

END FLUSH CAP

- FINISH GRADE END FLUSH CAP
- 6" ROUND BOX WITH LID 3/4" POLY DRIP PIPE 2" DEPTH OF GRAVEL



90° FITTING

EMITTER PLACEMENT DETAIL

24" CIRCLE FROM TRUNK **EMITTERS** 1/4" DISTRIBUTION LINE

TREE TRUNK/ ROOT CROWN

3/4" POLYETHYLENE DRIPLINE

EMITTER PLACED AT THE EDGE OF THE ROOT BALL

NOTE: INSTALL EMITTERS ABOVE THE ROOT BALL IF PLANT IS INSTALLED ON A SLOPE.

N.T.S.

BUBBLER PLACEMENT DETAIL

TREE TRUNK/ ROOT CROWN 36" DIA AROUND TREE 12-18" DIA AROUND SHRUB PVC LATERAL PIPE (SIZE VARIES) BUBBLERS


-TREE: (3)1.0 GPM -VERTICAL SHRUB: (2) 0.5 GPM -SHRUB: (1) 0.5 GPM -YUCCA AND OTHER VERY LOW WATER-USE SHRUBS: (1) 0.25 GPM

NOTE: INSTALL BUBBLER(S) ABOVE THE ROOT BALL IF PLANT IS INSTALLED ON A SLOPE.



PEDESTAL MOUNTED AUTOMATIC CONTROLLER

N.T.S.

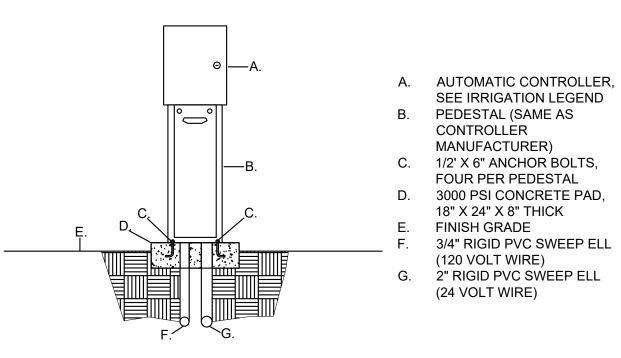

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Albuquerque

Sheet Title: Irrigation Details

Sheet Number: