

GENERAL NOTES

- A. ALL WORK IN PUBLIC RIGHT-OF-WAY WORK SHALL COMPLY WITH CITY OF ALBUQUERQUE (COA) STANDARDS. B. ALL DIMENSIONS ON THIS SITE PLAN ARE TO FACE OF CURB, CENTER
- LINE OF TRAFFIC STRIPE, OR EDGE OF CONCRETE, UNO. C. SEE ALSO CIVIL FOR ADDITIONAL INFORMATION.
- D. SEE ALSO MECHANICAL AND ELECTRICAL FOR ADDITIONAL INFORMATION.
- E. SEE LANDSCAPING AND IRRIGATION SHEETS FOR ADDITIONAL INFORMATION AND FOR LANDSCAPING CALUCULATIONS. F. SEE PROJECT MANUAL FOR GEOTECHNICAL REPORT BY VINYARD 4 ASSOCIATES, INC. PROJECT Ø1-Ø1-341, DATED SEPTEMBER 24, 2001.

KEYED NOTES

NOTE: THE FOLLOWING KIEYED NOTES APPLY TO SHEETS C3.1 AND C3.2.

SOME NOTES MAY NOT BE USED ON EVERY SHEET. NEW CMU/STUCCO SITE WALL. SEE SITE ELEVATIONS & DETAILS.

EXISTING 6' HIGH CMU SITE WALL TO REMAIN. EXISTING ADOBE/CMU SITE WALL. HEIGHT YARIES, SEE SITE ELEVATIONS DETAILS ON SHEET C42.

4. PAINT DASHED PORTION OF CURB FACE AND TOP COLOR RED WITH WHITE STENCILED 4" HIGH LETTERS "NO PARKING" AND "FIRE LANE" ALTERNATING 5. EXISTING DOUBLE-HEAD LIGHT POLE WITH CONCRETE BASE ON ADJACENT PROPERTY. (NORTH HEAD THROWS LIGHT ONTO PROPERTY IN THIS WORK).

6. NEW LIGHT POLE WITH CONCRETE BASE COMPLYING WITH LIGHTING REGULATIONS ON THIS SHT. SEE ELECTRICAL. 1. 5'-0" WIDE CROSSWALK OF 12" WIDE STRIPES AT 30" O.C. PAINTED WITH

WHITE REFLECTIVE TRAFFIC PAINT. 3. 4" WIDE WHITE TRAFFIC PAINT PAYEMENT MARKINGS, TYP. AT NON-HANDICAP AND MOTORCYCLE PARKING SPACES. 4" WIDE BLUE TRAFFIC PAINT AT PERIMETER AND 45 DEG STRIPES AT

3'-0" O.C. AT HANDICAP ACCESSIBLE AISLES. PAINT 4" W BLUE STRIPE BETWEEN HANDICAP ACCESSIBLE SPACES NOT SEPARATED BY AISLES.
10. PAINTED WHEELCHAIR SYMBOL ON PAVEMENT. SEE SITE DETAILS. PAINT WHITE STENCILED 12" HIGH LETTERS "YAN" WHERE SHOWN. PAINT WHITE STENCILED 12" HIGH LETTERS "COMPACT" WHERE SHOWN, O "STAFF" WHERE SHOWN.

2. 4" WIDE WHITE TRAFFIC PAINT AT PERIMETER AND 45 DEG STRIPES AT 3'-0" O.C. AT BICYCLE PARKING AREA. 13. 18" W X 10'-0" L (MIN.) WHITE REFLECTIVE TRAFFIC STRIPE AND TEXT "STOP" IN 18" H LETTERS WHERE SHOWN.

SEE SITE DETAILS. 15. DOUBLE 'TRAFFIC YELLOW' TRAFFIC PAINT STRIPING DIVIDER LINE - TWO 4" WIDE STRIPES SEPARATED BY 4" CLEAR. 6. SINGLE 4" WIDE STRIPE WHITE TRAFFIC PAINT. SOLID FIRST 60', BROKEN LINE BALANCE OF LENGTH. NEW CONC. CURB AND GUTTER COA STD. 2415, MEDIAN C4G. SEE CIVIL.

2'-0" WIDE BREAK IN CURB. SEE CIYIL. 2'-0" WIDE CONC. CHANNEL. SEE CIVIL. 1'-0" WIDE SIDEWALK CULVERT, SEE CIVIL. PROVIDE COVER WHERE SHOWN. 21. 2'-0" WIDE SIDEWALK CULVERT, SEE CIVIL. PROVIDE COVER WHERE SHOWN.

NEW STORM INLET. SEE CIVIL. 23. NEW UNDERGROUND STORM DRAIN PIPE. SEE CIVIL. 24. EXIST. STORM INLET AND UNDERGROUND PIPING. PROTECT. SEE CIVIL. 25. 6'-0" WIDE EROSION PROTECTION. SEE CIVIL. 26. FORMED ASPHALTIC CONCRETE CURB ON TOP OF ASPHALTIC CONC. PAYING PER COA STD. DWG. 2415. 27. CONCRETE PAYING TURNDOWN EDGE DETAIL AT ASPHALT.

SEE SITE DETAILS. 28. TURN-DOWN EDGE OF ASPHALTIC CONC. PAYING. (8" DEEP x 12" WIDE) 29. NEW CONCRETE STAND-UP CURB. SEE SITE DETAILS. 30. NEW HANDRAIL. SEE DETAIL 20/C4.1. 1. FLUSH ASPHALT/CONC. PAYING. SEE SITE DETAILS. SEE CIVIL.

32. EDGE OF PAYEMENT. 33. NEW AND EXISTING PAYEMENT TO MEET FLUSH AND HAVE POSITIVE DRAINAGE. SEE CIVIL.

34. EXIST. STAIRS OR RAMP STRUCTURE TO REMAIN.
35. PRE-CAST CONC. BUMPER. CENTER ON WIDTH OF PARKING SPACE AND MOUNT 2'-0" FROM FACE OF CAR SIDE OF BUMPER TO F.O.CURB, SEE DETAIL. 36. 2'-0" WIDE RAISED CONC. MEDIAN. SEE SITE DETAILS. 37. EXISTING CONC. CURB, GUTTER AND SIDEWALK TO REMAIN. PROTECT. 38. EXISTING PAVEMENT TO REMAIN. PROTECT.

39. DASHED LINE INDICATES ROOF LINE ABOVE. 40. LANDSCAPE AREA. SEE LANDSCAPE DRAWINGS 41. NEW LOCATION OF SALVAGED DEDICATION STONE AND CROSS.
42. DASHED LINES INDICATE FUTURE CONSTRUCTION, NOT IN THIS WORK. 43. EXISTING 6' TALL PERIMETER CHAIN LINK FENCE TO REMAIN. 44. NEW PUBLIC FIRE HYDRANT PER COA STANDARDS. SEE UTILITIES, SEE

CIVIL. LOCATE HYDRANT IN CENTER OF 3'-0" X 3'-0" CONC. PAD. POUR PAD TO WEST AND CLEAR OF 6'-0" WIDE PUBLIC SIDEWALK.

45. 25' CLEAR SIGHT TRIANGLE PER COA.
46. 35' CLEAR SIGHT TRIANGLE PER COA.
47. STRAIGHT CURB RAMP. SEE SITE DETAILS.
48. FLARED CURB RAMP. SEE SITE DETAILS. 49. CURB-BREAK RAMP. SEE SITE DETAILS. 50. 2-SIDED CURB RAMP. SEE SITE DETAILS.

'HANDICAPPED PARKING' SIGN. SEE SITE DETAILS. MOTORCYCLE PARKING' SIGN. SEE SITE DETAILS. PROVIDE 4 SPACES. 53. 'BICYCLE PARKING' SIGN. SEE SITE DETAILS.
54. BIKE RACK. SEE SITE DETAILS. PROVIDE S SPACES TOTAL.

55. 'STOP' SIGN. SEE SITE DETAILS. 56. KEEP RIGHT' SIGN. SEE SITE DETAILS. 57. REPAIR END OF EXIST. ADOBE WALL WHERE PORTION OF EXIST. REMOVED. SEE SITE DEMO PLAN. SEE ALSO SHT. C42.

58. NEW REFUSE ENCLOSURE AND APRON. SEE SITE DETAILS. 59. NEW STAIRS. SEE SITE DETAILS. (SEE LEGEND BELOW FOR DESCRIPTIONS OF PAVEMENT)
60. NEW STANDARD-DUTY PORTLAND CEMENT CONCRETE PAVING.
61. NEW HEAVY-DUTY PORTLAND CEMENT CONCRETE PAVING.

62. NEW STANDARD-DUTY ASPHALTIC CONCRETE PAYING. 63. NEW HEAVY-DUTY ASPHALTIC CONCRETE PAYING. 64. EXISTING MONUMENT SIGN TO REMAIN. 65. NEW DRIVEPAD/DROPPED SIDEWALK CURBS. CONSTRUCT PER COA.

STD. DWG. 2426. SEE CIVIL. 66. NEW CORNER CURB RAMP PER COA STD. DWG. 2426. 67. NEW CONCRETE BENCH. SEE SITE DETAILS.

68. FIRE LINE YALVES AND BACKFLOW PREVENTER IN HOT BOX MOUNTED, MOUNTED ON CONC. PAD. SEE UTILITIES, SEE MECHANICAL. 69. FIRE LINE POST INDICATOR VALVE (P.I.Y.). SEE UTILITIES, SEE MECHANICAL REMOTE FIRE DEPT. CONNECTION (RF.D.C.). SEE UTILITIES, SEE MECHANICAL 71. LEADING EDGE OF BOTTOM TREAD AT NON-UNIFORM HEIGHT RIGER

(3M SAFETY-WALK GENERAL PURPOSE TAPES, SERIES 600 OR EQUAL COLOR: BLACK 1610, SIZE: 2" 72. PROVIDE 6" WIDE DRAINAGE SLOT IN TOP OF CONC. BENCH TO DRAIN ADJACENT FLATWORK. BOTTOM OF SLOT SHALL DRAIN WEST. SEE CIVIL. TOOL CONTROL JOINTS IN VERTICAL FACE OF CONC. BENCH.

13. ELECTRIC TRANSFORMER ON MIN. 6'X6' CONC. PAD PER FNM SPECS. SEE UTILITIES, SEE ELECTRICAL. COORDINATE WITH FNM. PERCOLATION PIT. SEE CIVIL FOR DESIGN DETAILS.

15. GAS METER. SEE UTILITIES, SEE MECHANICAL. PROVIDE TWO (2) BOLLARDS. PAINT BOLLARDS AND METER/PIPING PAINT COLOR XP-1. SEE SHT. C4.1.

16. NEW PUBLIC SIDEWALK EASEMENT. SEE SHT. CO.O., SURVEY REPLAT.

EXIST. COA PUBLIC UTILITY EASEMENT. SEE SHT. CO.O, SURVEY REPLAT. 18. EXIST. COA PUBLIC STORM DRAIN EASEMENT. SEE STH. CO.O, SURVEY REPLAT. 79. "FLOATING BEAM." SEE STRUCTURAL AND EXTERIOR ELEVATIONS. 80. DEPRESS CONC. FLATWORK SLAB 1/2" IN THIS AREA AND INSTALL 13"X13" CERAMIC TILE, AMALFI NOCE, IN STAGGERED PATTERN SHOWN. SEE 49 SHTS.

Public Infrastructure shown on these plans for information only and not part of approval. Separate DRC/Permit approval and Work Order required.

TRAFFIC CIRCULATION LAYOU

MUST HAVE TRUNCATED DOMES.

LEGEND - NEW PAVING Asphaltic Concrete Pavement

HEAVY-DUTY ASPHALTIC CONCRETE PAYING SECTION: 3" THK, CONCRETE ON 4" THK, AGGREGATE BASE COURSE ON COMPACTED FILL PER GEOTECHNICAL REPORT RECOMMENDATIONS. COA CLASS B MIN. STANDARD-DUTY ASPHALTIC CONCRETE PAYING SECTION:

3" THK. ASPHALTIC CONCRETE ON COMPACTED FILL PER GEOTECHNICAL REPORT RECOMMENDATIONS. COA CLASS B MIN.

Portland Cement Concrete Pavement

HEAVY-DUTY PORTLAND CEMENT CONC. PAYING SECTION: (AT REFUSE ENCLOSURE ONLY)

6" THK. P.C., 4,000 PSI WITH 3/4" AGGREGATE, AND 5×6-10/10 WWM. REINFORCEMENT AT REFUSE APRON, AND $A^\prime PPROVED$ 6" THK. P.C., 4,000 PSI WITH 3/4" AGGREGATE, AND 6×6-10/10 WWM. REINFORCEMENT IN REFUSE ENCLOSURE. ON 4" AGGREGATE COURSE ON COMPACTED FILL PER GEOTECHNICAL REPORT RECOMMENDATIONS.

STANDARD-DUTY PORTLAND CEMENT CONC. PAVING SECTION: (AT ALL OTHER AREAS) 4" THK. P.C., 3,000 PSI MIX PER SPECIFICATIONS, AND

ON COMPACTED FILL PER GEOTECHNICAL. EJ. = 1/2" WIDE EXPANSION JOINT, FULL DEPTH. CONTROL/CONSTRUCTION JOINT, TOOLED.

C3.

acad file:

MPROVEMENTS

ШѮ 工员

sheet title: ARCHITECTURAL SITE PLAN EAST

PARKING CALCULATIONS

APR 24 2008 HYDROLOGY

GENERAL NOTES

A. ALL WORK IN PUBLIC RIGHT-OF-WAY WORK SHALL COMPLY WITH CITY OF ALBUQUERQUE (COA) STANDARDS. B. ALL DIMENSIONS ON THIS SITE PLAN ARE TO FACE OF CURB, CENTER LINE OF TRAFFIC STRIPE, OR EDGE OF CONCRETE, UNO. C. SEE ALSO CIVIL FOR ADDITIONAL INFORMATION. D. SEE ALSO MECHANICAL AND ELECTRICAL FOR ADDITIONAL

INFORMATION.

E. SEE LANDSCAPING AND IRRIGATION SHEETS FOR ADDITIONAL INFORMATION AND FOR LANDSCAPING CALUCULATIONS. F. SEE PROJECT MANUAL FOR GEOTECHNICAL REPORT BY VINYARD & ASSOCIATES, INC. PROJECT 07-01-341, DATED SEPTEMBER 24, 2007.

KEYED NOTES

NOTE: THE FOLLOWING KIEYED NOTES APPLY TO SHEETS C3.1 AND C3.2. SOME NOTES MAY NOT BE USED ON EVERY SHEET. NEW CMU/STUCCO SITE WALL. SEE SITE ELEVATIONS & DETAILS. EXISTING 6' HIGH CMU SITE WALL TO REMAIN.

3. EXISTING ADOBE/CMU SITE WALL. HEIGHT VARIES, SEE SITE ELEVATIONS 4 DETAILS ON SHEET C42. 4. PAINT DASHED PORTION OF CURB FACE AND TOP COLOR RED WITH WHITE STENCILED 4" HIGH LETTERS "NO PARKING" AND "FIRE LANE" ALTERNATING 5. EXISTING DOUBLE-HEAD LIGHT POLE WITH CONCRETE BASE ON ADJACENT PROPERTY. (NORTH HEAD THROUG LIGHT ONTO PROPERTY IN THIS WORK).

6. NEW LIGHT POLE WITH CONCRETE BASE COMPLYING WITH LIGHTING REGULATIONS ON THIS SHT. SEE ELECTRICAL. 7. 5'-0" WIDE CROSSWALK OF 12" WIDE STRIPES AT 30" O.C. PAINTED WITH WHITE REFLECTIVE TRAFFIC PAINT. 8. 4" WIDE WHITE TRAFFIC PAINT PAYEMENT MARKINGS, TYP. AT NON-

HANDICAP AND MOTORCYCLE PARKING SPACES. 9. 4" WIDE BLUE TRAFFIC PAINT AT PERIMETER AND 45 DEG STRIPES AT 3'-0" O.C. AT HANDICAP ACCESSIBLE AISLES. PAINT 4" W BLUE STRIPE BETWEEN HANDICAP ACCESSIBLE SPACES NOT SEPARATED BY AISLES. 10. PAINTED WHEELCHAIR SYMBOL ON PAVEMENT, SEE SITE DETAILS. PAINT WHITE STENCILED 12" HIGH LETTERS "YAN" WHERE SHOWN. 11. PAINT WHITE STENCILED 12" HIGH LETTERS "COMPACT" WHERE SHOWN, OR "STAFF" WHERE SHOWN.

12. 4" WIDE WHITE TRAFFIC PAINT AT PERIMETER AND 45 DEG STRIPES AT 3'-0" O.C. AT BICYCLE PARKING AREA. 13. 18" W X 10'-0" L (MIN.) WHITE REFLECTIVE TRAFFIC STRIPE AND TEXT "STOP" IN 18" H LETTERS WHERE SHOWN. 14. WHITE REFLECTIVE DIRECTIONAL TRAFFIC ARROW, DIRECTION AS INDICATED. SEE SITE DETAILS. 15. DOUBLE TRAFFIC YELLOW' TRAFFIC PAINT STRIPING DIVIDER LINE - TWO 4" WIDE STRIPES SEPARATED BY 4" CLEAR.

16. SINGLE 4" WIDE STRIPE WHITE TRAFFIC PAINT. SOLID FIRST 60", BROKEN LINE BALANCE OF LENGTH. IT. NEW CONC. CURB AND GUTTER COA STD. 2415, MEDIAN C4G. SEE CIVIL. 18. 2'-0" WIDE BREAK IN CURB. SEE CIVIL. 19. 2'-0" WIDE CONC. CHANNEL. SEE CIVIL. 20. 1'-0" WIDE SIDEWALK CULVERT, SEE CIVIL. PROVIDE COVER WHERE SHOWN.

21. 2'-0" WIDE SIDEWALK CULVERT, SEE CIVIL. PROVIDE COVER WHERE SHOWN. NEW STORM INLET. SEE CIVIL. 23. NEW UNDERGROUND STORM DRAIN PIPE. SEE CIVIL. 24. EXIST. STORM INLET AND UNDERGROUND PIPING. PROTECT. SEE CIVIL. 25. 6'-0" WIDE EROSION PROTECTION. SEE CIVIL. 26. FORMED ASPHALTIC CONCRETE CURB ON TOP OF ASPHALTIC CONC. PAYING PER COA STD. DWG. 2415.

27. CONCRETE PAYING TURNDOWN EDGE DETAIL AT ASPHALT. SEE SITE DETAILS. 28. TURN-DOWN EDGE OF ASPHALTIC CONC. PAYING. (8" DEEP x 12" WIDE) 29. NEW CONCRETE STAND-UP CURB. SEE SITE DETAILS. 30. NEW HANDRAIL. SEE DETAIL 20/C4.1.

31. FLUSH ASPHALT/CONC. PAYING. SEE SITE DETAILS. SEE CIVIL. 32. EDGE OF PAYEMENT. 33. NEW AND EXISTING PAVEMENT TO MEET FLUSH AND HAVE POSITIVE DRAINAGE. SEE CIVIL. 34. EXIST. STAIRS OR RAMP STRUCTURE TO REMAIN.

35. PRE-CAST CONC. BUMPER. CENTER ON WIDTH OF PARKING SPACE AND MOUNT 2'-0" FROM FACE OF CAR SIDE OF BUMPER TO F.O.CURB, SEE DETAIL. 36. 2'-0" WIDE RAISED CONC. MEDIAN. SEE SITE DETAILS. 31. EXISTING CONC. CURB, GUTTER AND SIDEWALK TO REMAIN. PROTECT. 38. EXISTING PAYEMENT TO REMAIN. PROTECT. 39. DASHED LINE INDICATES ROOF LINE ABOVE. 40. LANDSCAPE AREA. SEE LANDSCAPE DRAWINGS.
41. NEW LOCATION OF SALVAGED DEDICATION STONE AND CROSS.

42. DASHED LINES INDICATE FUTURE CONSTRUCTION, NOT IN THIS WORK. 43. EXISTING 6' TALL PERIMETER CHAIN LINK FENCE TO REMAIN. 44. NEW PUBLIC FIRE HYDRANT PER COA STANDARDS. SEE UTILITIES, SEE CIVIL. LOCATE HYDRANT IN CENTER OF 3'-0" X 3'-0" CONC. PAD. POUR PAD TO WEST AND CLEAR OF 6'-0" WIDE PUBLIC SIDEWALK.
45. 25' CLEAR SIGHT TRIANGLE PER COA.
46. 35' CLEAR SIGHT TRIANGLE PER COA.

47. STRAIGHT CURB RAMP. SEE SITE DETAILS.
48. FLARED CURB RAMP. SEE SITE DETAILS.
49. CURB-BREAK RAMP. SEE SITE DETAILS. 50. 2-SIDED CURB RAMP. SEE SITE DETAILS. 'HANDICAPPED PARKING' SIGN. SEE SITE DETAILS. MOTORCYCLE PARKING' SIGN. SEE SITE DETAILS. PROVIDE 4 SPACES.

53. 'BICYCLE PARKING' SIGN. SEE SITE DETAILS. 54. BIKE RACK. SEE SITE DETAILS. PROVIDE 8 SPACES TOTAL. 55. 'STOP' SIGN. SEE SITE DETAILS. 56. KEEP RIGHT' SIGN. SEE SITE DETAILS. 57. REPAIR END OF EXIST. ADOBE WALL WHERE PORTION OF EXIST.

REMOVED. SEE SITE DEMO PLAN. SEE ALSO SHT. C42. 58. NEW REFUSE ENCLOSURE AND APRON. SEE SITE DETAILS. 59. NEW STAIRS. SEE SITE DETAILS. (SEE LEGEND BELOW FOR DESCRIPTIONS OF PAVEMENT)
60. NEW STANDARD-DUTY PORTLAND CEMENT CONCRETE PAVING.
61. NEW HEAVY-DUTY PORTLAND CEMENT CONCRETE PAVING. 62. NEW STANDARD-DUTY ASPHALTIC CONCRETE PAYING. 63. NEW HEAVY-DUTY ASPHALTIC CONCRETE PAYING.

64. EXISTING MONUMENT SIGN TO REMAIN. 65. NEW DRIVEPAD/DROPPED SIDEWALK CURBS. CONSTRUCT PER COA.

STD. DWG. 2426. SEE CIVIL.

66. NEW CORNER CURB RAMP PER COA STD. DWG. 2426.

67. NEW CONCRETE BENCH. SEE SITE DETAILS.

68. FIRE LINE YALVES AND BACKFLOW PREVENTER IN HOT BOX MOUNTED, MOUNTED ON CONC. PAD. SEE UTILITIES, SEE MECHANICAL. 69. FIRE LINE POST INDICATOR VALVE (P.I.V.). SEE UTILITIES, SEE MECHANICAL REMOTE FIRE DEPT. CONNECTION (RF.D.C.). SEE UTILITIES, SEE MECHANICAL.

11. LEADING EDGE OF BOTTOM TREAD AT NON-UNIFORM HEIGHT RISER TO HAVE DISTINCTIVE MARKING STRIPE W/ SLIP RESISTANT SURFACE.
(3M SAFETY-WALK GENERAL PURPOSE TAPES, SERIES 600 OR EQUAL COLOR: BLACK *610, SIZE: 2" 72. PROVIDE 6" WIDE DRAINAGE SLOT IN TOP OF CONC. BENCH TO DRAIN ADJACENT FLATWORK. BOTTOM OF SLOT SHALL DRAIN WEST. SEE CIVIL.

TOOL CONTROL JOINTS IN VERTICAL FACE OF CONC. BENCH. 13. ELECTRIC TRANSFORMER ON MIN. 6'X6' CONC. PAD PER FNM SPECS. SEE UTILITIES, SEE ELECTRICAL. COORDINATE WITH FNM. 14. PERCOLATION PIT. SEE CIVIL FOR DESIGN DETAILS.

15. GAS METER. SEE UTILITIES, SEE MECHANICAL. PROVIDE TWO (2) BOLLARDS. PAINT BOLLARDS AND METER/PIPING PAINT COLOR XP-1. SEE SHT. C4.1.
16. NEW PUBLIC SIDEWALK EASEMENT. SEE SHT. CO.O., SURVEY REPLAT. 17. EXIST. COA PUBLIC UTILITY EASEMENT. SEE SHT. CO.O., SURVEY REPLAT.
18. EXIST. COA PUBLIC STORM DRAIN EASEMENT. SEE STH. CO.O., SURVEY REPLAT.
19. "FLOATING BEAM." SEE STRUCTURAL AND EXTERIOR ELEVATIONS.
80. DEPRESS CONC. FLATWORK SLAB 1/2" IN THIS AREA AND INSTALL 13"X13"

CERAMIC TILE, AMALFI NOCE, IN STAGGERED PATTERN SHOWN. SEE AS SHTS.

SYMBOLS LEGEND ₩ ELECTRIC METER

GAS METER XX WV WATER VALVE O WM WATER METER

o CO SEWER CLEANOUT IRR IRRIGATION CONTROL VALVE/BOX → FH FIRE HYDRANT

● PP POWER POLE ANCH ANCHOR -O-LP LIGHT POLE

MH SANITARY SEWER MANHOLE

----OVERHEAD POWER LINE _____ BURIED POWER CONDUIT INDEX COUTOUR INTERVAL: 5 FT.

CONTOUR INTERVAL: 1 FT.

SPOT ELEVATION UNLESS OTHERWISE INDICATED, SPOT ELEVATIONS ARE TO NATURAL GRADE

EDGE OF ASPHALT

CHAIN LINK FENCE

STORM DRAIN LINE

BURIED TELEPHONE LINE

TOP OF ASPHALT


GAS LINE

TOP OF CURB / CONCRETE FLOWLINE TW TOP OF WALK OR WALL * * *

RECEIVED APR 24 2008

TRANSPORTATION

HYDROLOGY

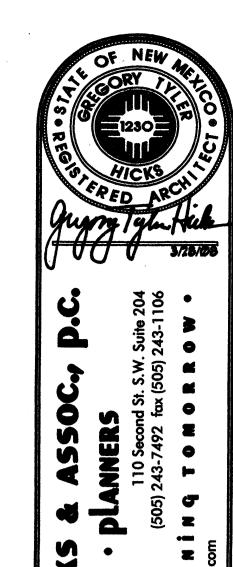

0715C3

SANTA - IMPROVEMENTS

の正法

KESE WCHURC


ARCHDIO SAN JOSE PARISH N

sheet title:

ARCHITECTURAL

SITE PLAN WEST


C3.2

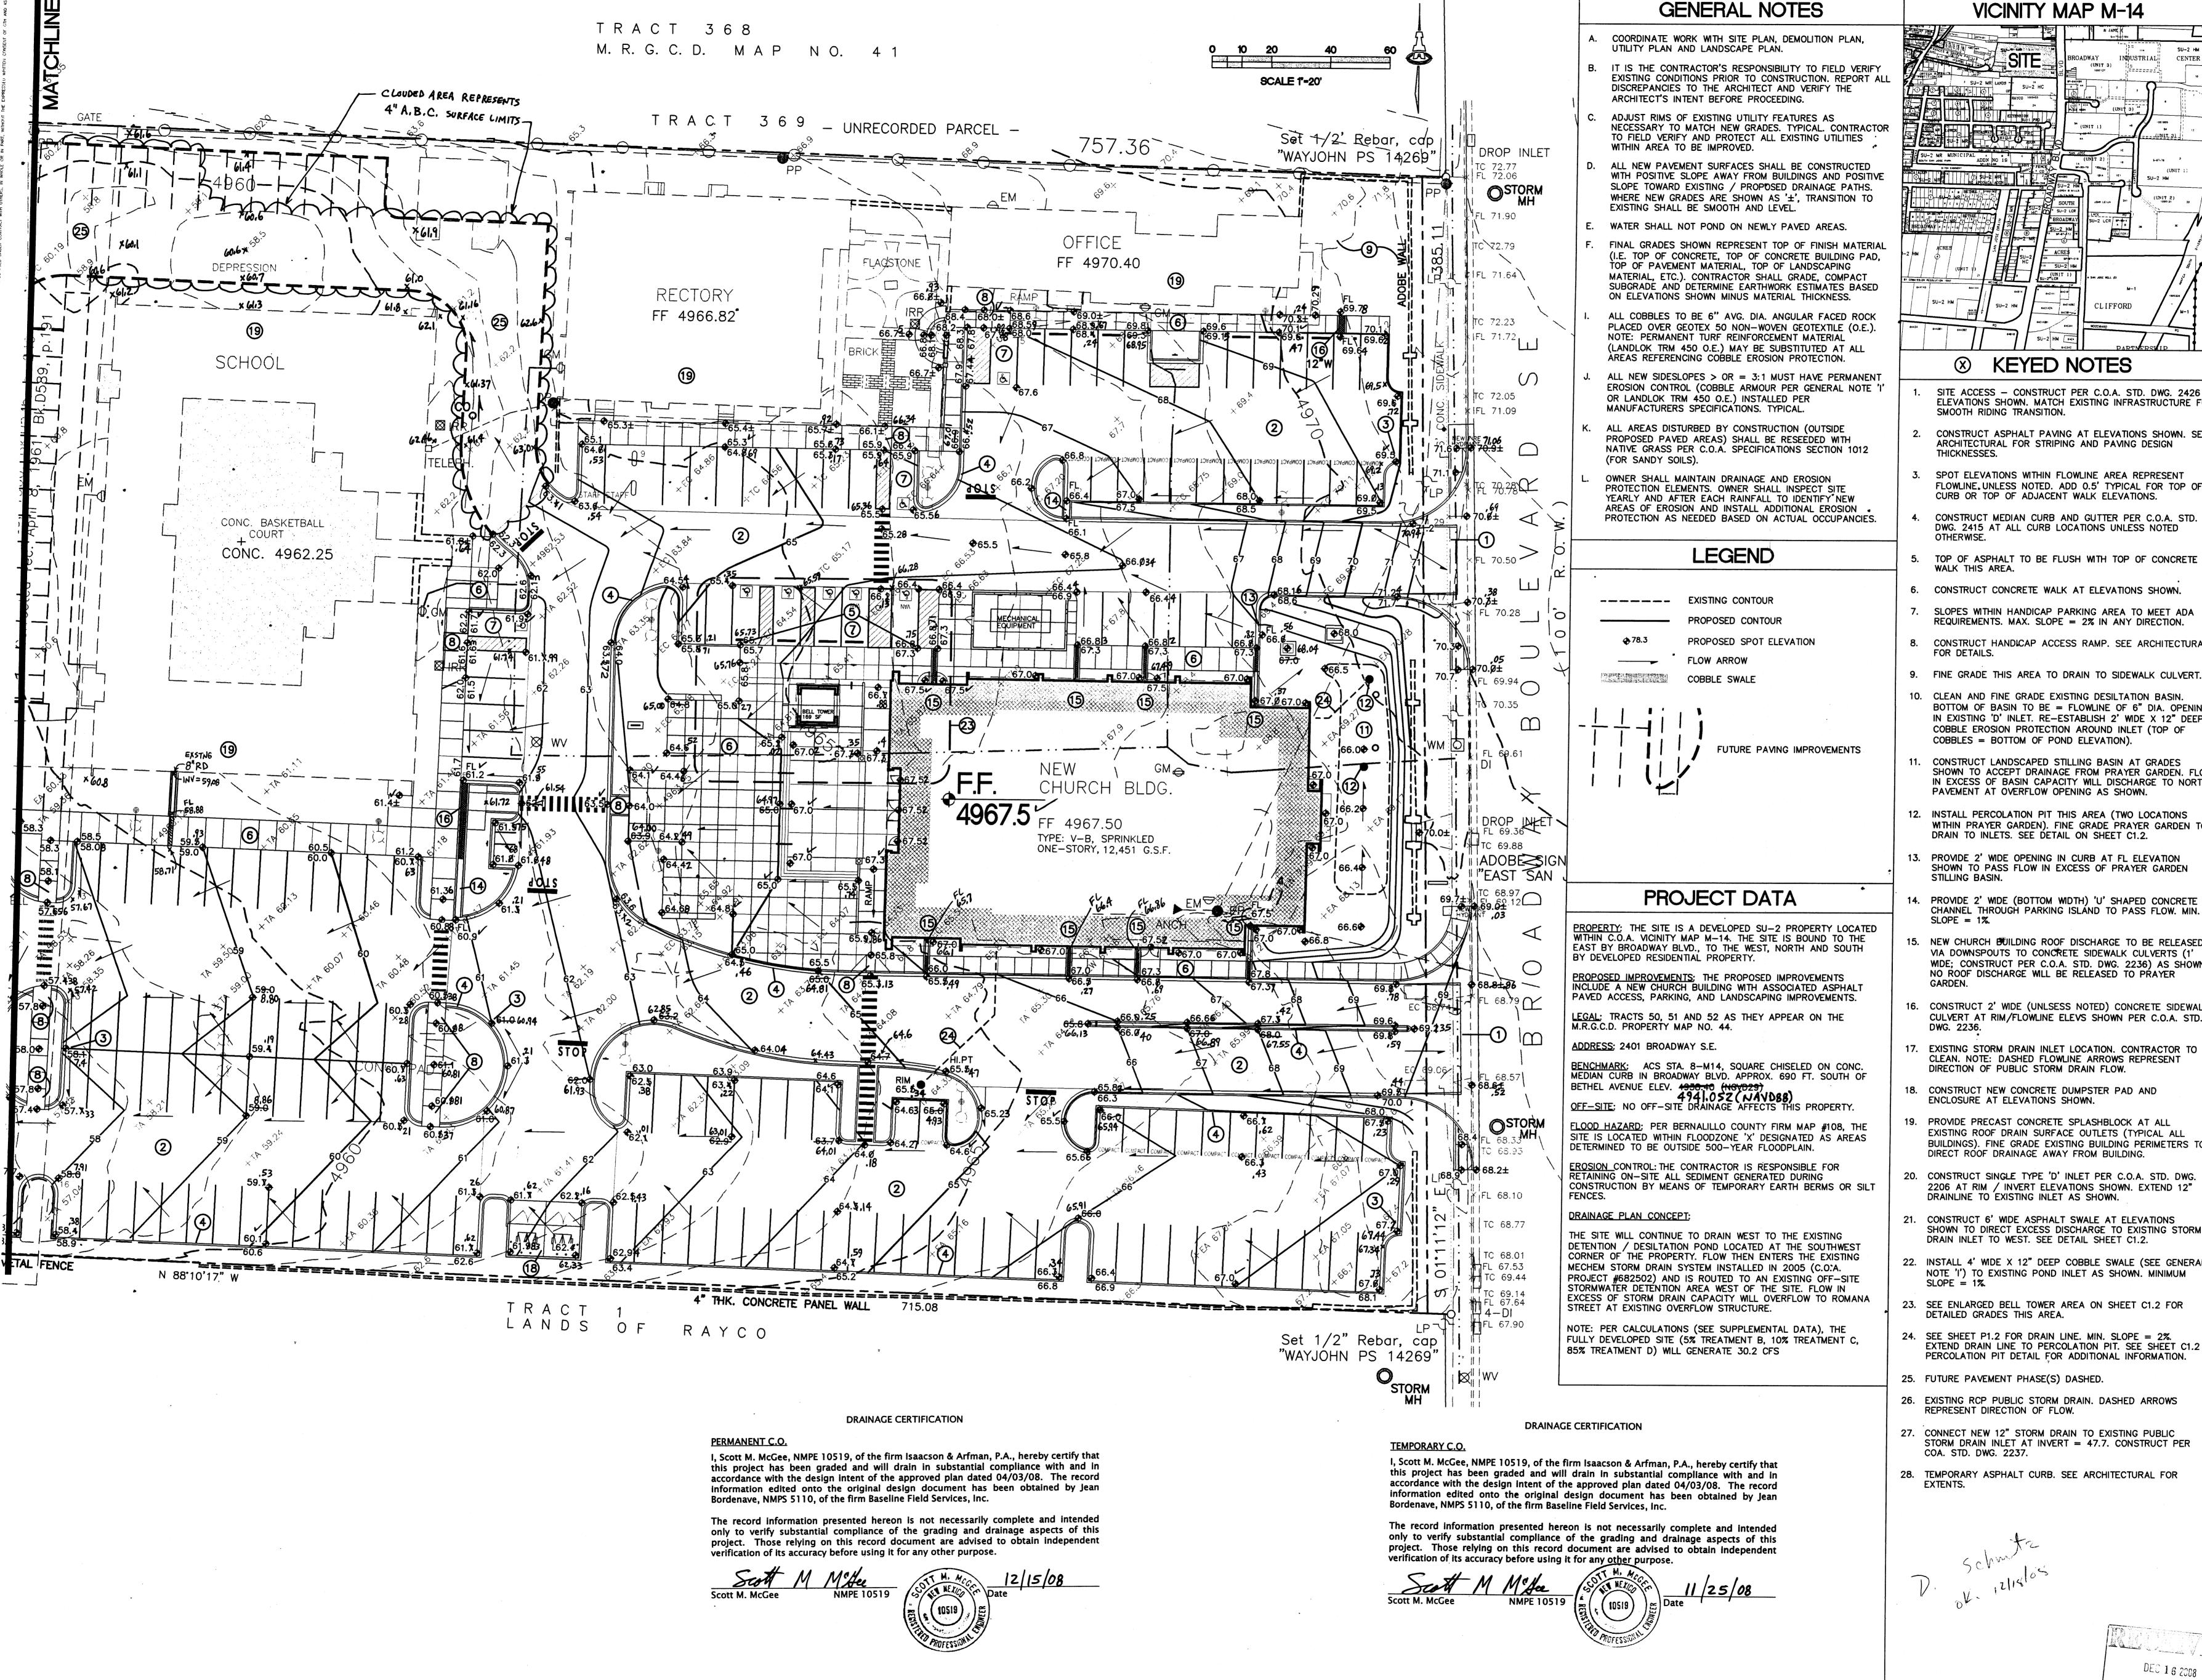

VICINITY MAP M-14

KEYED NOTES

- SITE ACCESS CONSTRUCT PER C.O.A. STD. DWG. 2426 TO ELEVATIONS SHOWN. MATCH EXISTING INFRASTRUCTURE FOR SMOOTH RIDING TRANSITION.
- CONSTRUCT ASPHALT PAVING AT ELEVATIONS SHOWN. SEE ARCHITECTURAL FOR STRIPING AND PAVING DESIGN
- SPOT ELEVATIONS WITHIN FLOWLINE AREA REPRESENT
- FLOWLINE, UNLESS NOTED. ADD 0.5' TYPICAL FOR TOP OF CURB OR TOP OF ADJACENT WALK ELEVATIONS. CONSTRUCT MEDIAN CURB AND GUTTER PER C.O.A. STD.
- 5. TOP OF ASPHALT TO BE FLUSH WITH TOP OF CONCRETE
- 6. CONSTRUCT CONCRETE WALK AT ELEVATIONS SHOWN.
- SLOPES WITHIN HANDICAP PARKING AREA TO MEET ADA REQUIREMENTS. MAX. SLOPE = 2% IN ANY DIRECTION.
- 8. CONSTRUCT HANDICAP ACCESS RAMP. SEE ARCHITECTURAL FOR DETAILS.
- 10. CLEAN AND FINE GRADE EXISTING DESILTATION BASIN. BOTTOM OF BASIN TO BE = FLOWLINE OF 6" DIA. OPENINGS IN EXISTING 'D' INLET. RE-ESTABLISH 2' WIDE X 12" DEEP COBBLE EROSION PROTECTION AROUND INLET (TOP OF
- 11. CONSTRUCT LANDSCAPED STILLING BASIN AT GRADES SHOWN TO ACCEPT DRAINAGE FROM PRAYER GARDEN. FLOW IN EXCESS OF BASIN CAPACITY WILL DISCHARGE TO NORTH
- PAVEMENT AT OVERFLOW OPENING AS SHOWN. 12. INSTALL PERCOLATION PIT THIS AREA (TWO LOCATIONS
- WITHIN PRAYER GARDEN). FINE GRADE PRAYER GARDEN TO DRAIN TO INLETS. SEE DETAIL ON SHEET C1.2.
- SHOWN TO PASS FLOW IN EXCESS OF PRAYER GARDEN STILLING BASIN.
- 15. NEW CHURCH BUILDING ROOF DISCHARGE TO BE RELEASED VIA DOWNSPOUTS TO CONCRETE SIDEWALK CULVERTS (1'
- WIDE: CONSTRUCT PER C.O.A. STD. DWG. 2236) AS SHOWN. NO ROOF DISCHARGE WILL BE RELEASED TO PRAYER 16. CONSTRUCT 2' WIDE (UNLSESS NOTED) CONCRETE SIDEWALK
- CULVERT AT RIM/FLOWLINE ELEVS SHOWN PER C.O.A. STD.
- 17. EXISTING STORM DRAIN INLET LOCATION. CONTRACTOR TO CLEAN. NOTE: DASHED FLOWLINE ARROWS REPRESENT DIRECTION OF PUBLIC STORM DRAIN FLOW.
- ENCLOSURE AT ELEVATIONS SHOWN.
- 19. PROVIDE PRECAST CONCRETE SPLASHBLOCK AT ALL EXISTING ROOF DRAIN SURFACE OUTLETS (TYPICAL ALL BUILDINGS). FINE GRADE EXISTING BUILDING PERIMETERS TO DIRECT ROOF DRAINAGE AWAY FROM BUILDING.
- 20. CONSTRUCT SINGLE TYPE 'D' INLET PER C.O.A. STD. DWG. 2206 AT RIM / INVERT ELEVATIONS SHOWN. EXTEND 12" DRAINLINE TO EXISTING INLET AS SHOWN.
- 21. CONSTRUCT 6' WIDE ASPHALT SWALE AT ELEVATIONS SHOWN TO DIRECT EXCESS DISCHARGE TO EXISTING STORM DRAIN INLET TO WEST. SEE DETAIL SHEET C1.2.
- 22. INSTALL 4' MDE X 12" DEEP COBBLE SWALE (SEE GENERAL NOTE 'I') TO EXISTING POND INLET AS SHOWN. MINIMUM
- 23. SEE ENLARGED BELL TOWER AREA ON SHEET C1.2 FOR DETAILED GRADES THIS AREA.
- 24. SEE SHEET P1.2 FOR DRAIN LINE. MIN. SLOPE = 2%. EXTEND DRAIN LINE TO PERCOLATION PIT. SEE SHEET C1.2 PERCOLATION PIT DETAIL FOR ADDITIONAL INFORMATION.
- 25. FUTURE PAVEMENT PHASE(S) DASHED. 26. EXISTING RCP PUBLIC STORM DRAIN. DASHED ARROWS
- 27. CONNECT NEW 12" STORM DRAIN TO EXISTING PUBLIC STORM DRAIN INLET AT INVERT = 47.7. CONSTRUCT PER
- 28. TEMPORARY ASPHALT CURB. SEE ARCHITECTURAL FOR

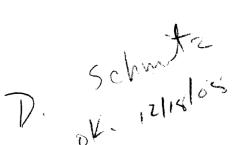

·* * * *

SACVEMENTS IMPROVEMENTS 『SPE PARISH


acad file:

SINCE 1980

sheet title: **GRADING AND DRAINAGE PLAN** EAST

T S S S

DEC 16 2008

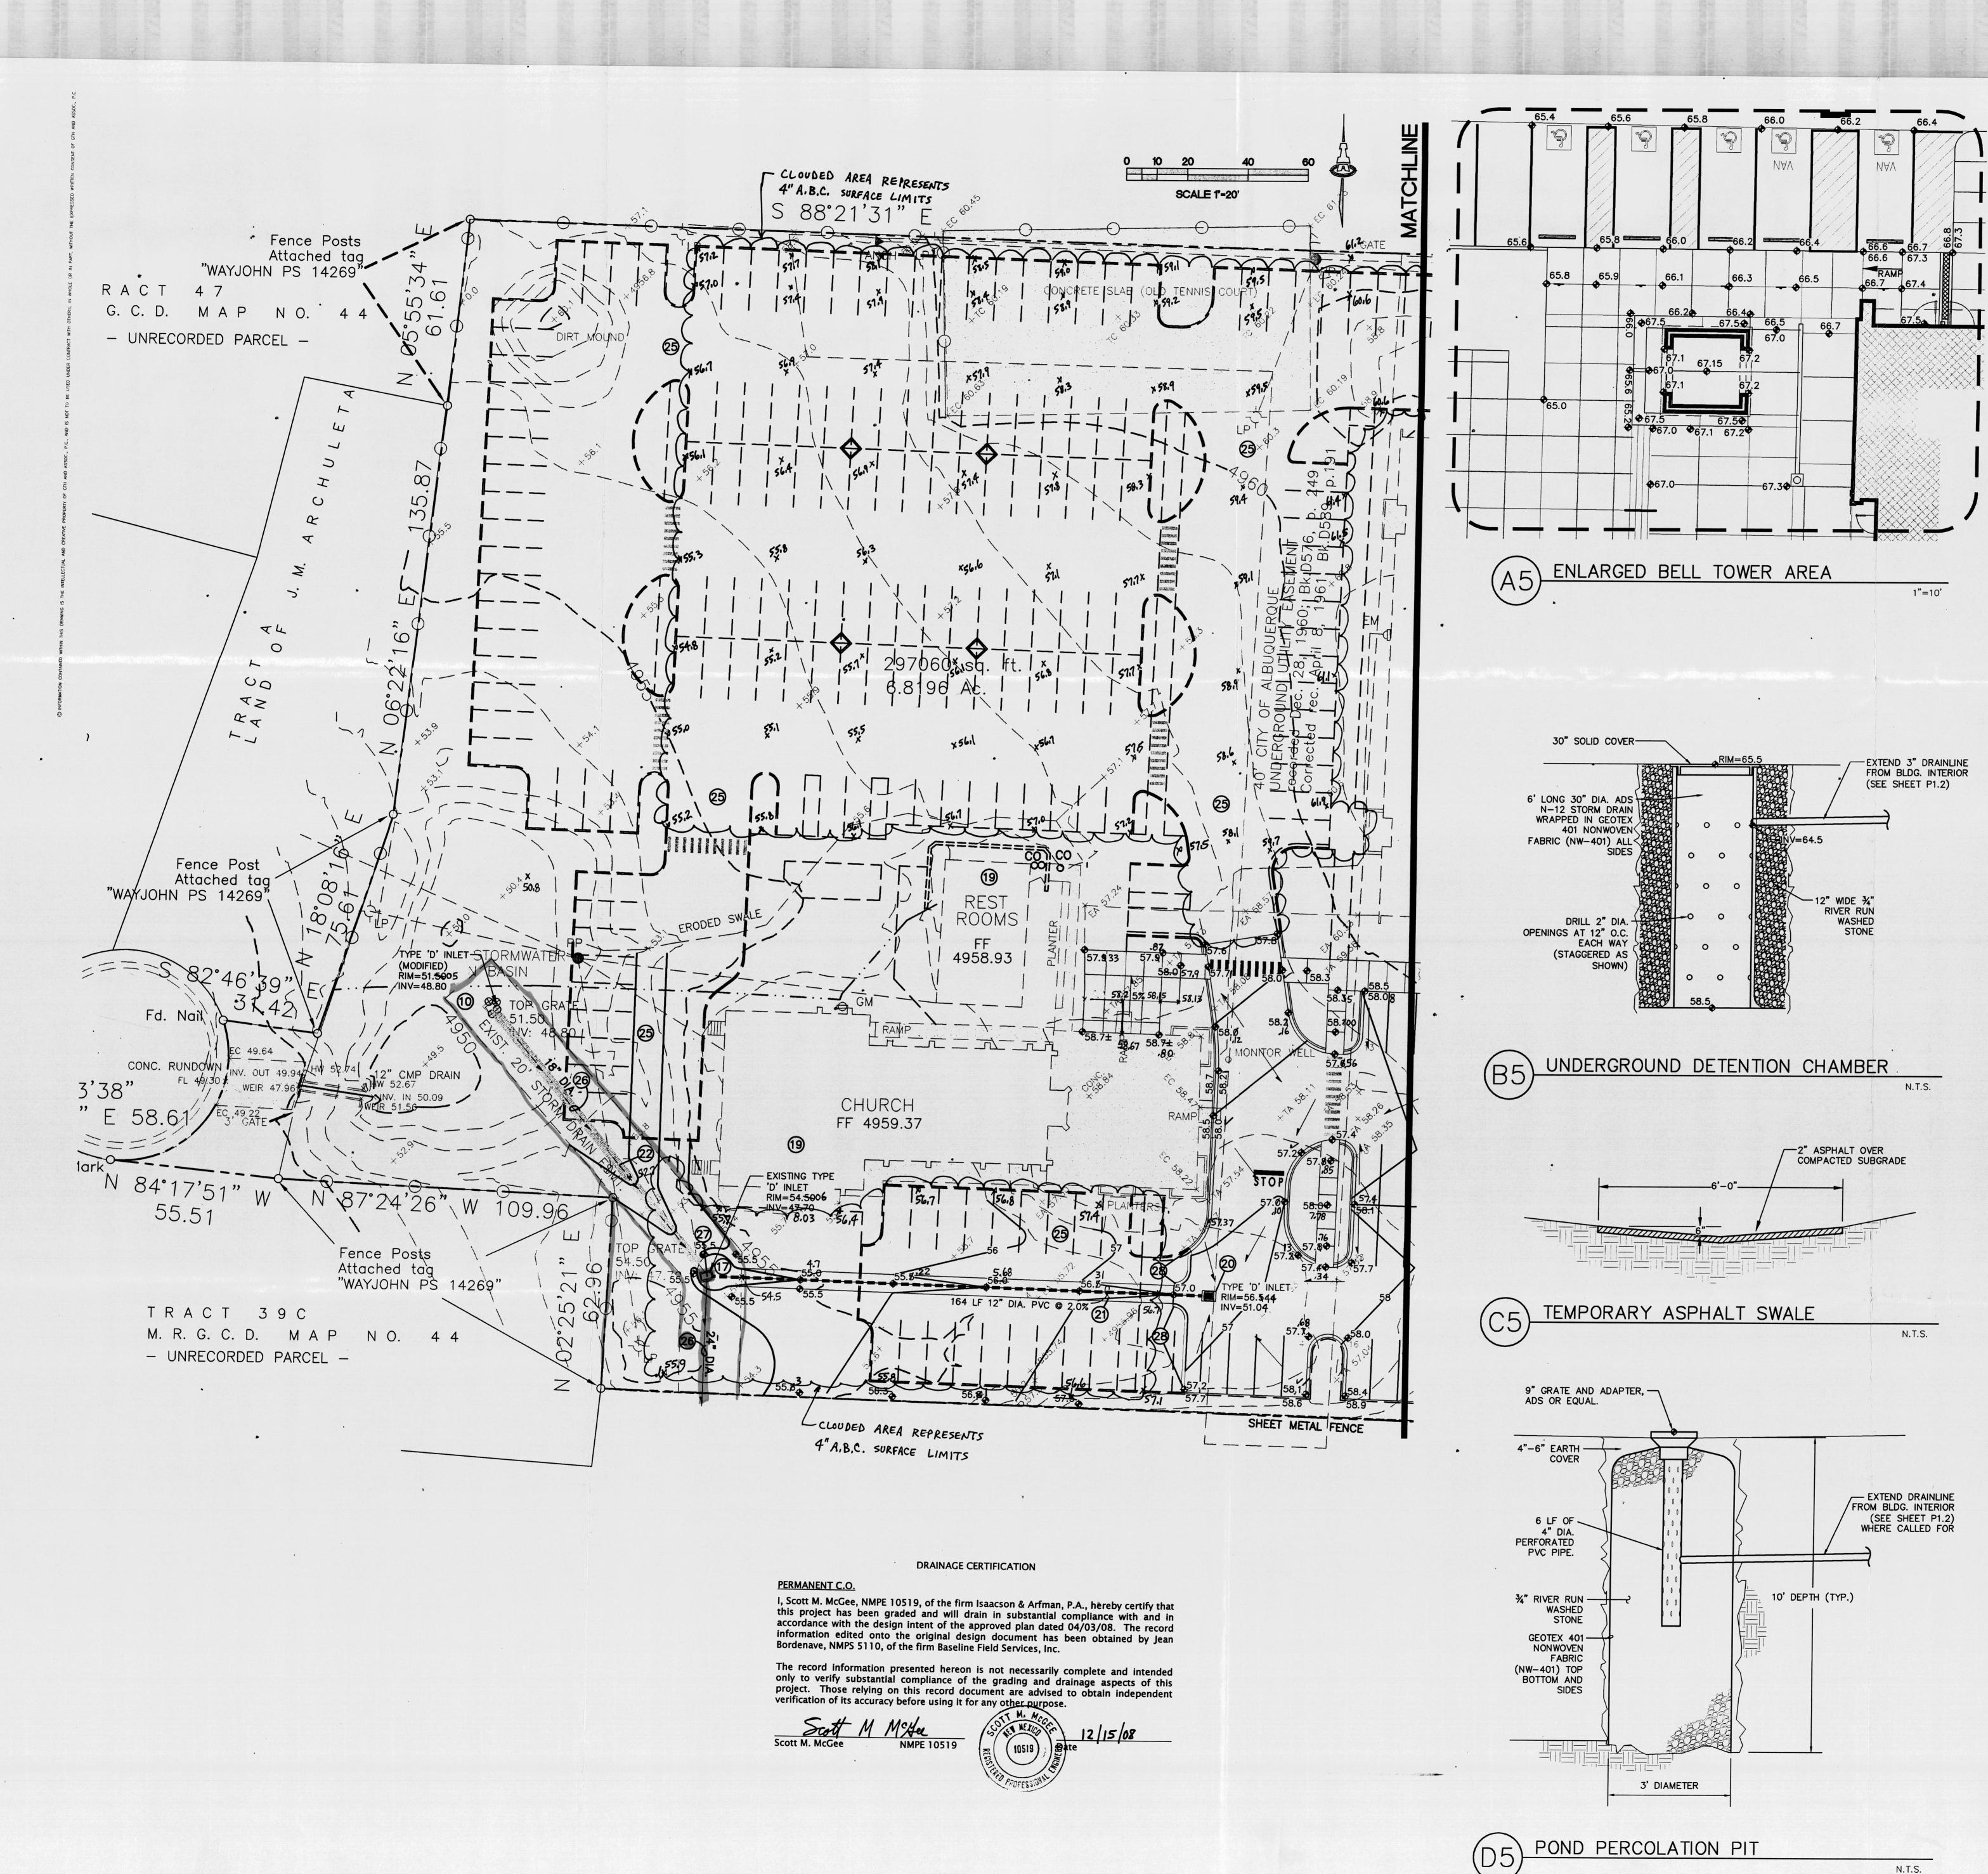

KEYED NOTES

- SITE ACCESS CONSTRUCT PER C.O.A. STD. DWG. 2426 TO ELEVATIONS SHOWN. MATCH EXISTING INFRASTRUCTURE FOR SMOOTH RIDING TRANSITION.
- CONSTRUCT ASPHALT PAVING AT ELEVATIONS SHOWN. SEE ARCHITECTURAL FOR STRIPING AND PAVING DESIGN THICKNESSES.
- SPOT ELEVATIONS WITHIN FLOWLINE AREA REPRESENT FLOWLINE UNLESS NOTED. ADD 0.5' TYPICAL FOR TOP OF
- * CURB OR TOP OF ADJACENT WALK ELEVATIONS. CONSTRUCT MEDIAN CURB AND GUTTER PER C.O.A. STD. DWG. 2415 AT ALL CURB LOCATIONS UNLESS NOTED
- TOP OF ASPHALT TO BE FLUSH WITH TOP OF CONCRETE
- WALK THIS AREA.
- CONSTRUCT CONCRETE WALK AT ELEVATIONS SHOWN.
- SLOPES WITHIN HANDICAP PARKING AREA TO MEET ADA REQUIREMENTS. MAX. SLOPE = 2% IN ANY DIRECTION.
- CONSTRUCT HANDICAP ACCESS RAMP. SEE ARCHITECTURAL FOR DETAILS.
- 9. FINE GRADE THIS AREA TO DRAIN TO SIDEWALK CULVERT.
- 10. CLEAN AND FINE GRADE EXISTING DESILTATION BASIN. BOTTOM OF BASIN TO BE = FLOWLINE OF 6" DIA. OPENINGS IN EXISTING 'D' INLET. RE-ESTABLISH 2' WIDE X 12" DEEP COBBLE EROSION PROTECTION AROUND INLET (TOP OF COBBLES = BOTTOM OF POND ELEVATION).
- CONSTRUCT LANDSCAPED STILLING BASIN AT GRADES SHOWN TO ACCEPT DRAINAGE FROM PRAYER GARDEN. FLOW IN EXCESS OF BASIN CAPACITY WILL DISCHARGE TO NORTH PAVEMENT AT OVERFLOW OPENING AS SHOWN.
- 12. INSTALL PERCOLATION PIT THIS AREA (TWO LOCATIONS WITHIN PRAYER GARDEN). FINE GRADE PRAYER GARDEN TO DRAIN TO INLETS. SEE DETAIL ON SHEET C1.2.
- 13: PROVIDE 2' WIDE OPENING IN CURB AT FL ELEVATION SHOWN TO PASS FLOW IN EXCESS OF PRAYER GARDEN

SLOPE = 1%.

- STILLING BASIN. 14. PROVIDE 2' WIDE (BOTTOM WIDTH) 'U' SHAPED CONCRETE CHANNEL THROUGH PARKING ISLAND TO PASS FLOW. MIN.
- 15. NEW CHURCH BUILDING ROOF DISCHARGE TO BE RELEASED VIA DOWNSPOUTS TO CONCRETE SIDEWALK CULVERTS (1' WDE; CONSTRUCT PER C.O.A. STD. DWG. 2236) AS SHOWN. NO ROOF DISCHARGE WILL BE RELEASED TO PRAYER
- 16. CONSTRUCT 2' WIDE (UNLSESS NOTED) CONCRETE SIDEWALK CULVERT AT RIM/FLOWLINE ELEVS SHOWN PER C.O.A. STD.
- 17. EXISTING STORM DRAIN INLET LOCATION. CONTRACTOR TO CLEAN. NOTE: DASHED FLOWLINE ARROWS REPRESENT DIRECTION OF PUBLIC STORM DRAIN FLOW.
- 18. CONSTRUCT NEW CONCRETE DUMPSTER PAD AND ENCLOSURE AT ELEVATIONS SHOWN.
- 19. PROVIDE PRECAST CONCRETE SPLASHBLOCK AT ALL EXISTING ROOF DRAIN SURFACE OUTLETS (TYPICAL ALL BUILDINGS). FINE GRADE EXISTING BUILDING PERIMETERS TO DIRECT ROOF DRAINAGE AWAY FROM BUILDING.
- 20. CONSTRUCT SINGLE TYPE 'D' INLET PER C.O.A. STD. DWG. 2206 AT RIM / INVERT ELEVATIONS SHOWN. EXTEND 12" DRAINLINE TO EXISTING INLET AS SHOWN.
- 21. CONSTRUCT 6' WIDE ASPHALT SWALE AT ELEVATIONS SHOWN TO DIRECT EXCESS DISCHARGE TO EXISTING STORM DRAIN INLET TO WEST. SEE DETAIL SHEET C1.2.
- 22. INSTALL 4' WIDE X 12" DEEP COBBLE SWALE (SEE GENERAL NOTE 'I') TO EXISTING POND INLET AS SHOWN. MINIMUM SLOPE = 1%.
- 23. SEE ENLARGED BELL TOWER AREA ON SHEET C1.2 FOR DETAILED GRADES THIS AREA.
- 24. SEE SHEET P1.2 FOR DRAIN LINE. MIN. SLOPE = 2%. EXTEND DRAIN LINE TO PERCOLATION PIT. SEE SHEET C1.2 PERCOLATION PIT DETAIL FOR ADDITIONAL INFORMATION.
- 25. FUTURE PAVEMENT PHASE(S) DASHED.
- 26. EXISTING RCP PUBLIC STORM DRAIN. DASHED ARROWS REPRESENT DIRECTION OF FLOW.
- 27. CONNECT NEW 12" STORM DRAIN TO EXISTING PUBLIC STORM DRAIN INLET AT INVERT = 47.7. CONSTRUCT PER COA. STD. DWG. 2237.
- 28. TEMPORARY ASPHALT CURB. SEE ARCHITECTURAL FOR

S.O.19: NOTICE TO CONTRACTORS

- AN EXCAVATION / CONSTRUCTION PERMIT WILL BE REQUIRED BEFORE BEGINNING ANY WORK WITHIN THE CITY RIGHT-OF-WAY.
- ALL WORK DETAILED ON THESE PLANS TO BE PERFORMED, EXCEPT AS OTHERWISE STATED OR PROVIDED FOR HEREON, SHALL BE CONSTRUCTED IN ACCORDANCE WITH THE CITY OF ALBUQUERQUE STANDARD SPECIFICATIONS FOR PUBLIC WORKS CONSTRUCTION, 1986 EDITION AS REVISED THROUGH UPDATE #7 AMENDMENT 1.
- TWO WORKING DAYS PRIOR TO ANY EXCAVATION, THE CONTRACTOR MUST CONTACT NEW MEXICO ONE CALL SYSTEM (260-1990) FOR LOCATION OF EXISTING UTILITIES.
- PRIOR TO CONSTRUCTION, THE CONTRACTOR SHALL EXCAVATE AND VERIFY THE HORIZONTAL AND VERTICAL LOCATIONS OF ALL CONSTRUCTIONS. SHOULD A CONFLICT EXIST, THE CONTRACTOR
- SHALL NOTIFY THE ENGINEER SO THAT THE CONFLICT CAN BE RESOLVED WITH A MINIMUM AMOUNT OF DELAY. BACKFILL COMPACTION SHALL BE ACCORDING TO TRAFFIC / STREET
- MAINTENANCE OF THESE FACILITIES SHALL BE THE RESPONSIBILITY OF THE OWNER OF THE PROPERTY SERVED.
- WORK ON ARTERIAL STREETS SHALL BE PERFORMED ON A

24-HOUR BASIS. APPROVAL NAME DATE INSPECTOR

LEGEND

---- EXISTING CONTOUR PROPOSED CONTOUR PROPOSED SPOT ELEVATION

DEC 1 6 2008

HYDROLOGY

PARIS O


IS

sheet title:

GRADING AND

DRAINAGE PLAN -

SINCE 1980 •

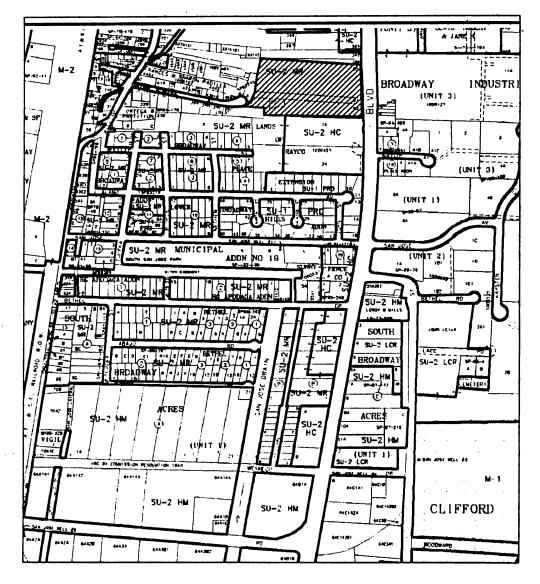

SUBDIVISION DATA

- 1. DRB Proj. No.
- 2. Zone Atlas Index No. M-14
- 3. Current Zoning SU-2 MR
- 4. Gross acreage 6.8196 Ac.
- 5. Existing number of deeded parcels 3
 Replatted number of tracts 1

LOG NO. 2008030816

NOTE

- 1. Bearings shown on this plat are New Mexico State Plane Grid, Central Zone, NAD 83. Bearings and distances in parenthesis are from existing adjoining recorded plat(s).
- 2. Perimeter distances are field measurements made on the ground.
- 3. Monuments recovered and accepted or reset are noted on inscribed plat.
- 4. No property within the area of this plat shall at any time be subject to a deed restriction, covenant, or binding agreement prohibiting solar collectors from being installed on buildings or erected on the lots or parcels within the area of proposed plat. The foregoing requirement shall be a condition to approval of this plat.
- 5. Existing 20' Public Storm Drainage easement granted to the City of Albuquerque by document recorded October 5, 2005 in Book A104, Page 7333 as document No. 2005147737.
- 6. A Forty foot (40') City of Albuquerque Underground Utility Easement traversing property from North to South recorded December 28, 1960; Book D576, page 249, Corrected and recorded April 8, 1961; Book D 589, page 191, records of Bernalillo County, New Mexico.
- 7. Public Sidewalk easement granted to the City of Albuquerque by this plat.

PURPOSE OF PLAT

والمعاملين والأرا

This plat has been prepared for the purpose of eliminating interior tract boundaries, creating one tract from three parcels, granting of easements and dedication of additional right of way.

FOR BERNALILLO COUNTY TREASURER'S OFFICE USE ONLY THIS IS TO CERTIFY THAT TAXES ARE CURRENT AND PAID ON UPC# 101405531247721620, 101405530750021621 PROPERTY OWNER OF RECORD:
ARCHDIOCESE OF SANTA FE
Control of the second of the s
BERNAULLO COUNTY TREASURER'S OFFICE
Stacy Niles 3/19/08
1

DOC# 2008031920

03/20/2008 03:20 PM Page: 1 of 2 PLAT R:\$12.00 B: 2008C P: 0054 M. Toulouse, Bernalillo County

COUNTY CLERK RECORDING LABEL HERE

DESCRIPTION

A tract of land in Albuquerque, Bernalillo County, New Mexico, within Section 32, Township 10 North, Range 3 East, N.M.P.M., being and comprising Tracts 50, 51 and 52, as they appear on the Middle Rio Grande Conservancy District Property Map No. 44, said tract being more particularly described as follows:

BEGINNING at the Northeast corner of the herein described land, being a point on the Westerly right—of—way line of Broadway Boulevard, SE, from which point NMSHC Station "G-10" (x=1522561.449, y=1477731.980, New Mexico State Plane Grid Coordinates, Central Zone, NAD 83) bears N 25'22'47" E, a distance of 1071.23 feet and running from said beginning point thence, along the West line of Broadway Boulevard, S 01'11'12" E, a distance of 385.11 feet to the Southeast corner of the herein described land;

thence, N 88'10'17" W, a distance of 715.08 feet; thence, N 02'25'21" E, a distance of 62.96 feet; thence, N 87'24'26" W, a distance of 109.96 feet;

thence, N 84'17'51" W, a distance of 55.51 feet to the Southwest corner of the herein described land, said corner being a point on the South line of Romana Avenue, SE;

thence, in a Northeasterly direction along a curve to the left following said street, having a radius of 34.61 feet, a central angle of 115°43'38", chord bearing N 37°50'20" E 58.61 feet, an arc length of 69.91 feet;

thence, departing said street, S 82'46'39" E, a distance of 31.42 feet;

thence, N 18'08'16" E, a distance of 75.61 feet;

thence, N 06°22'16" E, a distance of 135.87 feet;

thence, N 05'55'34" E, a distance of 61.61 feet to the Northwest corner of the herein described land;

thence, S 88'21'31" E, a distance of 757.36 feet to the Northeast corner and the place of beginning, containing 6.8196 acres, more or less.

FREE CONSENT

The platting of the property as described above, granting of all public and private easements and dedication of additional right of way to the City of Albuquerque in fee simple with warranty covenants is with the free consent and in accordance with the desires of the undersigned owner. Said owner warrants that it holds complete and indefeasible title in fee simple to the land subdivided.

Host Rev. Michael J. Sheetan, Archbishop and President, Roman Catholic Date Church, Archdiocese of Santa Fe

ACKNOWLEDGMENT STATE OF NEW MEXICO

COUNTY OF Romalilla

On this 4th day of March, 2008, the foregoing instrument was acknowledged before me by Most Rev. Michael J. Sheehan, Archbishop and President, Roman Catholic Church, Archdiocese of Santa Fe

My Commission expires

O Habaal

JOPAN DELL JOPAN RECIPCION DE MESSICE CARREST PRESENTANTE

TRACT A SOUTH SAN JOSE PARISH

A REPLAT OF TRACTS 50, 51 AND 52
MIDDLE RIO GRANDE PROPERTY MAP NO. 44
WITHIN SECTION 32, T.10N., R.3E., N.M.P.M.
ALBUQUERQUE, BERNALILLO COUNTY, NEW MEXICO

FEBRUARY 2008

PROJECT NUMBER: 1007062	
pplication Number: 08-70/27	· · · · · · · · · · · · · · · · · · ·
ity Approvals:	3-6-08
City Surveyor	Date
Traffic Engineering, Transportation Division	0ate 3-19-88
Christina Sanderal	3 19 08
Parks and Recreation Department Brudley 1. Burghan	3/19/08
Bradley J. Bizken	• 3 (19/08
City Engineer	3/19/08
DR8/Chairperson, Planning Department	Date


SURVEYOR'S CERTIFICATE

I, Thomas D. Johnston, licensed as a Professional Surveyor under the laws of the State of New Mexico, do hereby certify that this plat was prepared by me or under my supervision, that I am responsible for this plat, that it shows all easements of the recorded plat and made known to me by the title company, utility companies or by the owner of record, meets the minimum standards for monumentation and surveys of the Albuquerque Subdivision Ordinance, and meets the Minimum Standards for Land Surveys as adopted by the New Mexico State Board of Registration for Professional Engineers and Surveyors, effective May 1, 2007 and is true and correct to the heet of my knowledge and belief

Thomas D. Johnston, Nav.P.S. No. 14269

2.28.up



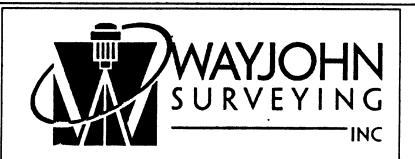

330 LOUISIANA BLVD., N.E. ALBUQUERQUE, N.M. 87108 PHONE: (505) 255-2052 FAX: (505) 255-2887

INDEXING INFORMATION FOR COUNTY

OWNER: ARCHOIOCESE OF SANTA FE LOCATION: SEC. 32 T.10 N., R.3 E., N.M.P.M. DRAWN: E W K

FILE NO. SP-1-02-2008

CHECKED: T D J

DRAWING NO.

SP10208.DWG

14 JAN 2000 FILE VE

APR 0 3 2008

...

· HYDROLOGY

DOCH 2008031828

| SECURITY CLERK RECORDING LAREL HERE
| SOUT | SCALE: 1 | INICH = 60 | FEET | SECURITY | SECU

(REC. S 83'02'35" E) S 82'46'39" E

R = 34.61' L = 69.91' Δ = 115'43'38" Ch N 37'50'20" E 58.61'_

> W B N 87'24'26" 109.96'

- UNRECORDED PARCEL

TRACT A SOUTH SAN JOSE PARISH

A REPLAT OF TRACTS 50, 51 AND 52
MIDDLE RIO GRANDE PROPERTY MAP NO. 44
WITHIN SECTION 32, T.10N., R.3E., N.M.P.M.
ALBUQUERQUE, BERNALILLO COUNTY, NEW MEXICO

MONUMENT LEGEND:

- A Set 1/2" Rebar, cap "WAYJOHN PS 14269"
- B Attached tag "WAYJOHN PS 14269" to chain link fence post

TRACT A

293,979 sq. ft. 6.7489 Ac.

TRACT 50

TRACT 51

TRACT 52


TRACT 1-A LANDS OF RAYCO


filed February 28, 2003; Bk. 2003C, p.45

707.07

- C Found chiseled mark on concrete
- D Found nail, no I.D.

N 88'10'17" W

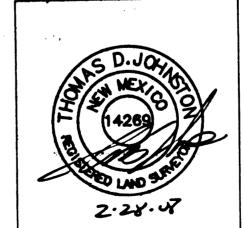

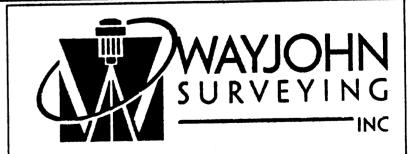

330 LOUISIANA BLVD., N.E. ALBUQUERQUE, N.M. 87108 PHONE: (505) 255-2052 FAX: (505) 255-2887

OWNER: ARCHDIOCESE OF SANTA FE LOCATION: SEC. 32 T.10 N., R.3 E., N.M.P.M.

 DRAWN:
 E W K
 SCALE:
 FILE NO.

 CHECKED:
 T D J
 1" = 60'
 SP-1-02-2008

 DRAWING NO.
 SP10208.DWG
 14 JAN 2008
 SHEET 2 OF 2