CITY OF ALBUQUERQUE

Planning Department Alan Varela, Director



Mayor Timothy M. Keller

June 5, 2023

Ian M. N. Anderson, P.E. Isaacson & Arfman, Inc. 128 Monroe St. NE Albuquerque, NM 87108

Re: MAS School Parking Lot 1717 Yale Blvd. SE Traffic Circulation Layout Engineer's Stamp 06-02-23 (L16-D044)

Dear Mr. Anderson,

The TCL submittal received 05-26-2023 is approved for Building Permit by Transportation. A copy of the stamped and signed plan will be needed for each of the building permit plans. Please keep the original to be used for certification of the site for final C.O. for Transportation.

PO Box 1293

When the site construction is completed and an inspection for Certificate of Occupancy (C.O.) is requested, use the original City stamped approved TCL for certification. Redline any minor changes and adjustments that were made in the field. A NM registered architect or engineer must stamp, sign, and date the certification TCL along with indicating that the development was built in "substantial compliance" with the TCL. Submit this certification, the TCL, and a completed <u>Drainage and Transportation Information Sheet</u> to the <u>PLNDRS@cabq.gov</u> for log in and evaluation by Transportation. **An approved work order is a condition of releasing the**

Albuquerque

NM 87103 **final CO**.

www.cabq.gov


Once verification of certification is completed and approved, notification will be made to Building Safety to issue Final C.O. To confirm that a final C.O. has been issued, call Building Safety at 924-3690.


Sincerely,

Ernest Armijo, P.E.

Principal Engineer, Planning Dept. Development Review Services

C: CO Clerk, File

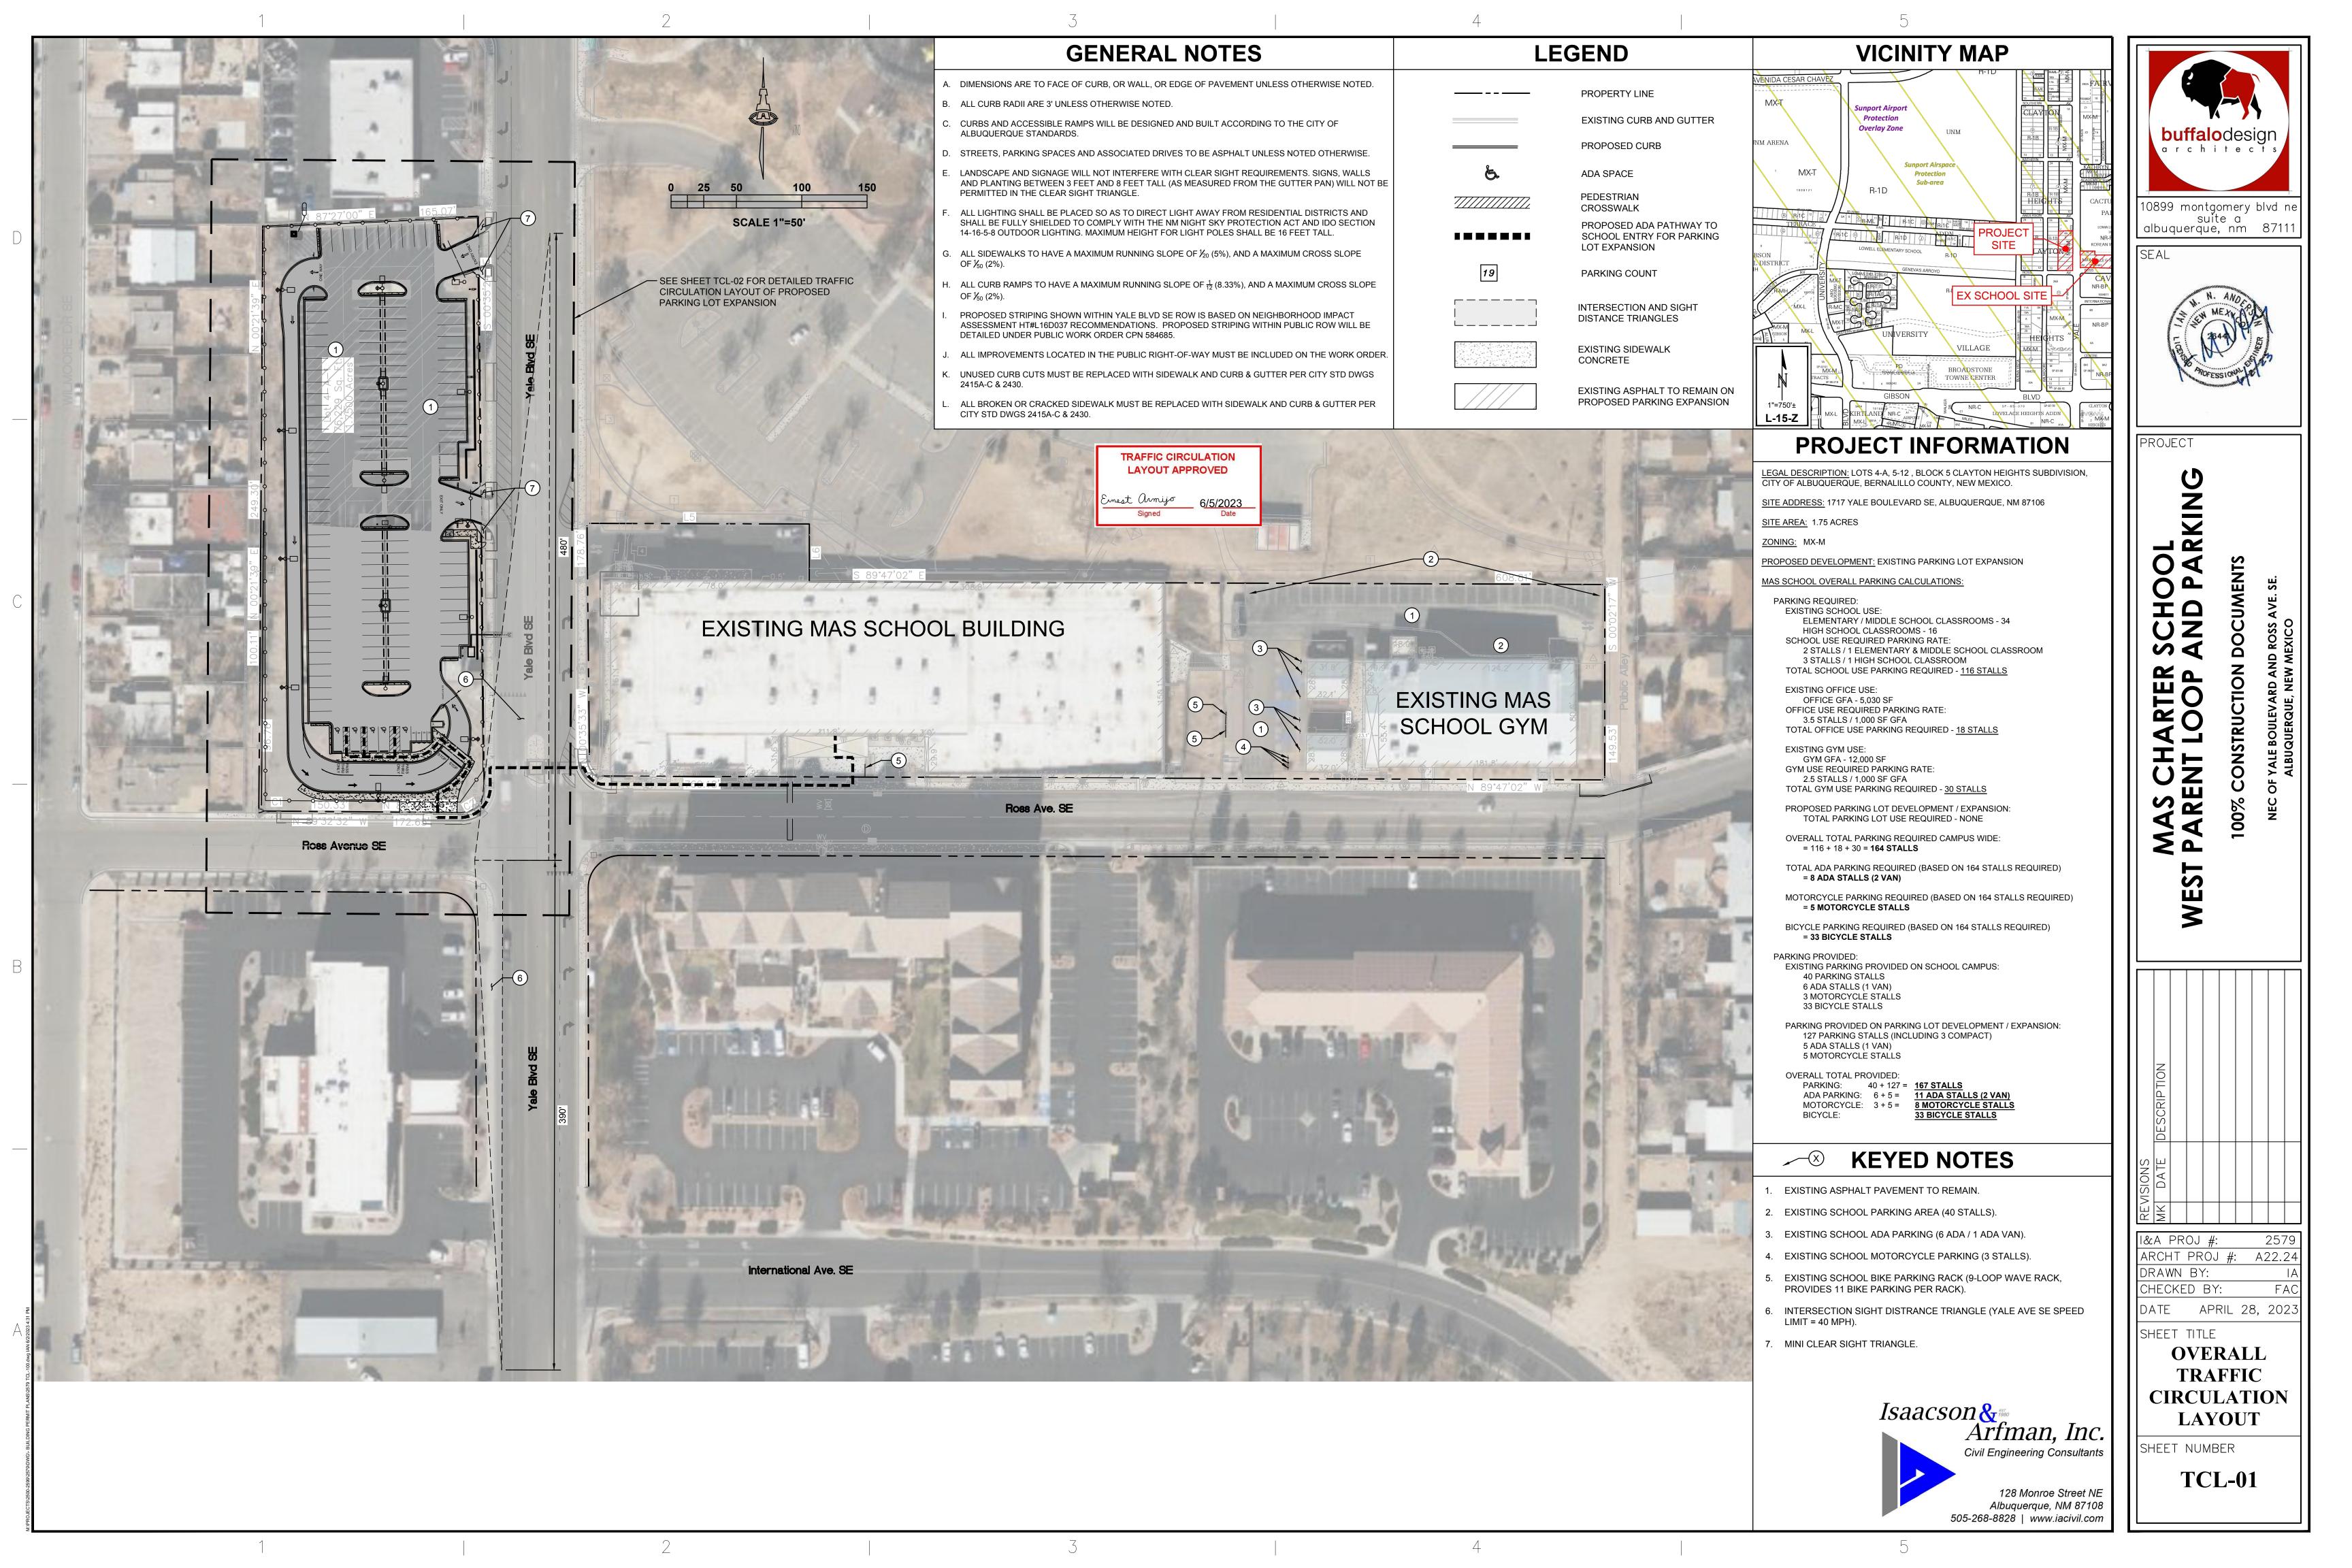

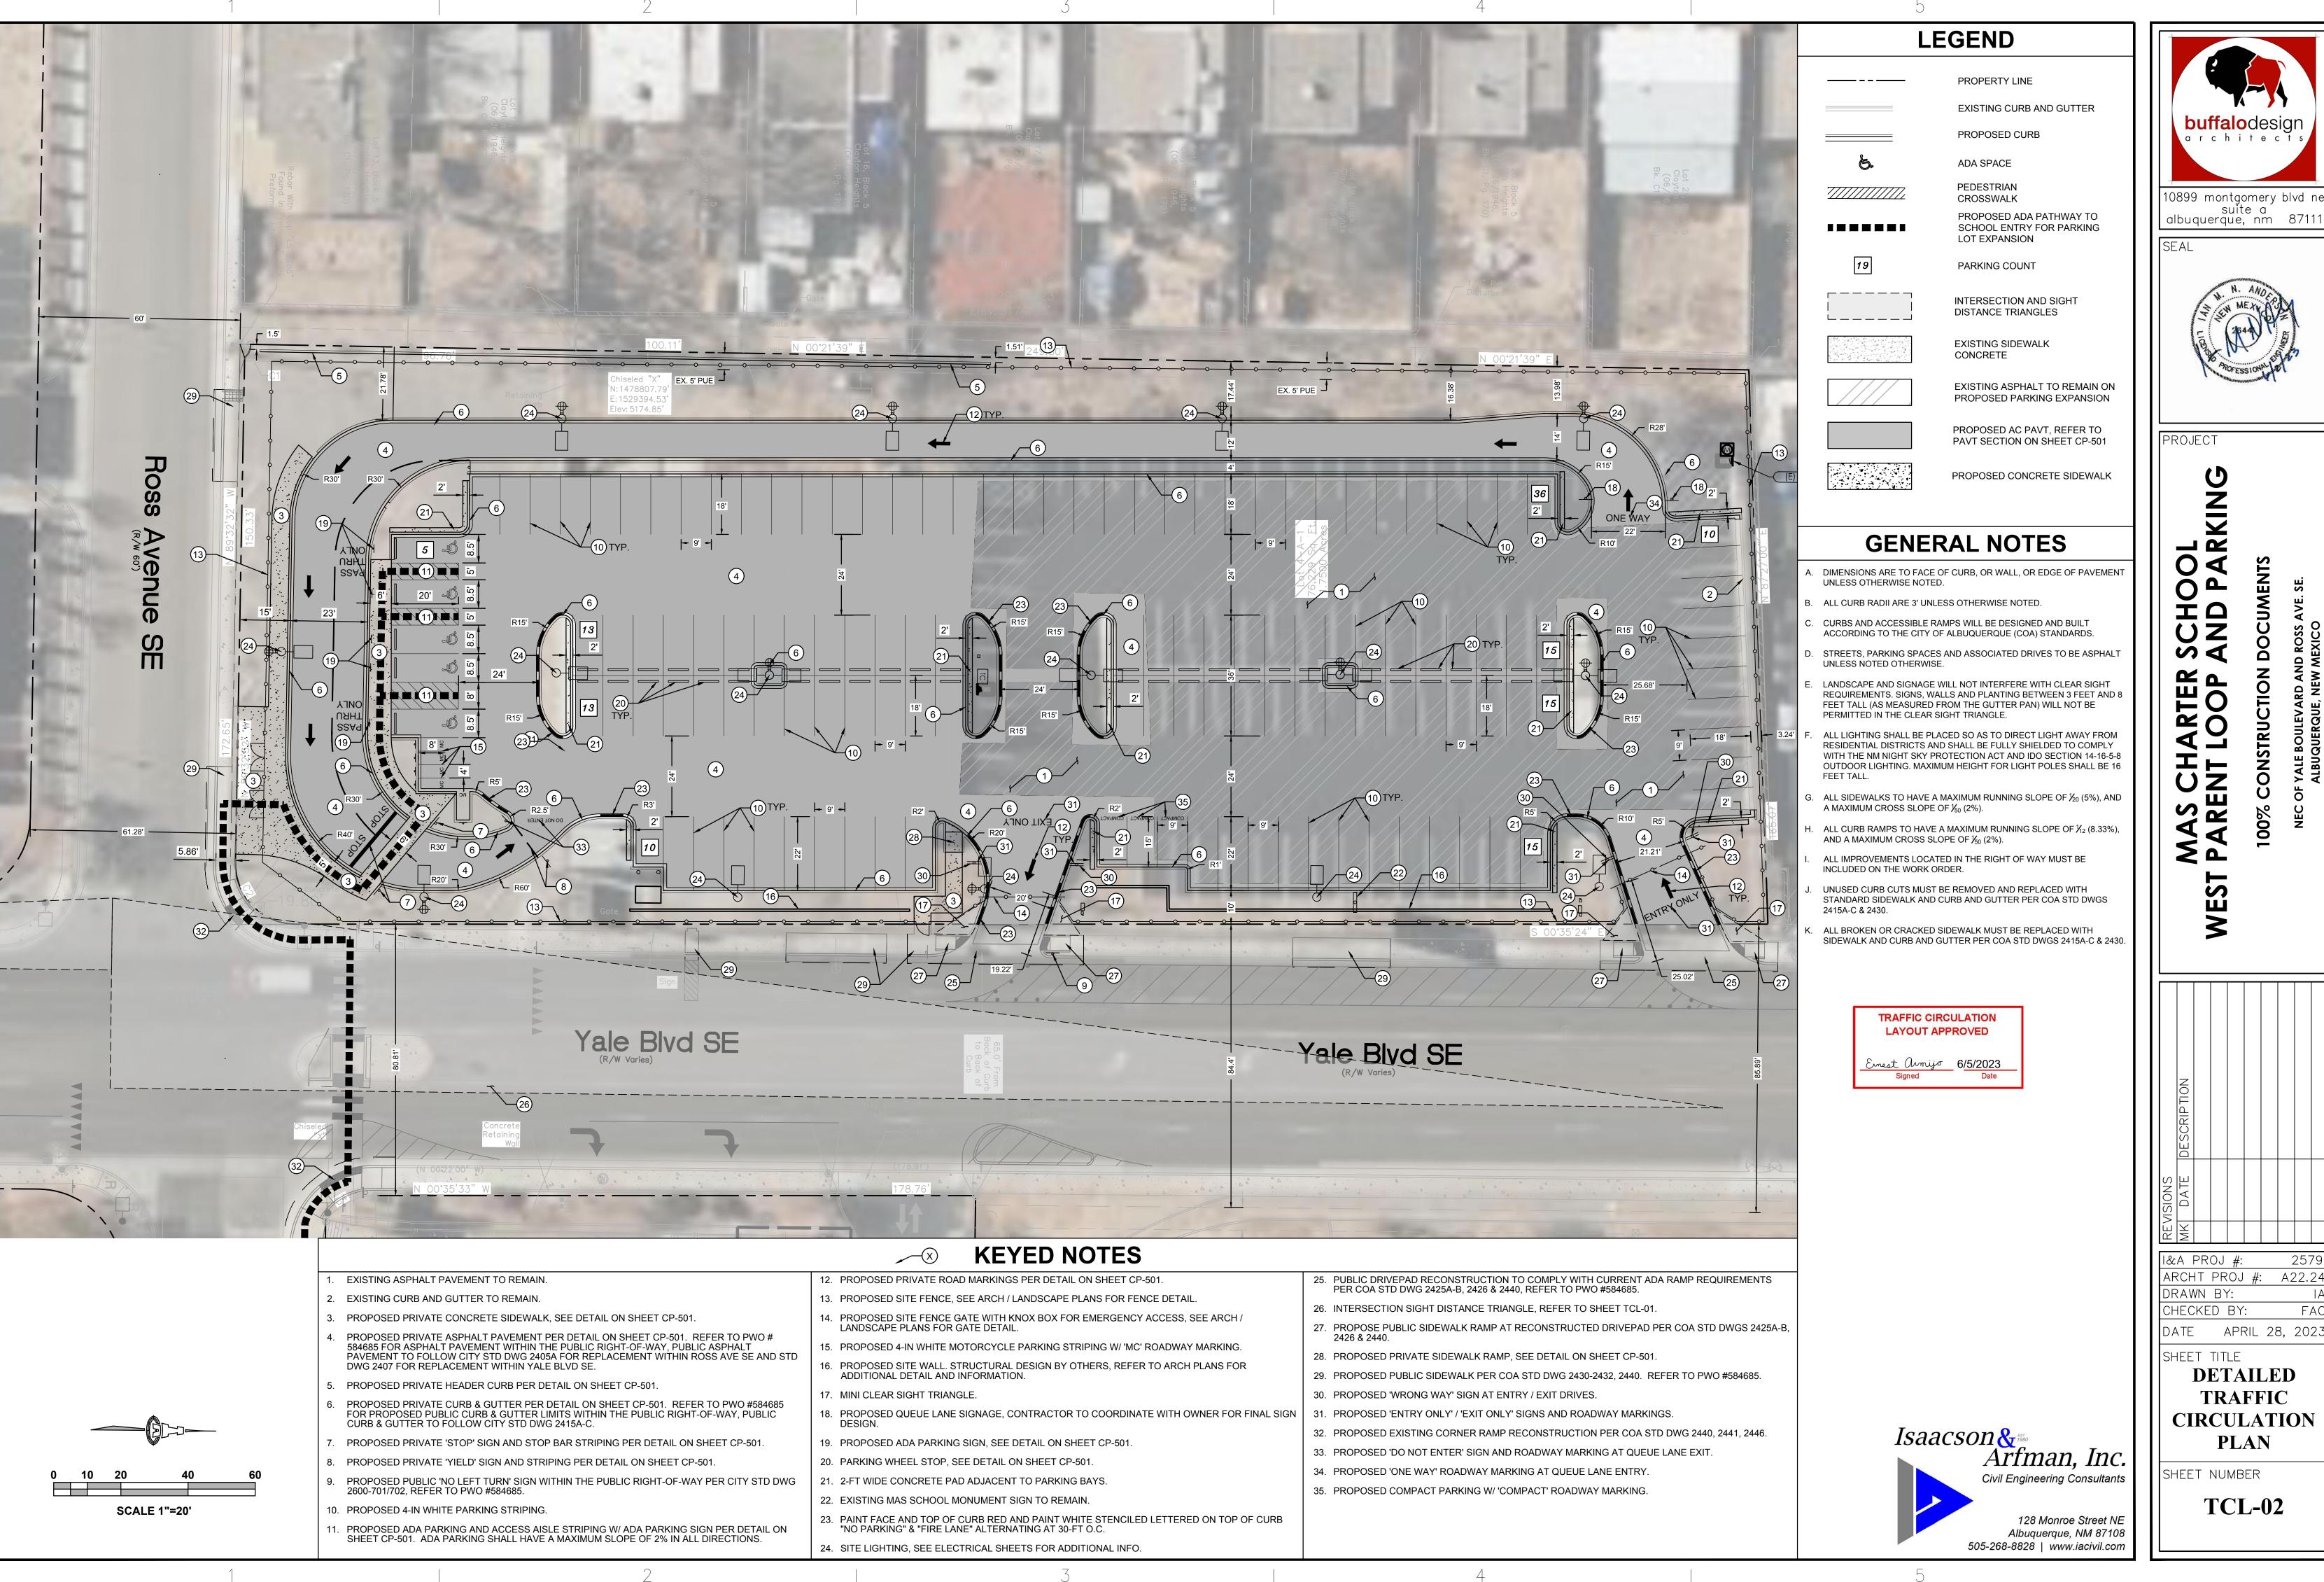


buffalodesign



A22.24

DETAILED

CIRCULATION

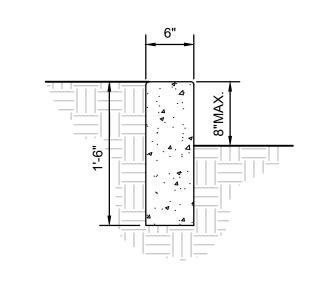

5'-0"


PAINTED TRAFFIC ARROW

GENERAL NOTES

- 1. CONTRACTION / CONTROL JOINTS @ 6' MAX.
- 2. 1/2" EXPANSION JOINTS 24' O.C.
- 3. REQUIRES FULL FORM ON ALL FACES.
- 4. 3/8" RADII AT ALL EXPOSED EDGES.

SCALE: N.T.S.

HEADER CURB

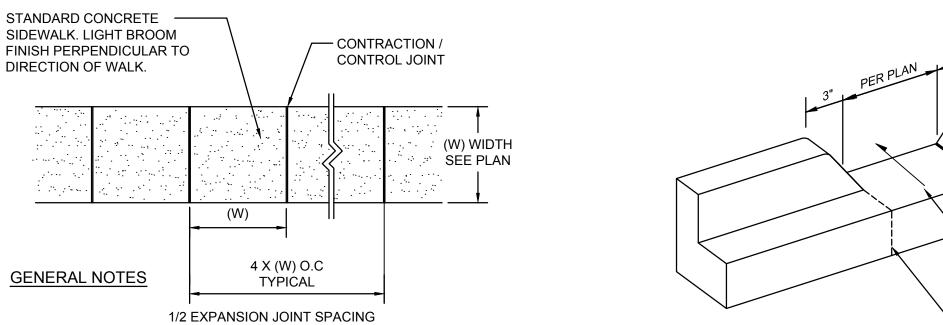

GENERAL NOTES

4000 PSI COMPRESSIVE STRENGTH CONCRETE

RESERVED-

PARKING

VOLATORS ARE SUBJECT TO A FINE AND/OR TOWING

VAN-

ACCESSIBLE

\$CALE: N.T.S

- 2. SEE CONCRETE JOINTS DETAIL
- FINISHED EDGE OF ASPHALT PAVING TO BE 1/2" ABOVE EDGE OF CONCRETE (TYP).
- 4. 3/8" RADII AT ALL EXPOSED EDGES.
- 5. MAXIMUM RUNNING SLOPE = 1/20 (5%), MAXIMUM CROSS SLOPE = 1/50 (2%).

- 12"X18" WHITE SIGN WITH

GREEN FRAME, GREEN TEXT,

WHITE ISA SYMBOL ON ADA

BLUE PER STATE / LOCAL

12"X6" WHITE SIGN WITH

GREEN FRAME, GREEN TEXT

WHERE INDICATED ON PLAN.

CODE.

1.5" O.D.

AWAY.

- 2-3/8" 0.D.

SLEEVE

- 8" X 2.0'

FOOTING

CONCRETE

STEEL PIPE

GALVANIZED STEEL PIPE

BREAKAWAY

GALVANIZED POST

COUPLER. CROWN

CONC. TO DRAIN

CONCRETE WALK

BROOM FINISH

SCALE: N.T.S.

PARKING

'STOP' SIGN

R1-1-30 R/W


RIGHT

TURN

ONLY

31-0460

'RIGHT TURN ONLY' SIGN

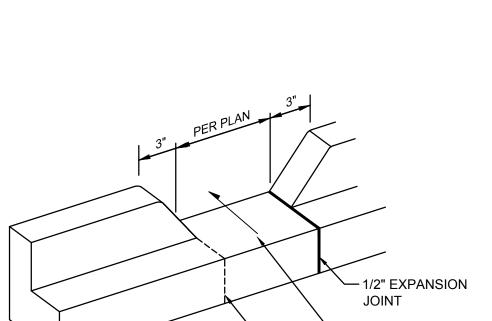

SCALE: N.T.S.

- SLOPE GUTTER TO - CONTROL JOINT

CURB OPENING

- 12"X18" WHITE SIGN WITH

GREEN FRAME, GREEN TEXT.

'SCHOOL CROSSWALK' SIGN

'YIELD' SIGN

NO LEFT TURN SIGNS

SCALE: N.T.S.

R3-1L & 31-0520

R1-2

SCALE: N.T.S.

PAINT 12" **LETTERS**

WHITE (SEE DETAIL THIS SHEET)

8.5' MIN.

5' AISLE

GENERAL NOTES

- 1. WHEEL STOPS TO BE PLACED 2' BACK, CENTERED IN THE PARKING STALL WHEEL STOPS CAN BE PAINTED IN A CONTRASTING COLOR SUCH AS GRAY, YELLOW OR BLACK.
- 2. BLUE SHALL BE USED FOR HANDICAP PARKING STALLS.
- 3. INSTALL EACH WITH TWO DOWELS PER MANUFACTURERS SPECIFICATIONS.

CONCRETE WHEEL STOP

SIDEWALK

STRIPES ADA

SCALE: N.T.S.

STRIPES ADA

– PAINT 12"

LETTERS WHITE (SEE

SHEET)

8' AISLE @ VAN

PARKING

OF STALL

PARKING

STALL


8.5' MIN.

DETAIL, THIS

— WIDTH VARIES RE: SITE PLAN (6' MIN. CONCRETE SIDEWALK — - MONOLITHIC CONCRETE HANDICAP RAMP INTEGRALLY COLORED DAVIS COLORS 160 "BRICK RED"; SMOOTH TEXTURE FINISH W/ 1/4" PROVIDE 5' SQUARE MINIMUM — DEEP X 1/4" WIDE GROOVES 2" O.C. LANDING, 2% MAX SLOPE IN ALL DIRECTIONS, AT TOP OF RAMP FOR CHANGE IN DIRECTION LANDSCAPE **EXPANSION JOINT -**- EXPANSION JOINT - PROVIDE ADA APPROVED **EXPANSION JOINT** TRUNCATED DOME STRIP 2' LANDSCAPE AREA IN WIDTH - 6" STANDUP CURB OR CURB & GUTTER AS APPLICABLE (SEE SITE PLAN) INSTALL 1" TOOLED RADIUS ON ALL EXPOSED EDGES


NOTE:
CURB RAMP SHALL NOT EXCEED 6" VERTICAL RISE. RAMP MAXIMUM RUNNING SLOPE = 1/12 (8.33%), RAMP MAXIMUM CROSS SLOPE = 1/50 (2%), AND SHALL CONFORM W/ ALL APPLICABLE ANSI REQ'S. G.C SHALL VERIFY CONFORMANCE W/ ALL APPLICABLE ANSI REQ'S.

CURBED RAMP DETAIL

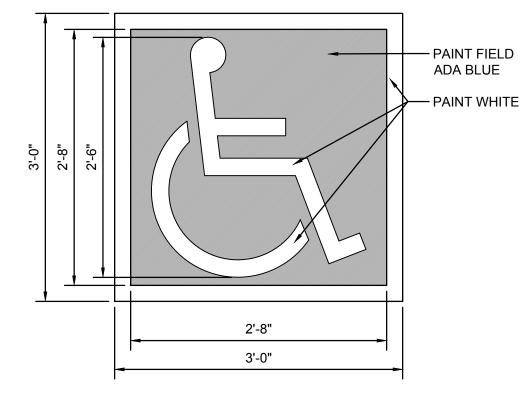

ACCESSIBILITY SYMBOL

SCALE: N.T.S.

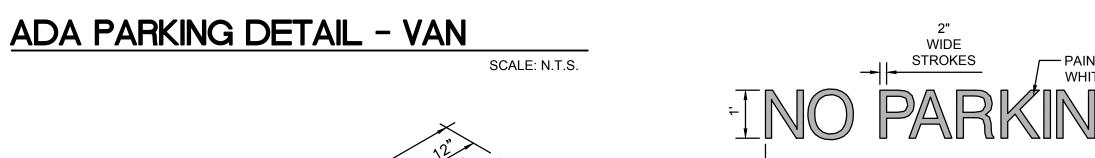




8-FT WIDE ACCESS AISLE

5-FT WIDE ACCESS AISLE

PAINTED 'NO PARKING'


SCALE: N.T.S.



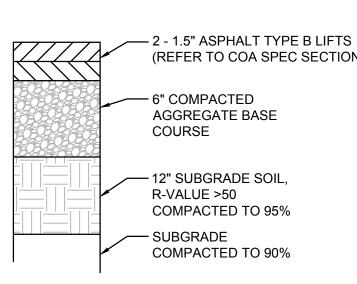

ASPHALT PAVING SECTION

SCALE: N.T.S.

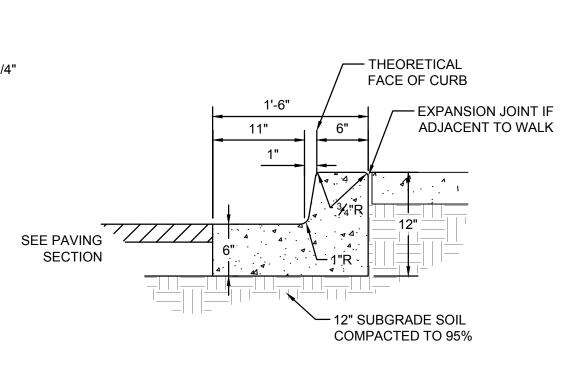

GENERAL NOTES

6" WIDE THEORETICAL FACE OF CURB


- 1. REQUIRES FULL FORM ON ALL FACES.
- 2. CONTRACTION / CONTROL JOINTS @ 6' O.C. MAX.
- 3. EXPANSION JOINTS @ 48' O.C., CURB RETURNS AND EACH SIDE OF
- 4. EDGES NOT SPECIFICALLY DIMENSIONED SHALL BE EDGED WITH A 3/8"

MEDIAN CURB AND GUTTER

SCALE: N.T.S.

Isaacson & Manan, Inc. Civil Engineering Consultants 128 Monroe Street NE Albuquerque, NM 87108 505-268-8828 | www.iacivil.com

10899 montgomery blvd n suite a albuquerque, nm 8711

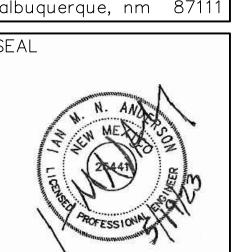

PROJECT OO PA

100 WEST

|I&A PROJ #: ARCHT PROJ #: A22.24 DRAWN BY: CHECKED BY: FAC APRIL 28, 2023

SHEET TITLE

PAVING

DETAILS

SHEET NUMBER

CP-501

SIGNAGE