


FEMA MAP

SCALE: 1"=500' REF. PANEL 354, 1996 REF. PANEL 35, 1983

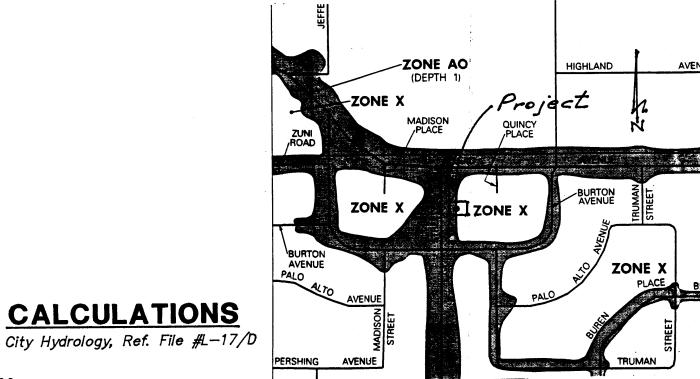

### I. DESIGN CRITERIA

HYDROLOGIC METHODS PER SECTION 22.2, HYDROLOGY, OF THE DEVELOPMENT PROCESS MANUAL (DPM), REVISED JANUARY 1993 FOR THE CITY OF ALBUQUERQUE AND ADOPTED BY THE COUNTY OF BERNALILLO. DISCHARGE RATE: Q = Qpeak x AREA..."PEAK DISCHARGE RATES FOR SMALL WATERSHEDS" VOLUMETRIC DISCHARGE: VOLUME = Eweighted x AREA SOIL TYPE: 'B', Etc, EMBUDO SERIES, A GRAVELLY FINE SANDY LOAM AS CLASSIFIED BY THE SCS SOIL SURVEY P100 = 2.35 INCHES, ZONE 2 TIME OF CONCENTRATION, TC = 10 MINUTES DESIGN STORM: 100-year/6-hour, 10-year/6-hour WHERE [ ] = 10 year VALUES

### II. EXISTING CONDITIONS

STUDY AREA = 0.16 ACRES, WHERE EXCESS PRECIPITATION 'C' = 1.13 IN. [0.52] PEAK DISCHARGE, Q100 = 0.50 CFS [0.3 CFS], WHERE UNIT PEAK DISCHARGE 'C' = 3.1 CFS/ACRE [1.7] THEREFORE: VOLUME100 = 656 C.F. [302 C.F.]

### III. DEVELOPED CONDITIONS

DETERMINE LAND TREATMENTS, PEAK DISCHARGE & WEIGHTED EXCESS PRECIPITATION

UNDEVELOPED, 0 AC.(0%) A 1.56[0.38] 0.53[0.13]
LANDSCAPING, 0.01 AC.(6%) B 2.28[0.95] 0.78[0.28]
GRAVEL & COMPACTED SOIL 0.02 AC.(13%) C 3.14[1.71] 1.13[0.52]
ROOF/PAVEMENT, 0.13 AC.(83%) D 4.70[3.14] 2.12[1.34]

Eweighted = 1.9 IN.  $\begin{bmatrix} 1.2 \end{bmatrix}$ Q100 = 0.70 CUBIC FEET PER SECOND (CFS) Q10 = 0.45 CFS; VOL.100 = 1103 CUBIC FEET (CF), VOL.10 = 680 C.F.

## GRADING & DRAINAGE PLAN <u>LEGEND</u>

SITE DATA:

THE EXISTING SITE IS CURRENTLY A "HARD PAN" DIRT UNDEVELOPED LOT, AND ZONED.

C-1, FOR COMMERCIAL USE. THE PROJECT IS LOCATED IN A AN IN-FILL AREA AND ALL

ADJOINING PROPERTY IS DEVELOPED. MONROE STREET IS LOCATED ON THE WEST AND IS

CLASSIFIED AS AN MINOR COLLECTOR WITH CURB/GUTTER AND SIDEWALK. THE ROADWAY

IS 40 FEET WIDE AND SITUATED WITHIN A 60' RIGHT-OF-WAY.

AN EXISTING 25 FEET WIDE GRAVEL SURFACED ALLEY IS THE EAST ADJOINER.

EXISTING DRAINAGE CONDITIONS: HISTORIC RUN-OFF HAS ESSENTIALLY SHEET FLOWED ACROSS
THE SITE WITH A PORTION EXITING TO THE WEST AND THE REMAINING DRAINING TO THE EAST ALLEY.
THE PROPERTY IS IMPACTED BY A FEMA DESIGNATED FLOODPLAIN (ZONE AO 1').
TH FLOOD PLAIN IS WITHIN MONROE STREET AND EXTENDS INTO THE PROPERTY APPROXIMATELY 35 FEET.

NOTE: NO OFF-SITE DRAINAGE IMPACTS THE SITE.

PROPOSED IMPROVEMENTS: CONSIST OF A 2646 S.F., SINGLE STORY COMMERCIAL BUILDING, ASPHALT PAVING, CONCRETE DRIVEWAY ENTRANCE, GRAVEL SURFACING, AND NATIVE VEGETATION LANDSCAPING AREAS. THE EXISTING GRAVEL ALLEY WILL BE CONSTRUCTED TO CITY STANDARDS AND BE PAVED.

PROPOSED DRAINAGE CONDITIONS: DISCHARGE OF RUN-OFF THROUGH THE PROPOSED DRIVEPAD, IN ADDITION TO ROUTING ROOF & REAR LOT RUNOFF TO THE PROPOSED PAVED ALLEY.

FREE DISCHARGE OF SITE RUNOFF IS ALLOWED SINCE THE INCREASE OF DEVELOPED FLOW IS MINIMAL.

EXIST. SPOT ELEV. +92.5

EXIST. CONTOUR — 08

NEW SPOT ELEV. 10.10 \$\infty\$

NEW CONTOUR

NEW CONCRETE

TOP OF CURB TC, tc
FLOW LINE FL, fl

EXIST. POWER POLE

SWALE

DRAINAGE FLOW

VICINITY MAP ZONE L-17

SCALE: 1"=750'

## NOTES:

Highland H.S.

All Work Within the Right—of—Way Shall Be Constructed In Accordance With the City of Albuquerque Standard Specs. For Public Works Construction, Latest Edition.


- 1. AN EXCAVATION/CONSTRUCTION PERMIT WILL BE REQUIRED BEFORE BEGINNING ANY WORK WITHIN CITY R.O.W. AN APPROVED COPY OF THIS PLAN MUST BE SUBMITTED AT THE TIME of APPLICATION.
- 2. ALL WORK PERFORMED ON THIS PROJECT SHALL BE PER— FORMED IN ACCORDANCE WITH APPLICABLE FEDERAL, STATE AND LOCAL LAWS, RULES AND REGULATIONS CONCERNING CONSTRUCTION SAFETY AND HEALTH.
- 3. CONTRACTOR SHALL MAINTAIN ACCESS TO ADJACENT PROPERTIES DURING CONSTRUCTION.
- 4. ALL UTILITIES AND UTILITY SERVICE LINES SHALL BE INSTALLED PRIOR TO THE CONSTRUCTION OF PAVING.
- 5. FRONT YARD DEPRESSED LANDSCAPED AREAS SHALL BE SOFT—LINED WITH NATIVE VEGETATION AND OR GRAVEL, NO DEVELOPED RUNOFF PERMITTED TO DRAIN TO THESE AREAS. ASPHALT PARKING AREA SHALL DRAIN DIRECTLY TO MONROE ST.
- 6. CONTRACTOR SHALL ENSURE THAT NO SITE SOILS/SEDIMENT OR SILT ENTER THE RIGHT—OF WAY DURING CONSTRUCTION

BLK. B PARKLAND HILLS YALLA **DEPRESSED** LANDSCAPE AREA (See Note 5.) jo. \_\_\_\_1.0% . \_\_\_\_ . . . \_\_\_ . SCALE: 1"=10' FIN. FLR. ELEV. 52<del>52.6</del> 52.58 Q<sub>DEV</sub>=0.2 CFS ROOF DRNG. Construct Residential Alley Asphalt Pavement Section per COA St'd. └─Remove Existing Drawings #2411, 2415 & 2428. (185 l.f. to Zuni Street) SEE Plan & Profile, City Project Header Curb-**GRAVEL** Bot. El. = 51.4 (0.5' Depth±) PROJECT BENCHMARK TC51.20 Construct Flush 6" P.C.C. Top of Curb / Slash Pipe/Nail EXISTING STRUCTURE APPROX. FEMA FLOOD PLAIN BDRY DEPRESSED -LANDSCAPE AREA अत्राप्त व भ्रमप्रत्रमण भारत्व (See Note 5.

As Constructed

I, PHILIP W. CLARK, PROFESSIONAL ENGINEER, REGISTERED IN ACCORDANCE WITH THE LAWS IN THE STATE OF NEW MEXICO, DO HEREBY CERTIFY THAT THE GRADING AND DRAINAGE IMPROVEMENTS SHOWN ON THIS PLAN ARE IN SUBSTANTIAL COMPLIANCE WITH THE APPROVED PLAN.

PHILIP W. CLARK, P.E. #10265

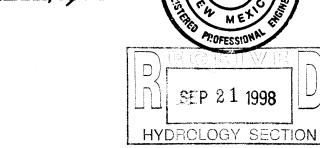

## PROJECT INFORMATION

LEGAL DESCRIPTION: LOTS 5, 6 & 7, BLOCK B, PARKLAND HILLS IN CITY OF ALBUQUERQUE, NEW MEXICO BERNALILLO COUNTY

PROPERTY ADDRESS: MONROE STREET, Southeast ALBUQUERQUE, NM 87108

PROJECT BENCHMARK: TOP OF CURB OF THE PROJECTION OF THE SOUTHWEST PROPERTY CORNER, AS TIED FROM ACS ALUM.

CAP MARKED 13-L17 SET IN DRILL HOLE FLUSH WITH THE TOP OF CURB LOCATED AT THE EAST, SOUTHEAST CURB RETURN AT MADISON PLACE AND ZUNI RD.

Clark Consulting Engineers

19 Ryan Road Edgewood, New Mexico 87015
(505) 281-2444 FAX (505) 281-2444

DATE REVISION LOT 5-A, BLOCK B, PARKLAND HILLS

6/4/98 Reconfig. PKg, STELLA BLANCO - THE SHADY LADY STORE

Atley per int

Affley pavimit Grading &

Drainage Plan

DESIGNED BY: PWC DRAWN BY: CCE JOB NO: PLIMPT\_STO

CHECKED BY: PWC DATE: 3/17/98 FILE No: G/D . SHEET!

PHILIP W. CLARK NMPE #10265


WERE DETERMINED.

ILIP W. CLARK NMPE #10265

I, PHILIP W. CLARK, A PROFESSIONAL ENGINEER LICENSED IN ACCORDANCE WITH THE LAWS OF THE STATE

OF NEW MEXICO, DO HEREBY CERTIFY THAT I HAVE VISITED THE SITE SHOWN HEREON, AND THAT THE CONTOURS

SHOWN REPRESENT THE EXISTING GROUND CONDITIONS, AND DO FURTHER CERTIFY THAT NO EARTHWORK OF ANY KIND, NOR ANY DISTURBANCE OF THE EXISTING FROUND HAS OCCURRED ON THIS SITE SINCE THE CONTOURS

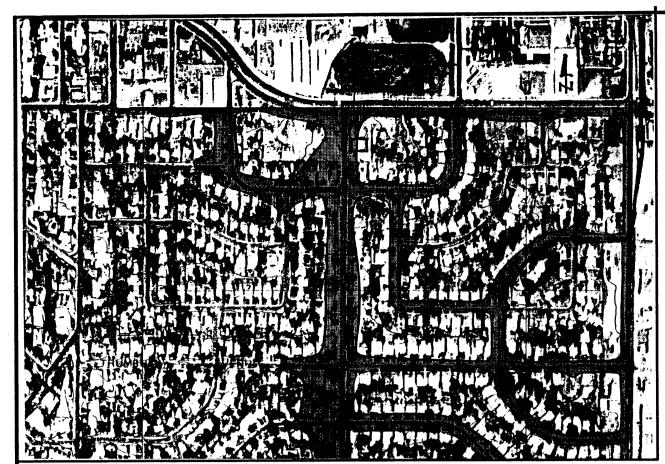

### FEMA MAP

SCALE: 1"=500' REF. PANEL 354, 1996 REF. PANEL 35, 1983

## GRADING & DRAINAGE PLAN

SITE DATA: THE EXISTING SITE IS CURRENTLY A "HARD PAN" DIRT UNDEVELOPED LOT, AND ZONED. C-1, FOR COMMERCIAL USE. THE PROJECT IS LOCATED IN A AN IN-FILL AREA AND ALL ADJOINING PROPERTY IS DEVELOPED. MONROE STREET IS LOCATED ON THE WEST AND IS CLASSIFIED AS AN MINOR COLLECTOR WITH CURB/GUTTER AND SIDEWALK. THE ROADWAY IS 40 FEET WIDE AND SITUATED WITHIN A 60' RIGHT-OF-WAY. AN EXISTING 25 FEET WIDE GRAVEL SURFACED ALLEY IS THE EAST ADJOINER.

EXISTING DRAINAGE CONDITIONS: HISTORIC RUN-OFF HAS ESSENTIALLY SHEET FLOWED ACROSS THE SITE WITH A PORTION EXITING TO THE WEST AND THE REMAINING DRAINING TO THE EAST ALLEY. THE PROPERTY IS IMPACTED BY A FEMA DESIGNATED FLOODPLAIN (ZONE AO 1'), AND AS A RESULT NO DOWNSTREAM CAPACITY EXISTS TO HANDLE THE DEVELOPED FLOWS. THE FLOODPLAIN IS WITHIN IMPROVED MONROE STREET AND EXTENDS INTO THE PROPERTY APPROXIMATELY 40 FEET.

PROPOSED IMPROVEMENTS: CONSIST OF A 2646 S.F., SINGLE STORY COMMERCIAL BUILDING, ASPHALT PAVING, CONCRETE DRIVEWAY ENTRANCE, GRAVEL SURFACING, AND NATIVE VEGETATION LANDSCAPING AREAS.

PROPOSED DRAINAGE CONDITIONS: DISCHARGE OF RUN-OFF THROUGH THE PROPOSED DRIVEPAD, IN ADDITION TO ROUTING EXCESS, DEVELOPED RUNOFF TO DEPRESSED LANDSCAPING AREAS.

See Section A-A

LOT

€ Note #5

NOTE: EMERGENCY SPILLWAY IS TO MONROE STREET

SHALLOW PONDING / LANDSCAPE AREA

VOLProv. = 134 c.f.

WERE DETERMINED.


## LEGEND


EXIST. SPOT ELEV. +92.5 EXIST. CONTOUR NEW SPOT ELEV. 10.10 NEW CONTOUR NEW CONCRETE TOP OF CURB FLOW LINE EXIST. POWER POLE

O Power Pole

SCALE: 1"=10"

DRAINAGE FLOW APPROX FEMA FLOOD PLAIN BORY

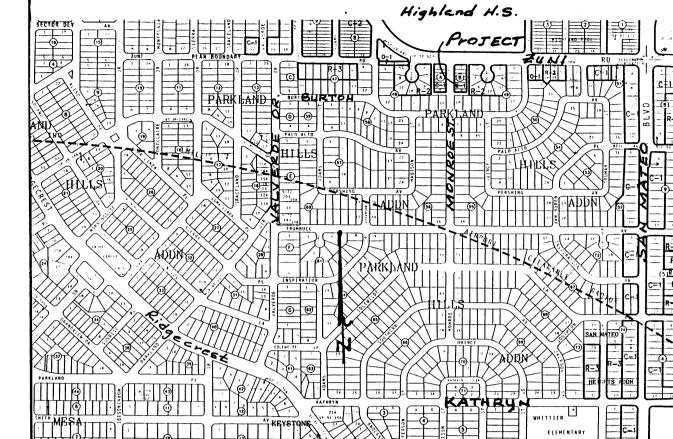

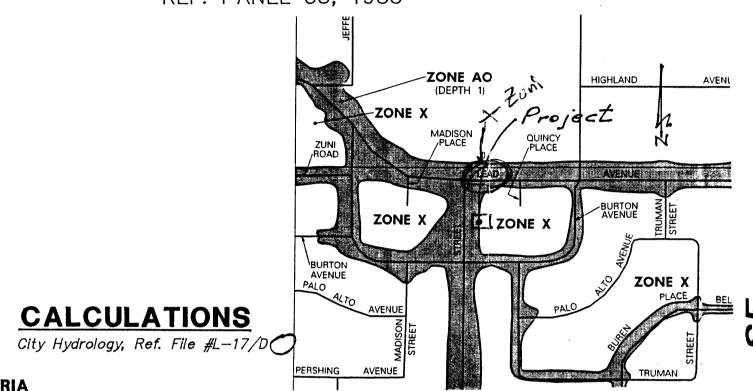

### I. DESIGN CRITERIA

HYDROLOGIC METHODS PER SECTION 22.2, HYDROLOGY, OF THE DEVELOPMENT PROCESS MANUAL (DPM), REVISED JANUARY 1993 FOR THE CITY OF ALBUQUERQUE AND ADOPTED BY THE COUNTY OF BERNALI'LLO. DISCHARGE RATE: Q = Qpeak x AREA..."PEAK DISCHARGE RATES FOR SMALL WATERSHEDS" VOLUMETRIC DISCHARGE: VOLUME = Eweighted x AREA SOIL TYPE: 'B', Etc, EMBUDO SERIES, A GRAVELLY FINE SANDY LOAM AS CLASSIFIED BY THE SCS SOIL SURVEY P100 = 2.35 INCHES, ZONE 2 TIME OF CONCENTRATION, TC = 10 MINUTES

P100 = 2.35 INCHES, ZONE 2 TIME OF CONCENTRATION, TC = 10 MINUTES

DESIGN STORM: 100-year/6-hour, 10-year/6-hour WHERE [ ] = 10 year VALUES

## . EXISTING CONDITIONS

STUDY AREA = 0.16 ACRES, WHERE EXCESS PRECIPITATION 'C' = 1.13 IN. [0.52] PEAK DISCHARGE, Q100 = 0.50 CFS [0.3 CFS], WHERE UNIT PEAK DISCHARGE 'C' = 3.1 CFS/ACRE [1.7] THEREFORE: VOLUME100 = 656 C.F. [302 C.F.]

### III. DEVELOPED CONDITIONS


DETERMINE LAND TREATMENTS, PEAK DISCHARGE & WEIGHTED EXCESS PRECIPITATION

UNDEVELOPED, LANDSCAPING. 0.02 AC.(13%) GRAVEL & COMPACTED SOIL 0.04 AC. (24%) 0.10 AC.(63%) 0.16 ACRES ROOF/PAVEMENT,

Eweighted = 1.7 IN. [1.0]Q100 = 0.64 CUBIC FEET PER SECOND (CFS) Q10 = 0.4 CFS; VOL.100 = 987 CUBIC FEET (CF), VOL.10 = 580 C.F.

### IV. DETENTION POND DESIGN

(SEE SUPPLEMENTAL CALCULATIONS ON FILE WITH CITY HYDROLOGY, 1417/1

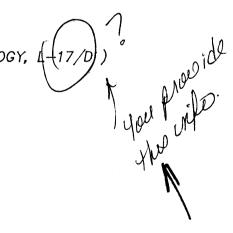

0.53[0.13] 0.78[0.28] 1.13[0.52] 2.12[1.34]

*52.1* (Set 2' min. above highest Adjacent Flowline of Monroe St.) TENG GREAT त्र ROOF DRNG. -Remove Exist**i**ng Fence See Section A-A Note # 5 Fnd. Iron Pipe/Nail APPROX. FEMA EXISTING STRUCTURE FLOOD PLAIN BDRY SHALLOW PONDING / LANDSCAPE AREA TOL 3 3FK' 3 5Y3KFYJO IIIFF3  $VOL_{Prov.} = 120 \text{ c.f.}$ NOTE: EMERGENCY SPILLWAY IS TO MONROE STREET Ona homa -Accass officillay

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KIND, NOR ANY DISTURBANCE OF THE EXISTING GROUND HAS OCCURRED ON THIS SITE SINCE THE CONTOURS

TOL 4 3FX' 3 5Y9XFYND HIFF2

APPROX FEMA

5A

# PROJECT INFORMATION

LEGAL DESCRIPTION: LOTS 5, 6 & 7, BLOCK B, PARKLAND HILLS IN CITY OF ALBUQUERQUE, NEW MEXICO BERNALILLO COUNTY

PROJECT BENCHMARK: TOP OF CURB OF THE PROJECTION OF THE SOUTHWEST PROPERTY CORNER, AS TIED FROM ACS ALUM. CAP MARKED 13-L17 SET IN DRILL HOLE FLUSH WITH THE TOP OF CURB LOCATED AT THE EAST, SOUTHEAST CURB RETURN AT MADISON PLACE AND ZUNI RD.

VICINITY MAP ZONE L-17 SCALE: 1"=750'

## NOTES:

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- PROPERTIES DURING CONSTRUCTION. 4. ALL UTILITIES AND UTILITY SERVICE LINES SHALL BE INSTALLED PRIOR TO THE CONSTRUCTION OF PAVING.
- 75. FRONT YARD PONDING AREAS SHALL BE SOFT—LINED WITH NATIVE VEGETATION AND OR GRAVEL. NO MIL PLASTIC WILL BE PERMITTED. IN ORDER TO ENSURE PERVIOUS NATURE AND DESIGN INTENT TO ALLOW PERCOLATION OF RUNOFF.
- 6. CONTRACTOR SHALL ENSURE THAT NO SITE SOILS/SEDIMENT OR SILT ENTER THE RIGHT-OF WAY DURING CONSTRUCTION



SECTION A-A


no scale

ALBUQUERQUE, NM 87108

PROPERTY ADDRESS: (MONROE STREET, Southeast


Clark Consulting Engineers 19 Ryan Road Edgewood, New Mexico 87015 (505) 281-2444 FAX (505) 281-2444 REVISION | LOT 5-A, BLOCK B, PARKLAND HILLS STELLA BLANCO - THE SHADY LADY STORE Grading & Drainage Plan

DESIGNED BY: PWC DRAWN BY: CCE JOB No: PLIMPT\_STO CHECKED BY: PWC DATE: 3/17/98 FILE Not G/D

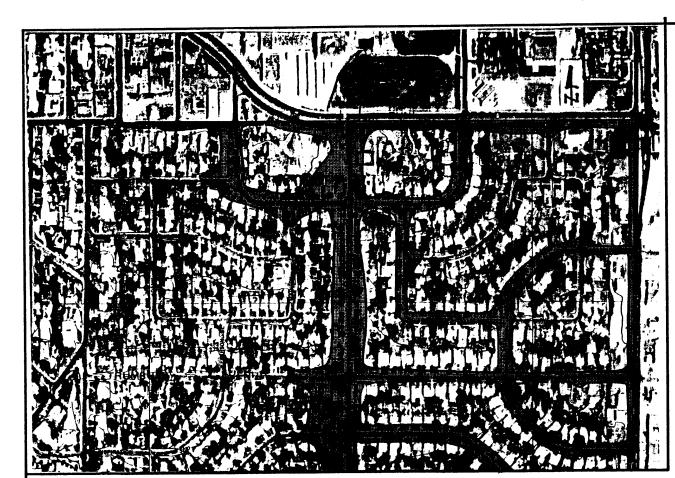

FEMA MAP

SCALE: 1"=500' REF. PANEL 354, 1996 REF. PANEL 35, 1983

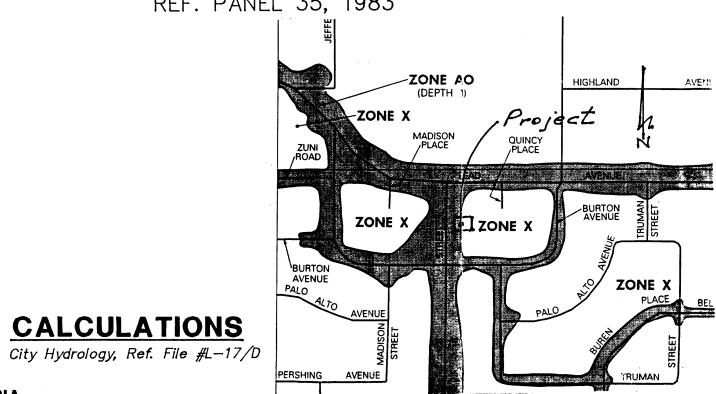

### I. DESIGN CRITERIA

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### **II. EXISTING CONDITIONS**

STUDY AREA = 0.16 ACRES, WHERE EXCESS PRECIPITATION 'C' = 1.13 IN. [0.52] PEAK DISCHARGE, Q100 = 0.50 CFS [0.3 CFS], WHERE UNIT PEAK DISCHARGE 'C' = 3.1 CFS/ACRE [1.7] THEREFORE: VOLUME100 = 656 C.F. [302 C.F.]

CALCULATIONS

### III. DEVELOPED CONDITIONS

DETERMINE LAND TREATMENTS. PEAK DISCHARGE & WEIGHTED EXCESS PRECIPITATION

	AREA	LAND TREATMENT	UNIT PEAK DISCHARGE	<u>'E'</u>
UNDEVELOPED,	0 AC.(0%)	Α	1.56[0.38]	0.53[0.13]
LANDSCAPING.	0.01 AC.(6%)	В	2.28[0.95]	0.78 0.28
GRAVEL & COMPACTED SOIL		С	3.14[1.71]	1.13[0.52
ROOF/PAVEMENT,	0.13 AC.(83%)	D	4.70[3.14]	2.12[1.34
•	0.16 ACRES		- <del>-</del>	

Eweighted = 1.9 IN. [1.2]Q1000 = 0.70 CUBIC FEET PER SECOND (CFS) Q10 = 0.45 CFS; VOL.100 = 1103 CUBIC FEET (CF), VOL.10 = 680 C.F.

## GRADING & DRAINAGE PLAN

SITE DATA: THE EXISTING SITE IS CURRENTLY A "HARD PAN" DIRT UNDEVELOPED LOT, AND ZONED. C-1, FOR COMMERCIAL USE. THE PROJECT IS LOCATED IN A AN IN-FILL AREA AND ALL ADJOINING PROPERTY IS DEVELOPED. MONROE STREET IS LOCATED ON THE WEST AND IS CLASSIFIED AS AN MINOR COLLECTOR WITH CURB/GUTTER AND SIDEWALK. THE ROADWAY IS 40 FEET WIDE AND SITUATED WITHIN A 60' RIGHT—OF—WAY. AN EXISTING 25 FEET WIDE GRAVEL SURFACED ALLEY IS THE EAST ADJOINER.

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#### NOTE: NO OFF-SITE DRAINAGE IMPACTS THE SITE.

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PROPOSED DRAINAGE CONDITIONS: DISCHARGE OF RUN-OFF THROUGH THE PROPOSED DRIVEPAD, IN ADDITION TO ROUTING ROOF & REAR LOT RUNOFF TO THE PROPOSED PAVED ALLEY. FREE DISCHARGE OF SITE RUNOFF IS ALLOWED SINCE THE INCREASE OF DEVELOPED FLOW IS MINIMAL.

## LEGEND

EXIST. SPOT ELEV. EXIST. CONTOUR NEW SPOT ELEV. NEW CONTOUR NEW CONCRETE

TC, tc TOP OF CURB FLOW LINE

EXIST. POWER POLE *P.P.* • SWALE DRAINAGE FLOW

VICINITY MAP ZONE L-17


SCALE: 1"=750'

## NOTES:


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### PROJECT INFORMATION

LEGAL DESCRIPTION: LOTS 5, 6 & 7, BLOCK B, PARKLAND HILLS IN CITY OF ALBUQUERQUE, NEW MEXICO BERNALILLO COUNTY

PROPERTY ADDRESS: MONROE STREET, Southeast ALBUQUERQUE, NM 87108

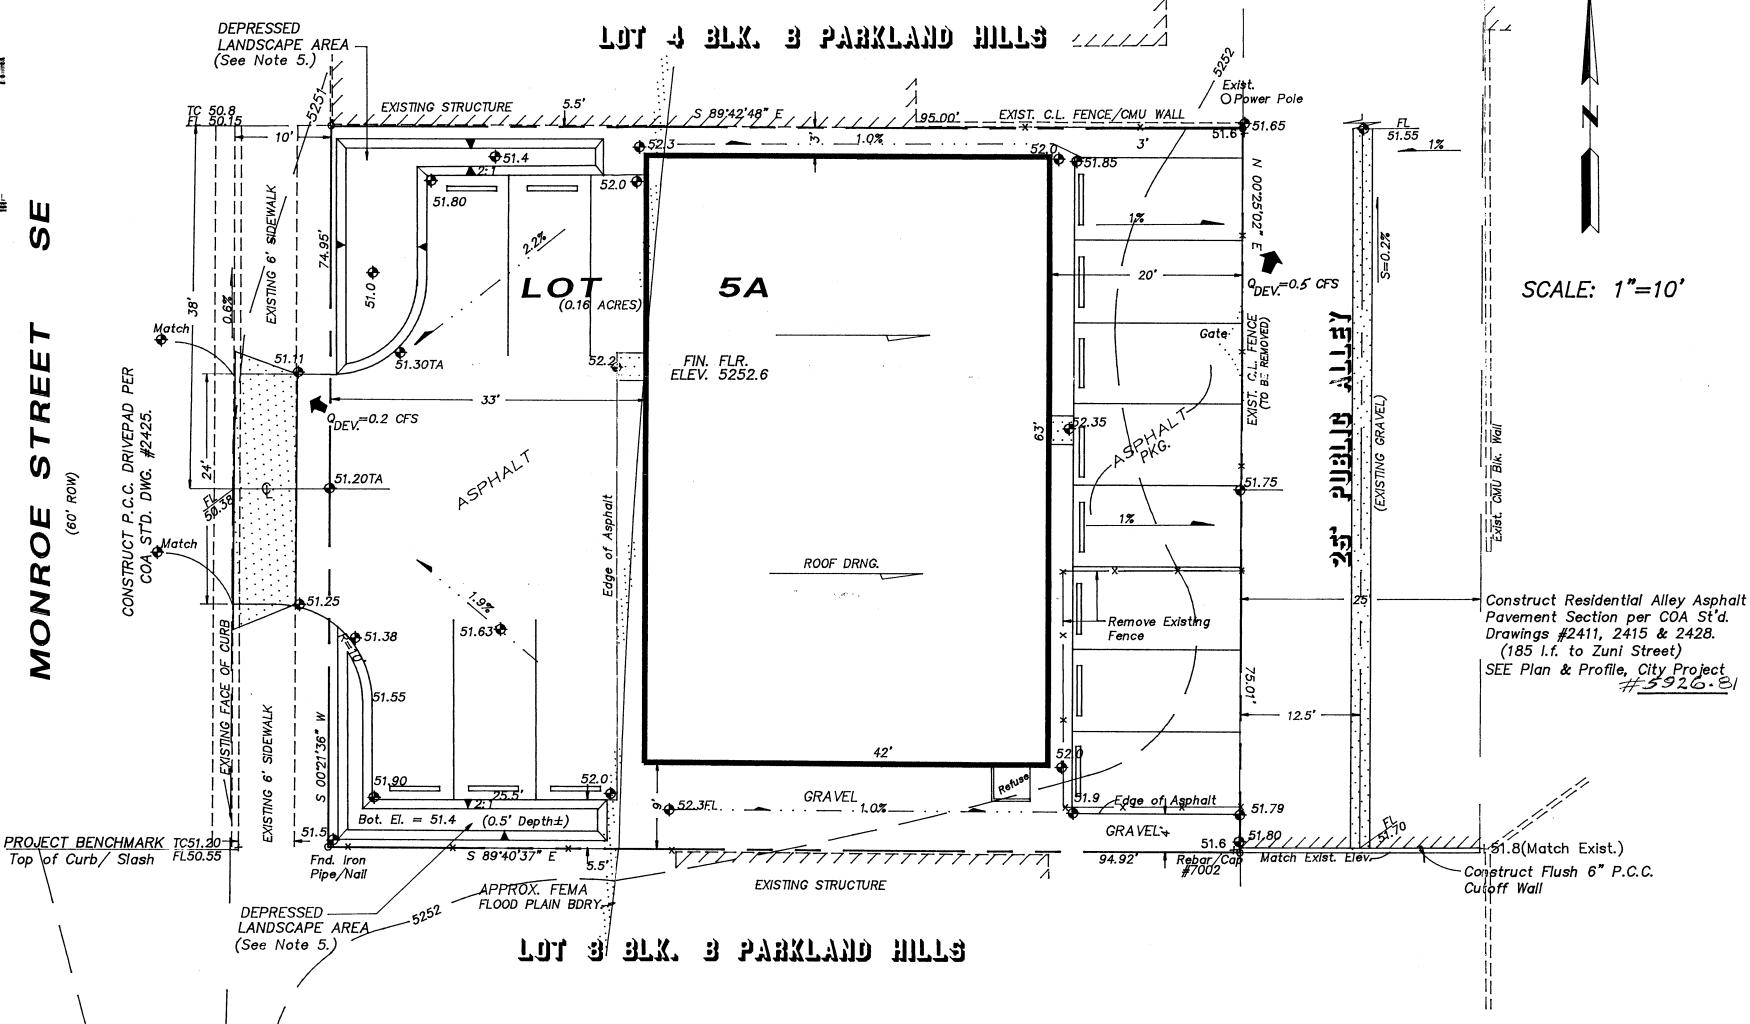PROJECT BENCHMARK: TOP OF CURB OF THE PROJECTION OF THE SOUTHWEST PROPERTY CORNER, AS TIED FROM ACS ALUM. CAP MARKED 13-L17 SET IN DRILL HOLE FLUSH WITH THE TOP

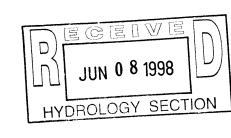

DATE REVISION LOT 5-A, BLOCK B, PARKLAND HILLS 6/4/98 Reconfig. PKg. STELLA BLANCO - THE SHADY LADY STORE Alley pevinit

A Cales/Text

Puc Grading & Drainage Plan

OF CURB LOCATED AT THE EAST, SOUTHEAST CURB RETURN AT MADISON PLACE AND ZUNI RD. DESIGNED BY: PWC DRAWN BY: CCE JOB No: PLIMPT\_STO CHECKED BY: PWC DATE: 3/17/98 FILE No: G/D

I, PHILIP W. CLARK, A PROFESSIONAL ENGINEER LICENSED IN ACCORDANCE WITH THE LAWS OF THE STATE

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SHOWN REPRESENT THE EXISTING GROUND CONDITIONS, AND DO FURTHER CERTIFY THAT NO EARTHWORK OF ANY KIND, NOR ANY DISTURBANCE OF THE EXISTING GROUND HAS OCCURRED ON THIS SITE SINCE THE CONTOURS