

TRAFFIC CIRCULATION LAYOUT

APPROVED

Public Infrastructure shown

on these plans for Information

only and not part of approval.

Separate DRC/Permit approval

adn Work Order required.

表 TRUMBULE

BELL

Existing Alley

ends here

EXISTING

BLPG

TEXIST, CONC, -

SIEWALK

ADJACENT BLOG.

EXIGING 8" CMU MALL C ARBINING

CODE ANALYSIS Applicable Code: Accessibility Code: Zoning:

UBC 1997 Edition, 1991 UMC, UPC and NEC 1997 State of New Mexico Building Code Chapter 31, ANSI-A-117.1 1998 Edition

C-1 City of Albuquerque, New Mexico **Building Addition** Total Area: 3190 gsf Type V-N, Table 5A Construction Type:

Occupancy Group: B, Table 3-A, Sales and warehouse

Seismic, Zone: 2B as per 1997 UBC Emil Mann Addition Property Address: 520 Louisiana S.E. City of Albuquerque, Bern Cty. UPC # 101905601043521013 Total Pad Site Area: 13,500 gsf, .31 ac.

Dead Loads 35 psf Live Loads 20 psf Assumed Soil 1500PSF

Block 10, Lot 'A

Replats of Lots 5 & 6

Off-Street Parking:Based on:

Wind Loading: 90 MPH, Exposure 'C' 1485 nsf Rear Storage Area: 1485 nsf at 1-space / 200 nsf = 7.42 spaces

Customer, meat cutting/ display and Employee Areas: 1540 nsf at 1-space/ 200 sf = 8 spaces

Total parking required = 16 spaces Total parking available = 16 spaces

Landscaping Requirements:

Bearing Capacity:

15% of Net Lot Area: Net Area = 10,200 sf x 15% = 1530 sf

Landscape area available Gross area = 2,122 @ 75% = net at adult stage Net area = 1,592 sf available

PLANT MATERIAL SCHEDULE

COMMON NAME BOTANICAL NAME QTY SIZE REMARK TREES: (A) Purple, Red 2" caliper (B) Modesto Ash Fraxinus veluntina 8'-10' SHRUBS: (The proposed plant material is shown below as a range of plants to choose from) (C)-Apache Plume Container (D)-Autumn Sage 5 gal. Container (E)-Japanese barberry 5 gal. Container F) -Desert Willow Container (G) -"Blue Carpet" 5 gal. Container (H)-Silky Threadgrass Stipa tennuifolia 5 gal. Container MULCHES: (I)-Gravel Mulch River Bank Run 3/4" +, 2" thick layer over 4 mil. plastic -Shredded tree bark small to medium size

Symbols identify all trees and shrubs small or large and are as listed in the above plant schedule and shown on the Site Plan as landscaped areas. The # along side the symbol identifies the number of plants recommended and equally spaced within the available area between trees.

2" thick layer over a 4 mil plastic barrier

Adjustable bubbler at all trees and large shrubs as shown in plan. Place 1-bubbler at each tree and each larger plant.


Adjustable shrub sprays with a 3-5 streams per bubbler and place at least to water up to 3- shrubs or flowering plants, as shown in plan.

Underground sprinkler lines, main and/or laterals are shown extending from the valve boxes shown, whether existing on south side or new in the developed areas.

SPRINKER SYSTEM LEGEND

Sprinkler Heads shall be of the fixed bubbler or spray type for this particular landscaping concept, the assemblies shall be as manufactured by "Toro" or of the "Hunter" type. Model numbers referenced ar by "Toro", or provide an equal. Note! The owner will be responsible for maintaining all plant material and also replacing any plants that die.

Flood bubblers nozzles - Model # FB - 25- PC Stream spray nozzles - Model # SB - 180- PC2

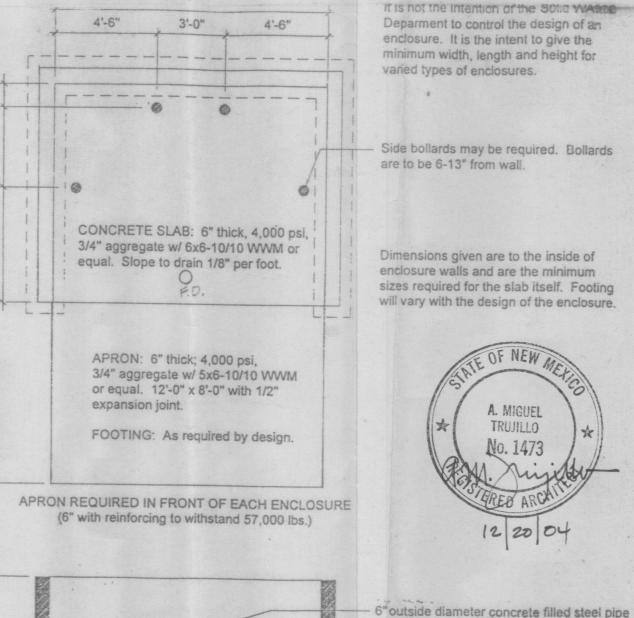

SITE DEVELOPMENT PLAN

45-0 BLOG. GETBACK

1170

TYPE &

COMPG

Customer Parking

- IRRIGATION VALVES

BOX W PISER

3505

6.0

Existing 6' Sidewalk

Scale: 1" = 10' - 0"

- Existing 6' Sidewalk -

55-0"

CARNECERIA BUILDING

3300 gsf

105 NSH >

FFL 5326.50

Qustomer Parking

PEDESTRIAN

WALKHAT

Entrance

35-0

V4-5PACES@ 8-6 = 34-0"

Driveway

aisle H.C. VAN

755

220

Driveway.

TRASH ENCLOSURE PLAN

MAP L-18 VICINITY MAP

ARCHITECTSCOP 12/21/04

shall be encased in 12" concrete all around

and embedded 2'-0".

SITE DEVELOPMENT CONSTRUCTION KEYNOTES:

- 1. 8"x 8" 6' 8" high existing block wall and existing power pole with electrical transformer for building power distribution.
- 2. Proposed new 8" cmu wall by owner or a solid wood fence as is permitted by Zoning and Planning; fence to be 6'-0" high.
- This owner may have the option to close-off this end of the existing 16 foot alley or install a wood swinging gate that will allow him to enter the property at the rear side.
- 4. The owner will install a 6' 0" high solid wood picket fencing w/ 4"x4" wood fences at 8'-0" o.c. and in a concrete base.
- Install a 6"x6" treated timber, staked into ground; timber will act as a separation of the new asphalt from the gravel mulched area.
- 6. New 2" minimum asphalt paving over a min. 4" thick fully com-
- pacted sub-base and sloped as per the grading and drainage plan. Contractor shall remove portions of existing drivepad to accom-
- modate the construction of the new concrete drivepad per G&D.
- New 2" thick asphalt paving shall match up to the existing asph.
- 9. The new 4" concrete porch pad may not line up with the existing concrete sidewalk at existing commercial building.
- 10. Remove existing railroad ties from property line and place paving as per KN# 8 above.
- 11. NEW ON-SITE FIRE HYDRANT, TIED-INTO STREET MAIN.
- 12. 4"X 6" TREATED LANDSCAPE TIMBERS AS EDGING AS SHOWN
- 13. 6"x 12" HIGH CONC. HEADER CURBING W/ 1#4 REINF. BAR.

IRRIGATION GENERAL NOTES:

- 1. All valves shall be installed a minimum of 4" from hard edges and boxes in shrub beds shall be installed a minimum of 12" from edges of walks or other hard surfaces.
- of CMU (4 minimum per valve box). Install blocks in a manner in which it will prevent contact with piping, wiring, sidewalks, etc....

2. All valve boxes shall be supported by solid pieces

- 3. Mark all 24 volt wire ends with 3M STD-09 wire marker tape at the valve box and controller locations.
- 4. All 24 volt wiring shall be in common trench with the water main and shall have separate sleeve where it crosses all underground hard const. matls. All sleeve piping for 24-volt wiring shall be of 2" Class 200 PVC.
- 5. 24-volt wire shall be marked with a 3" wide red marker tape and marked "Warning'Electrical". Lay marker tape horizontally 6" above wire.
- where proposed piping is to cross existing concrete sidewalks, trench below sidewalks and install a PVC sleeve as required, backfill into solidly from both sides of sidewalk width.
- 7. Contractor shall adjust all valves, bubblers, and sprinklers for optimum coverage, and shall provide and install nozzles other than those specified or instructed by the landscape architect, at no additional cost to the owner.
- 8. Install all bubblers on the high side of each tree wells, typically.
- 9. Contractor shall tape closed all sleeve pipe openings use duct tape to prevent debris from entering
- 10. Contractor shall extend 120-volt AC wiring form existing power to proposed controller and backflow preventer locations. All elect. work shall be as per local codes and NEC Standards.
- 11. Existing water main line locations shall be determined by the landscaping contr. as the responsibility of the installers to pot hole and field check to determine exact locations prior to tiein of new main line extensions or laterals lines.
- The proposed controller location indicated on the drawings is approximate; the actual location shall be determined after consultation with the owner's requirements.
- . If needed, install sleeves prior to field work.
- 4. This underground irrigation system was designed for a 50 PSI static water pressure at the head and 45 GPM. The installers must verify the actual static water pressure prior to construction and and it shall be discussed with the Arch. if there are any design modifications required.
- 15. The contractor shall install manual drains on lateral and main line piping to ensure proper and complete drainage of piping (see manual drain assembly). Install one manual drain per zone, minimum. Locations shall be field determined; the installers should show them on the "As-builts".

MIGUEL TRUJILLO & ASSOCIATES Construction Management Architecture 8504 Spain Road NE Office (505) 821-5687 Albuquerque, NM Cell # (505) 410-4776 87111

Project: CUAUHTEMOC CARNECERIA BUILDING

Butcher Shop with Retail Meat Sales

520 Louisiana Blvd. S. E. Albuquerque, New Mexico

Owners: Juan Manuel Jacquez 844 Bridge S. W.


Albuquerque, New Mexico 87105 DIAMETER Sheet No.

Job No. 2004-0011 Date: 5EPT. 28,2004

Design By: A. Miguel Trujillo

Checked A. Miguel Trujillo

MAR 24 2013 HYDROLOGY

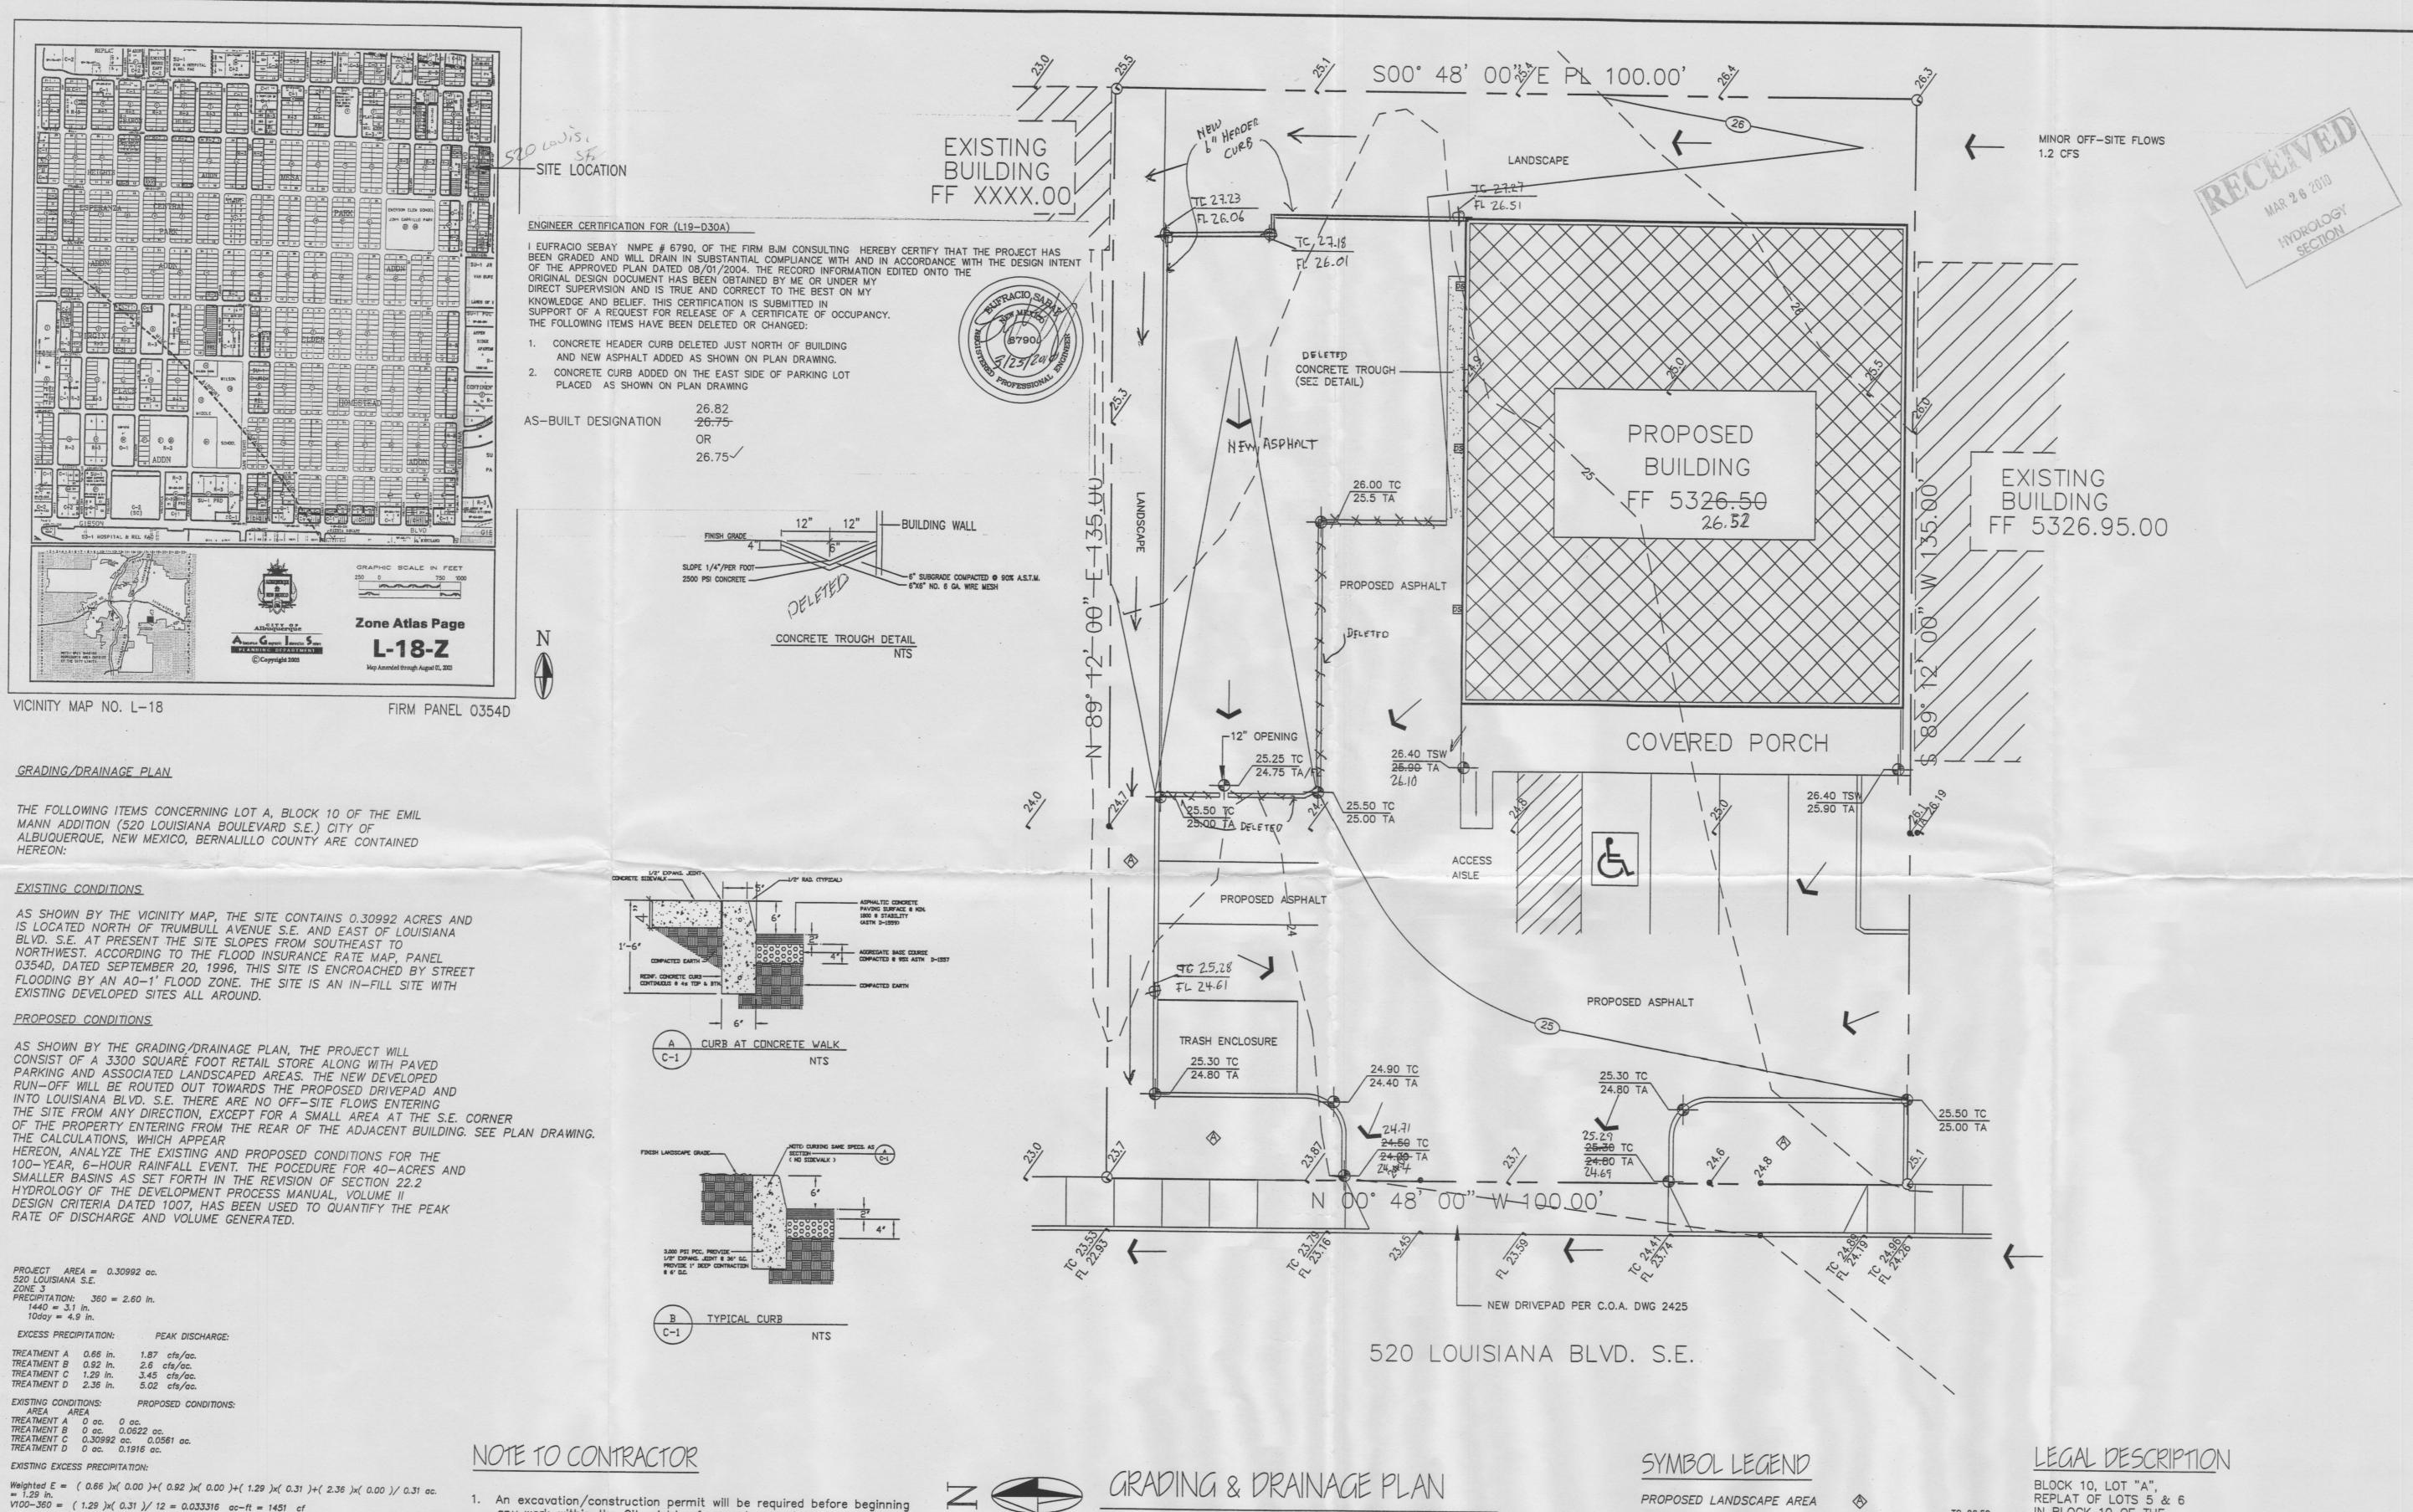

1. An excavation/construction permit will be required before beginning any work within the City right-of-way. Approved copy of this plan must be submitted at the time of application for permit.

EXISTING PEAK DISCHARGE:

PROPOSED PEAK DISCHARGE:

INCREASE 1.16 CFS - 1.07 CFS = 0.09 CFS

PROPOSED EXCESS PRECIPITATION:

Q100 = (1.87)x(0.00) + (2.60)x(0.00) + (3.45)x(0.31) + (5.02)x(0.00) = 1.07 cfs

V100-1440 = (0.05)+(0.19)x(3.10-2.60)/12 = 0.056464 ac-ft = 2460 cf

V100-10day = (0.05)+(0.19)x(4.90-2.60)/12 = 0.085204 ac-ft? = 3711 cf

Q100 = (1.87)x(0.00) + (2.60)x(0.06) + (3.45)x(0.06) + (5.02)x(0.19) = 1.16 cfs

V100-360 = (1.88)x(0.31)/12.0 = 0.048481 ac-ft = 2112 cf

Weighted $E = (0.66) \times (0.00) + (0.92) \times (0.06) + (1.29) \times (0.06) + (2.36) \times (0.19) / 0.31$ ac.

- 2. All work detailed in this plan to be performed, except as otherwise stated or provided hereon, shall be constructed in accordance with City of Albuquerque Standard Specification for Public Works Construction.
- 3. Two working days prior to any excavation, contractor must contact line locating Services for locating existing utilities (260-1990).
- 4. Prior to construction, the contractor shall excavate and verify the horizonal and vertical location of all construction. Should a conflict exist, the contractor shall notify the engineer so that the conflict can be resolved with a minimum amount of delay.
- 5. Backfill compaction shall be according to residential use.
- 6. All work on this project shall be performed in accordance with applicable Federal, State and local laws, rules and regulations concerning construction safty and health.
- 1"=10"

EROSION CONTROL MEASURES

- 1. THE CONTRACTOR SHALL BE HELD RESPONSIBLE FOR MANAGEMENT OF STORM RUN-OFF DURING CONSTRUCTION, HE SHALL ASSURE THAT THE FOLLOWING MEASURES ARE
 - A) ADJACENT PROPERTY SHALL BE PROTECTED AT ALL TIMES BY TEMPORARY BERMS, DOWN SPOUT DIKES, SWALES, AND OTHER TEMPORARY GRADING AS REQUIRED TO PREVENT STORM RUN-OFF FROM LEAVING THE SITE AND ENTERING ADJACENT PROPERTY.
 - B) ADJACENT PUBLIC RIGHT-OF-WAY SHALL BE PROTECTED AT ALL TIMES FROM STORM WATER RUN-OFF FROM THE SITE. NO SEDIMENT BEARING WATER SHALL BE PERMITTED TO ENTER THE PUBLIC STREETS.
- 2. THE CONTRACTOR SHALL IMMEDIATELY AND THOROUGHLY REMOVE ANY OR ALL SEDIMENT WITHIN THE PUBLIC STREETS THAT HAVE BEEN ERODED FROM THE SITE AND DEPOSITED THERE.

PROPOSED LANDSCAPE AREA 26.00 TC 26.50 FL 26.00 PROPOSED CONTOUR EXISTING SPOT ELEVATION DESIGNED SPOT ELEVATION PROPERTY LINE

EASEMENT LINE FLOW DIRECTION

TOP OF CON. PAD TOP OF CURB TOP OF ASPHALT - TA FLOWLINE - FL TOP OF WALL - TW TOP OF SIDEWALK - TSW

REPLAT OF LOTS 5 & 6 IN BLOCK 10 OF THE EMIL MANN ADDITION UPC #: 101905601043521013 BERNALILLO COUNTY ALBUQUERQUE, NEW MEXICO

BENCHMARK

A.C.S. USED 6-L18 LOCATED AT THE INTERSECTION OF TRUMBULL & LOUISIANA S.E. ELEVATION: 5327.676 T.B.M. SPRAY PAINTED BLUE AT THE PROJECTION OF THE NORTHWEST PROPERTY CORNER ELEVATION: 5323.53



JOB NO:
DATE: AUGUST 2004
REVISIONS
AUGUST 1, 2004

Checked By B.IM	BJM	BV.	Drawn Br. BJM
& DRAINAGE PLAN	9	101	GRADING &



SHEET NO.